

CERTIFICATE OF APPROPRIATENESS **EXECUTIVE SUMMARY**

HEARING DATE: DECEMBER 16, 2020

Record No.: 2019-021869COA **Project Address: 1216 Fulton Street**

Landmark: Contributor, Alamo Square Historic District

Zoning: RH-3 RESIDENTIAL- HOUSE, THREE FAMILY Zoning District

40-X Height and Bulk District

Block/Lot: 1180/009

Project Sponsor: Toby Morris, Kerman Morris Architects

139 Noe Street

San Francisco, CA 94114

Staff Contact: Shannon M. Ferguson - 628-652-7354

Shannon.Ferguson@sfgov.org

Recommendation: Approval

Property Description

1216 Fulton Street (Assessors Block 1180, lot 009, subject property) is located on the north side of Fulton Street between Divisadero and Scott streets. The subject property is a contributor to the Alamo Square Historic District, locally designated under Article 10, Appendix E of the Planning Code.

The Italianate-style, two-family residence was designed in 1883 by Henry Geilfuss. The two-story, plus basement, wood-framed building is set back from the public right of way and has a shallow front yard enclosed by a low concrete wall topped by wrought iron fencing. The building is clad in horizontal wood siding and has a gable roof behind a high false parapet. The west bay of the front façade contains a prominent porch with turned wood balustrades and carved wood columns supporting a curved pedimented roof. The porch shelters inset partially glazed paneled wood doors that are flanked by wood paneling. Above the porch at the second floor is a segmentally arched, double-hung wood window in a flat wood surround with ghosting of wood detailing at the upper corners of the surround. The east bay of the front facades contains an angled bay window that spans the basement to the second story. A curved cornice separates the first and second stories of the bay window. Segmentally arched, double-hung wood windows with flat wood surround with ghosting of wood detailing at

the upper corners fill the bay window. A remnant of a turned wood pilaster is located at the east side of the bay window at the first and second stories. A flat, carved wood pilaster is located at the corner of the façade at the second floor. The building terminates in an overhanging stepped cornice. Alterations include removal of historic wood detailing at front façade at an unknown date, including pilasters at bay window and frieze and brackets at the cornice. Original wood detailing is extant at the stepped back portion of the façade and includes molded window surrounds and a decorative frieze and brackets at the cornice.

The subject property is one of four similarly designed buildings in a row on Fulton Street on the western edge of the Alamo Square Historic District. The neighboring properties have been stripped of their original wood details and re-clad in T-111 siding or stuccoed. All neighboring properties have received an insensitive garage insertion. 1216 Fulton Street is the only property to retain the original configuration of the angled bay window spanning the basement to second floors, historic horizontal wood siding, and some historic wood detailing.

Project Description

The proposed project involves a rear horizontal addition and a vertical addition, plus excavation of the basement to add a third dwelling unit. At the public right of way, the existing wrought iron fencing will be salvaged and reinstalled on a new low concrete wall. The existing horizontal wood siding will be retained and repaired. The columned and pedimented front porch and double doors, pilasters will also be retained. All existing segmentally arched double-hung wood sash windows will be retained and repaired. New window openings with wood awning windows will be added to the basement level of the angled bay window. The vertical addition with angled roof will be set back from the front façade behind the existing high parapet. It will be clad in horizontal wood siding and have a glazed wood door and wood casement window accessing a new rooftop deck. At the east elevation, new paired and single window openings filled with double hung wood windows will be added to the basement, first and second stories. The rear (north) elevation of the horizontal addition will be clad in horizontal wood siding and will have wood sliding doors and double-hung windows surmounted by transom windows and new balconies with wood railings. The west elevation will be a blind wall clad in horizontal wood siding. Please see photographs and plans for details.

Compliance with Planning Code

PLANNING CODE DEVELOPMENT STANDARDS.

The proposed project is in compliance with all other provisions of the Planning Code.

In order to proceed, a building permit from the Department of Building Inspection is required.

APPLICABLE PRESERVATION STANDARDS.

The proposal overall, is appropriate for and consistent with the purposes of Article 10, meets the standards of Article 1006.6 of the Planning Code, and complies with the <u>Secretary of the Interior's Standards for Rehabilitation</u>, in that:

• The proposed project retains the historic purpose and use of the building as a multiple-family residence and adds a third dwelling unit in the basement that will require minimal change to the front façade of



the subject property;

- The proposed project will retain the original configuration of the angled bay window spanning the basement to the second story;
- The proposed project retains extant distinctive features and examples of skilled craftsmanship at the front facade;
- Sightline studies show that the vertical addition will be minimally visible from the street. The angled roof helps to differentiate it from the old and it is compatible in size and scale;
- The rear addition is contemporary and compatible with the massing of the subject property.;
- All new materials will be compatible with historic materials in composition and design.

The Department has determined that the proposed project is in conformance with the requirements of Article 10 of the Planning Code and the Secretary of Interior's Standards for Rehabilitation. The proposed project will not damage or destroy distinguishing original qualities or character of the façade of the subject building. The overall proposal includes the addition of a third dwelling unit as well as retention of the original configuration of the bay window and extant historic details. The new wood windows at the basement level of the bay window at the facade and east elevation are compatible in materials and with the existing fenestration pattern. The vertical addition is set back from the front elevation behind the high parapet and is minimally visible from the street, yet the angled roof allows it to be differentiated from the old. The rear horizontal addition is contemporary and compatible.

Public/Neighborhood Input

The Department has received one email from the public (attached) at the time of writing. Specifically, the public correspondence states that a garage should be inserted in the building because parking is difficult in the neighborhood and will increase in difficulty due to the addition of a dwelling unit, and it will make the building uniform with the neighboring buildings that already have garages.

Issues & Other Considerations

The Project is fully code complaint and is supported by Department Staff. As originally submitted the proposed project included two, two level dwelling units, a new garage, and incompatible materials at the rear elevation of the horizontal addition. As the Planning Code does not require parking, the building is located in an RH-3 zoning district, and is the only building in a row of four similar buildings on Fulton Street in Alamo Square Historic District to retain the original configuration of bay window and historic wood details, the Project Sponsor worked extensively with Department staff to retain the façade as originally configured, add an additional dwelling unit to the basement, and use compatible wood materials at the new rear elevation.

Conditions of Approval

None.



Environmental Review Status

The Project is exempt from the California Environmental Quality Act ("CEQA") as a Class 1 categorical exemption.

Basis for Recommendation

The Department recommends approval of the proposed project as it meets the provisions of Article 10 of the Planning Code regarding Major Alteration to a contributing resource in a Landmark District and the Secretary of the Interior Standards for Rehabilitation.

Attachments

Draft Motion – Certificate of Appropriateness Plans and Renderings Environmental Determination Maps and Context Photos Public Correspondence





CERTIFICATE OF APPROPRIATENESS DRAFT MOTION

HEARING DATE: DECEMBER 16, 2020

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Zoning: RH-3 RESIDENTIAL- HOUSE, THREE FAMILY Zoning District

40-X Height and Bulk District

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ADOPTING FINDINGS FOR A CERTIFICATE OF APPROPRIATENESS FOR MAJOR ALTERATIONS DETERMINED TO BE APPROPRIATE FOR AND CONSISTENT WITH THE PURPOSES OF ARTICLE 10 OF THE SAN FRANCISCO PLANNING CODE, AND TO MEET THE SECRETARY OF THE INTERIOR'S STANDARDS FOR REHABILITATION, FOR THE PROPERTY LOCATED AT 1216 FULTON STREET, ASSESSOR'S BLOCK 1180, LOT 009, IN A RH-3 RESIDENTIALHOUSE, THREE FAMILY ZONING DISTRICT AND A 40-X HEIGHT AND BULK DISTRICT.

Preamble

On November 8, 2019, Toby Morris of Kerman Morris Architects (hereinafter "Project Sponsor") filed Application No. 2019-021869COA (hereinafter "Application") with the San Francisco Planning Department (hereinafter "Department") for a Certificate of Appropriateness for a rear horizontal addition and a vertical addition, plus the excavation of the basement to add a dwelling unit at a subject building located in Assessor's Block 1180, Lot 009, which is a contributing resource to Alamo Square Landmark District and locally designated under Article 10, Appendix E of the Planning Code.

The Project is exempt from the California Environmental Quality Act ("CEQA") as a Class 1 categorical exemption. The Historic Preservation Commission (hereinafter "Commission") has reviewed and concurs with said determination.

On December 16, 2020, the Commission conducted a duly noticed public hearing at a regularly scheduled meeting on Certificate of Appropriateness Application No. 2019-021869COA.

The Planning Department Commission Secretary is the custodian of records; the File for Record No. 2019-021869COA is located at 49 South Van Ness Avenue, Suite 1400, San Francisco, California.

The Commission has heard and considered the testimony presented to it at the public hearing and has further considered written materials and oral testimony presented on behalf of the applicant, Department staff, and other interested parties.

MOVED, that the Commission hereby APPROVES the Certificate of Appropriateness, as requested in Application No. 2019-021869COA in conformance with the architectural plans dated November 8, 2020 and labeled Exhibit B based on the following findings:

Findings

Having reviewed all the materials identified in the recitals above and having heard oral testimony and arguments, this Commission finds, concludes, and determines as follows:

- 1. The above recitals are accurate and also constitute findings of the Commission.
- 2. Project Description. The proposed project involves a rear horizontal addition and a vertical addition, plus the excavation of the basement to add a dwelling unit. At the public right of way, the existing wrought iron fencing will be salvaged and reinstalled on a new low concrete wall. The existing horizontal wood siding will be retained and repaired. The columned and pedimented front porch and double doors, as well as all existing segmentally arched double-hung wood sash windows are proposed to be retained and repaired. New window openings with wood awning windows will be added to the basement level of the angled bay window. The vertical addition with angled roof will be set back from the front façade behind the existing high parapet. It will be clad in horizontal wood siding and have a glazed wood door and wood casement window accessing a new rooftop deck. At the east elevation, new paired and single window openings filled with double hung wood windows will be added to the basement, first and second floors. The rear (north) elevation of the horizontal addition will be clad in horizontal wood siding and will have wood sliding doors and double-hung windows surmounted by transom windows and new balconies with wood railings. The west elevation will be a blind wall clad in horizontal wood siding. Please see photographs and plans for details.
- 3. **Property Description.** 1216 Fulton Street is located on the north side of Fulton Street between Divisadero Street and Scott Street (Assessor's Block 1180; Lot 009, subject property). The subject property is a contributor to the Alamo Square Landmark District, locally designated under Article 10, Appendix E of the Planning Code. The Italianate-style, two-family residence was designed in 1883 by



Henry Geilfuss. The two-story, plus basement, wood-framed building is set back from the public right of way and has a shallow front yard enclosed by concrete and wrought iron fencing. The building is clad in horizontal wood siding and has a gable roof behind a high false parapet. The west bay of the front façade contains a prominent porch with turned wood balustrades and carved wood columns supporting a curved pedimented roof. The porch shelters an inset partially glazed paneled wood double doors that are flanked by wood paneling. Above the porch at the second floor is a segmentally arched, doublehung wood window in a flat wood surround with ghosting of wood detailing at the upper corners of the surround. The east bay of the front facades contains an angled bay window that spans the basement to the second story. A curved cornice separates the first and second stories. Segmentally arched, doublehung wood with flat wood surround with ghosting of wood detailing at the upper corners fill the bay window. A remnant of a turned wood pilaster is located at the east side of the bay window at the first and second stories. A flat, carved wood pilaster is located at the corner of the façade at the second floor. The building terminates in an overhanging stepped cornice. Alterations include removal of historic wood detailing at front façade. Original wood detailing is extant at a portion of the stepped back portion of the façade and includes molded window surrounds and decorative frieze and brackets at the cornice.

- 4. **Surrounding Properties and Neighborhood.** The subject property is one of four similarly designed buildings in a row on the north side of Fulton Street. The neighboring properties have been stripped of their original wood details and re-clad in T-111 siding or stuccoed. All neighboring properties have received an insensitive garage insertion. 1216 Fulton Street is the only one of the remaining four properties to retain the original configuration of the angled bay window spanning the basement to second floors and some historic wood detailing.
- 5. **Public Outreach and Comments.** The Department received one email from the public. Specifically, the public correspondence states that a garage should be inserted in the building because parking is difficult in the neighborhood and will increase in difficulty due to the addition of a dwelling unit, and will make the building uniform with the neighboring buildings that already have garages.
- 6. **Planning Code Compliance.** The Commission has determined that the proposed work is compatible with the exterior character-defining features of the subject property and meets the requirements of Article 10 of the Planning Code in the following manner:
 - A. Article 10 of the Planning Code. Pursuant to Section 1006.6 of the Planning Code, the proposed alteration shall be consistent with and appropriate for the effectuation of the purposes of this Article 10.

The proposed project is consistent with Article 10 of the Planning Code.

B. Secretary of the Interior's Standards. Pursuant to Section 1006.6(b) of the Planning Code, the proposed work shall comply with the Secretary of the Interior's Standards for the Treatment of Historic Properties for significant and contributory buildings, as well as any applicable guidelines, local interpretations, bulletins, or other policies. Rehabilitation is the act or process of making possible a compatible use for a property through repair, alterations, and additions while preserving those portions or features that convey its historical, cultural, or architectural values. The <u>Standards for Rehabilitation</u> provide, in relevant part(s):



- (1) A property shall be used for its historic purpose or be placed in a new use that requires minimal change to the defining characteristics of the building and its site and environment.
 - The subject property is a two dwelling unit building. The proposed project will add a third dwelling unit in the basement. The new unit retains the historic purpose and use of the building as a multiple-family residence. The addition of a new dwelling unit requires minimal change to character defining features of the building.
- (2) The historic character of a property will be retained and preserved. The removal of historic materials or alteration of features and spaces that characterize a property shall be avoided.
 - The proposed project will retain the original configuration of the angled bay window spanning the basement to the second story, thus retaining and preserving the historic character of the subject property. The proposed project will not remove historic materials or alter character defining features of the subject property as it will retain extant historic wood details at the front façade.
- (3) Each property will be recognized as a physical record of its time, place and use. Changes that create a false sense of historical development, such as adding conjectural features or elements from other historic properties, shall not be undertaken.
 - The proposed project retains historic materials and original configuration of the subject property. It recognizes the physical record of the subject property's time place and use. The proposed project does not include changes that create a false sense of historical development of add conjectural features or elements from other historic properties.
- (4) Most properties change over time; those changes that have acquired historic significance in their own right shall be retained and preserved.
 - Wood detailing at the front façade, including window pilasters, and frieze and brackets at the cornice, was removed at an unknown date. The proposed project retains and preserves extant historical detailing and materials.
- (5) Distinctive features, finishes, and construction techniques or examples of fine craftsmanship that characterize a property shall be preserved.
 - The proposed project preserves extant distinctive features and finishes, such as the finely crafted wood columns and curved pediment at the front porch and bay window, window surrounds, cornice and pilasters.
- (6) Deteriorated historic features shall be repaired rather than replaced. Where the severity of deterioration requires replacement of a distinctive feature, the new feature shall match the old in design, color, texture, and other visual qualities and, where possible, materials. Replacement of missing features shall be substantiated by documentary, physical, or pictorial evidence.



- The proposed project will retain and repair in-kind any deteriorated extant historic features such as horizontal wood sizing and segmentally arched double-hung wood windows.
- (7) Chemical or physical treatments, such as sandblasting, that cause damage to historic materials shall not be used. The surface cleaning of structures, if appropriate, shall be undertaken using the gentlest means possible.
 - The proposed project does not include any chemical or physical treatments that would cause damage to historic materials.
- (8) Significant archeological resources affected by a project shall be protected and preserved. If such resources must be disturbed, mitigation measures shall be undertaken.
 - The proposed project includes 12-feet of excavation at the basement level, approximately 689 cubic yards total. However, the subject property is not located in an archaeologically sensitive area.
- (9) New additions, exterior alterations, or related new construction shall not destroy historic materials that characterize the property. The new work shall be differentiated from the old and shall be compatible with the massing, size, scale, and architectural features to protect the historic integrity of the property and its environment.
 - The proposed project includes a vertical addition and a horizontal addition at the rear. Both additions will be clad in horizontal wood siding and have wood windows compatible with the historic materials of the subject property. Sightline studies show that the vertical addition will be minimally visible from the street. The angled roof helps to differentiate the vertical addition from the old and it is compatible in size and scale. The rear addition is contemporary and compatible with the massing of the subject property. Overall, the proposed project will not destroy historic materials or features that characterize the building. The new work is compatible with the massing and architectural features to protect the historic integrity of the subject property and the Alamo Square historic district.
- (10) New additions and adjacent or related new construction shall be undertaken in such a manner that if removed in the future, the essential form and integrity of the historic property and its environment would be unimpaired.
 - It is unlikely that the new additions will be removed in the future. However, the proposed project preserves the essential form of the front façade by retaining the original form of the angled bay window and preserves extant historic wood detailing thus preserving the integrity of the subject property and that of the Alamo Square historic district.
- C. Landmarks/Historic District. Article 10 of the Planning Code outlines specific findings for the Commission to consider when evaluating applications for alterations to Landmarks or within designated Historic Districts.



Historic Districts

1. Pursuant to Section 1006.6(d) of the Planning Code, for applications pertaining to property in historic districts, other than on a designated landmark site, any new construction, addition or exterior change shall be compatible with the character of the historic district as described in the designating ordinance; and, in any exterior change, reasonable efforts shall be made to preserve, enhance or restore, and not to damage or destroy, the exterior architectural features of the subject property which are compatible with the character of the historic district.

The project is in conformance with Article 10, and as outlined in Appendix E, as the horizontal and vertical additions will be compatible with the character of the historic district. The proposed project makes reasonable efforts to preserve and repair the exterior architectural features of the subject property that are compatible with the character of the historic districts.

2. Pursuant to Section 1006.6(e) of the Planning Code, for applications pertaining to all property in historic districts, the proposed work shall also conform to such further standards as may be embodied in the ordinance designating the historic district.

The project is in conformance with Article 10, and as outlined in Appendix E, as the proposed work conforms to standards embodied in the ordinance designating the historic district.

7. **General Plan Compliance.** The proposed Certificate of Appropriateness is, on balance, consistent with the following Objectives and Policies of the General Plan:

URBAN DESIGN ELEMENT

THE URBAN DESIGN ELEMENT concerns the physical character and order of the city, and the relationship between people and their environment.

OBIECTIVE 1:

EMPHASIS OF THE CHARACTERISTIC PATTERN WHICH GIVES TO THE CITY AND ITS NEIGHBORHOODS AN IMAGE, A SENSE OF PURPOSE, AND A MEANS OF ORIENTATION.

Policy 1.3

Recognize that buildings, when seen together, produce a total effect that characterizes the city and its districts.

OBJECTIVE 2:

CONSERVATION OF RESOURCES WHICH PROVIDE A SENSE OF NATURE, CONTINUITY WITH THE PAST, AND FREEDOM FROM OVERCROWDING.

Policy 2.4

Preserve notable landmarks and areas of historic, architectural or aesthetic value, and promote the preservation of other buildings and features that provide continuity with past development.



Policy 2.5

Use care in remodeling of older buildings, in order to enhance rather than weaken the original character of such buildings.

Policy 2.7

Recognize and protect outstanding and unique areas that contribute in an extraordinary degree to San Francisco's visual form and character.

The goal of a Certificate of Appropriateness is to provide additional oversight for buildings and districts that are architecturally or culturally significant to the City in order to protect the qualities that are associated with that significance.

The proposed project qualifies for a Certificate of Appropriateness and therefore furthers these policies and objectives by retaining, repairing and preserving the character-defining features of the subject property for the future enjoyment and education of San Francisco residents and visitors.

- **8. Planning Code Section 101.1(b)** establishes eight priority-planning policies and requires review of permits for consistency with said policies. On balance, the project complies with said policies in that:
 - A) The existing neighborhood-serving retail uses will be preserved and enhanced and future opportunities for resident employment in and ownership of such businesses will be enhanced:
 - The proposed project will not have an impact on neighborhood serving retail uses.
 - B) The existing housing and neighborhood character will be conserved and protected in order to preserve the cultural and economic diversity of our neighborhoods:
 - The proposed project will strengthen neighborhood character by respecting the character-defining features of the building in conformance with the Secretary of the Interior's Standards
 - C) The City's supply of affordable housing will be preserved and enhanced:
 - The project will not affect the City's affordable housing supply.
 - D) The commuter traffic will not impede MUNI transit service or overburden our streets or neighborhood parking:
 - The proposed project will not result in commuter traffic impeding MUNI transit service or overburdening the streets or neighborhood parking.
 - E) A diverse economic base will be maintained by protecting our industrial and service sectors from displacement due to commercial office development. And future opportunities for resident employment and ownership in these sectors will be enhanced:



The proposed project will not have a direct impact on the displacement of industrial and service sectors.

F) The City will achieve the greatest possible preparedness to protect against injury and loss of life in an earthquake.

All construction will be executed in compliance with all applicable construction and safety measures.

G) That landmark and historic buildings will be preserved:

The proposed project is in conformance with Article 10 of the Planning Code and the Secretary of the Interior's Standards.

H) Parks and open space and their access to sunlight and vistas will be protected from development:

The proposed project will not impact the access to sunlight or vistas for the parks and open space.

9. For these reasons, the proposal overall, appears to meet the Secretary of the Interiorfs Standards and the provisions of Article 10 of the Planning Code regarding Major Alterations.



Decision

That based upon the Record, the submissions by the Applicant, the staff of the Department and other interested parties, the oral testimony presented to this Commission at the public hearings, and all other written materials submitted by all parties, the Commission hereby APPROVES a Certificate of Appropriateness for the subject property located at Assessor's Block 1180, Lot 009 for proposed work in conformance with the architectural submittal dated November 8, 2019 and labeled Exhibit B on file in the docket for Record No. 2019-021869COA.

APPEAL AND EFFECTIVE DATE OF MOTION: The Commission's decision on a Certificate of Appropriateness shall be final unless appealed within thirty (30) days after the date of this Motion No. XXXXXX. Any appeal shall be made to the Board of Appeals, unless the proposed project requires Board of Supervisors approval or is appealed to the Board of Supervisors as a conditional use, in which case any appeal shall be made to the Board of Supervisors (see Charter Section 4.135). For further information, please contact the Board of Appeals in person at 49 South Van Ness Ave, Suite 1475 or call (628) 652-1150.

Duration of this Certificate of Appropriateness: This Certificate of Appropriateness is issued pursuant to Article 10 of the Planning Code and is valid for a period of three (3) years from the effective date of approval by the Historic Preservation Commission. The authorization and right vested by virtue of this action shall be deemed void and canceled if, within 3 years of the date of this Motion, a site permit or building permit for the Project has not been secured by Project Sponsor.

THIS IS NOT A PERMIT TO COMMENCE ANY WORK OR CHANGE OF OCCUPANCY UNLESS NO BUILDING PERMIT IS REQUIRED. PERMITS FROM THE DEPARTMENT OF BUILDING INSPECTION (and any other appropriate agencies) MUST BE SECURED BEFORE WORK IS STARTED OR OCCUPANCY IS CHANGED.

I hereby certify that the Historical Preservation Commission ADOPTED the foregoing Motion on December 16, 2020.

| Commission S | ecretary |
|--------------|-------------------|
| | |
| AYES: | |
| NAYS: | |
| ABSENT: | |
| ADOPTED: | December 16, 2020 |



Jonas P. Ionin

EXHIBIT A

Authorization Update

This authorization is for a Certificate of Appropriateness to allow Alterations located at 1216 Fulton Street, Block 1180, and Lot 009 pursuant to Planning Code Section(s) 1006 within the RH-3 District and a 40-X Height and Bulk District; in general conformance with plans, dated November 8, 2019, and stamped "EXHIBIT B" included in the docket for Record No. 2019-021869COA and subject to conditions of approval reviewed and approved by the Historic Preservation Commission on December 16, 2020 under Motion No XXXXXXX. This authorization and the conditions contained herein run with the property and not with a particular Project Sponsor, business, or operator.

Printing of Conditions of Approval on Plans

The conditions of approval under the 'Exhibit A' of this Historic Preservation Commission Motion No. XXXXX shall be reproduced on the Index Sheet of construction plans submitted with the site or building permit application for the Project. The Index Sheet of the construction plans shall reference to the Certificate of Appropriateness and any subsequent amendments or modifications.

Severability

The Project shall comply with all applicable City codes and requirements. If any clause, sentence, section or any part of these conditions of approval is for any reason held to be invalid, such invalidity shall not affect or impair other remaining clauses, sentences, or sections of these conditions. This decision conveys no right to construct, or to receive a building permit. "Project Sponsor" shall include any subsequent responsible party.

Changes and Modifications

Changes to the approved plans may be approved administratively by the Zoning Administrator. Significant changes and modifications of conditions shall require Historic Preservation Commission approval of a new Certificate of Appropriateness. In instances when Planning Commission also reviews additional authorizations for the project, Planning Commission may make modifications to the Certificate of Appropriateness based on majority vote and not required to return to Historic Preservation Commission.

Conditions of Approval

None.




1216 FULTON

ADDITIONS/ALTERATIONS TO (E) 2-UNIT STRUCTURE; ADDITION OF A DWELLING UNIT



GENERAL LEGEND

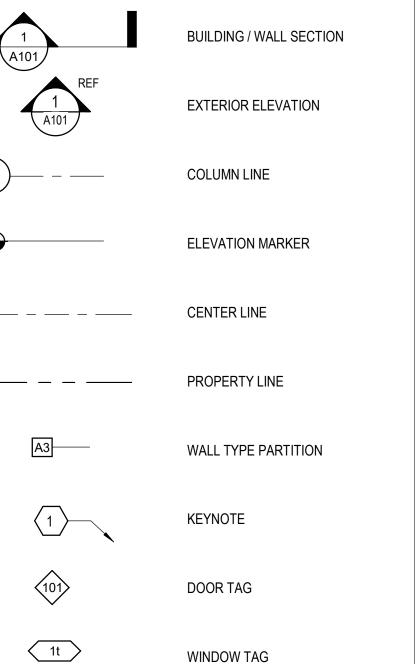

SHEET INDEX

| ARCHITECTURE EXISTING / DEMO D1.01 EXISTING / DEMO SITE PLANS D2.01 EXISTING / DEMO FLOOR PLANS D5.01 EXISTING / DEMO EXTERIOR ELEVATIONS ARCHITECTURE A1.01 SITE PLANS A2.01 FLOOR PLANS A2.02 FLOOR PLANS A5.01 EXTERIOR ELEVATIONS A5.01 EXTERIOR ELEVATIONS A5.02 EXTERIOR ELEVATIONS A7.01 BUILDING SECTIONS A7.02 SITE ANALYSIS A10.13 WINDOW SCHEDULE SHEET COUNT: 21 | G0.05 G0.06 G0.07 G0.08A G0.08B | COVER SHEET ABBREVIATIONS, SYMBOLS, & GENERAL NOTES PLANNING & PROJECT INFORMATION, BUILDING CODE ANALYSIS SITE PHOTOS |
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LOCATION MAP

kerman morris architects LLP

SUBJECT PROPERTY: 1216 FULTON STREET

139 Noe Street San Francisco, CA 94114 415 749 0302

Revisions

BUILDING DATA

OWNER: 411B LLC (415) 334-0100

PROJECT ADDRESS: 1216 FULTON STREET SAN FRANCISCO, CA 94117

PARCEL: 1180/009

ZONING DISTRICT: RH-3

UNITS: (2) EXISTING; (3) PROPOSED

OCCUPANCY GROUP: R-3 EXISTING (2 UNITS); R-2 PROPOSED (3 UNITS)

CONSTRUCTION TYPE: V-B EXISTING (UN-SPRINKLERED); V-A/1-HOUR PROPOSED (FULLY SPRINKLERED UNDER

SEPARATE PERMI

STORIES: (2) EXISTING; (3) OVER BASEMENT PROPOSED

ARCHITECT: KERMAN MORRIS ARCHITECTS

139 NOE STREET
SAN FRANCISCO, CA 94114
CONTACT: TOBY MORRIS
E: TOBY@KERMANMORRIS.COM
T: (415) 749-0302

STRUCTURAL ENGINEER: TBD

CONTRACTOR: TBD

DESCRIPTION OF WORK

THE PROJECT CONSISTS OF ADDITIONS AND ALTERATIONS TO AN EXISTING TWO STORY/2-UNIT BUILDING THAT IS A KNOWN HISTORIC RESOURCE (CLASS "A"). WORK CONSISTS OF EXCAVATION TO CREATE A NEW STREET/BASEMENT LEVEL THIRD DWELLING UNIT (FLAT) WITH EXPOSURE TO FRONT AND REAR; RENOVATION OF THE EXISTING FIRST AND SECOND FLOORS; AND REAR/HORIZONTAL AND VERTICAL/THIRD FLOOR ADDITIONS. THE COMPLETED BUILDING WILL CONSIST OF 3 DWELLING UNITS ON THIS RH-3 LOT. NO PARKING IS PROPOSED AND THE MAJORITY OF THE EXISTING FRONT YARD WILL REMAIN (SMALL PATH CREATED FOR ACCESS TO NEW UNIT). WORK HAS BEEN MINIMIZED TO THE HISTORIC FACADE

ALL WORK TO COMPLY WITH CURRENT LOCAL AND STATE CODES INCLUDING BUT NOT LIMITED TO: THE 2016 EDITION OF THE CALIFORNIA BUILDING CODE, THE CALIFORNIA PLUMBING CODE, THE CALIFORNIA MECHANICAL CODE, THE CALIFORNIA ELECTRICAL CODE AND THE CALIFORNIA FIRE CODE, THE CURRENT EDITION OF THE SAN FRANCISCO BUILDING AND PLANNING CODES, TITLE-24 ENERGY STANDARDS, GYPSUM FIRE RESISTANCE DESIGN MANUAL (20TH EDITION), ETC...

SITE PERMIT

10/28/2020 RESPONSE TO PCL #1 SFDBI BPA#: BPA#2019-1108-6888

PROJECT TO BE FULLY SPRINKLERED TO NFPA 13R UNDER SEPARATE PERMIT

1216 FULTON
1216 FULTON STREET

1216 FULTON STREET SAN FRANCISCO, CA 94117

BPA#2019-1108-6888

BLOCK / LOT: 1180/009

These drawings and specifications are the property and copyright of Kerman/Morris Architects and shall not be used on any other work except by written agreement with

Kerman/Morris Architects.

The Contractor shall verify all existing conditions. Written dimensions take preference over scaled dimensions and shall be verified on the project site. Any discrepancy shall be brought to the attention of Kerman Morris Architects prior to the

commencement of any work.

These drawings are an industry standards builders set for building permit and to assist the contractor is construction. The drawings show limited and only

representative/typical details.

All attachments, connections, fastenings,etc, are to be properly secured in conformance with best practice, and the Contractor shall be

responsible for providing and installing them.

COVER SHEET

DATE 09/25/2020

SCALE 1/8" = 1'-0"

DRAWN BY SC

CHECKED BY BZ

G0.01

JOB NO.

OBI PERMIT

ARRDE\/IATIONS

FTS FABRIC COVERED TACK SURFACE

FURG FURRING

| <u>ABE</u> | <u>BREVIATIONS</u> | | | |
|--------------|--|-------------|---------------------------------------|------------|
| & | AND | GA | GAUGE | S |
| @ | AT | GALV | GALVANIZED | SCD |
| 0 | DEGREES | GC | GENERAL CONTRACTOR | SCHED |
| Ø | DIAMETER OR ROUND | GEN | GENERAL | SD |
| (E) | EXISTING | GFIC | GROUND FAULT INTERRUPT | SECT |
| (N) | NEW | | CIRCUIT | SED |
| ' | FOOT / FEET | GND | GROUND | SF |
| " | INCH / INCHES | GWB | GYPSUM WALL BOARD | SFD |
| % | PERCENT | GYP | GYPSUM | CLIT |
| ± | PLUS / MINUS | LID | HOSE BIB | SHT SIM |
| # | POUND OR NUMBER | HB HD | HEAVY DUTY | SIM |
| AD | ANGLIOD DOLT | пD НМ | HOLLOW METAL | SMD |
| AB ADD'L | ANCHOR BOLT ADDITIONAL | HORZ | HORIZONTAL | SOG |
| ADD L ADJ | ADJACENT | HR | HOUR | SPD |
| AFF | ABOVE FINISH FLOOR | HSS | HOLLOW STEEL SECTION | SPEC |
| ALT | ALTERNATE | HT | HEIGHT | SQ |
| ALUM | ALUMINUM | HVAC | HEATING, VENTILATING, AND | SS/SST |
| | (APPROXIMATE | | AIR CONDITIONING | SSD |
| ARCH | ARCHITECTURAL | HWH | HOT WATER HEATER | STC |
| | | | | STD |
| B.O. | BOTTOM OF | IN | INCH OR INCHES | STL |
| BD | BOARD | INS | INSULATE / INSULATION / INSULATING | STRL |
| BLDG | BUILDING | INT | INTERIOR | SUSP |
| | | 1141 | IVILIUOIX | SYM |
| CAB | CABINET | J BOX | JUNCTION BOX | SYST |
| CBC | CALIFORNIA BUILDING CODE | JT | JOINT | T&B |
| CEC | CALIFORNIA ENERGY CODE | | | T&G |
| CEM CER | CEMENT CERAMIC | L | ANGLE / LONG / LENGTH | T.O. |
| CER | CUBIC FEET | LAV | LAVATORY | T/TRD |
| CFC | CALIFORNIA FIRE CODE | LBS | POUND / POUNDS | TB |
| CFCI | CONTRACTOR FURNISHED, | LF | LINEAR FEET | TEMP |
| 01 01 | CONTRACTOR INSTALLED | LVL | LEVEL | THK |
| CFOI | CONTRACTOR FURNISHED, | LWC | LIGHT WEIGHT CONCRETE | TOB |
| | OWNER INSTALLED | | | TOC |
| CJ | CONTROL JOINT | MAX | MAXIMUM | TOS |
| CL | CENTER LINE | MECH | MECHANICAL | TP |
| CLG | CEILING | MFR MH | MANUFACTURER MANHOLE | TYP |
| CLR | CLEAR | MIN | MINIMUM | |
| CMU COL | CONCRETE MASONRY UNIT COLUMN | MISC | MISCELLANEOUS | UON |
| CONC | CONCRETE | MTD | MOUNTED | V |
| CONST | CONSTRUCTION | MTG | MOUNTING | v VERT |
| CONT | CONTINUOUS | MTL | METAL | VERT |
| CPC | CALIFORNIA PLUMBING CODE | | | VPFAM |
| CPT | CARPET | N | NORTH | VIIIVI |
| CTR | CENTER | N/A | NOT APPLICABLE | |
| | | NIC | NOT IN CONTRACT | W |
| d | PENNY | NO | NUMBER | W/ |
| DBL | DOUBLE | NRC | NOISE REDUCTION COEFFICIENT | W/O |
| DEPT | DEPARTMENT | NTS | NOT TO SCALE | WC |
| DF | DOUGLAS FIR | NIO | NOT TO SOALE | WD |
| DH | DOUBLE HUNG | OC | ON CENTER | WDW WH |
| DIA DIM | DIAMETER DIMENSION | OFCI | OWNER FURNISHED, | WP |
| DIN | DOWN | | CONTRACTOR INSTALLED | WPT |
| DP | DRAIN PIPE | OFOI | OWNER FURNISHED, OWNER | WRB |
| DR | DOOR | OLL | INSTALLED | WT |
| DS | DOWNSPOUT | OH OPNG | OPPOSITE HAND | |
| DTL | DETAIL | UFING | OPENING | Х |
| DWG | DRAWING | PL | PROPERTY LINE | |
| | | PLAM | PLASTIC LAMINATE | |
| E | EAST | PLUMB | PLUMBING | |
| EA | EACH | PLY/PLY | PLYWOOD | |
| EERO | EMERGENCY ESCAPE AND RESCUE OPENING(S) | WD | | |
| EL | ELEVATION | POC | POINT OF CONNECTION | |
| ELEC | ELECTRICAL | PSF | POUNDS PER SQUARE FOOT | |
| ELEV | ELEVATOR / ELEVATION | PSI | POUNDS PER SQUARE INCH | |
| EQ | EQUAL | PTDF | PRESSURE TREATED DOUGLAS FIR | |
| EQUIP | EQUIPMENT | PTN | PARTITION PARTITION | |
| EXT | EXTERIOR | PV | PHOTOVOLTAIC | |
| | | | | |
| FA | FIRE ALARM | R | RADIUS (IN DIMENSION) / | |
| FC | FOOT-CANDLE | _ | RISER | |
| FDC | FLOOR DRAIN | RAD | RADIUS | |
| FDC | FIRE DEPARTMENT CONNECTION | RCP | REFLECTED CEILING PLAN | |
| FDN | FOUNDATION | RD DEE | ROOF DRAIN | |
| FE | FIRE EXTINGUISHER | REF REFR | REFERENCE REFRIGERATOR | |
| FEC | FIRE EXTINGUISHER W/ | REG | REGISTER | |
| | CABINET | REINF | REINFORCED | |
| FF | FINISH FLOOR | REQ | REQUIRED | |
| FIN | FINISH | RM | ROOM | |
| FLR | FLOOR / FLOORING | RO | ROUGH OPENING | |
| FLUOR | FLUORESCENT | RWD | REDWOOD | |
| FO FOC | FACE OF FACE OF CONCRETE / CURB | RWL | RAIN WATER LEADER | |
| FOF | FACE OF FINISH | | | |
| FOS | FACE OF STUD | | | |
| FT | FOOT OR FEET | | | |
| FTG | FOOTING | | | |
| FTS | FABRIC COVERED TACK | | | |

GENERAL NOTES

A. GENERAL NOTES:

SOUTH

SEE CIVIL DRAWINGS

STORM DRAIN

SQUARE FEET

SLAB ON GRADE

SPECIFICATIONS

STAINLESS STEEL

DRAWINGS

SHEET

SIMILAR

SQUARE

STANDARD

STRUCTURAL

SUSPENDED

SYMETRICAL

TOP AND BOTTOM TONGUE AND GROOVE

SYSTEM

TOP OF

TREAD

THICK

TOWEL BAR **TEMPORARY**

TOP OF BEAM

TOP OF SLAB

TOILET PAPER TYPICAL

VOLTAGE / VOLT VERTICAL

VERIFY IN FIELD

TOP OF CONCRETE

UNLESS OTHERWISE NOTED

VAPOR PERMEABLE FLUID

APPLIED MEMBRANE

WEST / WIDTH / WIDE

WITH

WITHOUT

WOOD

WINDOW

WEIGHT

BY

WATER CLOSET

WATER HEATER

WORKING POINT

WATERPROOF(ING)

WEATHER RESISTIVE BARRIER

STEEL

SECTION

SCHEDULE / SCHEDULING

SEE ELECTRICAL DRAWINGS

SEE LANDSCAPE DRAWINGS

SEE MECHANICAL DRAWINGS

SEE STRUCTURAL DRAWINGS

SOUND TRANSMISSION CLASS

SEE PLUMBING DRAWINGS

SEE FIRE PROTECTION

1. THE CONTRACTOR SHALL PROVIDE COMPLETE PROJECT SYSTEMS AND COMPONENTS AND COMPLY WITH ALL REQUIREMENTS INDICATED ON THE PROJECT DOCUMENTS.

2. WORK WITHIN THE AREA BOUNDARIES INDICATED IN THE PROJECT DOCUMENTS AND COMPLY WITH ALL APPLICABLE BUILDING CODE, REGULATION, & ORDINANCE REQUIREMENTS. OCCUPANTS ADJACENT TO THE PROJECT AREA BOUNDARIES SHALL CONTINUE UNINTERRUPTED OCCUPANCY DURING CONSTRUCTION OF THE PROJECT.

3. VERIFY FIELD CONDITIONS AND COORDINATION WITH THE PROJECT DOCUMENTS PRIOR TO PROCEEDING WITH THE WORK.

4. COORDINATE THE WORK WITH ALL REQUIREMENTS INDICATED IN THE PROJECT DOCUMENTS.

5. PERFORM THE WORK AT THE PROJECT SITE DURING NORMAL BUSINESS HOURS, UNLESS OTHERWISE

6. COORDINATE THE WORK WITH EQUIPMENT, FURNISHINGS AND SYSTEMS PROVIDED BY THE OWNER.

1. "TYPICAL" OR "TYP" INDICATES IDENTICAL COMPLETE SYSTEM SHALL BE PROVIDED FOR EACH

OCCURRENCE OF THE CONDITION NOTED. 2. "SIMILAR" INDICATES COMPLETE SYSTEM AND COMPONENTS SHALL BE PROVIDED COMPARABLE TO THE

CHARACTERISTICS FOR THE CONDITION NOTED. 3. "AS REQUIRED" INDICATES COMPONENTS REQUIRED TO COMPLETE THE NOTED, SYSTEM AS INDICATED IN

THE PROJECT DOCUMENTS, SHALL BE PROVIDED 4. "ALIGN" INDICATES ACCURATELY PROVIDE FINISH FACES OF MATERIALS IN STRAIGHT, TRUE AND PLUMB

RELATION TO ADJACENT MATERIALS.

C. DIMENSIONS:

1. DIMENSIONS ARE INDICATED TO THE CENTERLINE OF THE STRUCTURAL GRID, FACE OF CONCRETE WALL, NOMINAL FACE OF CMU WALL, FACE OF PARTITION AS SCHEDULED, UNLESS OTHERWISE NOTED.

2. ALIGNMENT OF PARTITIONS AND FINISHES AS SCHEDULED SHALL BE STRAIGHT, TRUE & PLUMB. THE

PRIORITY FOR PROJECT DIMENSIONS SHALL BE IN THE FOLLOWING ORDER:

- A. STRUCTURAL DRAWINGS B. LARGE SCALE DETAILS
- C. SMALL SCALE DETAILS D. ENLARGED VIEWS
- E. FLOOR PLANS AND ELEVATIONS
- 3. MINIMUM DIMENSIONS FOR ACCESSIBILITY CLEARANCES AND BUILDING CODE REQUIREMENTS SHALL BE MAINTAINED.

4. FLOOR ELEVATIONS ARE INDICATED TO THE FACE OF THE STRUCTURAL SLAB, UNLESS OTHERWISE NOTED.

5. VERTICAL DIMENSIONS ARE INDICATED FROM THE FLOOR ELEVATION TO FACE OF FINISHED MATERIAL, UNLESS NOTED ABOVE FINISH FLOOR -"AFF".

6. CEILING HEIGHTS ARE INDICATED FROM THE FLOOR ELEVATION TO THE FACE OF SUSPENDED ACOUSTIC PANEL CEILING GRID OR FACE OF FINISH MATERIAL FOR OTHER CEILING TYPES, UON.

7. DIMENSIONS SHOWN ON THE DRAWINGS SHALL INDICATE THE REQUIRED SIZE, CLEARANCE AND DIMENSIONAL RELATIONSHIP BETWEEN PROJECT SYSTEMS AND COMPONENTS. DIMENSIONS SHALL NOT BE DETERMINED BY SCALING THE DRAWINGS.

D. DRAWING SET ORGANIZATION:

"01" INDICATES THE SHEET NUMBER

1. EACH DRAWING SET SHEET IS IDENTIFIED BY THE SHEET NUMBER IN THE LOWER RIGHT HAND CORNER OF THE DRAWING TITLE BLOCK. THE SHEET TITLE PROVIDES A GENERAL DESCRIPTION OF THE CONTENTS OF THE SHEET.

SHEET NUMBER EXAMPLE: A201 "A" INDICATES THE DISCIPLINE THAT CREATED THE DRAWING "2" INDICATES THE DRAWING CATEGORY CONTAINED ON THE SHEET

2. SHEET NUMBERS MAY INCLUDE SUPPLEMENTAL CHARACTERS TO PROVIDE ADDITIONAL INFORMATION, SUCH AS DRAWING CONTENT, PROJECT SECTOR OR PHASE. REFER TO THE DRAWING INDEX FOR A COMPLETE LIST OF SHEETS INCLUDED IN THE DOCUMENT SET. EXAMPLE: EL201A

"EL" INDICATES THE DISCIPLINE THAT CREATED THE DRAWING AND THE DRAWING CONTENT =

ELECTRICAL LIGHTING "A" INDICATES SECTOR "A" OF PLAN SHEET "201". REFER TO THE PROJECT KEY PLAN OR COMPOSITE PLAN INDICATING THE RELATIONSHIP OF THE SECTORS.

3. DRAWING SET INDEX INDICATES THE COMPLETE LIST OF SHEETS CONTAINED IN THE DRAWING SET, INDEXED BY DISCIPLINE, SHEET NUMBER AND SHEET TITLE, IN SEQUENTIAL ORDER. NOTE THAT ALL SEQUENTIAL SHEET NUMBERS MAY BE NOT USED IN THE DRAWING SET.

4. DISCIPLINE IDENTIFICATION, IN ORDER BOUND IN THE DRAWING SET. REFER TO THE DRAWING SET INDEX FOR DISCIPLINE CONTAINED IN THIS DRAWING SET:

G GENERAL INFORMATION Q EQUIPMENT C CIVIL F FIRE PROTECTION

L LANDSCAPE P PLUMBING S STRUCTURAL M MECHANICAL A ARCHITECTURAL E ELECTRICAL T TELECOMMUNICATIONS I INTERIORS

5. DRAWING CATEGORY IDENTIFICATION. REFER TO THE DRAWING SET INDEX FOR DISCIPLINES, CATEGORIES AND SHEET NUMBERS CONTAINED IN THIS DRAWING SET:


kerman


architects i 139 Noe Street San Francisco, CA

415 749 0302

morris

Revisions

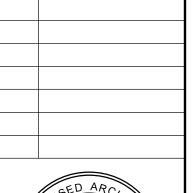

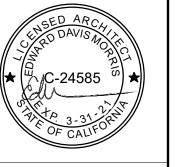

1216 FULTON 1216 FULTON STREET SAN FRANCISCO, CA 94117

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installing them.

ABBREVIATIONS SYMBOLS, & GENERAL NOTES

11/08/2019

SCALE 1" = 1'-0" DRAWN BY CHECKED BY JOB NO.

DATE

| ZONING INFORMATION & PLANNING CODE ANALYSIS | | | | | | |
|--|---------------------|---|--------------------|---|--|--|
| ADDRESS: 1216 FULTON STREET, SAN F | FRANCISCO, CA 94117 | | ORIGINAL FILING: | | | |
| BLOCK / LOT: 1180/009 | , | | HISTORIC STANDING: | A - HISTORIC RESOURCE PRESENT | | |
| Торіс | Code Section | Required / Allowed | Existing Provided | | | |
| ZONE/MAP | MAP ZN02 | RH-3 | | RESIDENTIAL-HOUSE, THREE FAMILY | | |
| PERMITTED USE | SFPC 207 | RESIDENTIAL, HOUSE | | RESIDENTIAL HOUSE | | |
| DWELLING UNIT DENSITY LIMIT | SFPC 207 | UP TO THREE UNITS PER LOT. | 2 DWELLING UNITS | 3 DWELLING UNITS | | |
| F.A.R | SFPC 124 | 1.8 TO 1 FOR NON-RESIDENTIAL USES | N/A | N/A | | |
| HEIGHT | SFPC 260 | 40-X (40' MAXIMUM HEIGHT) | 32'-6" | 37'-3" | | |
| BULK LIMIT | SFPC 270 | X = NO BULK LIMIT | N/A | N/A | | |
| FRONT YARD SETBACK | SFPC 132 | REQUIRED. BASED ON AVERAGE OF ADJACENT PROPERTIES OR IF SUBJECT PROPERTY HAS A LEGISLATED SETBACK. WHEN FRONT SETBACK IS BASED ON ADJACENT PROPERTIES, IN NO CASE SHALL THE REQUIRED SET BACK BE GREATER THAN 15 FEET | 18'-0" | KEEP EXISTING CONDITION, NO CHANGE. | | |
| REAR YARD SETBACK | SFPC 134(a)(2) | 45% OF LOT DEPTH OR AVERAGE OF ADJACENT NEIGHBORS. IF AVERAGED, NO LESS THAN 25% OR 15 FEET, WHICHEVER IS GREATER. | 63'-6" | 53'-3" FROM AVERAGE OF ADJACENT BUILDING. WITH EXCEPTION FROM SEC. 136(C)(25), EXCEPT IN REQUIRED SIDE YARDS, DECKS, AND ENCLOSED AND UNENCLOSED EXTENSIONS OF BUILDINGS, THE STRUCTURE SHALL EXTEND NO MORI THAN 12 FEET INTO THE REQUIRED OPEN AREA; AND SHALL NOT OCCUPY ANY SPACE WITHIN THE REAR 25 PERCENT OF THE TOTAL DEPTH OF THE LOT, OR WITHIN THE REAR 15 FEET OF THE DEPTH OF THE LOT, WHICHEVER IS GREATER. | | |
| USABLE OPEN SPACE FOR DWELLING UNITS | SFPC TABLE 135(a) | MIN. 100 sqft REQUIRED FOR PRIVATE, AND 133 sqft REQUIRED IF COMMON | 320 sqft | ALL UNITS HAVE COMPLYING PRIVATE OPEN SPACE; SEE PROJECT SUMMARY CHART BELOW | | |
| OBSTRUCTIONS | SFPC 136 | ALLOWED | | KEEP EXISTING CONDITION, NO CHANGE. | | |
| OFF-STREET PARKING | SFPC 151.1 | NONE REQUIRED. UP TO 1.5 CARS FOR EACH DWELLING UNIT. | N/A | NO PARKING PROPOSED | | |
| BICYCLE PARKING | SFPC 155.1 | (1) CLASS 1 SPACE PER UNIT | N/A | (3) CLASS 1 SPACES PROVIDED. | | |
| STREETSCAPE AND PEDESTRIAN IMPROVEMENTS (STREET TREES) | SFPC 202.2 | REQUIRED. | (1) EXISTING TREE | KEEP EXISTING CONDITION, NO CHANGE. | | |
| RESIDENTIAL DESIGN GUIDELINES | SFPC 311 | SUBJECT TO THE RESIDENTIAL DESIGN GUIDELINES. | | | | |

| PROJECT SUMMARY | | | | | |
|-----------------|----------|-----------|----------------|--------------|---------------|
| | | | DWELLING LINIT | EXTERIOR OPE | N SPACE (NET) |
| LEVEL | BEDROOMS | BATHROOMS | DWELLING UNIT | PRIVATE | COMMON |
| UNIT A | | | | | |
| BASEMENT | 3 | 2.5 | 1432 SF | 153 SF | 0 SF |
| | - | | 1432 SF | 153 SF | 0 SF |
| UNIT B | | | | | |
| FIRST FLOOR | 3 | 2.5 | 1468 SF | 806 SF | 0 SF |
| | | | 1468 SF | 806 SF | 0 SF |
| UNIT C | | | | | |
| FIRST FLOOR | 0 | 0 | 52 SF | 0 SF | 0 SF |
| SECOND FLOOR | 3 +DEN | 2 | 1353 SF | 235 SF | 0 SF |
| THIRD FLOOR | 0 | 0.5 | 817 SF | 281 SF | 0 SF |
| | | | 2222 SF | 516 SF | 0 SF |
| GRAND TOTAL: | 9+DEN | | 5123 SF | 1475 SF | 0 SF |


| GROSS BUILDING AREA BREAKDOWN | | | | | | | |
|--------------------------------------|----------|------------|---------|--|--|--|--|
| BY FLOOR (ENCLOSED AREA) | | | | | | | |
| LEVEL | EXISTING | ADDITIONAL | TOTAL | | | | |
| | | | | | | | |
| (N) BASEMENT | 1169 SF | 469 SF | 1638 SF | | | | |
| FIRST FLOOR | 1246 SF | 466 SF | 1712 SF | | | | |
| SECOND FLOOR | 1267 SF | 214 SF | 1482 SF | | | | |
| THIRD FLOOR | 0 SF | 905 SF | 905 SF | | | | |
| | 3682 SF | 2055 SF | 5737 SF | | | | |

| | | | | | RTMENT CODE A | |
|--------|--|------------------------------|--|-------------|---------------------------------------|--|
| | | | * SEE G0.06. | 1 | G0.06.2 FOR ADDITIONAL INFORMA | ATION |
| # | Description | Code Ref. (CBC, U.O.N.) | Allowable | Min/ Max | Proposed | Comments |
| - GE | NERAL PROJECT INFORMATION | | | | | |
| 1.1 | TYPE OF CONSTRUCTION | 602.1 | | | TYPE V-A | |
| 1.2 | OCCUPANCY CLASSIFICATION | 310.4 | | | R-2 (3 UNITS) | |
| 1.3 | HIGH-RISE BUILDING CLASSIFICATION | 403.1 | N/A | | N/A | |
| | TICLIT AND ADEA LIMITATIONS | | | | | |
| | EIGHT AND AREA LIMITATIONS BUILDING HEIGHT | Table 504.3 & | 40'-0" | Max. | 37'-3" | |
| | | 508.4.3 | | | | |
| 3.2 | BUILDING STORIES ABOVE GRADE | Table 504.4 & 508.4.3 | R-3: 3 | Max. | 3-STORY O/ BASEMENT | |
| 3.3 | LARGEST STORY AREA | Table 506.2 | 7,000 SF | Max. | 1,712 SF | Largest Story = First Floor |
| 3.4 | TOTAL BUILDING AREA | | , | | 5,742 SF | Total Gross Building Area |
| | | | | | | |
| | RE RESISTANCE RATING REQUIREMENTS | Table CO4 | 4110 | N Air- | 4 UD | T |
| 6.1 | PRIMARY STRUCTURAL FRAME | Table 601 | 1 HR | Min. | 1 HR | Non-combinatible metasial required at autoing well (fire retailed to the fire) |
| | BEARING WALLS - EXTERIOR | Table 601 | 1 HR | Min. | 1 HR | Non-combustible material required at exterior walls (fire-retardant treated wood okay) |
| | BEARING WALLS - INTERIOR | Table 601 | 1 HR | Min. | 1 HR | Non-combinatible metarial required at outside usella (fire extendent to standard to standard) |
| 6.4 | NON-BEARING WALLS - EXTERIOR | Table 601 | Varies - see below | N 4: | Varies - see below | Non-combustible material required at exterior walls (fire-retardant treated wood okay) |
| 6.41 | ` ' | Table 602 | 1 HR | Min. | 1 HR | |
| 6.42 | | Table 602 | 1 HR | Min. | 1 HR | |
| 6.43 | | Table 602 Table 602 | Not Required (NR) | | 0 HR 0 HR | |
| 6.44 | NON-BEARING WALLS - INTERIOR | Table 602 | Not Required (NR) Not Required U.O.N. | | Not Provided U.O.N. below | |
| | | 420, 708 | 1 HR | Min. | 1 HR | Required at all Dwelling Unit demising walls |
| 6.52 | CORRIDORS | Table 1020.1 | 1 HR / NR | Min. | Not Provided | No rating required at single occupancy residential corridors (<10 occupants) |
| 6.6 | FLOOR CONSTRUCTION AND ASSOCIATED SECONDARY MEMBERS | Table 601 and 510.4 | 1 HR | Min. | 1 HR | Only required between units |
| | SECONDARY MEMBERS | Table 601 | 1 HR | Min. | 1 HR | |
| 6.81 | SHAFT ENCLOSURES CONNECTING LESS THAN 4 STORIES | 713.4 | 1 HR | Min. | 1 HR | |
| | DE AND OMOVE PROTECTION FEATURES | | | | | |
| | RE AND SMOKE PROTECTION FEATURES | | | Ī | 1 | T |
| 7.1 | MAXIMUM AREA OF EXTERIOR WALL OPENINGS AND PROTECTION REQUIRED | | | | | |
| 7 10 | WHERE 3' = FSD <5'</td <td>Table 705.8</td> <td>15% OPENING PERMITTED</td> <td>Max.</td> <td><15% OF OPENING, SEE G0.07</td> <td></td> | Table 705.8 | 15% OPENING PERMITTED | Max. | <15% OF OPENING, SEE G0.07 | |
| ı . IZ | WITERE 3 VI- 13D V3 | i dule 700.ŏ | UNPROTECTED, SPRINKLERED | IVIdX. | >10 /0 OF OPENING, SEE GU.U/ | |
| | WHERE 5' = FSD <10'</td <td>Table 705.8</td> <td>25% OPENING PERMITTED UNPROTECTED, SPRINKLERED</td> <td>Max.</td> <td>N/A</td> <td></td> | Table 705.8 | 25% OPENING PERMITTED UNPROTECTED, SPRINKLERED | Max. | N/A | |
| 7.14 | WHERE 10' = FSD <15'</td <td>Table 705.8</td> <td>45% OPENING PERMITTED UNPROTECTED, SPRINKLERED</td> <td>Max.</td> <td>N/A</td> <td></td> | Table 705.8 | 45% OPENING PERMITTED UNPROTECTED, SPRINKLERED | Max. | N/A | |
| | WHERE 15' = FSD <20'</td <td>Table 705.8</td> <td>75% OPENING PERMITTED UNPROTECTED, SPRINKLERED</td> <td>Max.</td> <td>N/A</td> <td></td> | Table 705.8 | 75% OPENING PERMITTED UNPROTECTED, SPRINKLERED | Max. | N/A | |
| 7.16 | WHERE FSD >/= 20' | Table 705.8 | No Limit | | | |
| | DE DOCTECTION OVETENO | | | | | |
| | RE PROTECTION SYSTEMS AUTOMATIC, FULLY SPRINKLERED SYSTEM | 903 and NFPA 13 | Required per CBC 903 and NFPA 13 | | YES, provided per CBC 903 and NFPA 13 | |
| 9.2 | STANDPIPE SYSTEMS | 905 AND NFPA 14 | Not Required | | Not Required | |
| | | 901.8, 913 and NFPA 20 | Not Required | | Not Required | |
| 9.4 | FIRE ALARM AND DETECTION SYSTEM | 907 and NFPA 72 | Required per CBC 907 and NFPA 72 | | YES, provided per CBC 907 and NFPA 72 | |
| | SYSTEM | 907 and NFPA 72 | Not Required | | Not Required | |
| 9.6 | EMERGENCY RESPONDER RADIO COMMUNICATION SYSTEM | 403.4.5, 916, AND CFC 510 | Not Required | | Not Required | |
|) A.A | MEANS OF ECDESS & OCCURANT LOAD | | | | | |
| | IEANS OF EGRESS & OCCUPANT LOAD STAIRWAY WIDTH | 1005.3.1 & 10.11.2 | 36" | Min. | 36" Stairs Provided | The greater of 0.2"/Occupant x 32 Occupants = 6.4" per 1005.3.1 and 36" per 1011.2 Exception 1 (occupant |
| 0.11 | | | | | | less than 50) |

kerman morris architects up

139 Noe Street San Francisco, CA 94114 415 749 0302

Revisions

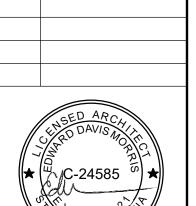

1216 FULTON
1216 FULTON STREET
SAN FRANCISCO, CA 94117

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PLANNING &
PROJECT
INFORMATION,
BUILDING CODE
ANALYSIS

DATE 11/08/2019

SCALE


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CHECKED BY Checker


JOB NO. 1804

SUBJECT BUILDING W/



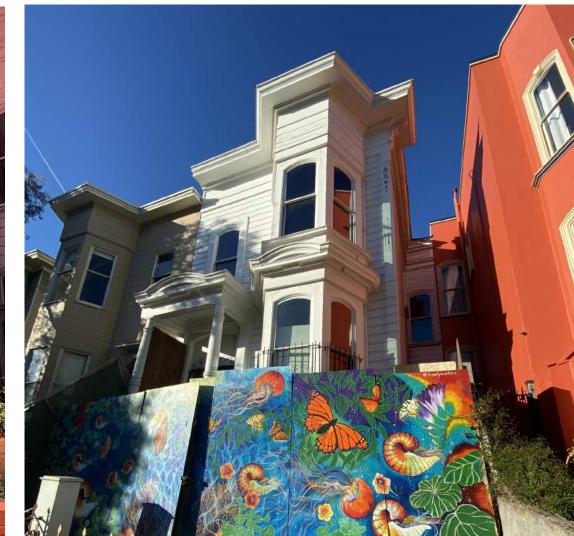


ADJACENT BUILDING (1214 FULTON)

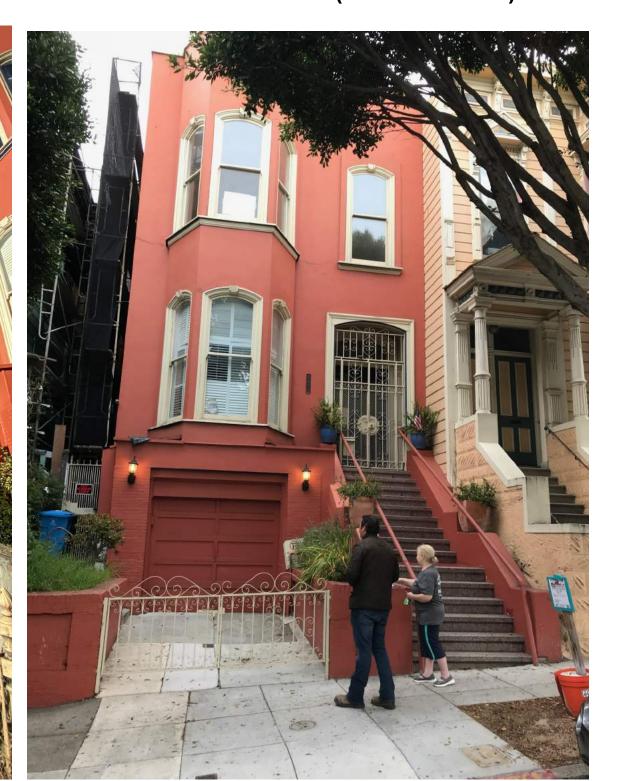


BUILDING ON THE SAME SIDE OF FULTON STREEET




BUILDING ON THE OPPOSITE SIDE OF FULTON STREET

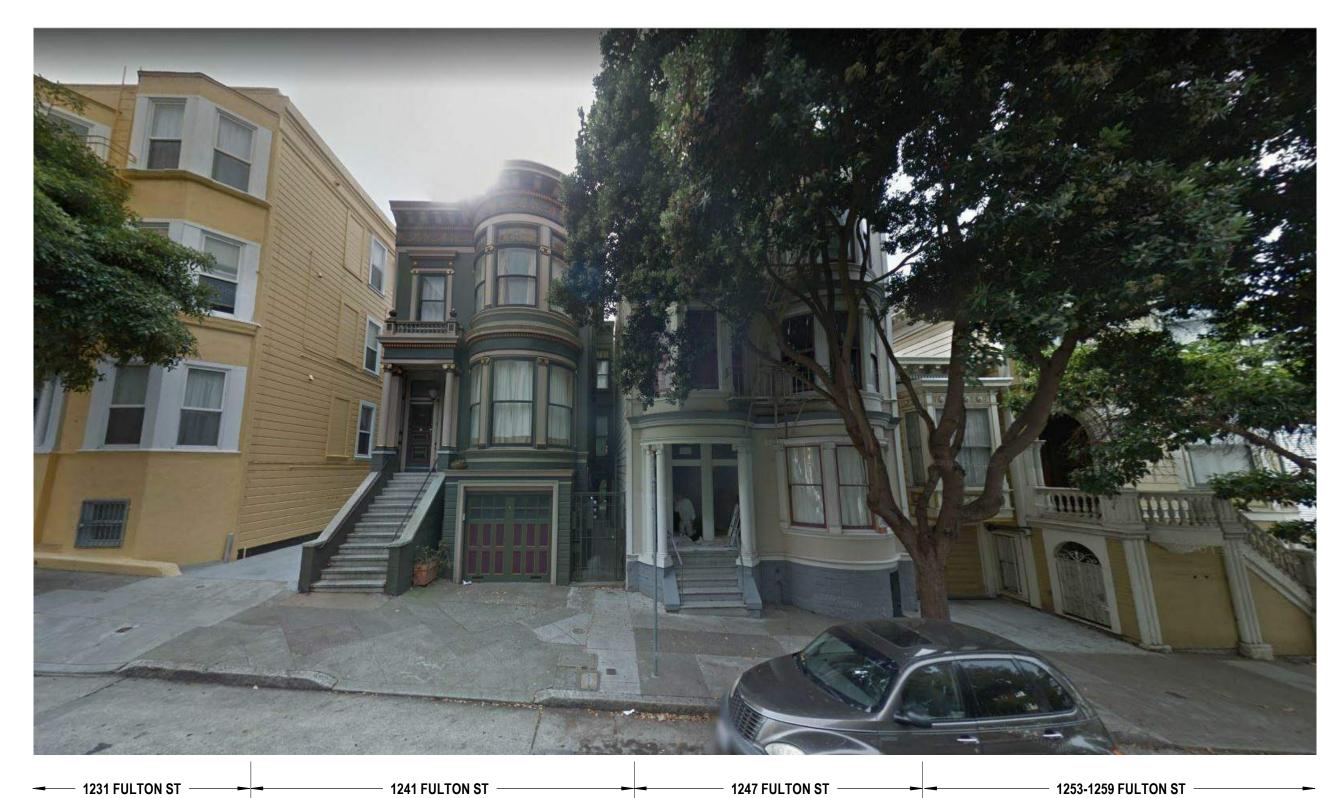

SUBJECT BUILDING W/ ADJACENT BUILDING (1214 FULTON)

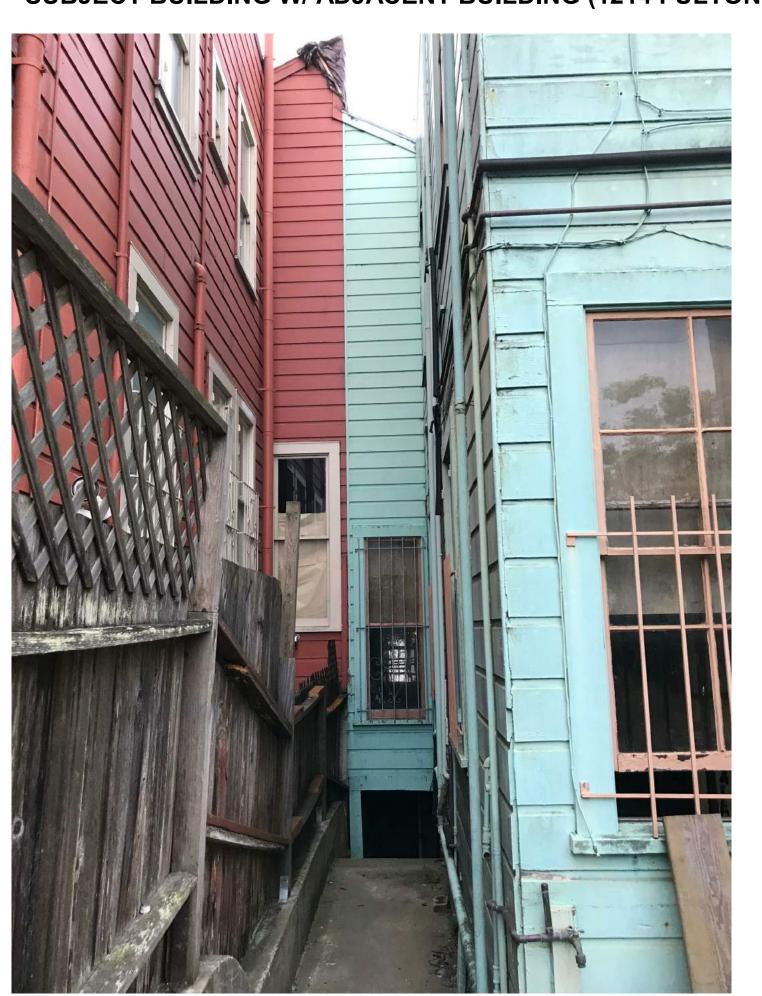

SUBJECT BUILDING REAR FACADE

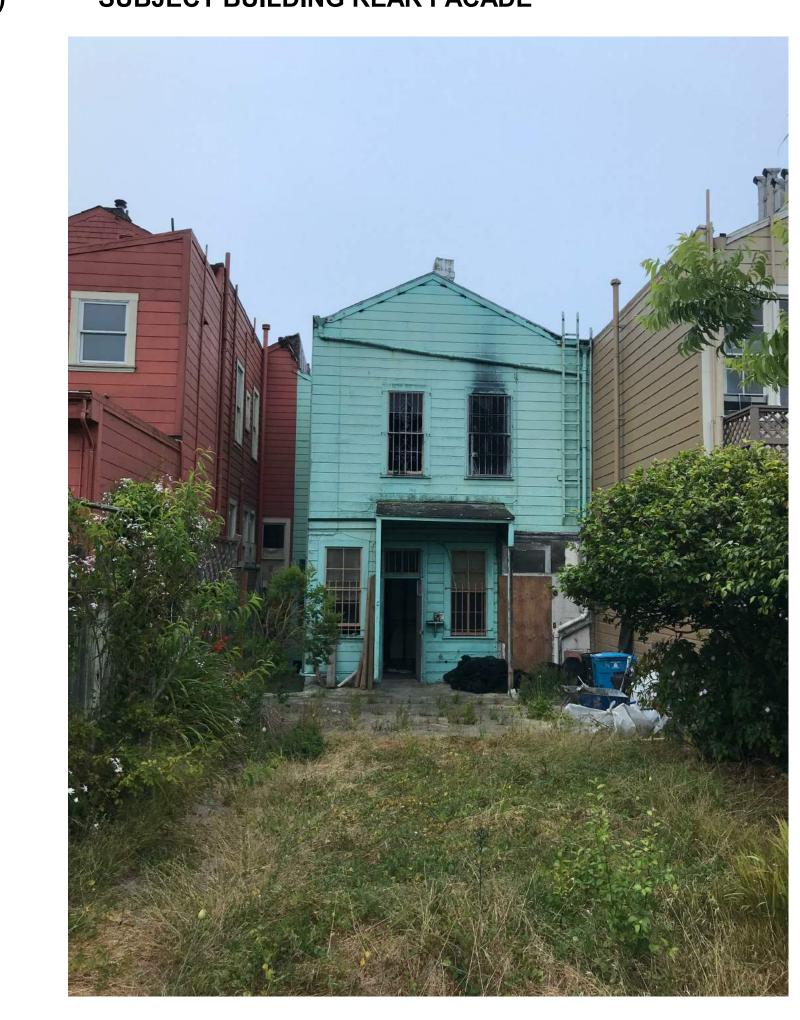

km architects u

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Revisions



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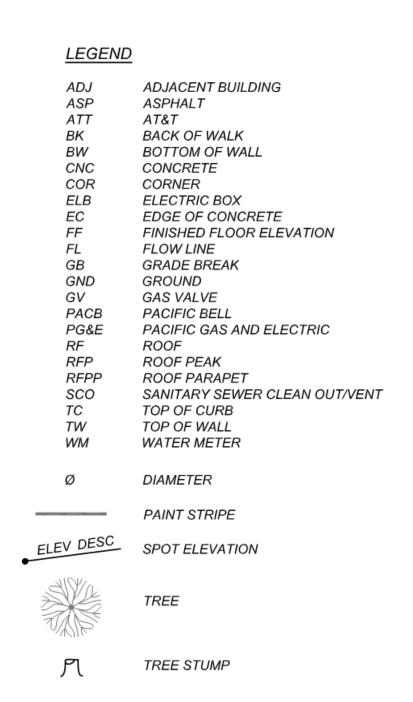
SITE PHOTOS


DATE 11/08/2019 DRAWN BY CHECKED BY


JOB NO.


NOTE: TO ANYONE HAVING ANY TYPE OF INTEREST IN THIS MAP PLEASE BE ADVISED AS FOLLOWS:

- 1. THAT ALL TITLE INFORMATION HEREON INCLUDING EASEMENTS WAS PREPARED SOLELY FOR AND IN STRICT CONFORMANCE WITH OUR CLIENT'S OR HIS AGENT'S REQUIREMENTS AND TITLE INFORMATION SUPPLIED TO FREDERICK T. SEHER & ASSOCIATES, INC.; FURTHERMORE, WE HEREBY DISCLAIM ANY AND ALL TITLE SEARCH RESPONSIBILITY ON THIS JOB.
- 2. NO PRELIMINARY TITLE REPORT WAS REVIEWED IN CONJUNCTION WITH THIS MAPPING. IT IS RECOMMENDED THAT A TITLE REPORT BE RECEIVED FROM THE OWNER TO VERIFY THE EXISTENCE OF ANY ADDITIONAL EASEMENTS OF RECORD OR LOT LINE ADJUSTMENTS THAT MAY HAVE ALTERED THE INFORMATION SHOWN HEREON PRIOR TO ANY DESIGN AND/OR CONSTRUCTION.
- 3. THAT THIS MAP WAS PREPARED AS A PROFESSIONAL INSTRUMENT OF SERVICE FOR TIMOTHY BROWN AND THAT IT REMAINS THE PROPERTY OF FREDERICK T. SEHER & ASSOCIATES, INC. WHETHER THE PROJECT (IF ANY PROPOSED) ON THIS SITE IS CONSTRUCTED OR NOT.
- 4. THAT ANY INFORMATION ON THIS MAP AND ANY DOCUMENT(S) PREPARED BY FREDERICK T. SEHER & ASSOCIATES, INC. IN RELATION HEREOF SHALL NOT BE USED FOR ANY OTHER PURPOSE THAN FOR: BUILDING PERMIT. FURTHERMORE, THE USE OF THIS MAP FOR ANY OTHER PURPOSES WHATSOEVER INCLUDING ENGINEERING DESIGNS OF OFFSITE OR ONSITE IMPROVEMENTS IS BEYOND THIS MAP'S PURPOSES, INTENT & CONTRACT. LIABILITY SHALL REST UPON THE PARTY USING OUR INFORMATION BEYOND THE ESTABLISHED LIMITATION ABOVE, IN WHICH CASE FREDERICK T. SEHER & ASSOCIATES, INC. DISAVOWS ANY AND ALL RESPONSIBILITY.
- 5. THAT ANY IMPROVEMENT CHANGES WITHIN THIS SITE OR THE ADJACENT SITE THEREOF AS WELL AS TITLE TRANSFERS OF THE PROPERTY IN QUESTION (EXCEPT FOR ALTA MAPS) AND/OR THE LAPSE OF 3 OR MORE YEARS FROM THE DATE OF THE MAP (WHICHEVER COMES FIRST) SHALL VOID ALL INFORMATION, HEREON UNLESS A RE-SURVEY IS ORDERED TO RECTIFY, UPDATE OR RE-CERTIFY THIS MAP.
- 6. THAT THIS INFORMATION SHALL NOT BE USED FOR ANY IMPROVEMENT STAKING UNLESS STATED IN ITEM NO. 4
- 7. THAT THE USE OF THIS MAP BY OTHER CONSULTANTS OR CONTRACTORS ON BEHALF OF OUR CLIENT SHALL PROMPT THE IMMEDIATE FULFILLMENTS OF ALL CLIENT'S OBLIGATIONS TO FREDERICK T. SEHER & ASSOCIATES, INC. UNLESS OTHERWISE AGREED TO.
- 8. IT SHALL BE THE RESPONSIBILITY OF THE PROPERTY OWNERS INVOLVED TO RESOLVE ALL ISSUES REGARDING PROPERTY DISPUTES WHICH MAY ARISE OUT OF INFORMATION SHOWN HEREON.
- 9. THIS MAP WILL BE PROVIDED IN AN ELECTRONIC FORMAT AS A COURTESY TO THE CLIENT. THE DELIVERY OF THE ELECTRONIC FILE DOES NOT CONSTITUTE THE DELIVERY OF OUR PROFESSIONAL WORK PRODUCT. A SIGNED PRINT DELIVERED TO THE CLIENT OR CLIENT REPRESENTATIVE CONSTITUTES OUR PROFESSIONAL WORK PRODUCT, AND IN THE EVENT THE ELECTRONIC FILE IS ALTERED, THE PRINT MUST BE REFERRED TO FOR THE ORIGINAL AND CORRECT SURVEY INFORMATION. WE SHALL NOT BE RESPONSIBLE FOR ANY MODIFICATIONS MADE TO THE ELECTRONIC FILE, OR FOR ANY PRODUCTS DERIVED FROM THE ELECTRONIC FILE WHICH ARE NOT REVIEWED, SIGNED AND SEALED BY



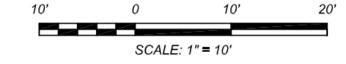

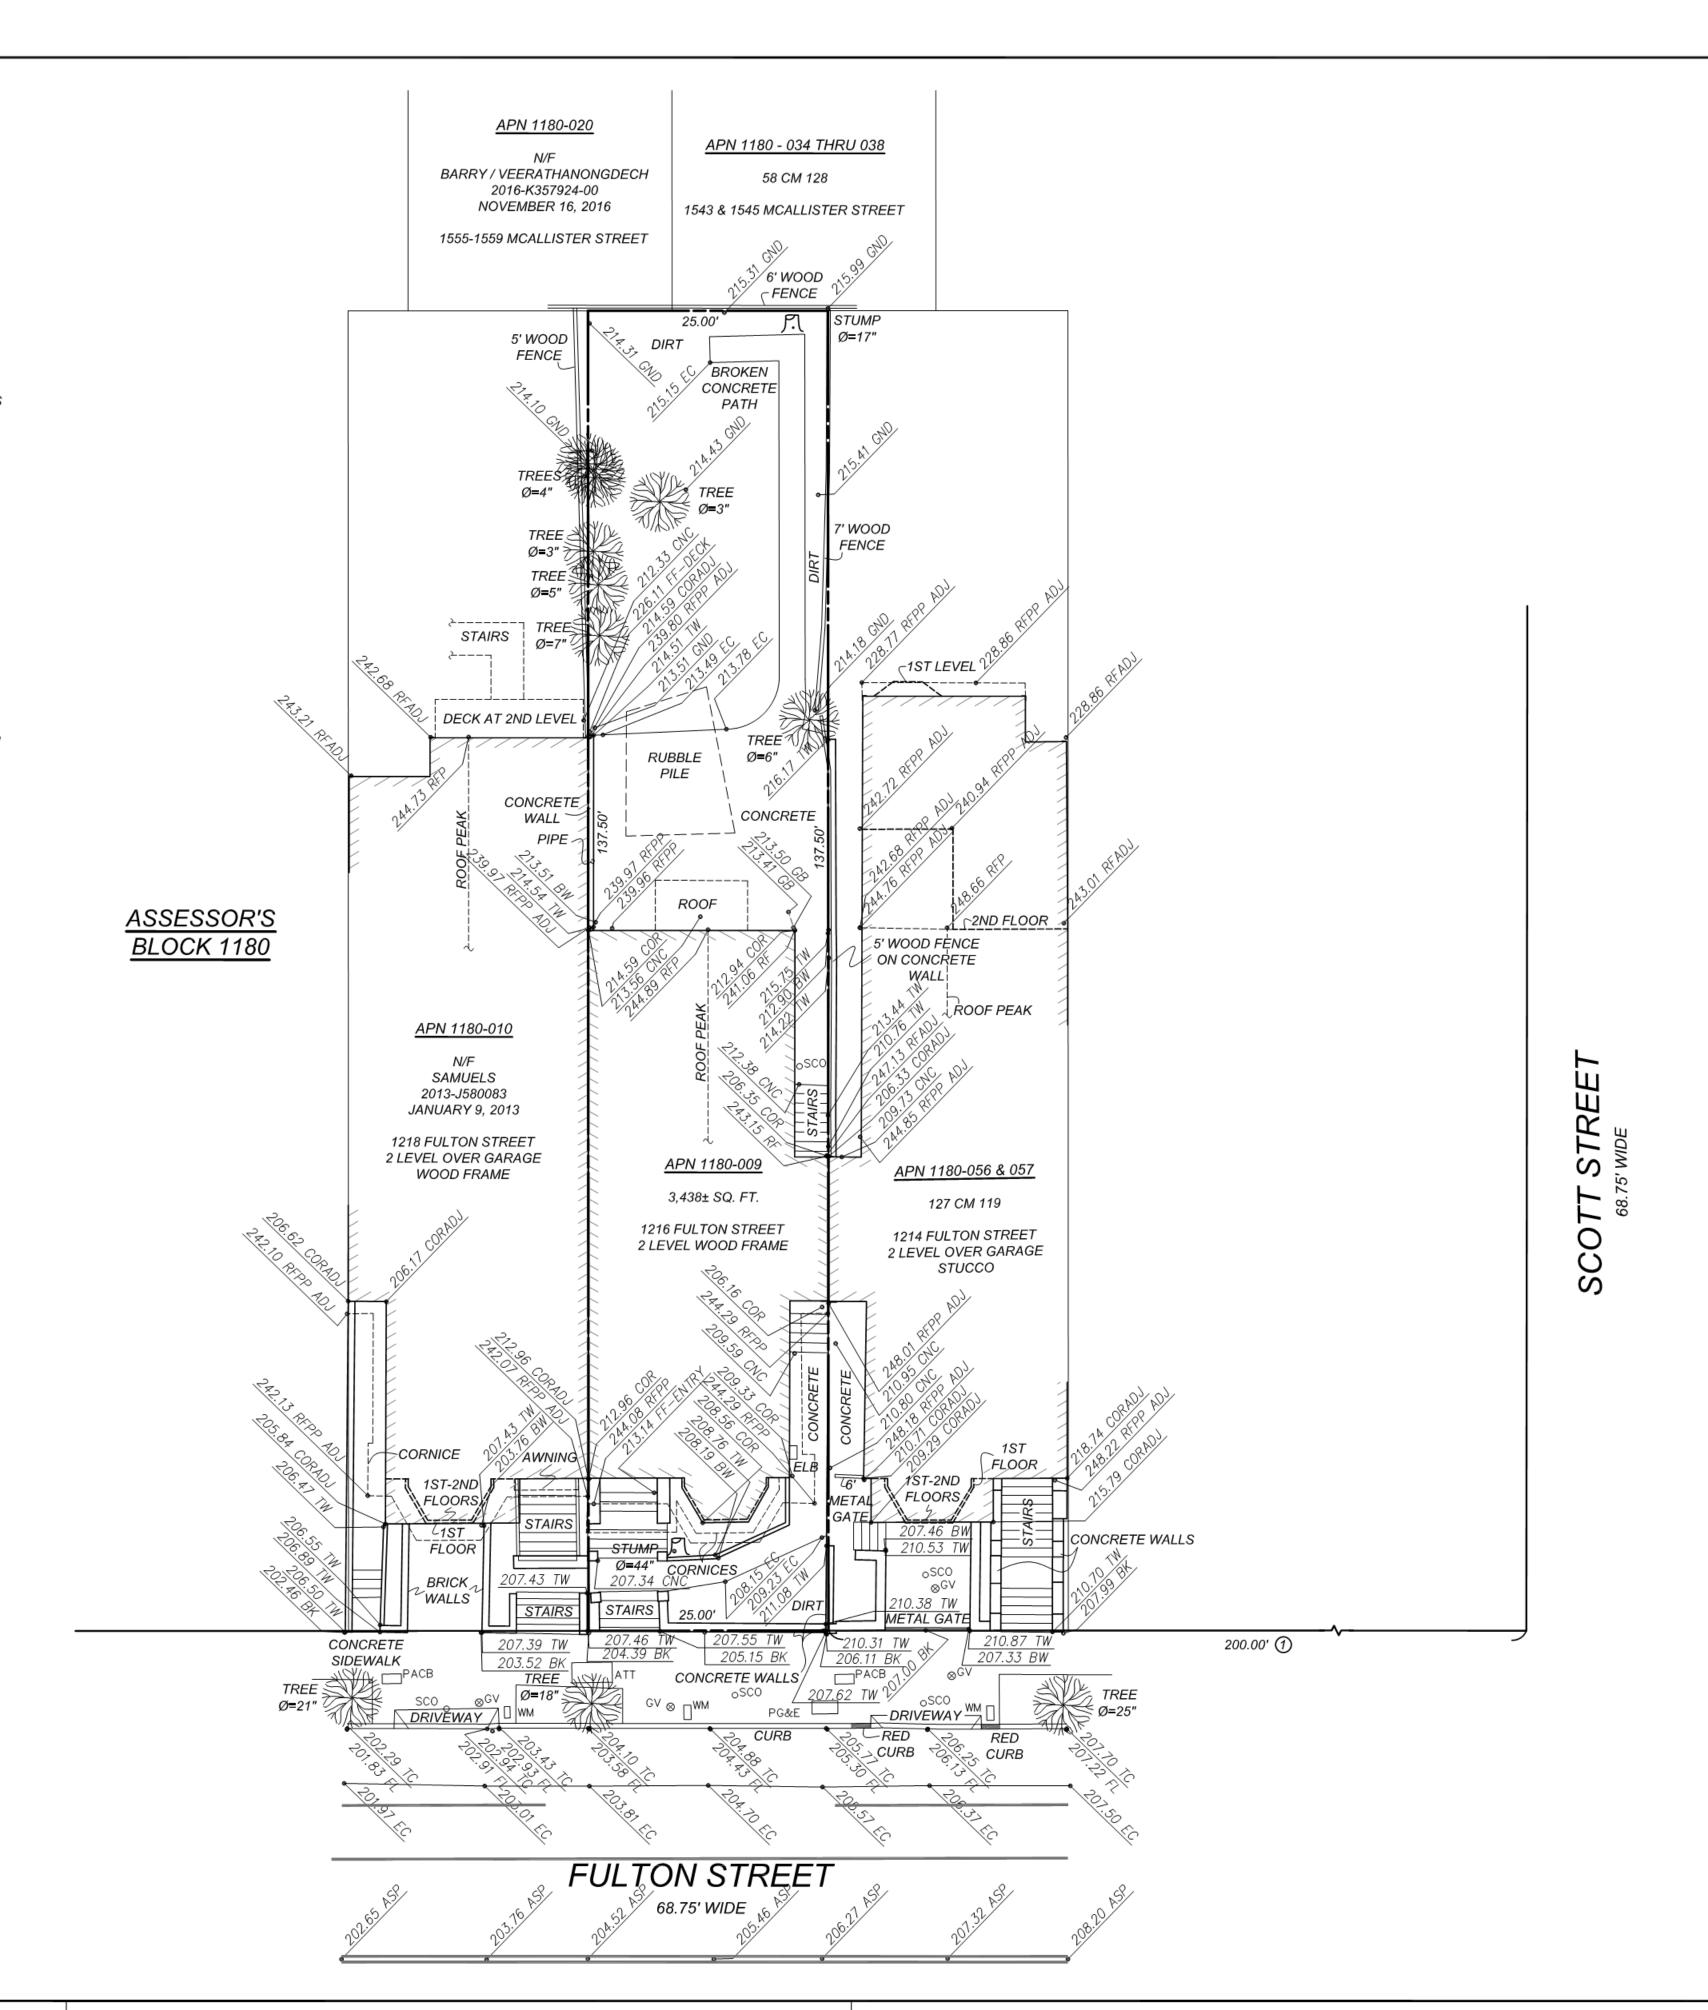

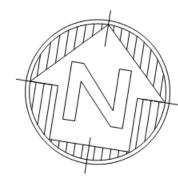

PRELIMINARY FOR REVIEW PURPOSES ONLY

BOUNDARY NOTES:

PROPERTY AND RIGHT-OF-WAY LINES SHOWN HEREON ARE PREDICATED ON AN ANALYSIS OF EXISTING IMPROVEMENTS, RECORD DATA, FIELD TIES AND ASSESSOR'S PARCEL MAPS. IT IS <u>NOT</u> THE INTENT OF THIS MAP TO PROVIDE A FORMAL BOUNDARY RESOLUTION FOR THE SUBJECT PROPERTY SHOWN HEREON. SAID RESOLUTION WOULD REQUIRE THE SETTING OF PROPERTY CORNERS AND THE FILING OF A RECORD OF SURVEY UNDER CALIFORNIA STATE LAW. <u>BOUNDARY INFORMATION SHOWN HEREON IS FOR PLANNING PURPOSES ONLY.</u>

ALL ANGLES ARE 90° UNLESS OTHERWISE NOTED

ALL DISTANCES ARE MEASURED IN FEET AND DECIMALS THEREOF.

DATE OF FIELD SURVEY:

TOPOGRAPHIC INFORMATION SHOWN HERE IS BASED UPON A FIELD SURVEY PERFORMED BY FREDERICK T. SEHER & ASSOCIATES INC. ON OCTOBER 17, 2018.

SURVEY REFERENCE:

THE SURVEY HEREON IS BASED ON THE LEGAL DESCRIPTION DESCRIBED IN THE FOLLOWING GRANT DEED:

APN 1180-009: RECORDED JULY 26, 2018, DOCUMENT NUMBER 2018-K645371-00.

UTILITY NOTE:

UNDERGROUND UTILITIES SHOWN HEREON WERE PLOTTED FROM A COMBINATION OF OBSERVED SURFACE EVIDENCE (CONDITIONS PERMITTING) AND RECORD INFORMATION OBTAINED FROM THE RESPECTIVE UTILITY COMPANIES, AND ARE NOT INTENDED TO REPRESENT THEIR ACTUAL LOCATIONS. THEREFORE, ALL UTILITIES MUST BE VERIFIED WITH RESPECT TO SIZES, HORIZONTAL AND VERTICAL LOCATIONS BY THE OWNER AND/OR CONTRACTOR PRIOR TO DESIGN OR CONSTRUCTION. NO RESPONSIBILITY IS ASSUMED BY THE SURVEYOR FOR THE LOCATION AND CAPACITY OF SAID UTILITIES.

PROJECT BENCHMARK - DESCRIPTION:

ELEVATIONS SHOWN HEREON WERE OBTAINED FROM A GROUP OF CITY BENCHMARKS, LOCATED AT THE INTERSECTION OF FULTON AND SCOTT STREETS, ELEVATIONS ARE BASED ON CITY AND COUNTY OF SAN FRANCISCO DATUM. N.W. CORNER 30'W, + CUT W END LOWER TERRAZZO STEP. ELEVATION = 219.006'

GENERAL NOTE:

THE FOLIAGE LINES OF ALL TREES PLOTTED HEREON ARE SHOWN IN A GRAPHICAL FORM ONLY, AND ARE NOT INTENDED TO REPRESENT ACTUAL DRIPLINES THEREOF.

SURVEYOR'S STATEMENT:

THIS MAP WAS PREPARED BY ME, OR UNDER MY DIRECTION, AND IS BASED UPON A FIELD

TEFREDERICK T. SEHER, PLS

FREDERICK T. SEHER, PL LICENSE NO. 6216

| DATE: OCTOBER, 2018 | | | | |
|-----------------------|-------------|----|------|-----------|
| SCALE: 1" = 10' | \triangle | | | |
| | | | | |
| DRAWN BY: | | | | |
| DRAWING NAME: 2177-18 | \triangle | | | |
| SURVEYED BY:FTS | \triangle | | | |
| CHECKED BY:EF | \triangle | | | |
| | | | | |
| CHECKED BY: | NO. | BY | DATE | REVISIONS |




FREDERICK T. SEHER & ASSOCIATES, INC.
PROFESSIONAL LAND SURVEYORS
SURVEYING & MAPPING
841 LOMBARD STREET, SAN FRANCISCO, CA 94133
(415) 921-7690 FAX (415) 921-7655

ARCHITECTURAL SITE SURVEY ASSESSOR'S PARCEL NUMBER: 1180-009 1216 FULTON STEET, SAN FRANCISCO, CA SHEET

G0.05

F 1 SHEETS

JOB NO.:
2177-18

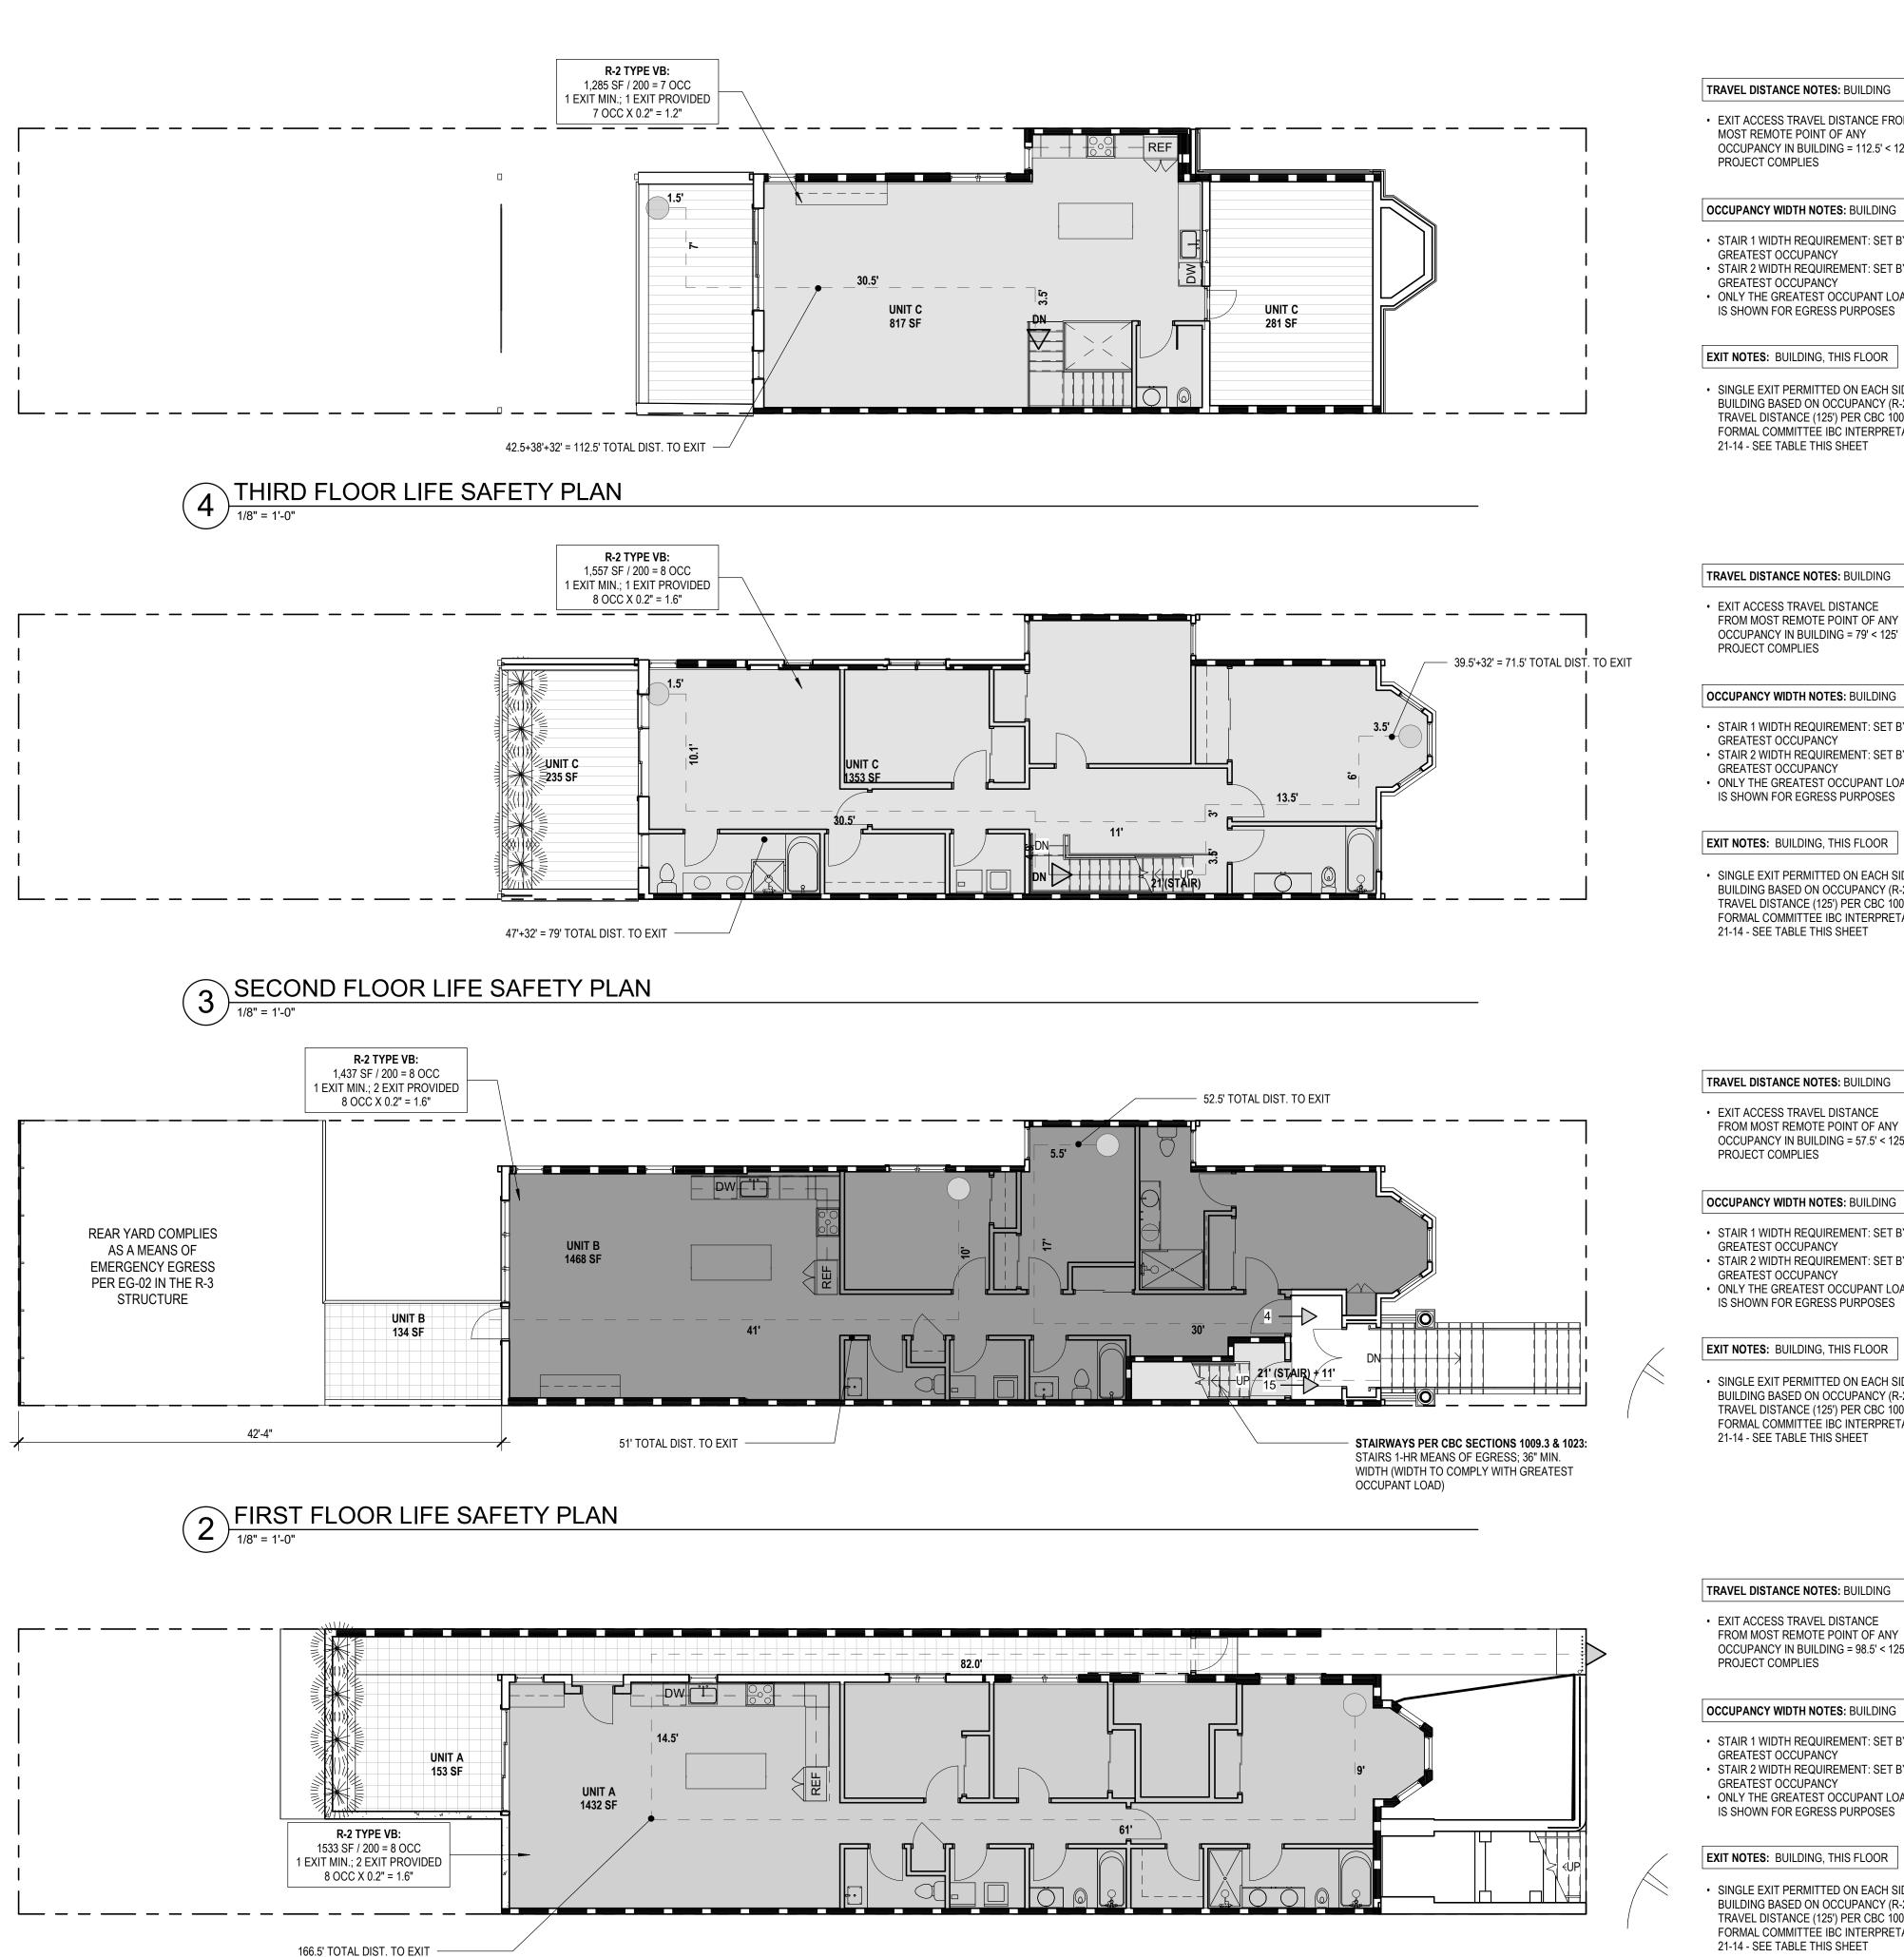

BASEMENT FLOOR LIFE SAFETY PLAN

TRAVEL DISTANCE NOTES: BUILDING

 EXIT ACCESS TRAVEL DISTANCE FROM MOST REMOTE POINT OF ANY OCCUPANCY IN BUILDING = 112.5' < 125' PROJECT COMPLIES

OCCUPANCY WIDTH NOTES: BUILDING

- STAIR 1 WIDTH REQUIREMENT: SET BY
- GREATEST OCCUPANCY
- STAIR 2 WIDTH REQUIREMENT: SET BY GREATEST OCCUPANCY ONLY THE GREATEST OCCUPANT LOAD

EXIT NOTES: BUILDING, THIS FLOOR

 SINGLE EXIT PERMITTED ON EACH SIDE OF BUILDING BASED ON OCCUPANCY (R-2), MAX. TRAVEL DISTANCE (125') PER CBC 1006.3.3 AND FORMAL COMMITTEE IBC INTERPRETATION 21-14 - SEE TABLE THIS SHEET

TRAVEL DISTANCE NOTES: BUILDING

 EXIT ACCESS TRAVEL DISTANCE FROM MOST REMOTE POINT OF ANY OCCUPANCY IN BUILDING = 79' < 125' PROJECT COMPLIES

OCCUPANCY WIDTH NOTES: BUILDING

- STAIR 1 WIDTH REQUIREMENT: SET BY GREATEST OCCUPANCY
- STAIR 2 WIDTH REQUIREMENT: SET BY
- GREATEST OCCUPANCY ONLY THE GREATEST OCCUPANT LOAD

EXIT NOTES: BUILDING, THIS FLOOR

 SINGLE EXIT PERMITTED ON EACH SIDE OF BUILDING BASED ON OCCUPANCY (R-2), MAX. TRAVEL DISTANCE (125') PER CBC 1006.3.3 AND FORMAL COMMITTEE IBC INTERPRETATION 21-14 - SEE TABLE THIS SHEET

TRAVEL DISTANCE NOTES: BUILDING

 EXIT ACCESS TRAVEL DISTANCE FROM MOST REMOTE POINT OF ANY OCCUPANCY IN BUILDING = 57.5' < 125' PROJECT COMPLIES

OCCUPANCY WIDTH NOTES: BUILDING

- STAIR 1 WIDTH REQUIREMENT: SET BY
- GREATEST OCCUPANCY STAIR 2 WIDTH REQUIREMENT: SET BY
- GREATEST OCCUPANCY ONLY THE GREATEST OCCUPANT LOAD
- IS SHOWN FOR EGRESS PURPOSES

EXIT NOTES: BUILDING, THIS FLOOR

 SINGLE EXIT PERMITTED ON EACH SIDE OF BUILDING BASED ON OCCUPANCY (R-2), MAX. TRAVEL DISTANCE (125') PER CBC 1006.3.3 AND FORMAL COMMITTEE IBC INTERPRETATION 21-14 - SEE TABLE THIS SHEET

TRAVEL DISTANCE NOTES: BUILDING

 EXIT ACCESS TRAVEL DISTANCE FROM MOST REMOTE POINT OF ANY OCCUPANCY IN BUILDING = 98.5' < 125' PROJECT COMPLIES

OCCUPANCY WIDTH NOTES: BUILDING

- STAIR 1 WIDTH REQUIREMENT: SET BY GREATEST OCCUPANCY
- STAIR 2 WIDTH REQUIREMENT: SET BY
- GREATEST OCCUPANCY ONLY THE GREATEST OCCUPANT LOAD IS SHOWN FOR EGRESS PURPOSES

EXIT NOTES: BUILDING, THIS FLOOR

 SINGLE EXIT PERMITTED ON EACH SIDE OF BUILDING BASED ON OCCUPANCY (R-2), MAX. TRAVEL DISTANCE (125') PER CBC 1006.3.3 AND FORMAL COMMITTEE IBC INTERPRETATION 21-14 - SEE TABLE THIS SHEET

PARTITION PLAN LEGEND

PARTITION / WALL / STRUCTURE NON-RATED

1-HR RATED

2-HR RATED

- REFER TO LIFE SAFETY PLANS AND WALL TYPES FOR ADDITIONAL INFORMATION

EGRESS PATH OF TRAVEL (WITH # occ.- - - occ.) COMMON PATH OF EGRESS TRAVEL **— —** EXIT ACCESS TRAVEL DISTANCE PATH OF TRAVEL FROM EERO TO EGRESS PATH OF TRAVEL VERTICAL CONTINUATION OF EGRESS AT GROUND FROM EERO ABOVE OR BELOW

USE AND MIN. OCCUPANT LOAD

DIAGONAL DIMENSION OF BUILDING &

EXIT SEPARATION DISTANCE

UNIT A(200 GROSS SF PER OCCUPANT)

UNIT B (200 GROSS SF PER OCCUPANT)

UNIT C (200 GROSS SF PER OCCUPANT)

EGRESS PLAN GENERAL NOTES

- 1. CORRIDORS AND ACCESIBLE ROUTES SHALL COMPLY WITH:
- ENTRANCE SIGNAGE PER CBC SECTION 1110A.2
- GLUE-DOWN CARPET PER CBC SECTION 1110A.3 & SECCTION 804.4.2 LEVEL CHANGES SHALL NOT EXCEED PER CBC SECTIONS 1111A & 1121A
- SLOPES SHALL NOT EXCEED 5% PER CBC SECTION 1111A
- MINIMUM WIDTH PER CBC SECTIONS 1119A.3 EXIT DESCHARGE SHALL COMPLY WITH CBC SECTION 1028.1
- EXIT ENCLOSURES TO COMPLY WITH CBC SECTIONS 1022.1 & 1023.1 -NO FURNISHING WILL BE ALLOWED
- 2. STAIRWAYS SHALL COMPLY WITH:
- SIGNAGE PER CBC SECTION 1023.8 & 1023.9
- TREADS, RISERS AND NOSING PER CBC SECTIONS 1123A STRIPING PER CBC SECTIONS 1123A.5
- BUILDING TO BE EQUIPPED WITH EMERGENCY VOICE ALARM SYSTEM.
- 3. AREAS OF REFUGE **NOT** REQUIRED PER CBC 1009.3, EXCEPTION 5 & 1009.3, EXCEPTION 8
- 4. DOOR FIRE RATING:
- AT 1-HOUR WALLS:
- 20-MINUTE FIRE-RATED DOORS CORRIDORS 45-MINUTE FIRE-RATED DOORS - PROTECTED OPENINGS
- 90-MINUTE FIRE-RATED DOORS STAIR ENCLOSURES


OCCUPANCY SCHEDULE BY FLOOR

| LEVEL | OCCUPANT LOAD (OL) - SCHEDULE ON G0.06 |
|--------------|--|
| | |
| (N) BASEMENT | 5 |
| FIRST FLOOR | 8 |
| SECOND FLOOR | 8 |
| THIRD FLOOR | 7 |
| | 28 |

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EGRESS / PATH OF TRAVEL SITE PLAN

DATE 11/08/2019 SCALE 1/8" = 1'-0' DRAWN BY Author CHECKED BY Checker

JOB NO.

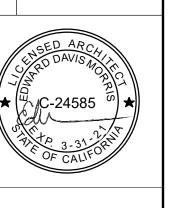P.L. THIRD FLOOR WALL AREA: 377.91 SF OPENING AREA: 40.68 SF 15% OPENING PERMITTED UNPROTECTED, SPRINKLERED PER CBC TABLE 705.8 377.91 SF X 0.15 = 56.68 SF SECOND FLOOR WALL AREA: 683.23 SF OPENING AREA: 54.05 SF 15% OPENING PERMITTED UNPROTECTED, SPRINKLERED PER CBC TABLE 705.8 683.23 SF X 0.15 = 102.48 SF SECOND FLOOR 13' - 0" FIRST FLOOR WALL AREA: 808.5 SF

OPENING AREA: 53.33 SF 15% OPENING PERMITTED UNPROTECTED, SPRINKLERED PER CBC TABLE 705.8 808.5 SF X 0.15 = 121.28 SF FIRST FLOOR
0" ALL WIINDOWS PROTECTED BY 1 HOUR WALL @ P.L. GRADE PLANE (N) BASEMENT -10' - 0" OPENING CALCULATION ELEVATION - EAST

3/16" = 1'-0"

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San Francisco, CA 94114 415 749 0302

Revisions

★ C-24585 TO ARCHAIL CONTROL CONTROL

1216 FULTON
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OPENING CALCULATIONS

DATE 11/08/2019

SCALE 3/16" = 1'-0'

DRAWN BY

CHECKED BY

CF

JOB NO.

December 19, 2019

Plan Review Supervisor for Pre-Application Meeting Department of Building Inspection 1660 Mission Street, 2nd Floor San Francisco, CA 94103

Participants: Irene Wong (SFDBI), Elizabeth Kerman-Morris (KMA), Shao-Lun Chien

PRE-APPLICATION MEETING FINDINGS

1216 Fulton Street Remodel of Existing 2-Story Building and Addition of Level 3 2016 California Building Code

BPA # 2019-1108-6888

PROJECT INFORMATION Address:

Stories:

kerman

morris

architects an

139 Nee Street Son Francisco, CA 94114 415 749 0302 kermaemorris com

11/20/2019

Occupancy:

1216 Fulton Street, San Francisco, CA 94117

1180 / 009 Block/Lot:

2019-1108-6888 Application No.:

Type of Construction: Existing: TYPE-VB NON-SPRINKLERED (non-rated)

Proposed: TYPE-VB, FULLY SPRINKLERED (NFPA 13R

sprinkler system)

Existing: 2 stories O/ basement

Proposed: 3 stories O/ basement Existing: 2-Units (R-3)

Proposed: 2-Units (R-3) (No change)

PROJECT SCOPE

The project proposes the remodel of an existing 2-story, 2-unit building on 1216 Fulton street. New work consists of remodeling first and second floor, converting partial of uninhabited basement floor to a master bedroom and a bedroom to be included in lower unit, and adding one-story to the existing building as a master bedroom of upper unit.

ATTACHED DOCUMENTS:

Enclosed please find a 11x17 set of relevant drawings including a code analysis, plans, and elevations.

Our Basic Code Assumptions to be Confirmed and Questions/ Code Ruling Requested:

GENERAL BUILDING HEIGHT AND AREA

1. Type of Construction: Please confirm that building additions may be up to 40'-0" tall, and 3stories o/ basement per 504.3 and Table 504.4 with the installation of sprinklers throughout the entire building per NFPA 13D, CBC Chapter 9.

Response: Confirmed.

1800

SFDBI

SFDBI

18W

SFDBI

SFDBI

(SM)

Additional Discussion: Per CBC Section 1006.2.1, NFPA 13D is not included in the exception when egress travel distance is more than 75 feet. The project requires NFPA 13R throughout the entire building.

FIRE-RESISTANCE CONSTRUCTION

2. Modified Wall Ratings: Please confirm that the existing walls may be considered 1-hr by adding one layer of 5/8" type-X gypsum board on the interior face of the wall.

Response: Confirmed. Along the property line, the existing walls should be upgraded to 1hr rating.

3. Wall Rating: Please confirm that the exterior walls where FSD less than 5 feet from the property line need only be 1-hr rated per CBC Tables 601 and 602

Response: Confirmed.

4. Exterior Wall Opening: Please confirm that per local, equivalency, windows in the 1-hr rated property line walls may be fixed 3/4 -hr. rated assemblies if the opening is protected by a fire sprinkler system installed as required by AB-009.

Response: Confirmed. Please look at AB-009 fire sprinkler location requirements.

MEANS OF EGRESS

5. Single Exit: Please confirm that only one exit is required in this fully sprinklered building for both unit/spaces on the basement per CBC section 1006.3.1 and Table 1006.3.2(1), provided that the common path of egress travel does not exceed 125 feet.

Response: Confirmed.

6. Roof Access: Please confirm that SFFD access to the roof shall not be required as the building has less than four stories per CBC 1011.12

Response: Confirmed.

7. Door Swing: Door swings are not required to swing in the direction of egress travel because the building occupancy is less than 50 occupants per CBC section 1010.1.2.1

18W **SFDBI** Response: Confirmed.

SFDBI

SFDBI

(SW)

SFDBI

15m

SFDBI

8. Panic Hardware: Panic hardware shall not be required on the doors along the path of egress travel as the occupant load is less than 50 persons per CBC section 1010.1.10

Response: Confirmed.

9. Stair Width: Please confirm that the exit stairs may be 36" wide, per Sec. 1011.2, exception #1 when the occupant load is less than 50.

18W Response: Confirmed. **SFDBI**

10. Applicability: Please confirm that the proposed privately-funded project is subject to neither CBC Chapter 11A nor CBC Chapter 11B.

Response: Confirmed. The project does not require.

11. Parking Accessibility: Please confirm that no accessible parking spaces will be required as CBC Chapter 11A and 11B are not required per question 10 above.

Response: Confirmed. The project does not require.

kerman morris architects ...

139 Noe-Street San Freedisco, CA 94114 415 749 0302 kernanmittis sant

Reviewed and agreed by

Irene Wong, SFDBI

11/20/2019

DBI PRE-APPLICATION MEETING



PHONE #: 415-749-0302

SAN FRANCISCO FIRE DEPARTMENT BUREAU OF FIRE PREVENTION PLAN CHECK DIVISION / WATER FLOW 1660 MISSION STREET, 4TH FLOOR SAN FRANCISCO, CA 94103 Email: WaterflowSFFD@sfgov.org

EMAIL: toby@kermanmorris.com

Phone: 415-558-6361 Payment (VISA/MC): 415-558-6177 (M-F; 8am-4pm)


REQUEST FOR WATER FLOW INFORMATION

(For additional information, see Water Flow FAQs at: https://sf-fire.org/plan-check#waterf)

REQUEST IS FOR: FIRE FLOW- YES X NO SPRINKLER DESIGN- YES NO X DATE: 10/16/2019 CONTACT PERSON: Toby Morris ADDRESS: 139 Noe St., San Francisco, CA 94114

OWNER'S NAME: _Tim Brown PHONE #: 415-334-0100 ADDRESS FOR WATER FLOW INFORMATION: 1216 Fulton St., San Francisco, CA 94117

CROSS STREETS (BOTH ARE REQUIRED): Divisadero St. / Scott St. SPECIFY STREET FOR WATER DEPT CONNECTION: Fulton St.

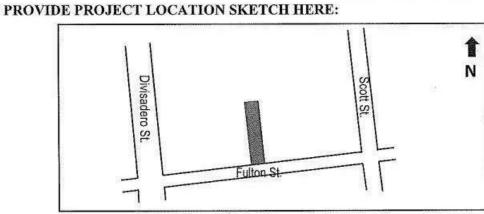

OCCUPANCY TYPE (CIRCLE ONE): R3 (R2) LIVE/WORK COMMERCIAL OTHER_ HAZARD CLASSIFICATION: (LIGHT) ORD 1 ORD 2 EXT 1 EXT 2 OTHER CAR-STACKER: YES (NO) NUMBER OF STORIES: 3-Stories over basement HEIGHT OF BLDG (FT): 36'-6"

- SUBMIT FORM WITH A \$130.00 CHECK (PAYABLE TO "SFFD") OR PAY BY CREDIT CARD (PHONE # ABOVE) REQUESTS REQUIRING A FIELD FLOW TEST WILL BE NOTIFIED BY EMAIL AND AN ADDITIONAL FEE
- OF \$260.00 WILL BE REQUIRED WATER FLOW INFORMATION WILL BE RETURNED BY EMAIL
- INCOMPLETE FORMS WILL NOT BE PROCESSED

PLEASE ALLOW FOR A MINIMUM OF 7 TO 14 BUSINESS DAYS FOR PROCESSING


Flow data provided by: SAMSON Flow data: ☐ FIELD FLOW TEST 62 X RECORDS ANALYSIS Gate Page 30 FLOW _____ 1200 ____ GPM INCH MAIN on _ Fulton


Rev. 09/08/2019

63'-6" EXISTING REAR YARD POTENTIAL TWO-STORY ADDITION ADJACENT PROPERTY: 1218 / 1218A FULTON ST (1180/010) TWO STORIES

1216 FULTON DBI PRE-APPLICATION MEETING

EXISTING SITE PLAN 00 - 01

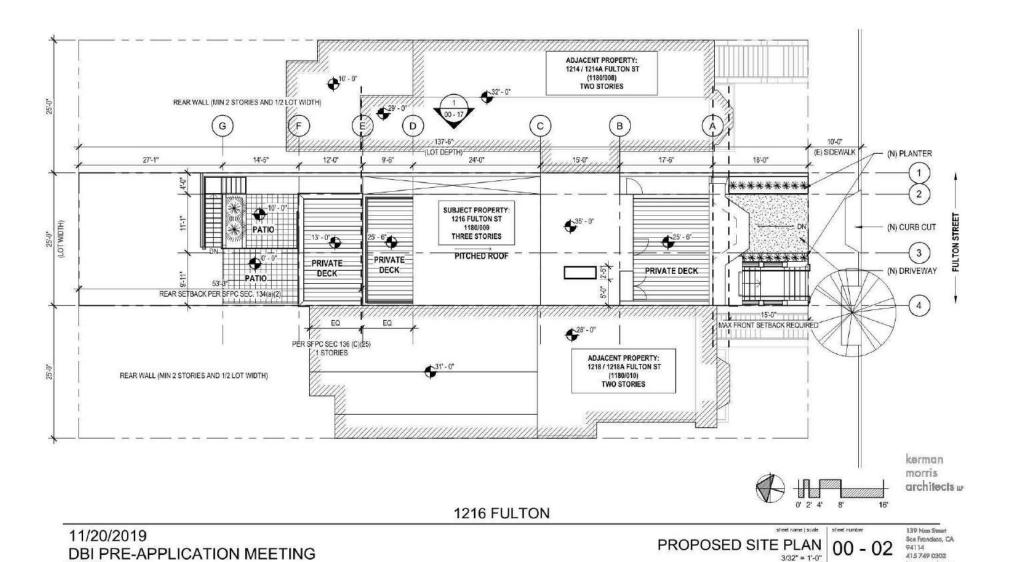

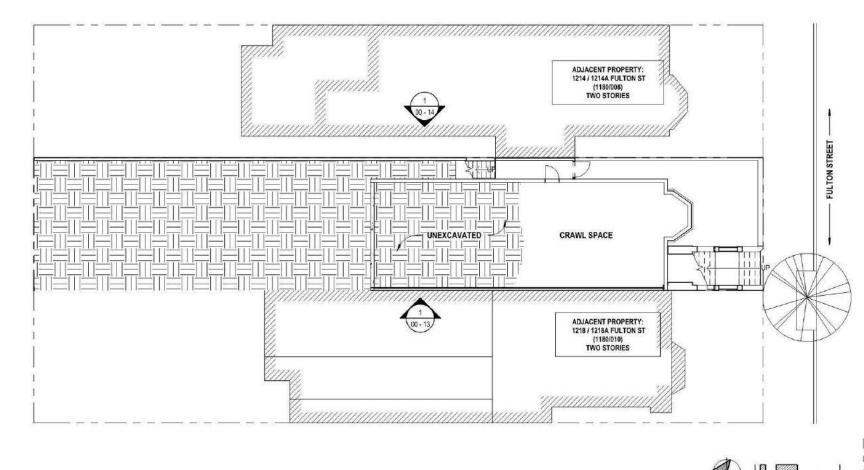


architects w 1216 FULTON

EXISTING BASEMENT FLOOR PLAN
3/32" = 1'-0"
15 749 0302

Kn kerman morris architects 139 Noe Street San Francisco, C

415 749 0302

Revisions

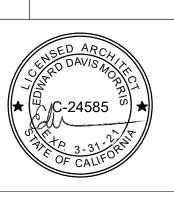

1216 FULTON 1216 FULTON STREET SAN FRANCISCO, CA 94117

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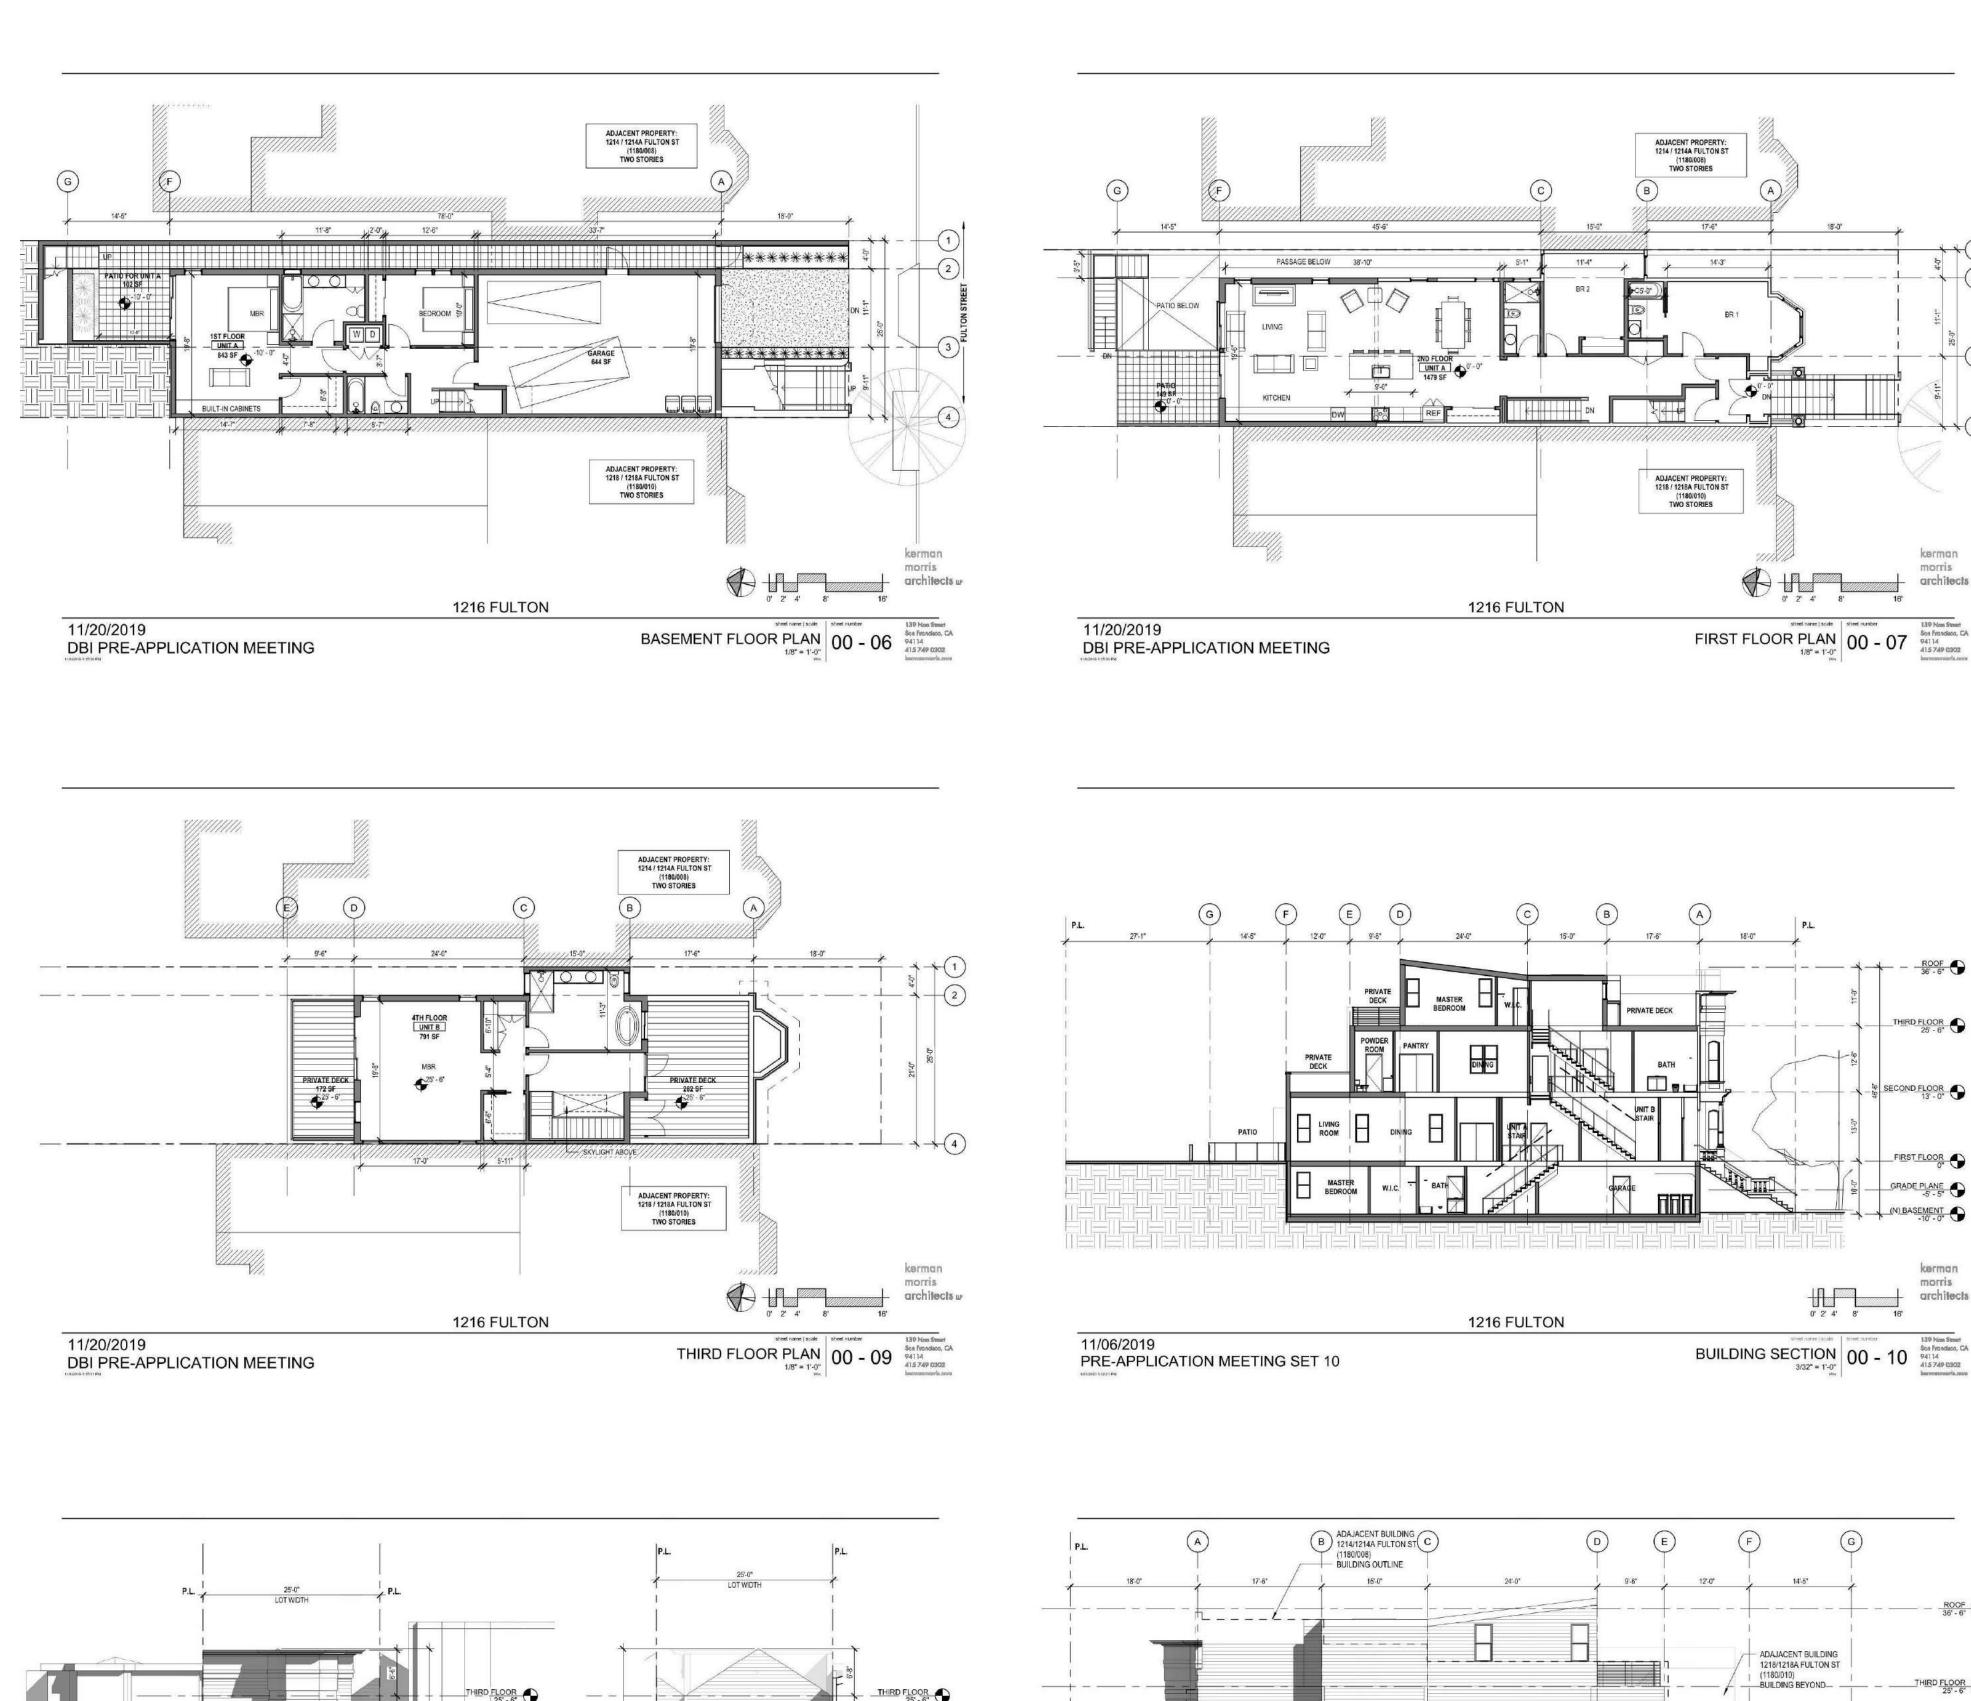
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FIRE FLOW INFO & DBI PRE-APPLICATION FINDING SUMMARY

DATE 11/08/2019 SCALE DRAWN BY CHECKED BY Checker JOB NO.

G0.08A



(E) BASEMENT

EXISTING ELEVATIONS 1/8" = 1"-0" 100 - 12 | Sheet number 130 Nons Strent Son Froncisco, CA 94114 (15749 0302 Intermental All 5749 0302


architects w


1 EXISTING ELEVATION - SOUTH (FRONT)

11/20/2019

DBI PRE-APPLICATION MEETING

1216 FULTON

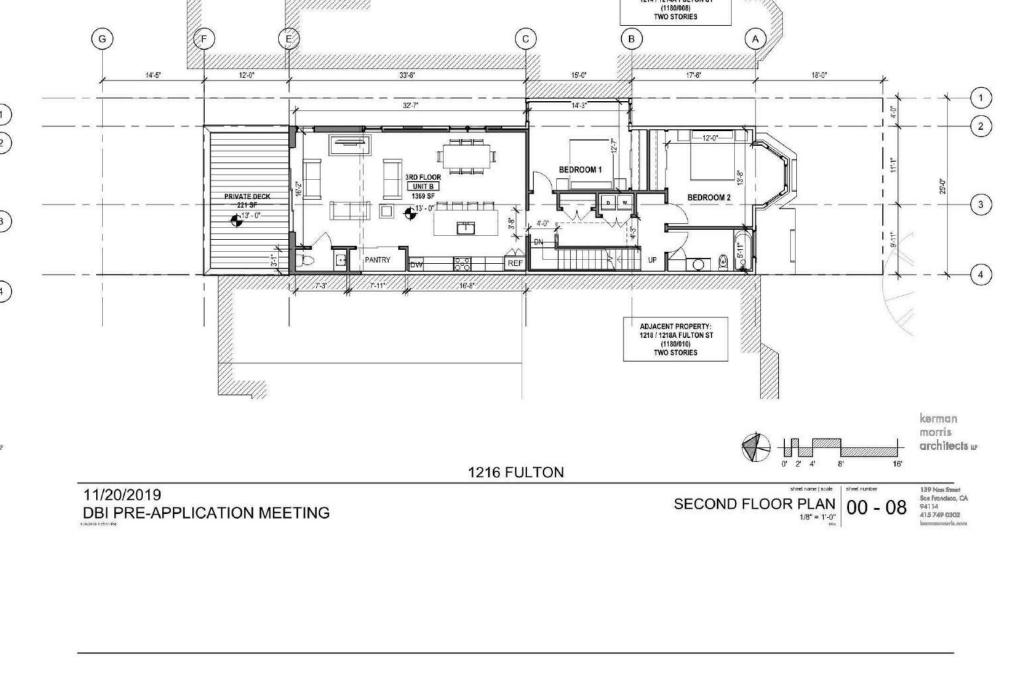


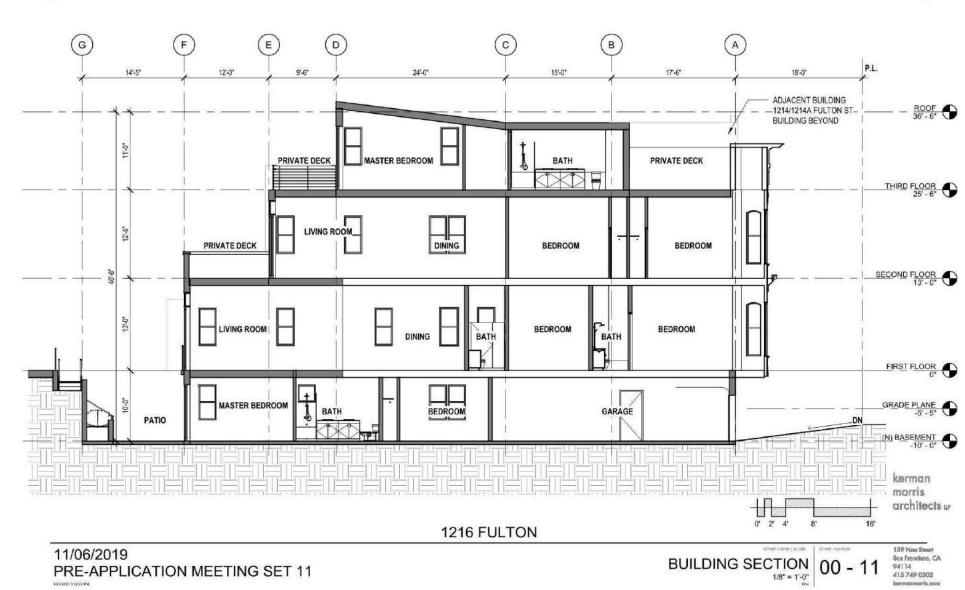

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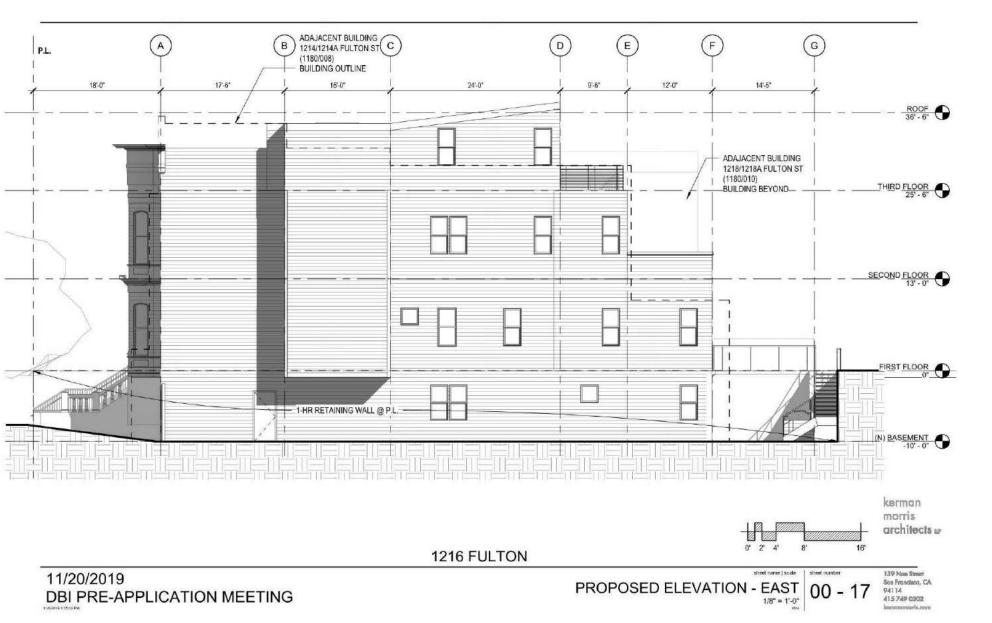
DBI PRE-APPLICATION **FINDINGS**

DATE 03/04/20 SCALE

DRAWN BY CHECKED BY

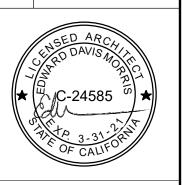JOB NO.

G0.08B



morris architects w

GS5: San Francisco Green Building Submittal Form for Residential Alteration + Addition Projects

| <u> </u> | DUOTIONO | | Transfer Cross Banang Cabinitan Form for Modian and Modian | | Form version: October 11, 2017 (For permit applications January 2017 - December 2019 |
|------------------------------------|--|--|--|--|---|
| 00000 NORMAN CO | RUCTIONS: ut the project information in the Verificatio | n box at the right. | | OTHER RESIDENTIAL ALTERATIONS + | VERIFICATION |
| 2. Subi | nittal must be a minimum of 11" x 17". | • | | ADDITIONS | Indicate below who is responsible for ensuring green building requirements are met. Projects that increase |
| This will be the second of | form is for permit applications submitted on submitted until January 1, 2018. | | er 2019. The prior version | adds any amount of conditioned | total conditioned floor area by ≥1,000 sq. ft. are required |
| | TITLE | SOURCE OF REQUIREMENT | DESCRIPTION OF REQUIREMENT | area, volume, or size | to have a Green Building Compliance Professional of Record as described in Administrative Bulletin 93. For |
| | GRADING & PAVING | CALGreen 4.106.3 | Show how surface drainage (grading, swales, drains, retention areas) will keep surface water from entering the building. | if applicable | projects that increase total conditioned floor area by |
| | RODENT PROOFING | CALGreen 4.406.1 | Seal around pipe, cable, conduit, and other openings in exterior walls with cement mortar or DBI-approved similar method. | паррисало | <1,000 sq. ft., the applicant or design professional may sign below, and no license or special qualifications are |
| | FIREPLACES & | CALGreen 4.406.1 | Seal around pipe, cable, conduit, and other openings in exterior walls with cement mortal or DBI-approved similar method. | • | required. FINAL COMPLIANCE VERIFICATION form |
| I K | WOODSTOVES | CALGreen 4.503.1 | Install only direct-vent or sealed-combustion, EPA Phase II-compliant appliances. | • | will be required prior to Certificate of Completion |
| SIDE | CAPILLARY BREAK, SLAB ON GRADE | CALGreen 4.505.2 | Slab on grade foundation requiring vapor retarder also requires a capillary break such as: 4 inches of base 1/2-inch aggregate under retarder; slab design specified by licensed professional. | • | 1216 FULTON PROJECT NAME |
| 2 | MOISTURE CONTENT | CALGreen 4.505.3 | Wall + floor <19% moisture content before enclosure. | | 1180/009 |
| | ten viele in condeten entre entretate description (entre transcription entre entre entre entre entre entre entre | 2004X 84 (Methods/Scholinder of End-2007/2012-1010) | | <u></u> | BLOCK/LOT |
| | BATHROOM EXHAUST | CALGreen 4.506.1 | Must be ENERGY STAR compliant, ducted to building exterior, and its humidistat shall be capable of adjusting between <50% to >80% (humidistat may be separate component). | • | 1216 FULTON STREET |
| MATERIALS | LOW-EMITTING MATERIALS | | Use products that comply with the emission limit requirements of 4.504.2.1-5, 5.504.4.1-6 for adhesives, sealants, paints, coatings, carpet systems including cushions and adhesive resilient flooring (80% of area), and composite wood products. | S., | R-2 PRIMARY OCCUPANCY 5,745 SF |
| TER | INDOOR WATER USE REDUCTION | CALGreen 4.303.1, SF Housing Code sec.12A10 | Meet flush/flow requirements for: toilets (1.28gpf); urinals (0.125gpf wall, 0.5gpf floor); showerheads (2.0gpm); lavatories (1.2gpm private, 0.5gpm public/common); kitchen faucets (1.8gpm); wash fountains (1.8gpm); metering faucets (0.2gpc); food waste disposers (1gpm/8gpm). Residential major improvement projects must upgrade all non-compliant fixtures SF Housing Code sec.12A10. | per • | GROSS BUILDING AREA 2,063 SF INCREASE IN CONDITIONED FLOOR AREA |
| WA | WATER-EFFICIENT IRRIGATION | Administrative Code ch.63 | If modified landscape area is ≥1,000 sq.ft., use low water use plants or climate appropriate plants, restrict turf areas and comply with Model Water Efficient Landscape Ordinance restrictions by calculated ETAF of ≤.55 or by prescriptive compliance for projects with ≤2,500 sq.ft. of landscape area. | • | I have been retained by the project sponsor to verify that approved construction documents and construction fulfill the requirements of San Francisco Green Building Code. It |
| ENERGY | ENERGY EFFICIENCY | CA Energy Code | Comply with all provisions of the CA Energy Code. | • | is my professional opinion that the requirements of the San Francisco Green Building Code will be met. I will notify the Department of Building Inspection if the project will, for any reason, not substantially comply with these requirements, if |
| PARKING | BICYCLE PARKING | Planning Code sec.155.1-2 | Provide short- and long-term bike parking to meet requirements of SF Planning Code sec.155.1-2. | if applicable | I am no longer the Green Building Compliance Professional of Record for the project, or if I am otherwise no longer responsible for assuring the compliance of the project with the San Francisco Green Building Code. |
| Z | RECYCLING BY OCCUPANTS | SF Building Code | Provide adequate space and equal access for storage, collection, and loading of compostable, recyclable and landfill materials. | • | LICENSED PROFESSIONAL (sign & date) |
| WASTE DIVERSIO | CONSTRUCTION & DEMOLITION (C&D) | AB-088 SFGBC 4.103.2.3 | For 100% of mixed C&D debris use registered transporters and registered processing facilities with a minimum of 65% diversion rate. | • | May be signed by applicant when <1,000 sq. ft. is added. AFFIX STAMP BELOW: |
| | WASTE MANAGEMENT | CAI Croon 4 702 1 | Installers must be trained in heat practices | | SED ARCH |
| ĭĀ | HVAC INSTALLER QUALS | CALGreen 4.702.1 | Installers must be trained in best practices. | | CENS DAVIS 40 PC |
| | HVAC DESIGN | CALGreen 4.507.2 | HVAC shall be designed to ACCA Manual J, D, and S. | • | THE |
| GHBOR | BIRD-SAFE BUILDINGS | Planning Code sec.139 | Glass facades and bird hazards facing and/or near Urban Bird Refuges may need to treat their glass for opacity. | • | (C-24585 (b) ★ |
| NE | TOBACCO SMOKE CONTROL | Health Code art.19F | Prohibit smoking within 10 feet of building entries, air intakes, and operable windows and enclosed common areas. | • | OF CALIFORNIE |
| POLLUTION | STORMWATER CONTROL PLAN | Public Works Code art.4.2 sec.147 | Projects disturbing ≥5,000 sq.ft. in combined or separate sewer areas, or replacing ≥2,500 impervious sq.ft. in separate sewer area, must implement a Stormwater Control Plan meets SFPUC Stormwater Management Requirements. | ting if project extends outside envelope | Projects that increase total conditioned floor area by ≥1,000 sq.ft.: Green Building Compliance Professional of Record will verify compliance. |
| POLLI | CONSTRUCTION SITE RUNOFF | Public Works Code art.4.2 sec.146 | Provide a construction site Stormwater Pollution Prevention Plan and implement SFPUC Best Management Practices. | if project extends outside envelope | of Record will verify compliance. |
| INDOOR ENVIRONMENTAL QUALITY | AIR FILTRATION (CONSTRUCTION) | CALGreen 4.504.1 | Seal permanent HVAC ducts/equipment stored onsite before installation. | | GREEN BUILDING COMPLIANCE PROFESSIONAL (name & contact phone #) |
| - | Indoor W | /ater Efficiency | Water Efficiency of Existing Non-Compliant Fixtures | II | |
| ≿ | Each fixture must not exceed FIXTURE TYPE | | All fixtures that are not compliant with the San Francisco Commercial Water Conservation | | X I am a LEED Accredited Professional |
| N N | The state of the s | 2 gpm @ 80 psi | Ordinance that serve or are located within the project area must be replaced with fixtures 1. For dual flush toilets, effective flush volume or fittings meeting the maximum flow rates and standards referenced above. For more | | I am a GreenPoint Rater |
| INFORMATION: | Lavatory Faucets: residential | 1.2 gpm @ 60 psi | is defined as the composite, average flush volume of two reduced flushes and one full information, see the Commercial Water Conservation Program Brochure, available at SFDBI. | | I am an ICC Certified CALGreen Inspector |
| ORN EFF | Kitchen Faucets | 1.8 gpm @ 60 psi default | flush. The referenced standard is ASME | | an an ico certified CALGreen inspector |
| R R | Wash Fountains | 1.8 gpm / 20 [rim space (inches) @ | Type High Efficiency Toilet Specification – 1 Any toilet manufactured to use more than 1.6 gallons/flush | | |
| OUR I | Metering Faucets | .20 gallons per cycle | 2. The combined flow rate of all showerheads 2. Any urinal manufactured to use more than 1 gallon/flush | | GREEN BUILDING COMPLIANCE PROFESSIONAL |
| Ž Š Š | Tank-type water closets | 1.28 gallons / flush¹ and EPA W | faterSense Certified in one shower stall shall not exceed the 3. Any showerhead manufactured to have a flow capacity of more than 2.5 gpm | | (sign & date) Signature by a professional holding at least one of |
| FOR | Flushometer valve water closets Urinals | 1.28 gallons / flush ¹ Wall mount: 0.125 gallons / flush Floor mount: 0.5 gallons / flush | the shower shall be designed to allow only one showerhead to be in operation at a time (CALGreen 5.303.2.1) Exceptions to this requirement are limited to situations where replacement of fixture(s) would detract from the historic integrity of the building, as determined by the Department of Building | | the above certifications is required. If the Licensed Professional does not hold a certification for green design and/or inspection, this section may be completed by another party who will verify applicable green building |
| | | mount vio ganono i nuon | | | requirements are met. |

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Revisions



1216 FULTON
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GREENPOINT RATED CHECKLIST

DATE 11/08/2019

SCALE

DRAWN BY SC

CHECKED BY Checker

JOB NO. 1804




EXISTING FLAT TRIMS AROUND WINDOWS

EXISTING B*LAP SIDING WITH SHADOW LINE REVEAL


RAILINGS FOLLOW NEIGHBOR'S STYLE

RAILINGS FOLLOW NEIGHBOR'


2 ENTRY STRAIGHT VIEW
12" = 1'-0"

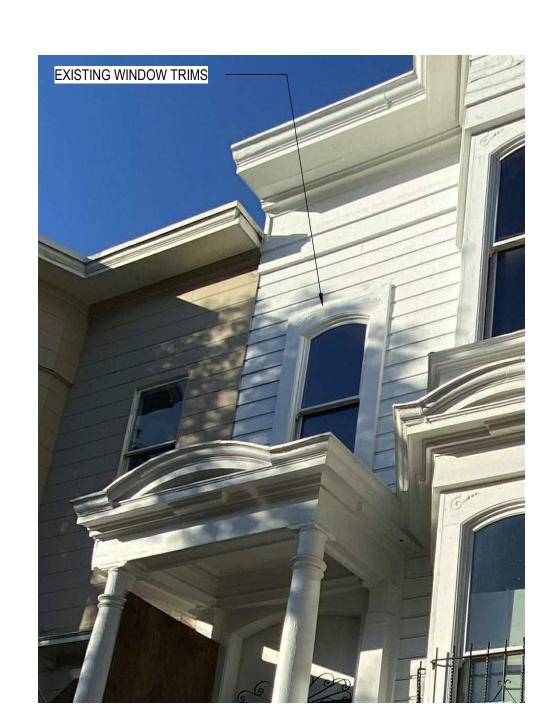

EXISTING WINDOW TRIMS EXISTIN

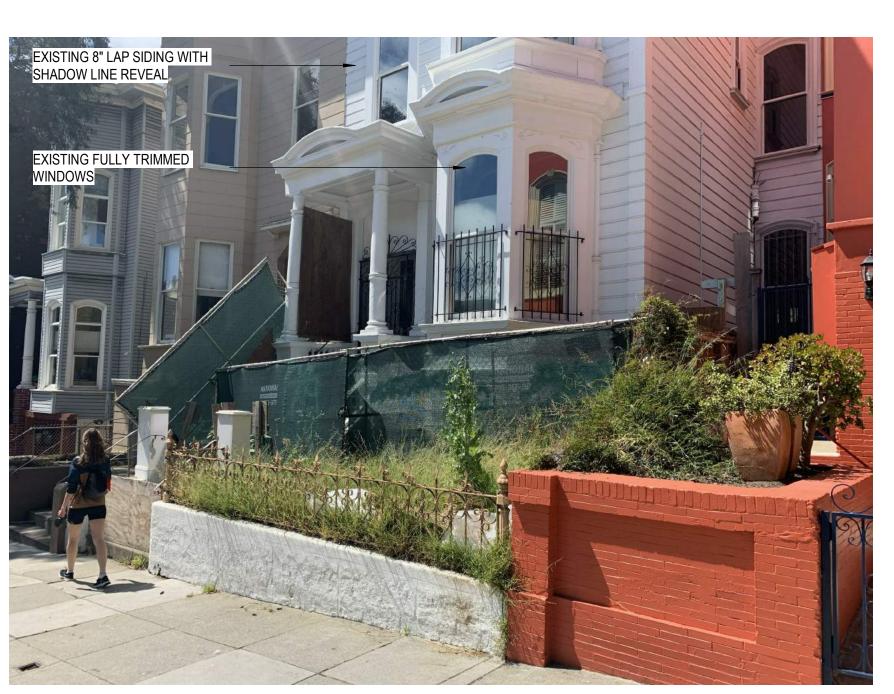

EXISTING ENTRY VIEW

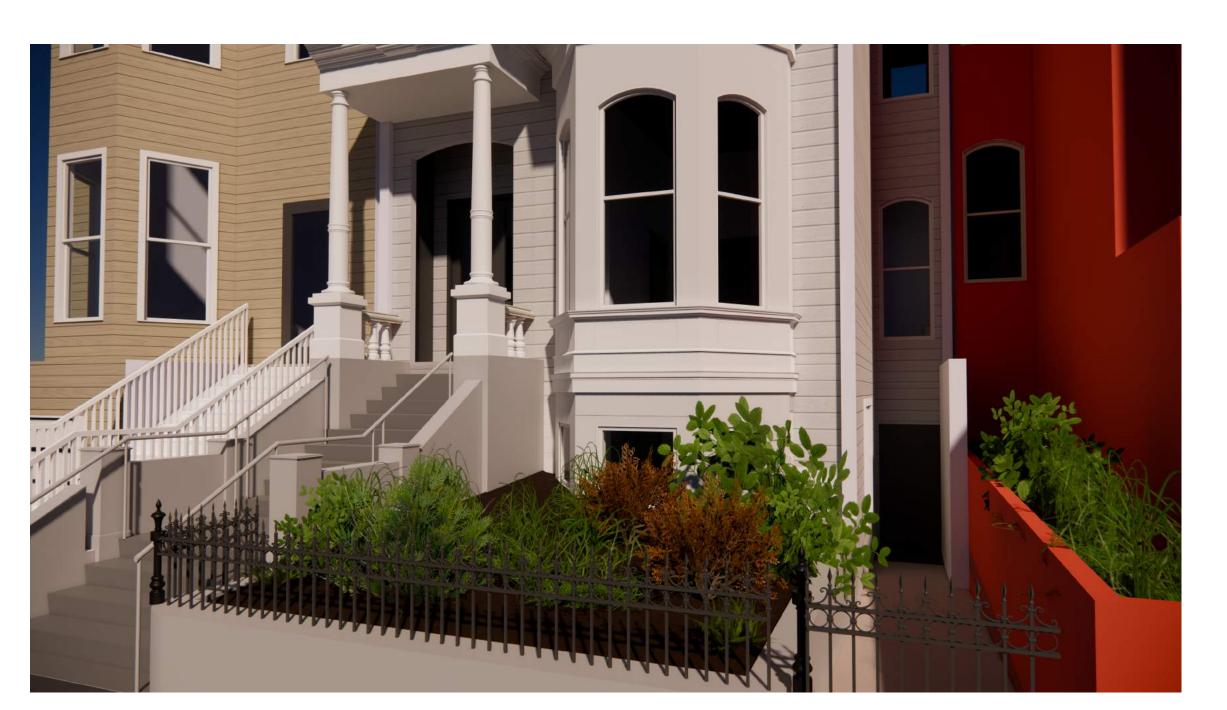

1 ENTRY PERSPECTIVE

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RENDERING & MATERIALS

DATE 11/23/20

SCALE 12" = 1'-0"

DRAWN BY Author

CHECKED BY Checker

JOB NO. 1804

ADJACENT PROPERTY: 1214 / 1214A FULTON ST (1180/008) TWO STORIES 10' - 0" 18'-0" FRONT SETBACK 1214 FULTON - EXCAVATION 12' DEEP (HATCHED AREA) (E) STAIRS TO BE REMOVED 137'-6" LOT DEPTH 63'-6" 56'-0" 18'-0" EXISTING REAR YARD SET BACK EXISTING BUILDING DEPTH (E) FRONT SET BACK (E) PLANTER TO BE REMOVED (E) DOOR BELOW TO BE REMOVED 43'-0" 15'-0" (E) SIDEWALK (E) ROOF BELOW (E) ROOF CORNICE TO REMAIN AND REPAIR (E) ROOF TO BE REMOVED (E) CANOPY TO REMAIN AND REPAIR (E) PAVED PATIO TO //BE REMOVED/ UNPAVED REAR (E) ENTRY STAIR TO REMAIN SUBJECT PROPERTY: YARD TO REMAIN 1216 FULTON ST —(E) TREE TO REMAIN (1180/009) TWO STORIES (E) DOOR BELOW TO BE REMOVED -ADJACENT PROPERTY: 18'-0" FRONT SETBACK 1218 / 1218A FULTON ST 1218 FULTON (1180/010) TWO STORIES

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EXISTING / DEMO SITE PLANS

 DATE
 11/08/2019

 SCALE
 1/8" = 1'-0"

 DRAWN BY
 Author


 CHECKED BY
 Checker


JOB NO.

D1.01

1) EXISTING / DEMO SITE PLAN


1/8" = 1'-0"

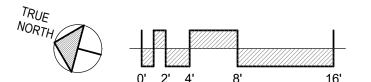

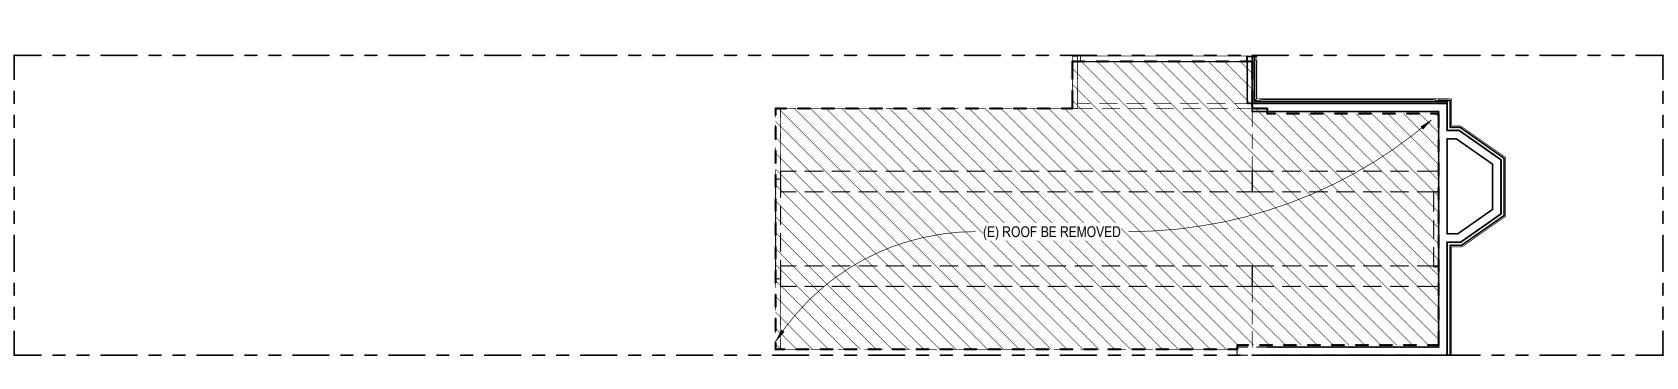

EXISTING / DEMO THIRD FLOOR PLAN

1/8" = 1'-0"

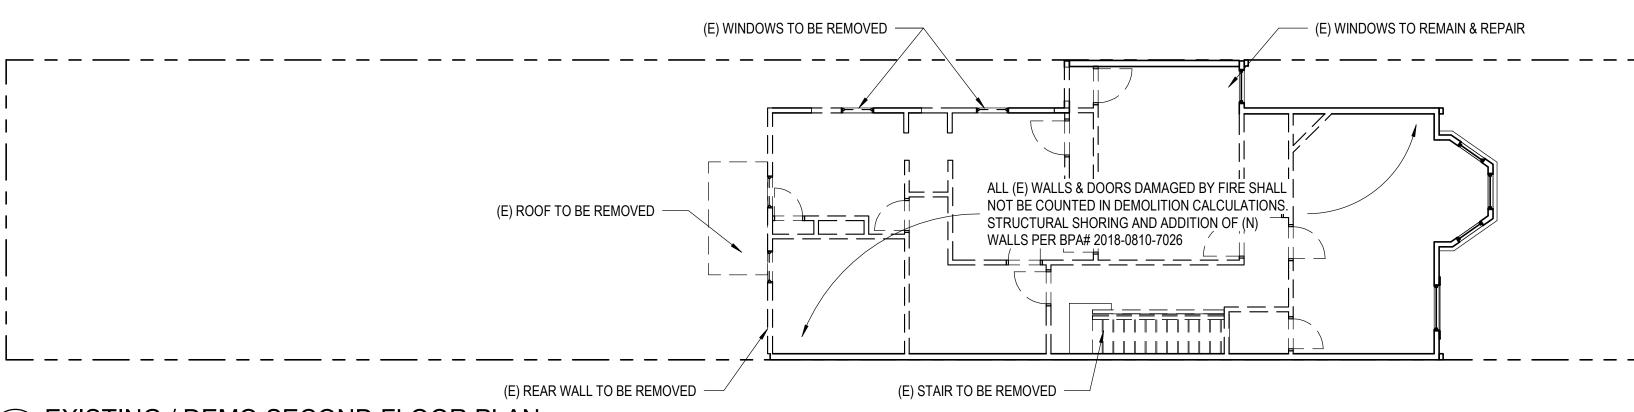


(E) REAR

3 EXISTING / DEMO SECOND FLOOR PLAN

1/8" = 1'-0"

NOTE: APPROXIMATE OUTLINE OF (E) WALLS & STRUCTURAL FRAMEWORK DESTROYED OR COMPROMISED IN FIRE

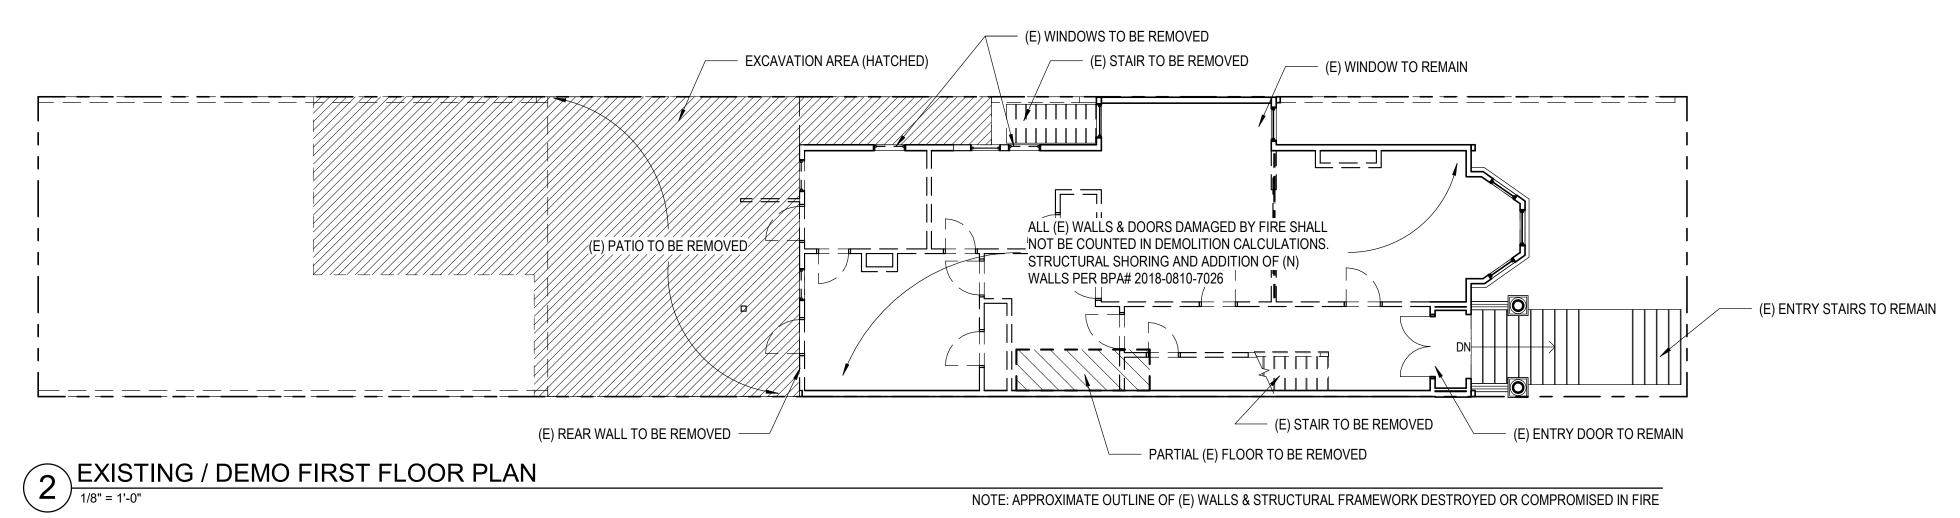

EXCAVATION AREA (HATCHED)

(E) STAIR TO BE REMOVED

(E) WALL TO BE REMOVED

(E) POUNDATION TO BE REMOVED

(E) PLANTER & RETAINING WALLL TO BE REMOVED

(E) WALLS & FOUNDATION

TO BE REMOVED

(E) PLANTER & RETAINING WALLL TO BE REMOVED

(E) PLANTER & RETAINING WALLL TO BE REMOVED

PARTITION LEGEND

(E) PARTITION TO REMAIN

(E) NON-STRUCTURAL PARTITION
TO BE REMOVED

(E) BUILDING OUTLINE

FLOOR PLATE / WALL AREA TO BE DEMOLISHED

DEMO CALCULATION PER SFPC SEC. 1005(f)
HORIZONTAL ELEMENTS (PER SFPC SEC. 1005(f)(4))

TOTAL (E) **TOTAL DEMO** FLOOR PLATE FLOOR PLATE **PERCENTAGE FLOOR** BASEMENT N/A N/A FIRST FLOOR 1,197.64 SF 37.94 SF 3% 0 SF SECOND FLOOR 1,162.51 SF 0% 1,167.18 SF 1,167.18 SF THIRD FLOOR 100% 3,524.33 SF 1205.12 SF 34% **TOTAL MAX PERMITTED 75%** CODE COMPLIANT


INTERIOR STRUCTURAL FRAMEWORK (PER SFPC SEC. 1005(f)(3))
NOTE: N/A, INTERNAL WALLS ARE COMPROMISED BY FIRE

DEMO CALCULATION PER SFPC SEC. 317

| REMOVAL OF VERTICA | L ELEMENTS, MEASURED IN S | OF OF ARCTURAL SURFACE ARE | A | MAX | CODE |
|--------------------|---------------------------|-----------------------------|------------|-----------|----------------------------|
| ELEVATION | TOTAL (E) FLOOR PLATE | TOTAL DEMO FLOOR PLATE | PERCENTAGE | PERMITTED | COMPLIANT? (EITHER ONE) |
| WEST | 2,249.55 SF | 269.14 SF | 11.96% | | |
| SOUTH (FRONT) | 988.45 SF | 83.29 SF | 8.42% | | |
| EAST | 2,249.55 SF | 246.47 SF | 10.96% | | |
| NORTH (REAR) | 768 SF | 595.74 SF | 35.04% | | |
| TOTAL | 6,255.55 SF | 1,194.64 SF | 19.10% | 50% | YES |
| REMOVAL OF HORIZON | NTAL ELEMENTS, MEASURED | IN SF OF ARCTURAL SURFACE A | REA | | 120 |
| FLOOR | TOTAL (E) FLOOR PLATE | TOTAL DEMO FLOOR PLATE | PERCENTAGE | | |
| BASEMENT | N/A | N/A | N/A | | |
| FIRST FLOOR | 1,197.64 SF | 37.94 SF | 3% | | |
| SECOND FLOOR | 1,162.51 SF | 0 SF | 0% | | |
| THIRD FLOOR | 1,167.18 SF | 1,167.18 SF | 100% | | |
| TOTAL | 3,524.33 SF | 1205.12 SF | 34% | 50% | |

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Revisions

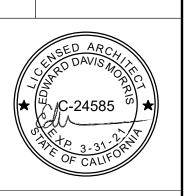

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EXISTING / DEMO FLOOR PLANS

DATE 11/08/2019 SCALE 1/8" = 1'-0'


DRAWN BY Author
CHECKED BY Checker


JOB NO. 1804

D2.01

1) EXISTING / DEMO BASEMENT FLOOR PLAN
1/8" = 1'-0"



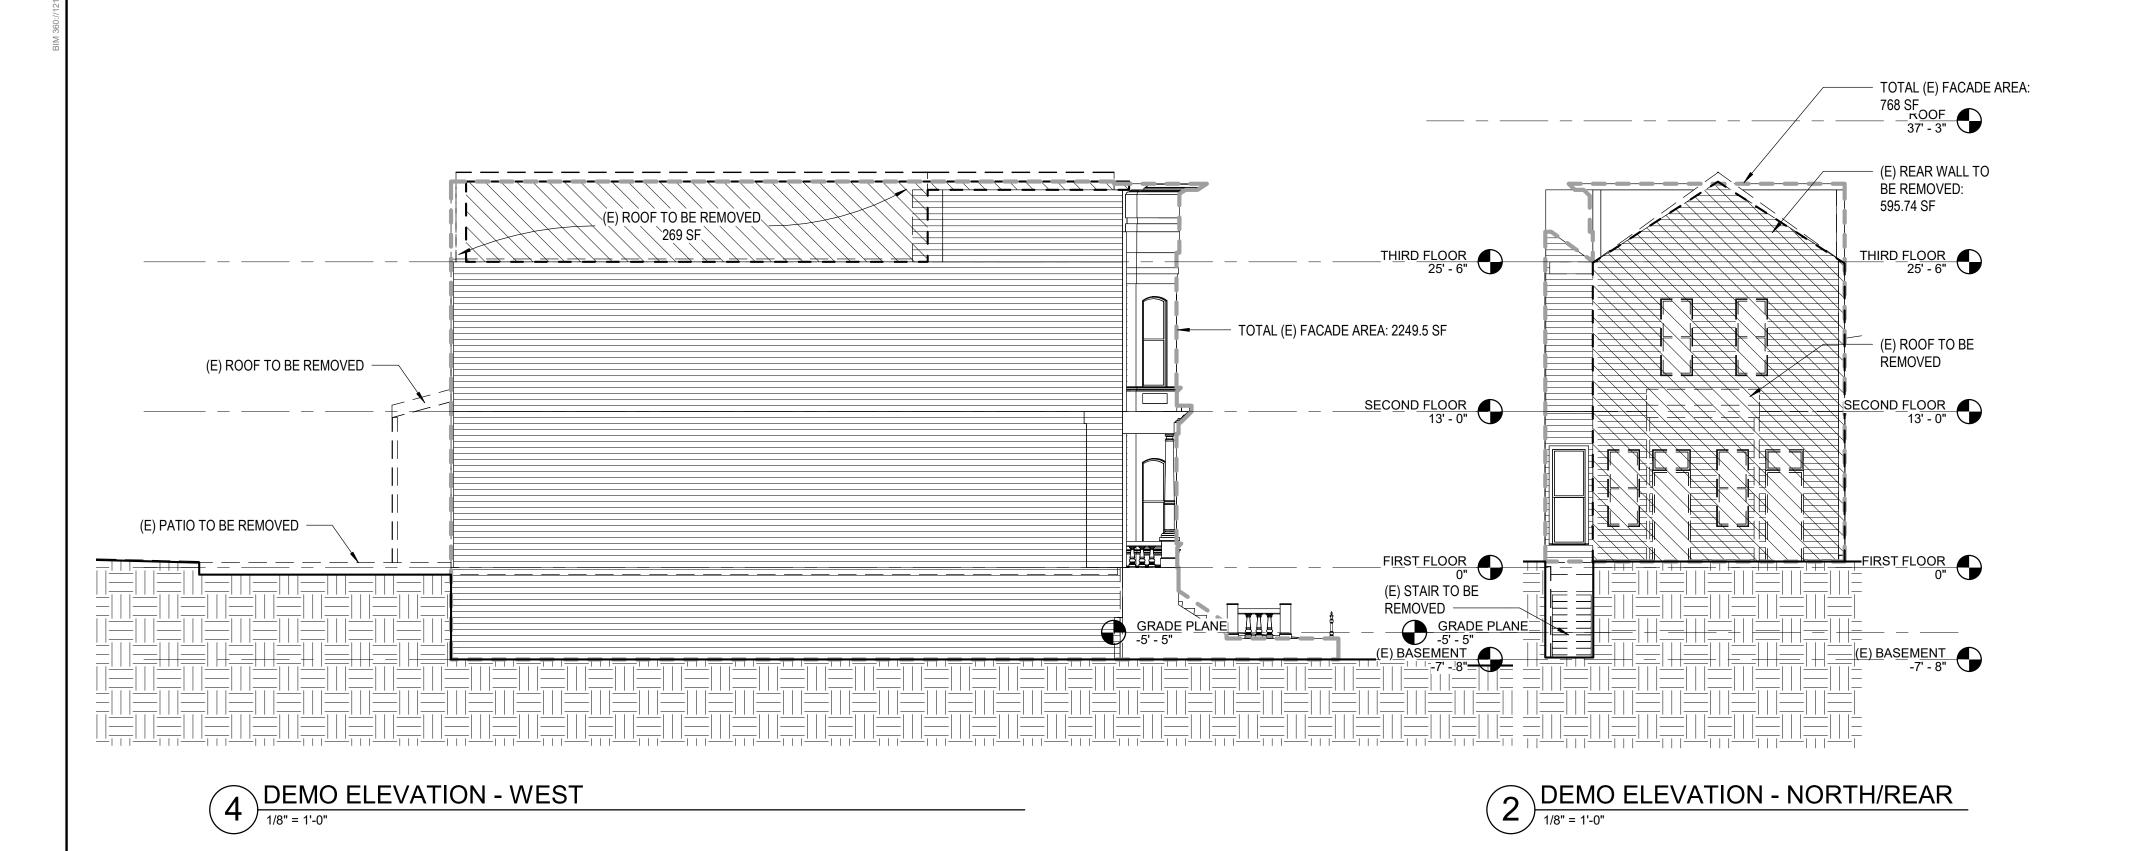

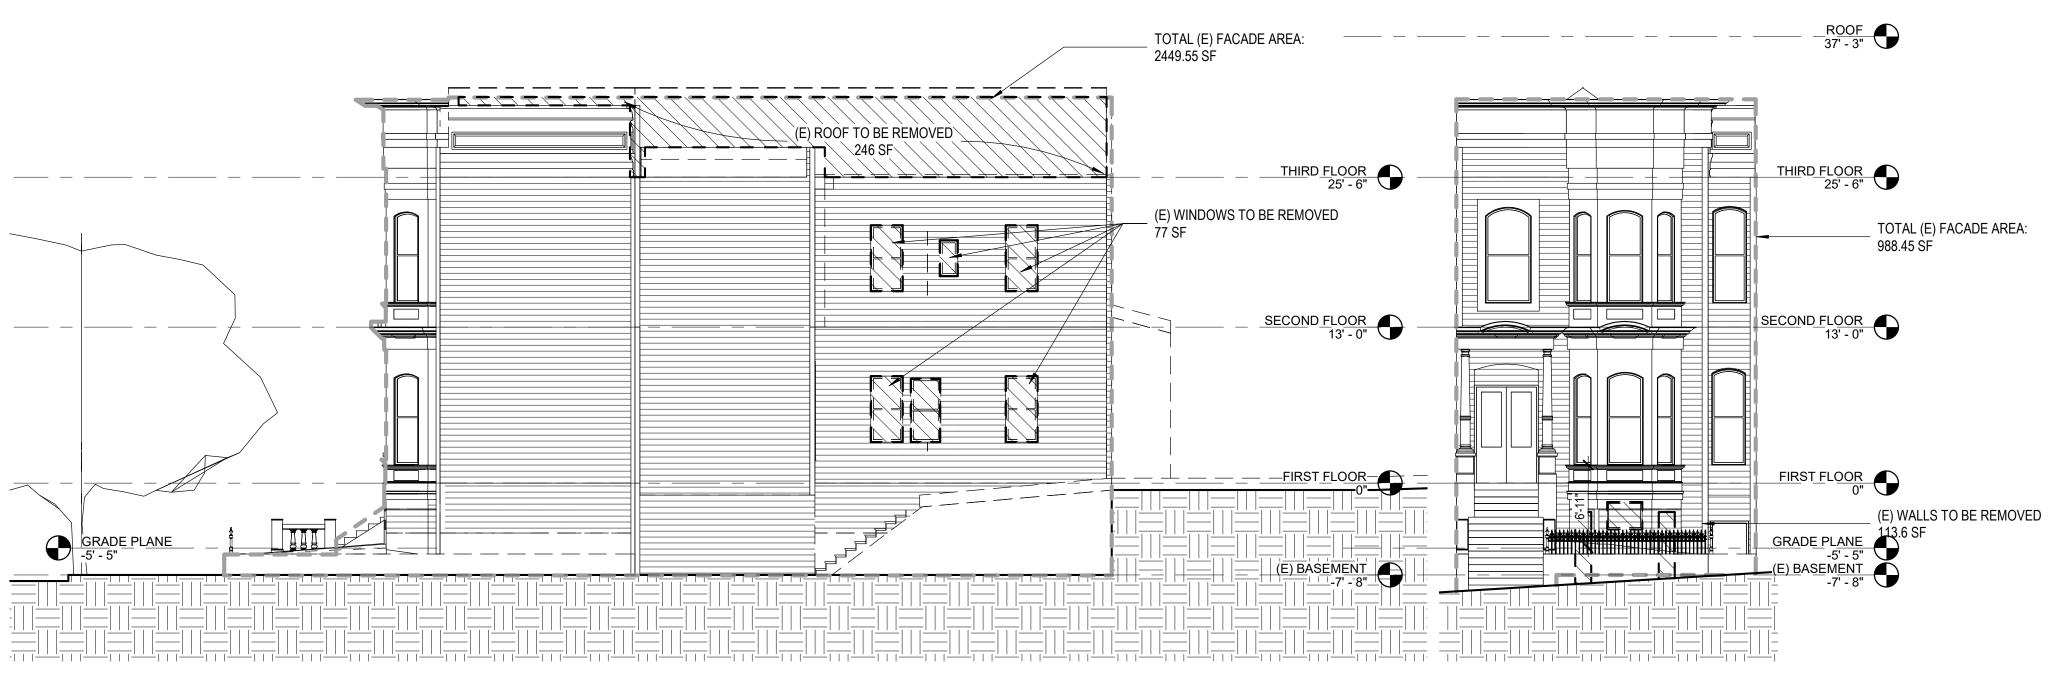

PARTITION LEGEND

(E) PARTITION TO REMAIN

(E) NON-STRUCTURAL PARTITION TO BE REMOVED

(E) BUILDING OUTLINE



DEMO CALCULATION PER SFPC SEC. 1005(f)

ALL PUBLIC FACING (PER SFPC SEC. 1005(f)(1))

| FACADE | TOTAL (E) WALL AREA | TOTAL DEMO WALL AREA | PERCENTAGE |
|---------------|------------------------|-------------------------|------------|
| SOUTH (FRONT) | 988.45 SF | 22.68 SF | 2.29% |
| | | | |
| | MAX PERMITTED | | 25% |
| PI | ROJECT COMPLIANT | | YES |

EXTERNAL WALLS FUNCTION AS EXT. WALLS (PER SFPC SEC. 1005(f)(2))

| FACADE | TOTAL (E) WALL AREA | TOTAL DEMO WALL AREA | PERCENTAGE |
|---------------|------------------------|-------------------------|------------|
| WEST | 2,249.55 SF | 269.14 SF | 11.96% |
| SOUTH (FRONT) | 988.45 SF | 22.68 SF | 2.29% |
| EAST | 2,249.55 SF | 246.47 SF | 10.96% |
| NORTH (REAR) | 768 SF | 595.74 SF | 35.04% |
| TOTAL | 6,255.55 SF | 1,112.03 SF | 17.78% |
| | MAX PERMITTED | | 50% |
| | CODE COMPLIANT | | YES |

DEMO CALCULATION PER SFPC SEC. 317

| | ACADE AND REAR FACAI | MAX PERMITTED | CODE COMPLIANT? (EITHER ONE | | |
|--------------------|----------------------|------------------|-----------------------------------|-----|-------------|
| ELEVATION | (E) FEET | DEMO FEET | PERCENTAGE | | (ETTHER ONE |
| SOUTH (FRONT) | 25'-0" | 5'-8" | 22.67% | | |
| NORTH (REAR) | 25'-0" | 21'-0" | 84% | | |
| TOTAL | 50'-0" | 26'-8" | 53.3% | 50% | |
| ELEVATION | (E) FEET | DEMO FEET | PERCENTAGE | | |
| EI EVATION | (E) FEET | DEMO FEET | PERCENTAGE | | |
| | 741.01 | 0'-0" | 0% | | YES |
| WEST | 74'-0" | 0-0 | U 70 | | |
| WEST SOUTH (FRONT) | 25'-0" | 5'-8" | 22.67% | | |
| | | | | | |
| SOUTH (FRONT) | 25'-0" | 5'-8" | 22.67% | | |

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EXISTING / DEMO EXTERIOR ELEVATIONS

DATE 11/08/2019

SCALE 1/8" = 1'-0"


DRAWN BY Author

CHECKED BY Checker


JOB NO. 1804

3 DEMO ELEVATION - EAST

1 DEMO ELEVATION - SOUTH/FRONT

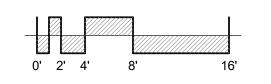

D5.01

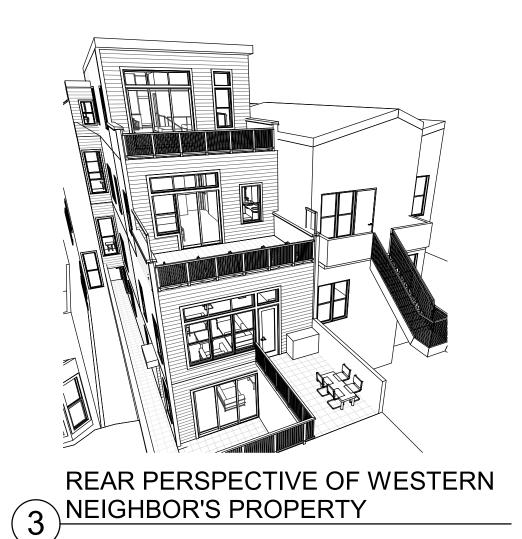



REAR PERSPECTIVE OF EASTTERN


NEIGHBOR'S PROPERTY

GRADE PLANE CALCULATION:

POINT A= -9'-6" POINT B= -3-0" POINT C= -10'-0" POINT D= 1'-0"

AVERAGE = -5-5" =>LOWEST LEVEL = BASEMENT kerman morris architects up 139 Noe Street San Francisco, CA 94114 415 749 0302

Revisions

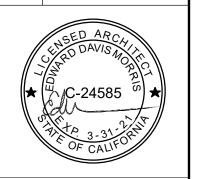

1216 FULTON 1216 FULTON STREET

1216 FULTON STREET SAN FRANCISCO, CA 94117

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SITE PLANS

 DATE
 11/08/2019


 SCALE
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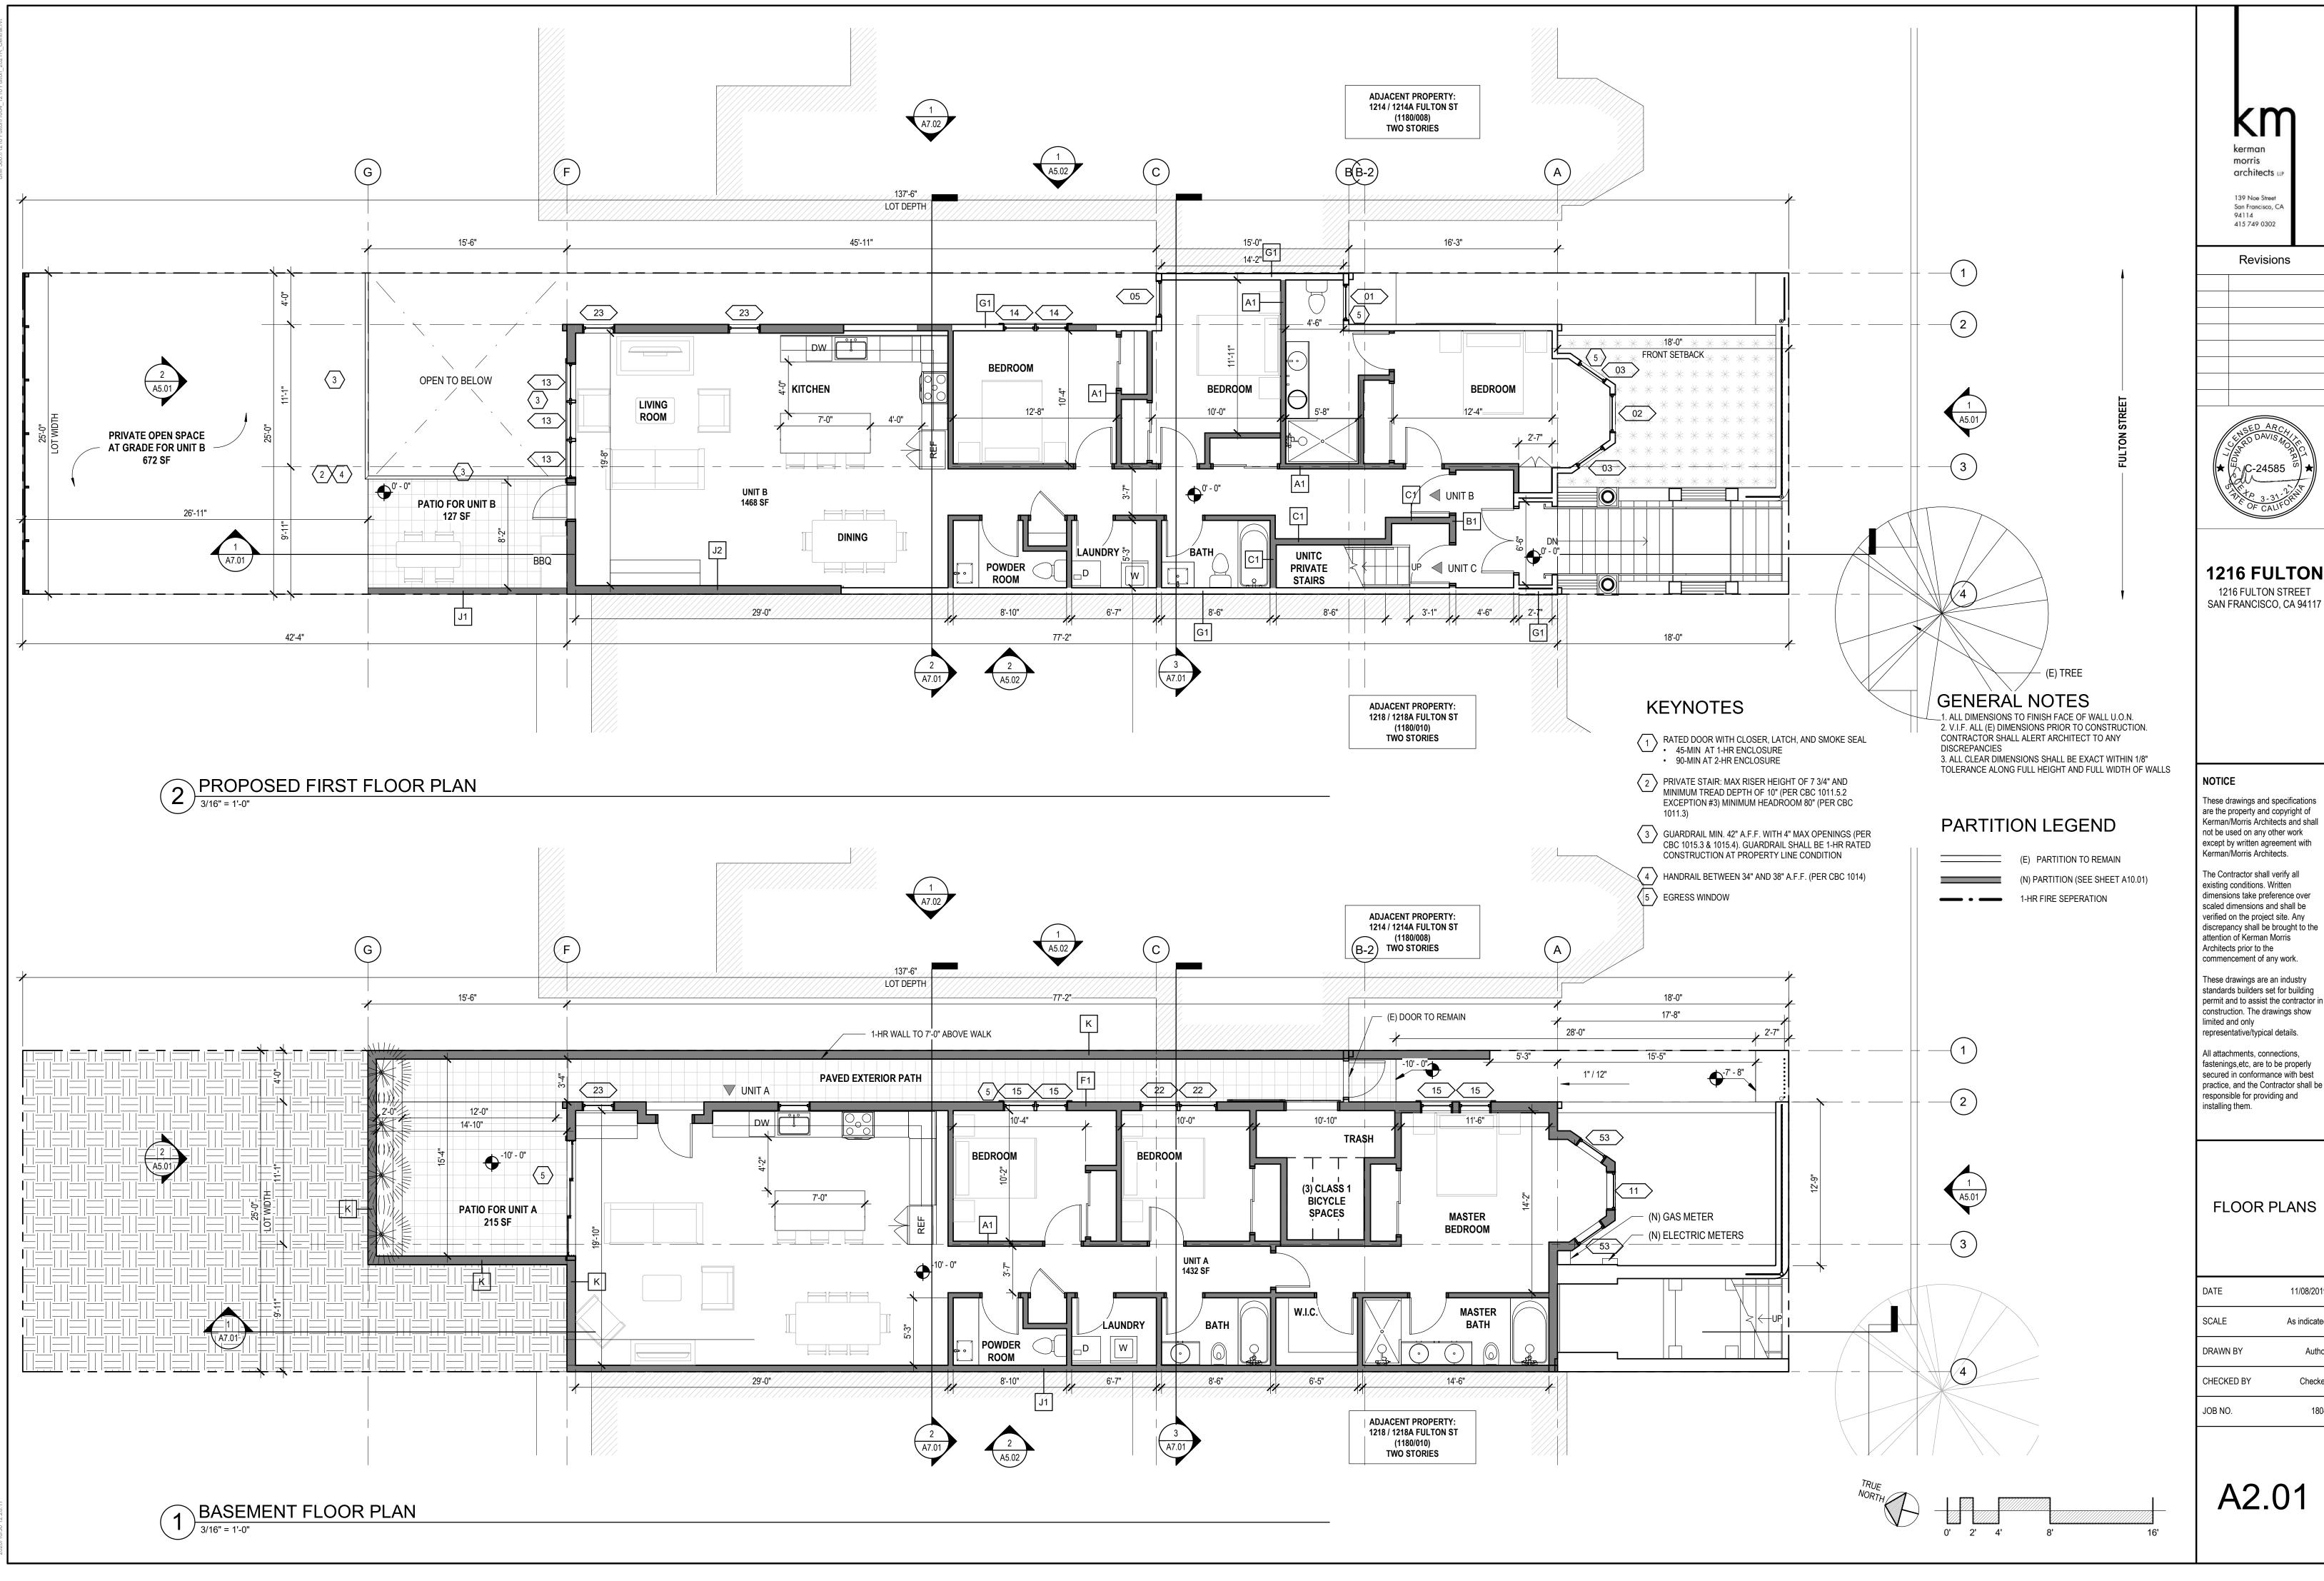
 DRAWN BY
 Author

 CHECKED BY
 Checker

JOB NO.

A1.01



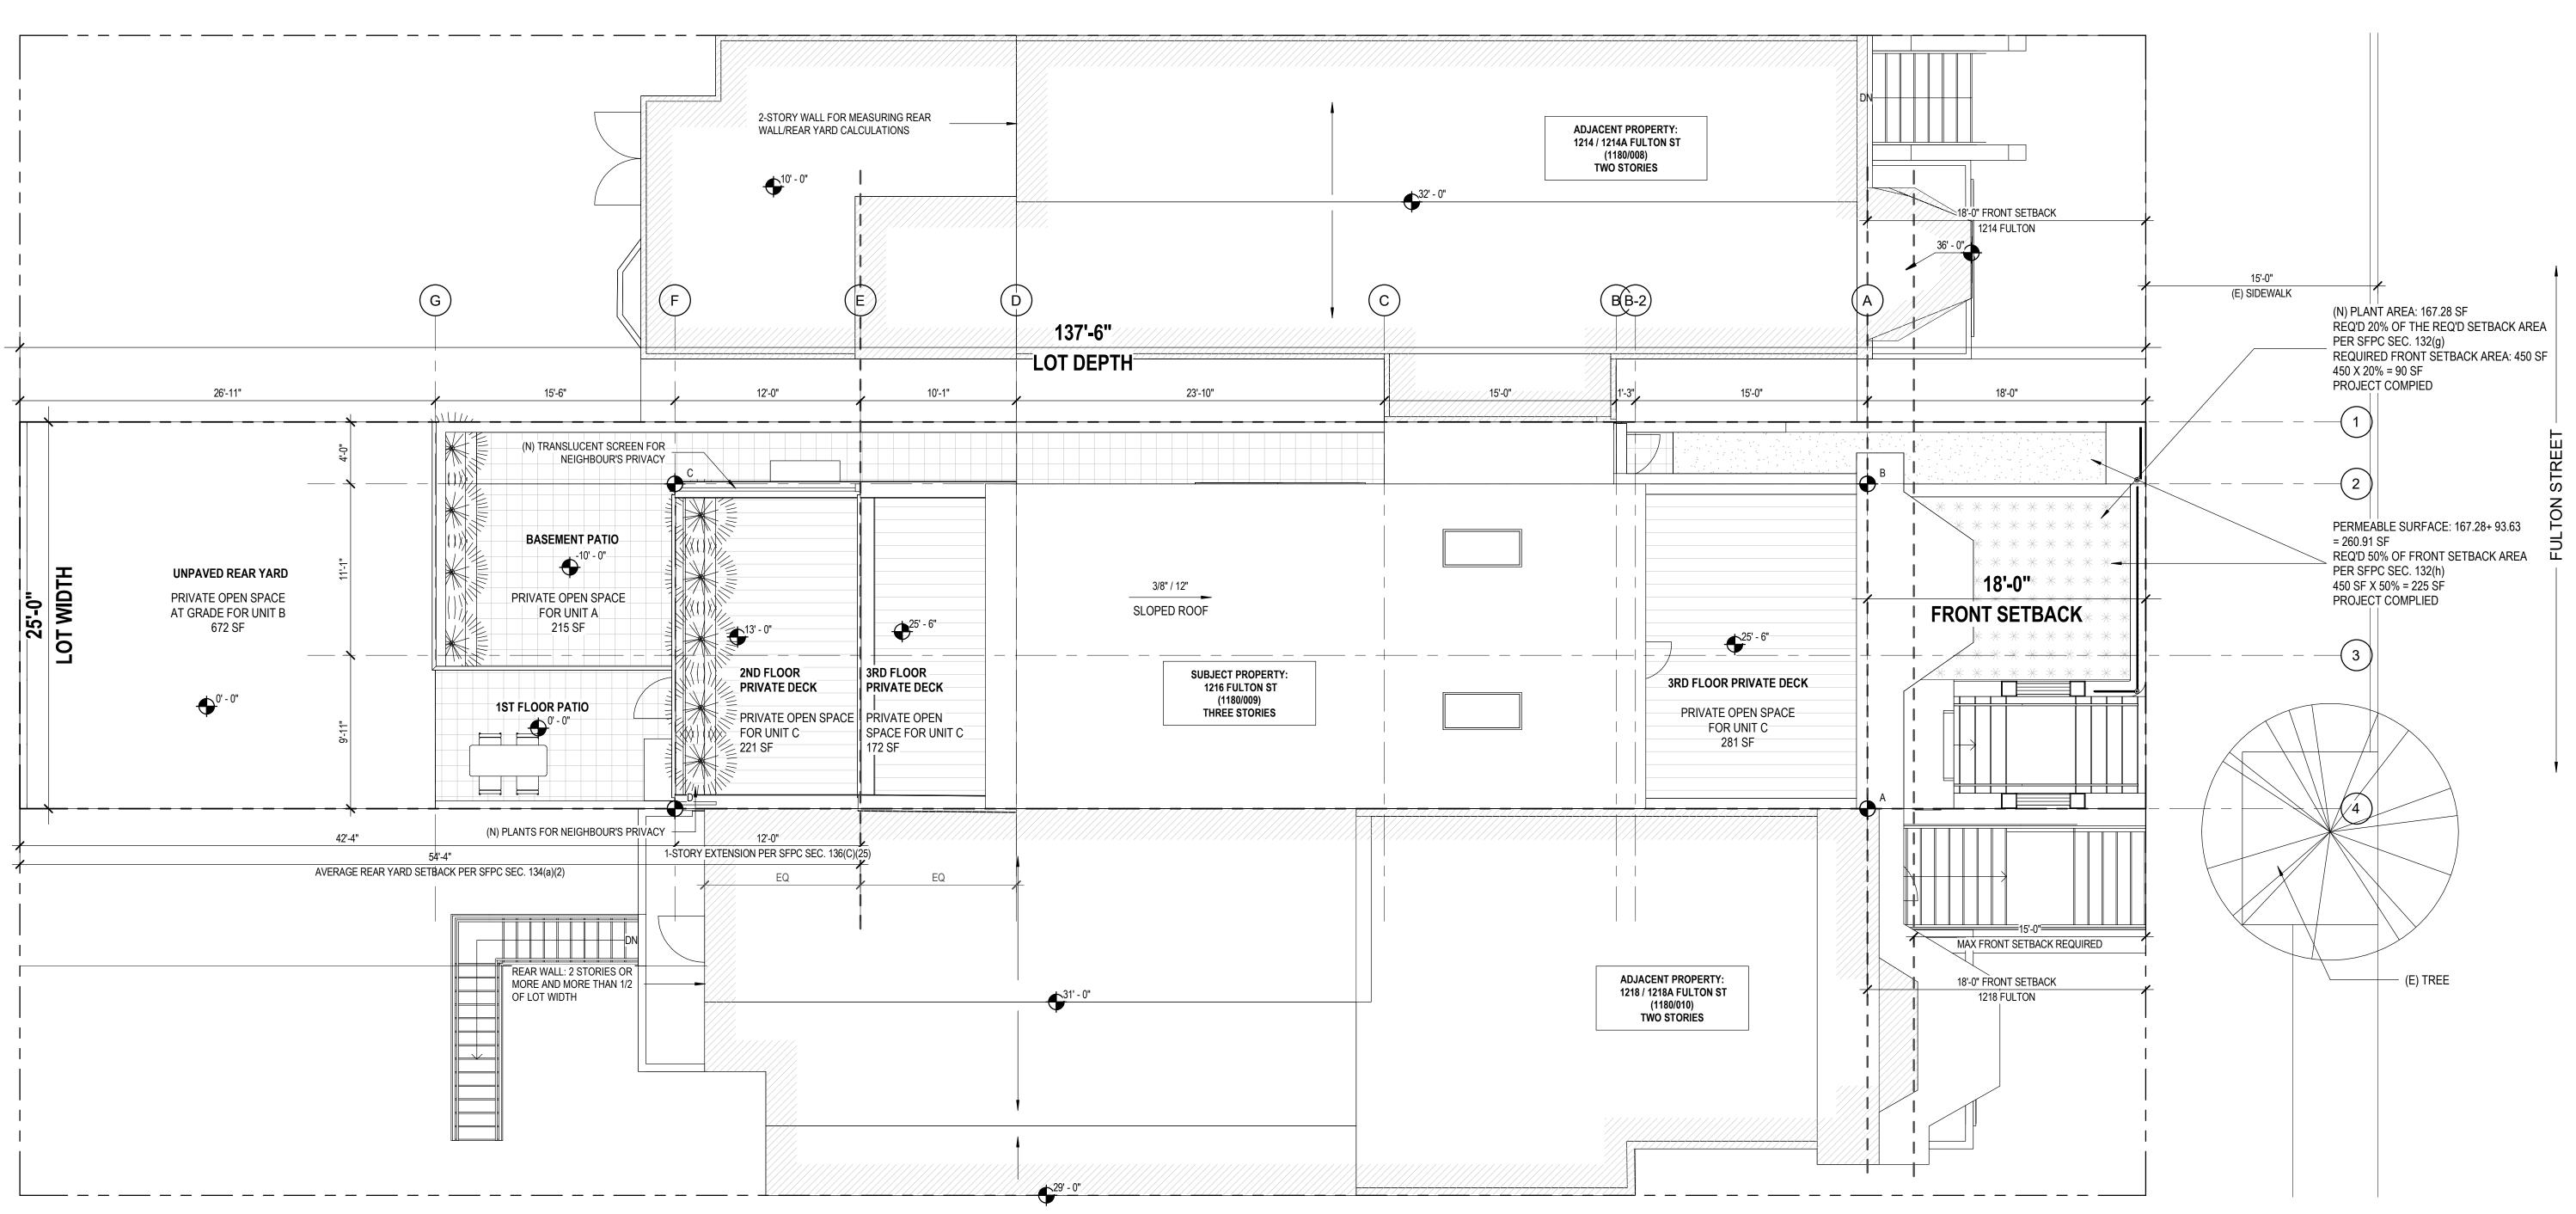



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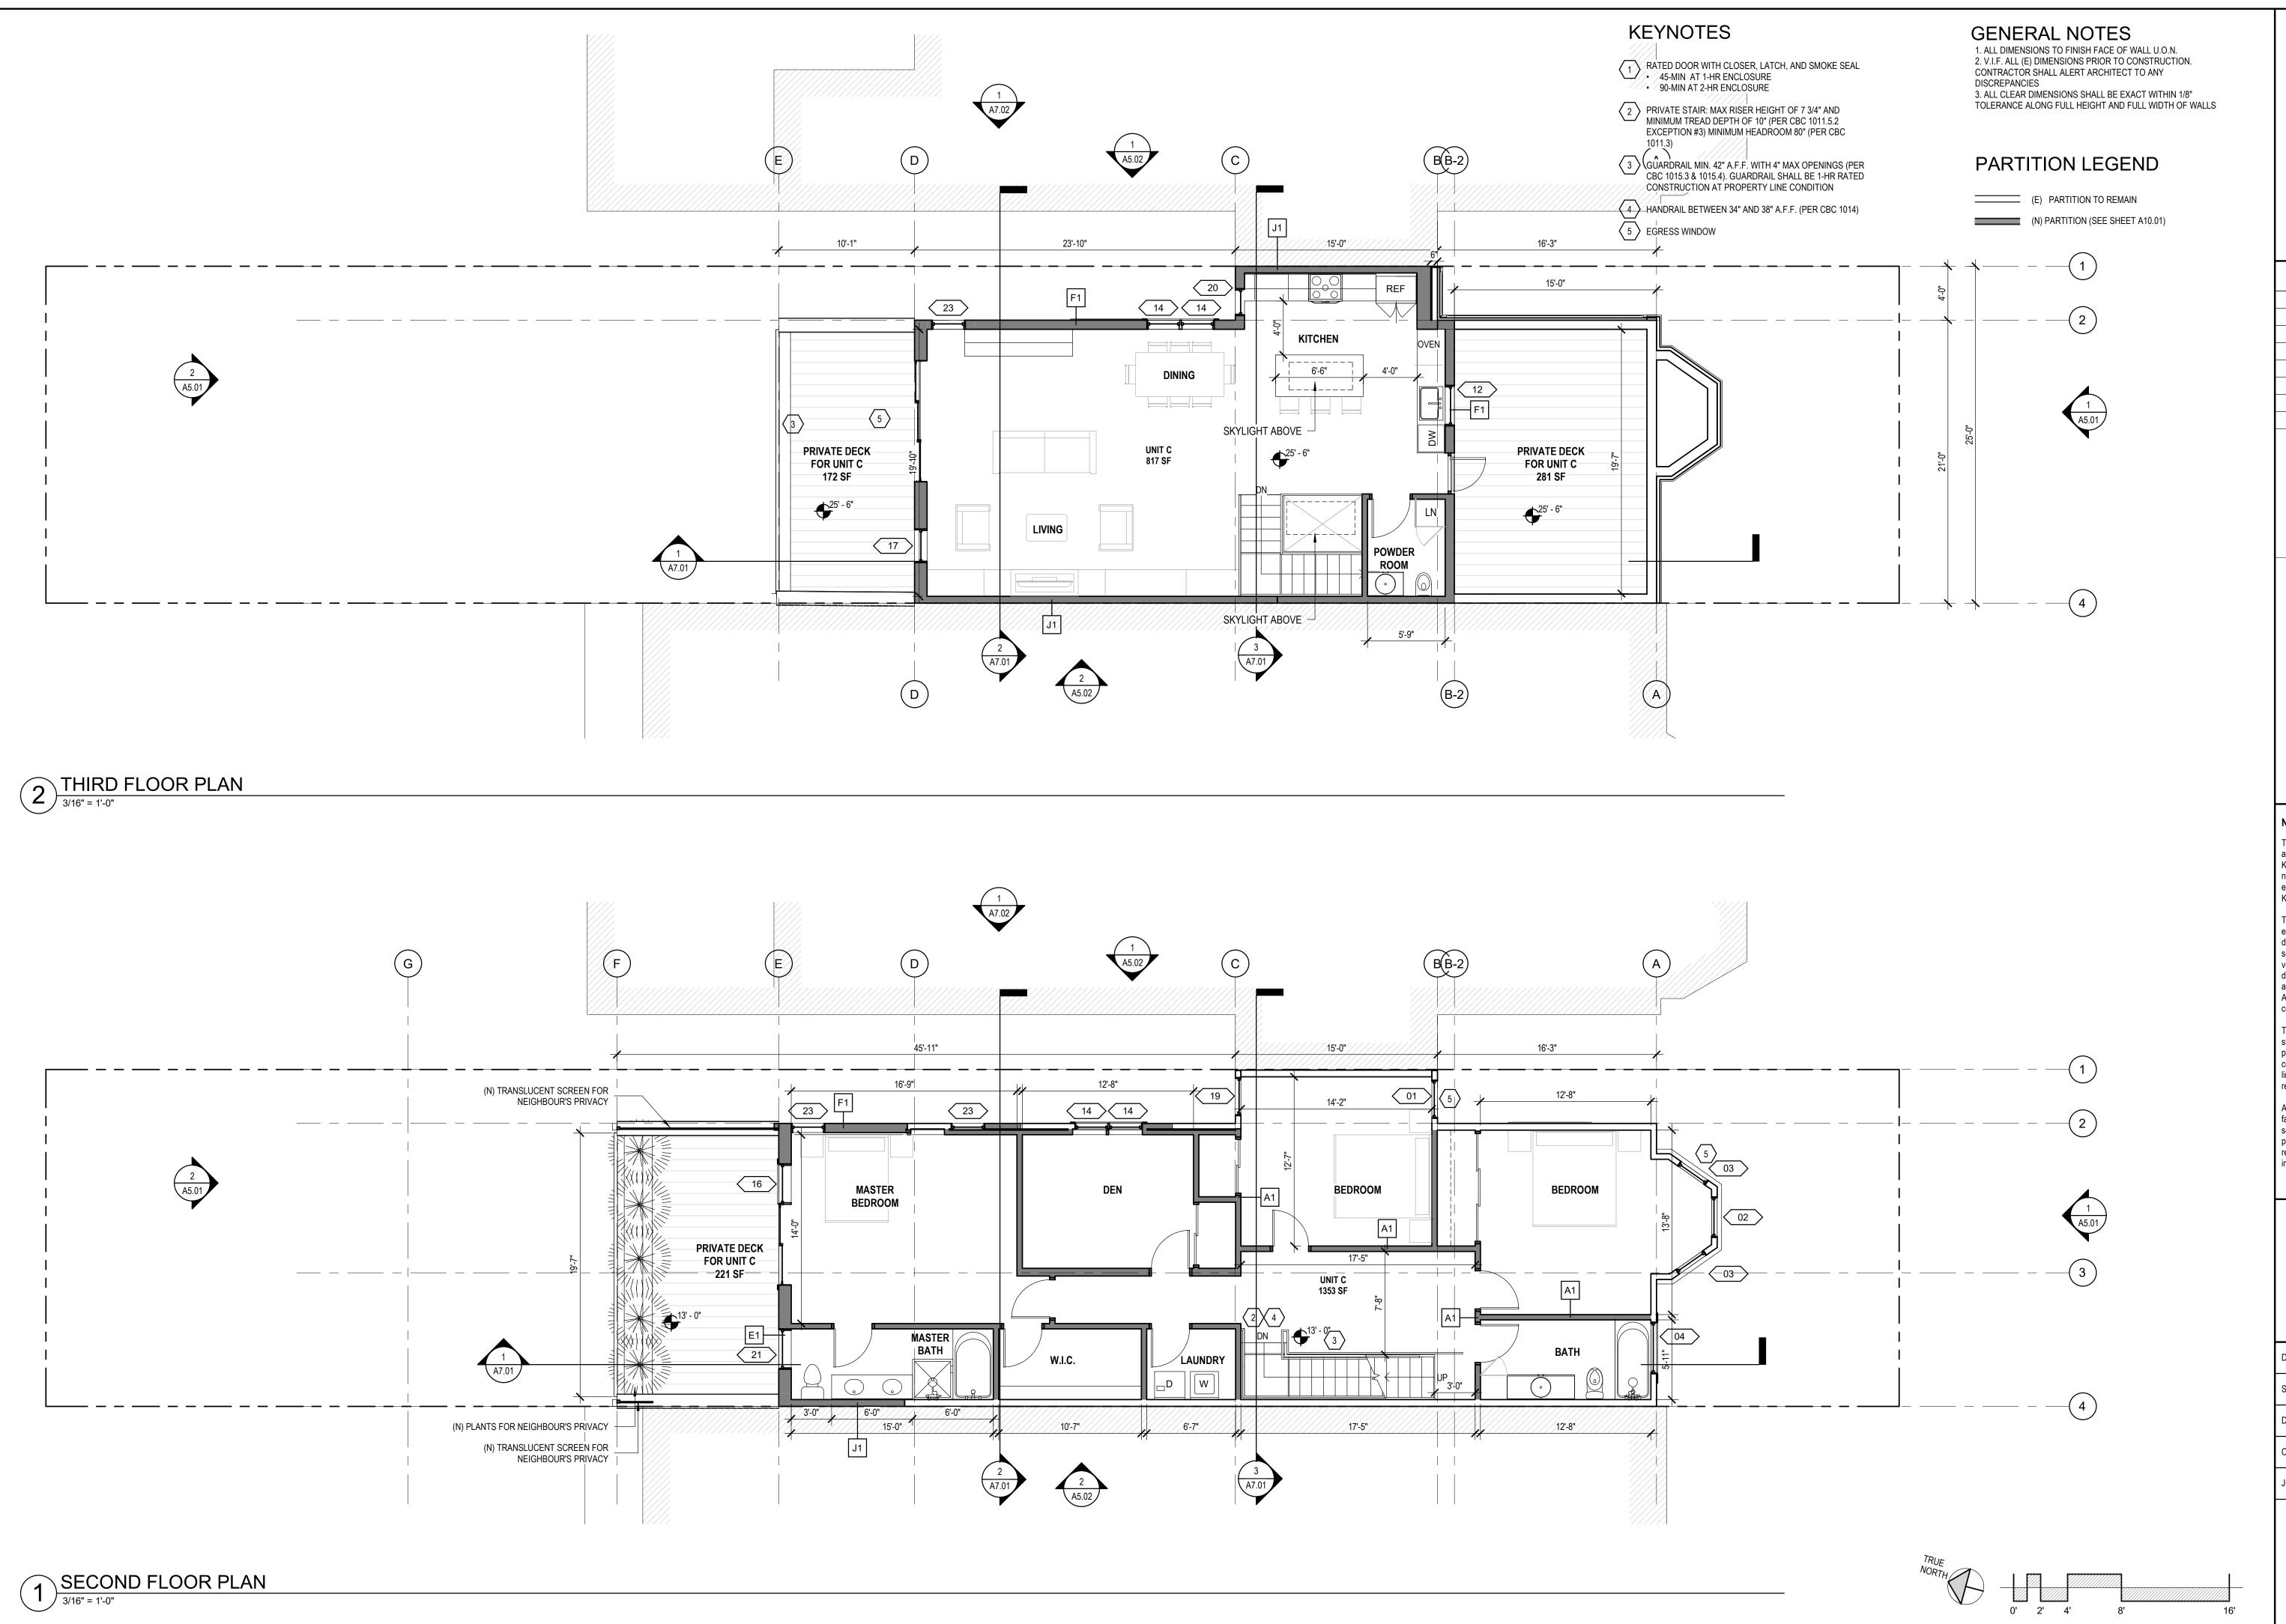
FLOOR PLANS

11/08/2019 As indicated

Author

Checker

A2.01



kerman morris

architects LLP

139 Noe Street
San Francisco, CA

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SAN FRANCISCO, CA 94117

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FLOOR PLANS

DATE 11/08/2019

SCALE As indicated

DRAWN BY Author

CHECKED BY Checker

JOB NO.

A2.02

| | WINDOW SCHEDULE | | | | | | |
|------|-----------------|---------|------------------|-------|--------|----------|------------------------------|
| Туре | Type R.O. | | | | | | |
| Mark | Width | Height | WINDOW TYPE | Count | Finish | Comments | STATUS |
| 01 | 2' - 10" | 8' - 0" | DOUBLE HUNG ARCH | 2 | WOOD | EERO | EXISTING TO REPAIR AS NEEDED |
| 02 | 3' - 0" | 8' - 0" | DOUBLE HUNG ARCH | 2 | WOOD | | EXISTING TO REPAIR AS NEEDED |
| 03 | 2' - 6" | 8' - 0" | DOUBLE HUNG ARCH | 4 | WOOD | | EXISTING TO REPAIR AS NEEDED |
| 04 | 3' - 10" | 8' - 0" | DOUBLE HUNG ARCH | 1 | WOOD | | EXISTING TO REPAIR AS NEEDED |
| 05 | 2' - 10" | 8' - 0" | DOUBLE HUNG | 1 | WOOD | | EXISTING TO REPAIR AS NEEDED |
| 11 | 3' - 0" | 2' - 6" | AWNING | 1 | WOOD | | NEW |
| 12 | 3' - 0" | 4' - 0" | DOUBLE HUNG | 1 | WOOD | | NEW |
| 13 | 3' - 0" | 6' - 0" | DOUBLE HUNG | 3 | WOOD | | NEW |
| 14 | 2' - 6" | 5' - 4" | DOUBLE HUNG | 6 | WOOD | | NEW |
| 15 | 2' - 6" | 5' - 0" | DOUBLE HUNG | 4 | WOOD | | NEW |
| 16 | 3' - 0" | 5' - 6" | DOUBLE HUNG | 1 | WOOD | | NEW |
| 17 | 2' - 6" | 5' - 6" | DOUBLE HUNG | 1 | WOOD | | NEW |
| 19 | 2' - 10" | 8' - 0" | DOUBLE HUNG | 1 | WOOD | | NEW |
| 20 | 2' - 0" | 4' - 0" | DOUBLE HUNG | 1 | WOOD | | NEW |
| 21 | 3' - 0" | 5' - 6" | DOUBLE HUNG | 1 | WOOD | | NEW |
| 22 | 3' - 0" | 5' - 0" | DOUBLE HUNG | 2 | WOOD | | NEW |
| 23 | 2' - 6" | 5' - 4" | DOUBLE HUNG | 7 | WOOD | | NEW |
| 51 | 3' - 0" | 2' - 0" | FIXED | 1 | WOOD | TRANSOM | NEW |
| 52 | 2' - 6" | 2' - 0" | FIXED | 1 | WOOD | TRANSOM | NEW |
| 53 | 2' - 6" | 2' - 6" | FIXED | 2 | WOOD | | NEW |
| 54 | 9' - 0" | 2' - 0" | FIXED | 3 | WOOD | TRANSOM | NEW |
| 70 | 2' - 4" | 5' - 0" | SKYLIGHT | 2 | METAL | | NEW |



PROPOSED ELEVATION - NORTH (REAR)

3/16" = 1'-0"

LOT WIDTH

54

19

05

- (N) WOOD SLIDING DOOR WITH TRIMS

(N) WOOD DOUBLE HUNG WINDOW

- (N) SIDING TO MATCH EXISTING, TYP.

(N) WOOD FIXED WINDOW

(N) SIDING TO MATCH EXISTING, TYP.

(N) TRANSLUCENT SCREEN FOR NEIGHBOUR'S PRIVACY

(N) WOOD FIXED WINDOW

- WOOD GUARDRAIL, TYP.

- (N) WOOD SLIDING DOOR

PAINTED WOOD COPING

ROOF 37' - 3"

THIRD FLOOR 25' - 6"

SECOND FLOOR 13' - 0"

FIRST FLOOR

(N) BASEMENT -10' -0"

25'-0"

(N) WOOD DOUBLE HUNG WINDOW WITH TRIMS

(N) SIDING TO MATCH EXISTING, TYP. $\,-\,$

(N) WOOD DOUBLE HUNG WINDOW

(E) SIDING TO REMIAN

(N) TRANSLUCENT

NEIGHBOUR'S PRIVACY

(E) WINDOW TO REMAIN & REPAIR -

(N) WOOD DOUBLE HUNG WINDOWS

(N) WOOD SLIDING WINDOW WITH TRIMS

GRADE PLANE

SCREEN FOR

PROPOSED ELEVATION - SOUTH (FRONT)

3/16" = 1'-0"

kerman morris architects up

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Revisions

C-24585 G

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SAN FRANCISCO, CA 94117

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EXTERIOR ELEVATIONS

 DATE
 11/08/2019


 SCALE
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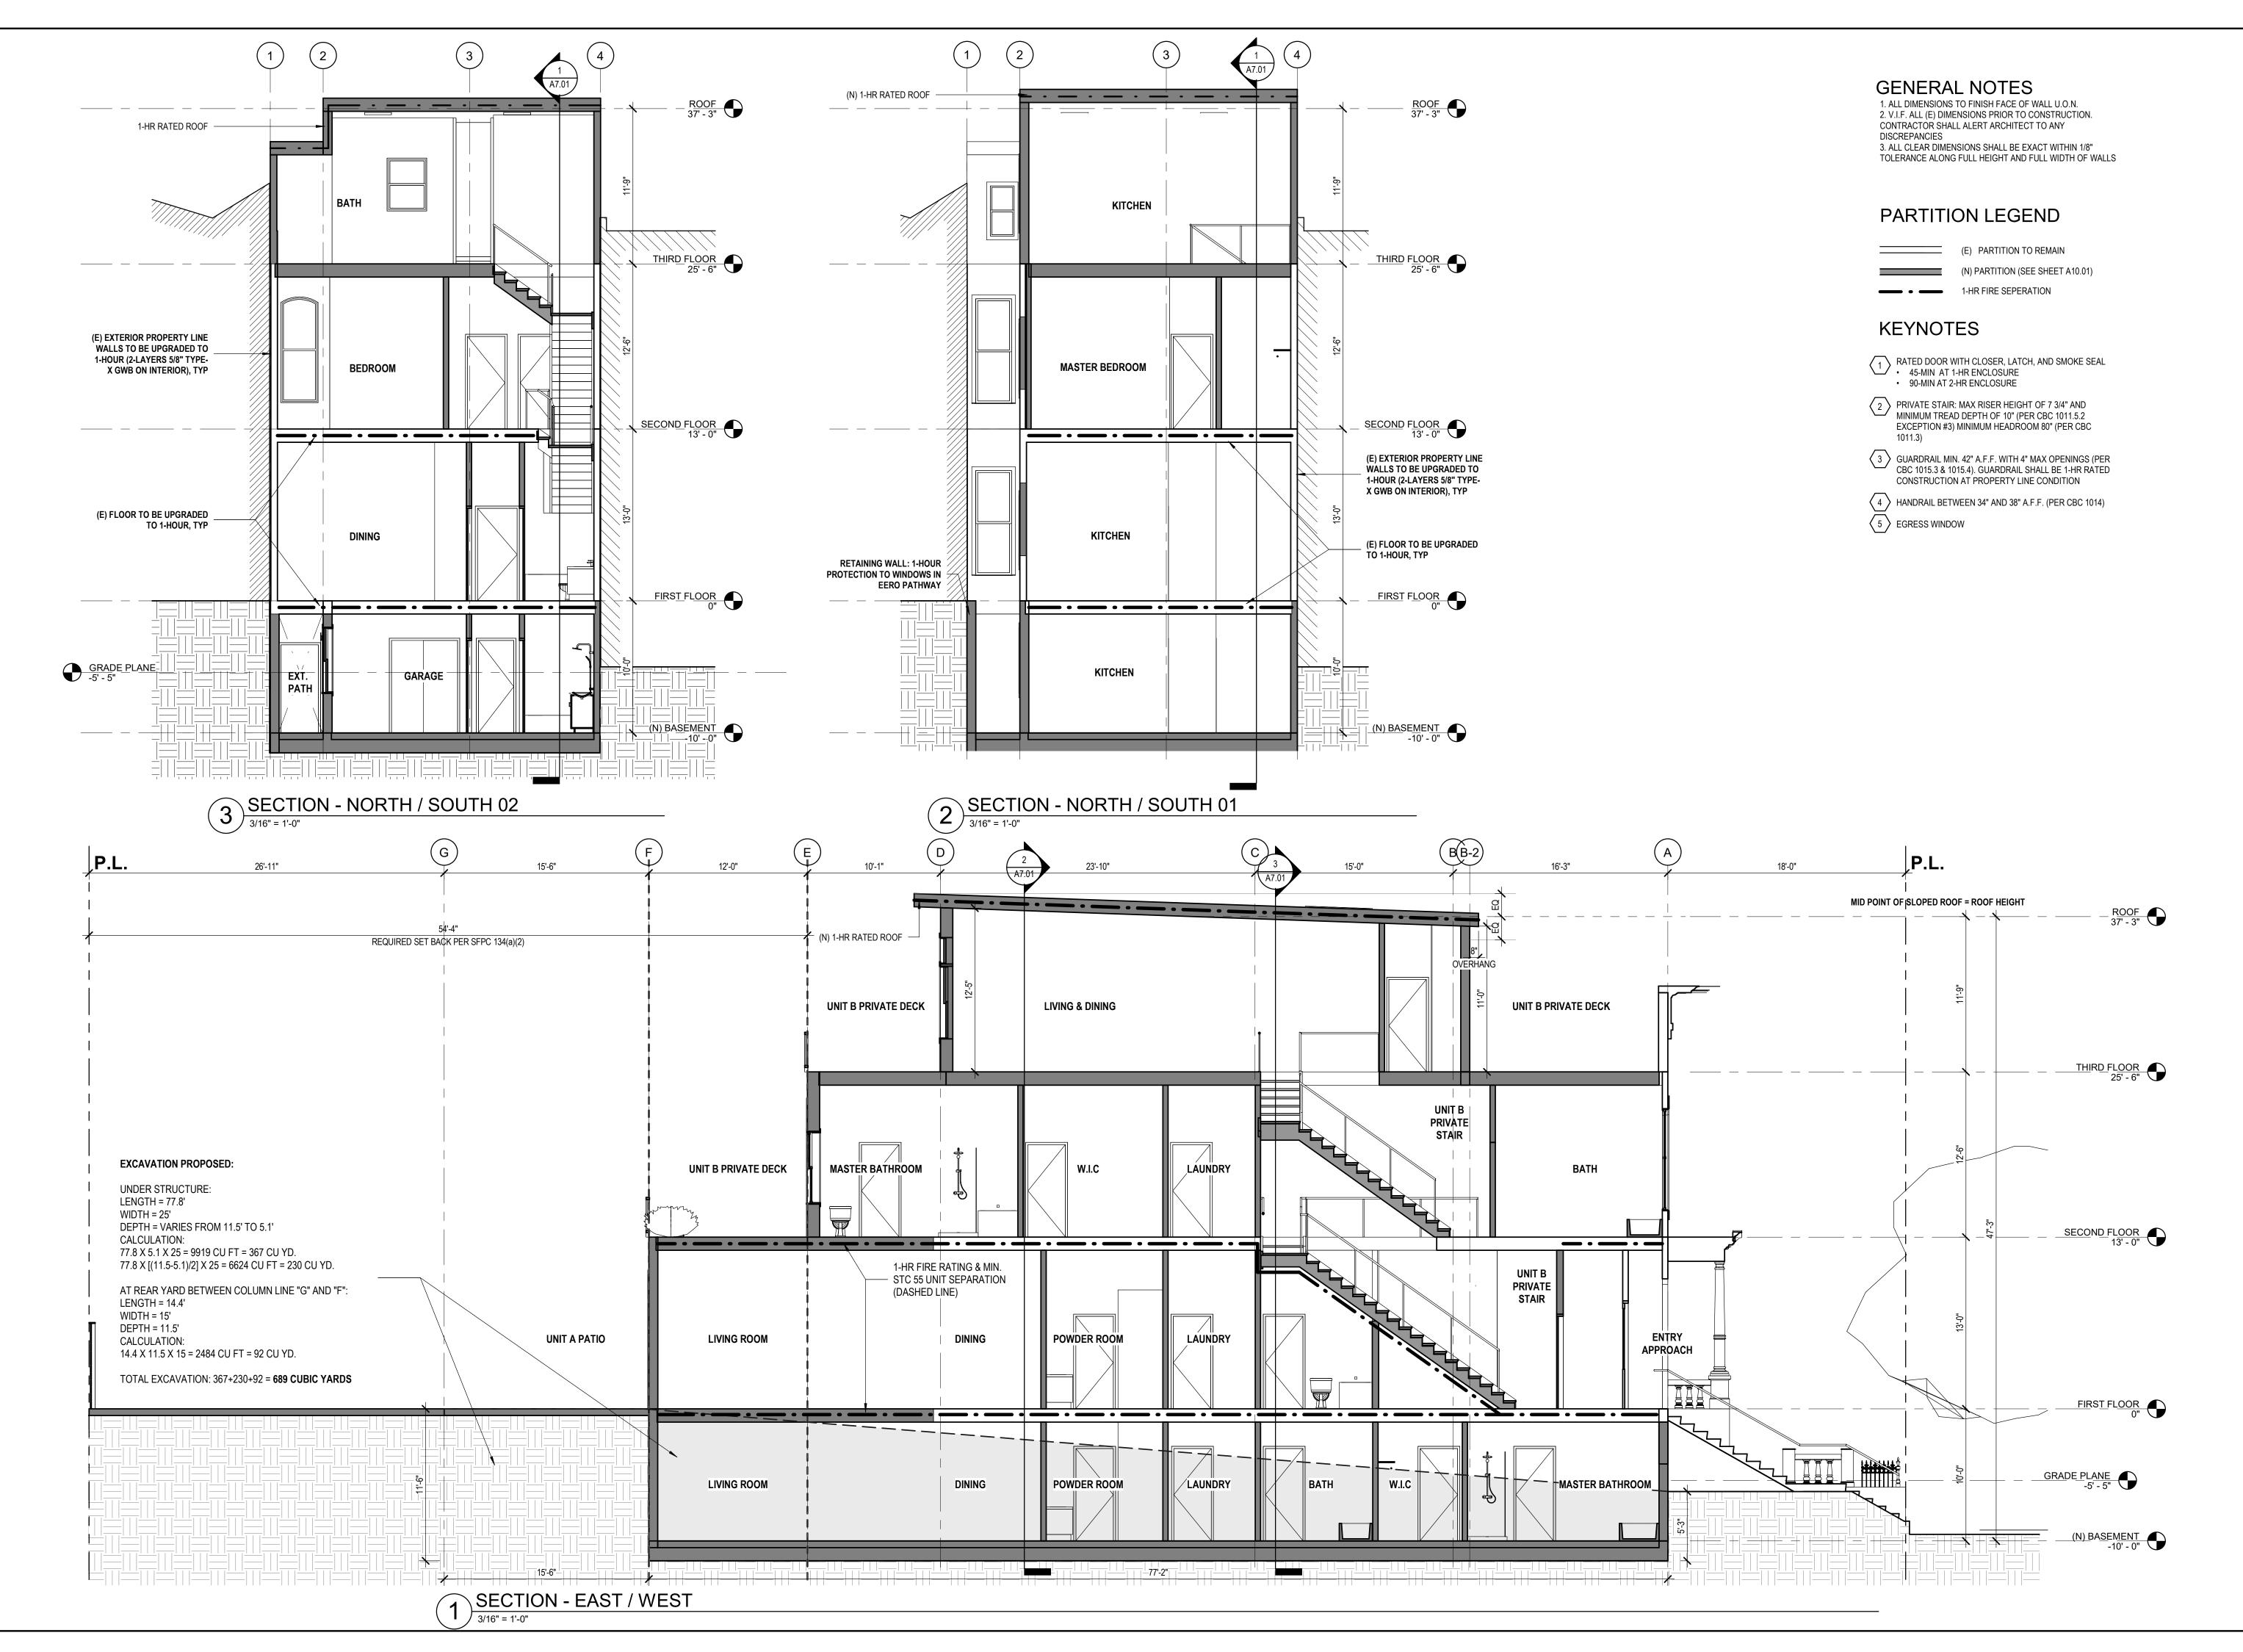
 DRAWN BY
 Author

 CHECKED BY
 Checker

 JOB NO.
 1804

A5.01



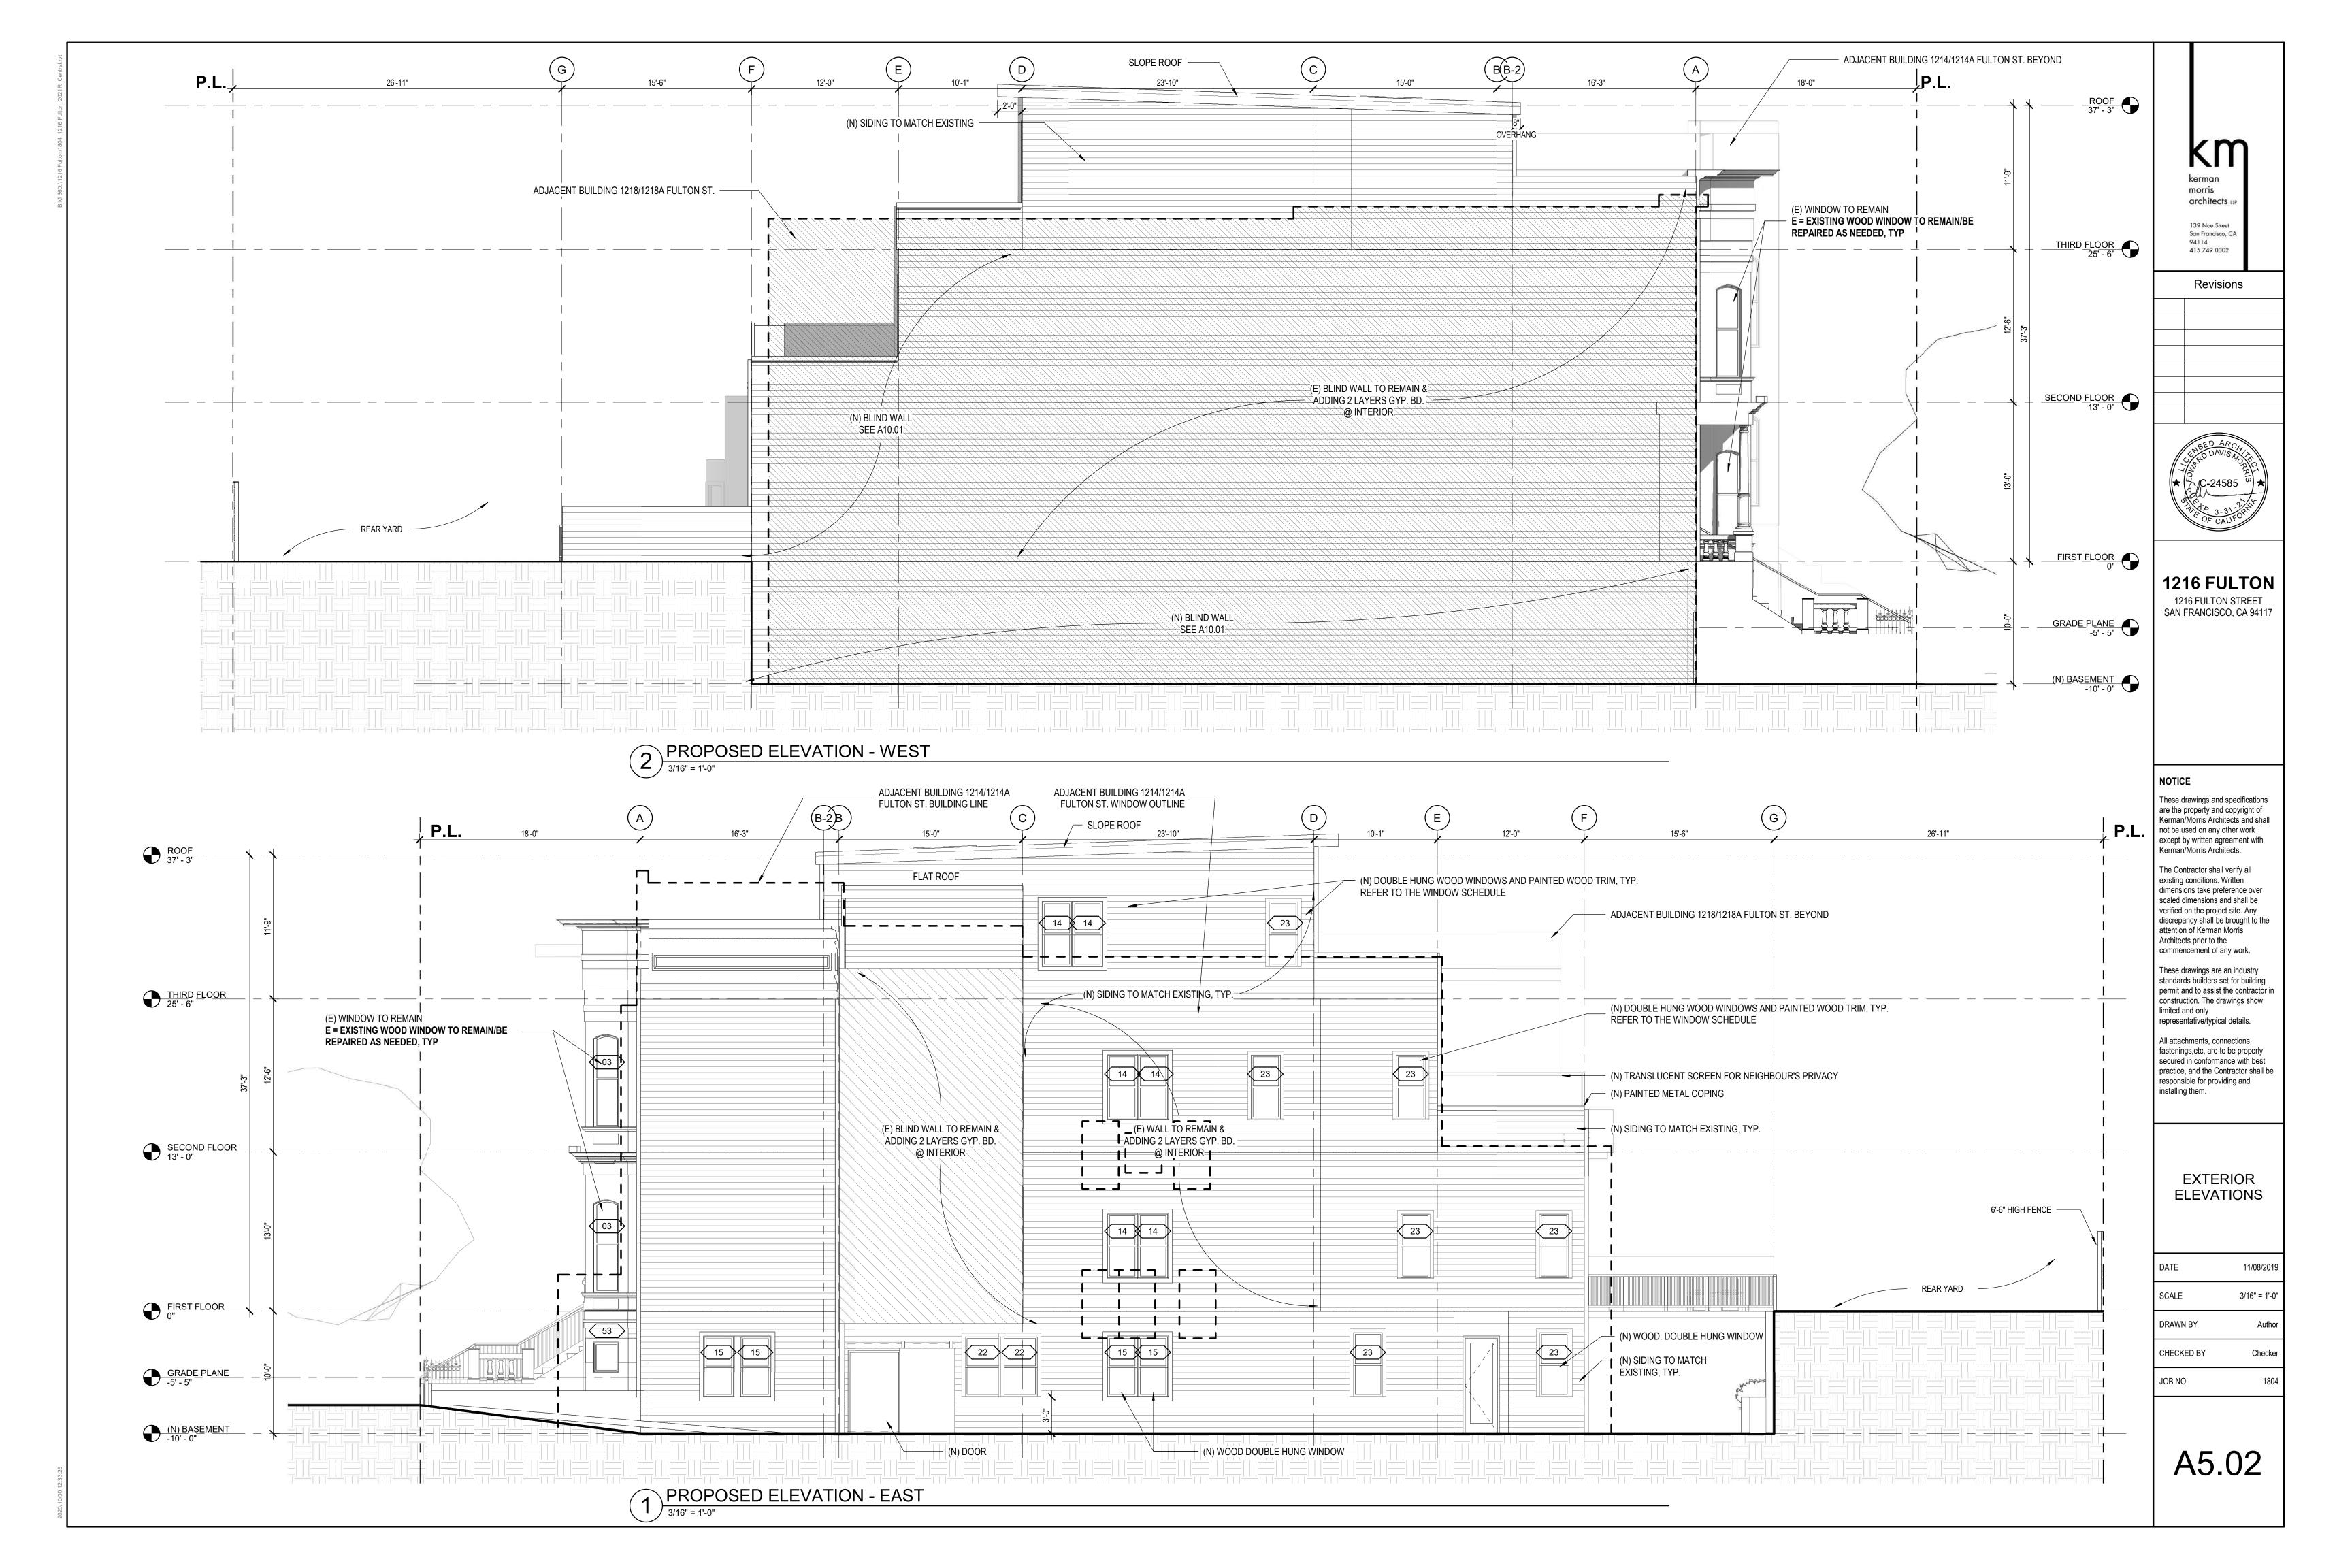

kerman morris architects LLP

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415 749 0302

C-24585 OF CALIFORNIA

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BUILDING SECTIONS

DATE 11/08/2019

SCALE As indicated

DRAWN BY Author

CHECKED BY Checker


JOB NO. 1804

A7.01

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Revisions

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SITE ANALYSIS

DATE 05/15/17

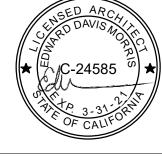
SCALE 1/8" = 1'-0"

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A7.02





49 South Van Ness Avenue, Suite 1400 San Francisco, CA 94103 628.652.7600 www.sfplanning.org

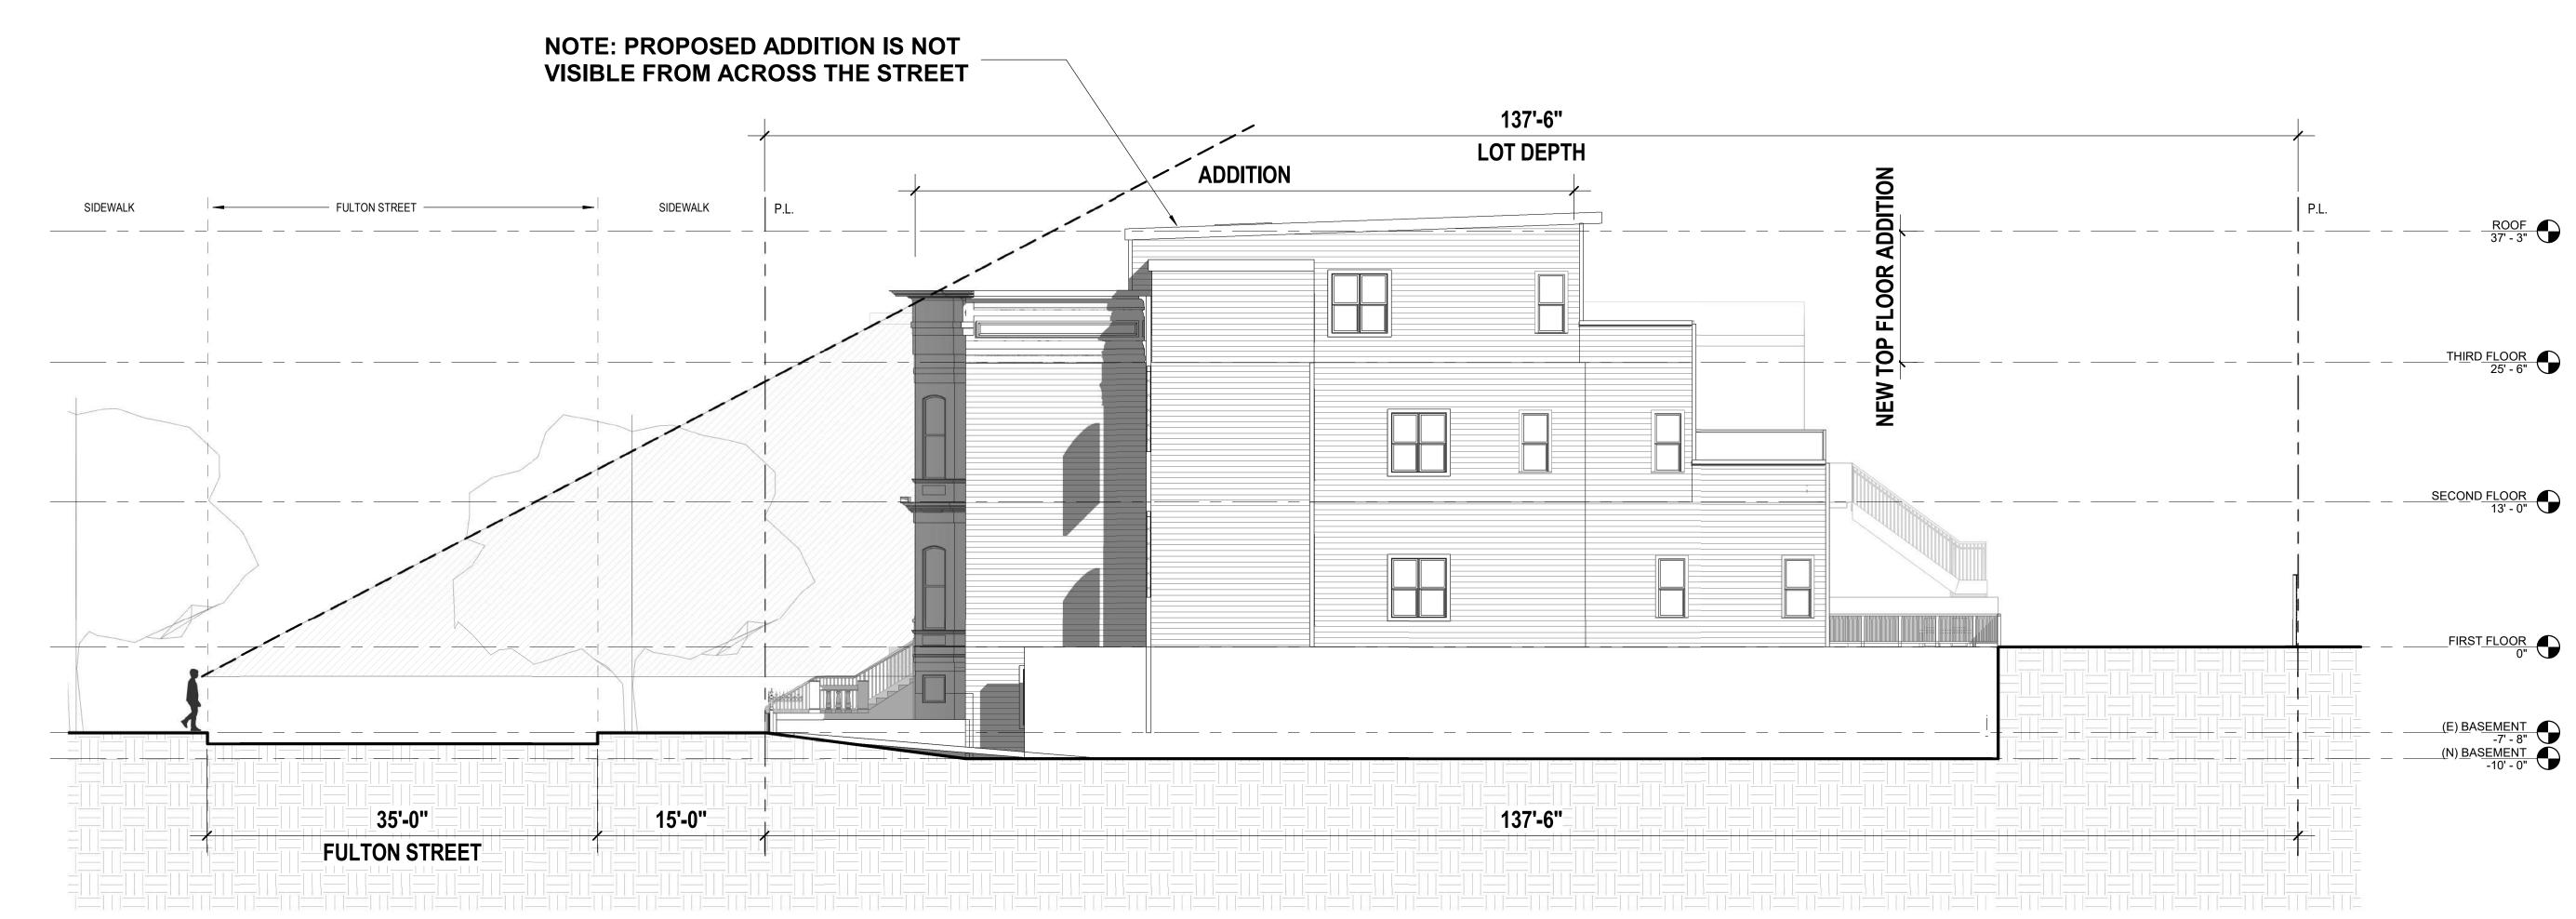CEQA Categorical Exemption Determination

PROPERTY INFORMATION/PROJECT DESCRIPTION

| Project Address | | | Block/Lot(s) | |
|---------------------|---|--|--|--|
| 1216 Fulton Street | | | 1180009 | |
| Case No. | | | Permit No. | |
| 2019-021869ENV | | | 201911086888 | |
| _ | Idition/ teration | ☐ Demolition (requires HRE for Category B Building) | New Construction | |
| The palso in approx | Project description for Planning Department approval. The project involves the adding a third story to the existing two-story, two-unit residential building. The project also involves interior alterations and adding habitable space to the basement. The project would add approximately 2,063 square feet. The new building would be three stories and 5,745 gross square feet in size. The project would require approxaimtely 12 feet of excavation. | | | |
| | | | | |
| The p | CEQA). | etermined to be categorically exempt under the | | |
| The p | project has been d CEQA). | | | |
| The p | oroject has been d CEQA). Class 1 - Existin Class 3 - New C | g Facilities. Interior and exterior alterations; addit onstruction. Up to three new single-family resider reial/office structures; utility extensions; change of | ions under 10,000 sq. ft. | |
| The p | Class 1 - Existin Class 3 - New Cobuilding; comme permitted or with Class 32 - In-Fil 10,000 sq. ft. and (a) The project is policies as well a (b) The proposed substantially surful (c) The project s (d) Approval of the water quality. (e) The site can | g Facilities. Interior and exterior alterations; addit onstruction. Up to three new single-family resider reial/office structures; utility extensions; change of | ions under 10,000 sq. ft. Inces or six dwelling units in one use under 10,000 sq. ft. if principally Inces or six dwelling units in one use under 10,000 sq. ft. if principally Inces or six dwelling units in one use under 10,000 sq. ft. Inces or six dwelling units in one use units or additions greater than Inces or six dwelling units in one use units or additions greater than Inces or six dwelling units in one use units or additions greater than Inces or six dwelling units in one use units or additions greater than Inces or six dwelling units in one use units or additions greater than Inces or six dwelling units in one use unit | |

STEP 2: CEQA IMPACTS

TO BE COMPLETED BY PROJECT PLANNER

| | Air Quality: Would the project add new sensitive receptors (specifically, schools, day care facilities, hospitals, residential dwellings, and senior-care facilities within an Air Pollution Exposure Zone? Does the project have the potential to emit substantial pollutant concentrations (e.g., backup diesel generators, heavy industry, diesel trucks, etc.)? (refer to EP_ArcMap > CEQA Catex Determination Layers > Air Pollution Exposure Zone) |
|-----|--|
| | Hazardous Materials: If the project site is located on the Maher map or is suspected of containing hazardous materials (based on a previous use such as gas station, auto repair, dry cleaners, or heavy manufacturing, or a site with underground storage tanks): Would the project involve 50 cubic yards or more of soil disturbance - or a change of use from industrial to residential? Note that a categorical exemption shall not be issued for a project located on the Cortese List if the applicant presents documentation of enrollment in the San Francisco Department of Public Health (DPH) Maher program, a DPH waiver from the Maher program, or other documentation from Environmental Planning staff that hazardous material effects would be less than significant (refer to EP_ArcMap > Maher layer). |
| | Transportation: Does the project involve a child care facility or school with 30 or more students, or a location 1,500 sq. ft. or greater? Does the project have the potential to adversely affect transit, pedestrian and/or bicycle safety (hazards) or the adequacy of nearby transit, pedestrian and/or bicycle facilities? |
| | Archeological Resources: Would the project result in soil disturbance/modification greater than two (2) feet below grade in an archeological sensitive area or eight (8) feet in a non-archeological sensitive area? If yes, archeo review is required (refer to EP_ArcMap > CEQA Catex Determination Layers > Archeological Sensitive Area) |
| | Subdivision/Lot Line Adjustment: Does the project site involve a subdivision or lot line adjustment on a lot with a slope average of 20% or more? (refer to EP_ArcMap > CEQA Catex Determination Layers > Topography). If yes, Environmental Planning must issue the exemption. |
| | Slope = or > 25%: Does the project involve any of the following: (1) square footage expansion greater than 500 sq. ft. outside of the existing building footprint, (2) excavation of 50 cubic yards or more of soil, (3) new construction? (refer to EP_ArcMap > CEQA Catex Determination Layers > Topography) If box is checked, a geotechnical report is required and Environmental Planning must issue the exemption. |
| | Seismic: Landslide Zone: Does the project involve any of the following: (1) square footage expansion greater than 500 sq. ft. outside of the existing building footprint, (2) excavation of 50 cubic yards or more of soil, (3) new construction? (refer to EP_ArcMap > CEQA Catex Determination Layers > Seismic Hazard Zones) If box is checked, a geotechnical report is required and Environmental Planning must issue the exemption. |
| | Seismic: Liquefaction Zone: Does the project involve any of the following: (1) square footage expansion greater than 500 sq. ft. outside of the existing building footprint, (2) excavation of 50 cubic yards or more of soil, (3) new construction? (refer to EP_ArcMap > CEQA Catex Determination Layers > Seismic Hazard Zones) If box is checked, a geotechnical report will likely be required and Environmental Planning must issue the exemption. |
| Com | ments and Planner Signature (optional): |
| | |

| | STEP 3: PROPERTY STATUS - HISTORIC RESOURCE TO BE COMPLETED BY PROJECT PLANNER | | |
|--|--|--|--|
| PROP | PROPERTY IS ONE OF THE FOLLOWING: (refer to Property Information Map) | | |
| | Category A: Known Historical Resource. GO TO STEP 5. | | |
| | Category B: Potential Historical Resource (over 45 years of age). GO TO STEP 4. | | |
| | Category C: Not a Historical Resource or Not Age Eligible (under 45 years of age). GO TO STEP 6. | | |
| STEP 4: PROPOSED WORK CHECKLIST TO BE COMPLETED BY PROJECT PLANNER | | | |
| Check all that apply to the project. | | | |
| | 1. Change of use and new construction. Tenant improvements not included. | | |

2. Regular maintenance or repair to correct or repair deterioration, decay, or damage to building. 3. Window replacement that meets the Department's Window Replacement Standards. Does not include storefront window alterations. 4. Garage work. A new opening that meets the Guidelines for Adding Garages and Curb Cuts, and/or replacement of a garage door in an existing opening that meets the Residential Design Guidelines. 5. Deck, terrace construction, or fences not visible from any immediately adjacent public right-of-way. 6. Mechanical equipment installation that is not visible from any immediately adjacent public right-of-way. 7. Dormer installation that meets the requirements for exemption from public notification under Zoning Administrator Bulletin No. 3: Dormer Windows. 8. Addition(s) that are not visible from any immediately adjacent public right-of-way for 150 feet in each direction; does not extend vertically beyond the floor level of the top story of the structure or is only a single story in height; does not have a footprint that is more than 50% larger than that of the original building; and does not cause the removal of architectural significant roofing features. Note: Project Planner must check box below before proceeding. Project is not listed. GO TO STEP 5. Project does not conform to the scopes of work. GO TO STEP 5. Project involves four or more work descriptions. GO TO STEP 5. Project involves less than four work descriptions. GO TO STEP 6.

STEP 5: CEQA IMPACTS - ADVANCED HISTORICAL REVIEW

TO BE COMPLETED BY PROJECT PLANNER

| Chec | Check all that apply to the project. | | |
|------|---|--|--|
| | 1. Project involves a known historical resource (CEQA Category A) as determined by Step 3 and conforms entirely to proposed work checklist in Step 4. | | |
| | 2. Interior alterations to publicly accessible spaces. | | |
| | 3. Window replacement of original/historic windows that are not "in-kind" but are consistent with existing historic character. | | |
| | 4. Façade/storefront alterations that do not remove, alter, or obscure character-defining features. | | |
| | 5. Raising the building in a manner that does not remove, alter, or obscure character-defining features. | | |
| | 6. Restoration based upon documented evidence of a building's historic condition, such as historic photographs, plans, physical evidence, or similar buildings. | | |
| | 7. Addition(s) , including mechanical equipment that are minimally visible from a public right-of-way and meet the <i>Secretary of the Interior's Standards for Rehabilitation</i> . | | |

| | 8. Other work consistent with the Secretary of the Interior State Properties (specify or add comments): | ndards for the Treatment of Historic | |
|---------|--|--------------------------------------|--|
| | | | |
| | 9. Other work that would not materially impair a historic distric | t (specify or add comments): | |
| | | | |
| | (Requires approval by Senior Preservation Planner/Preservation | on Coordinator) | |
| | 10. Reclassification of property status . (Requires approval be Planner/Preservation | y Senior Preservation | |
| | Reclassify to Category A | Reclassify to Category C | |
| | a. Per HRER or PTR dated | (attach HRER or PTR) | |
| | b. Other (specify): | | |
| | Note: If ANY box in STEP 5 above is checked, a Pre | servation Planner MUST sign below. | |
| | Project can proceed with categorical exemption review. The project has been reviewed by the Preservation Planner and can proceed with categorical exemption review. GO TO STEP 6. | | |
| Third s | Comments (optional): Third story addition will be minimally visible from public right of way as detailed in sightline study provided in blans. Rear addition will not be visible from the street. Facade alterations include compatible new wood windows | | |
| Preser | Preservation Planner Signature: Shannon Ferguson | | |
| _ | STEP 6: CATEGORICAL EXEMPTION DETERMINATION TO BE COMPLETED BY PROJECT PLANNER | | |
| | No further environmental review is required. The project is categorically exempt under CEQA. There are no unusual circumstances that would result in a reasonable possibility of a significant effect. | | |
| | Project Approval Action: | Signature: | |
| | Building Permit If Discretionary Review before the Planning Commission is requested, | Shannon Ferguson 12/06/2020 | |
| | the Discretionary Review hearing is the Approval Action for the project. | | |
| | Once signed or stamped and dated, this document constitutes a categorical exemption pursuant to CEQA Guidelines and Chapter 31of the Administrative Code. In accordance with Chapter 31 of the San Francisco Administrative Code, an appeal of an exemption determination can only be filed within 30 days of the project receiving the approval action. Please note that other approval actions may be required for the project. Please contact the assigned planner for these approvals. | | |

STEP 7: MODIFICATION OF A CEQA EXEMPT PROJECT


TO BE COMPLETED BY PROJECT PLANNER

In accordance with Chapter 31 of the San Francisco Administrative Code, when a California Environmental Quality Act (CEQA) exempt project changes after the Approval Action and requires a subsequent approval, the Environmental Review Officer (or his or her designee) must determine whether the proposed change constitutes a substantial modification of that project. This checklist shall be used to determine whether the proposed changes to the approved project would constitute a "substantial modification" and, therefore, be subject to additional environmental review pursuant to CEQA.

MODIFIED PROJECT DESCRIPTION

| Modit | ied Project Description: | | | | |
|--|--|---|--|--|--|
| | | | | | |
| | | | | | |
| DE1 | ERMINATION IF PROJECT (| CONSTITUTES SUBSTANTIAL MODIFICATION | | | |
| Comp | pared to the approved project, w | ould the modified project: | | | |
| | Result in expansion of the build | ding envelope, as defined in the Planning Code; | | | |
| | Result in the change of use that would require public notice under Planning Code Sections 311 or 312; | | | | |
| | Result in demolition as defined under Planning Code Section 317 or 19005(f)? | | | | |
| | Is any information being presented that was not known and could not have been known at the time of the original determination, that shows the originally approved project may no longer qualify for the exemption? | | | | |
| If at I | If at least one of the above boxes is checked, further environmental review is required. | | | | |
| DET | DETERMINATION OF NO SUBSTANTIAL MODIFICATION | | | | |
| | The proposed modification would not result in any of the above changes. | | | | |
| If this box is checked, the proposed modifications are categorically exempt under CEQA, in accordance with prior project approval and no additional environmental review is required. This determination shall be posted on the Planning Department website and office and mailed to the applicant, City approving entities, and anyone requesting written notice. In accordance with Chapter 31, Sec 31.08j of the San Francisco Administrative Code, an appeal of this determination can be filed within 10 days of posting of this determination. | | | | | |
| Plani | ner Name: | Date: | | | |
| | | | | | |


Parcel Map

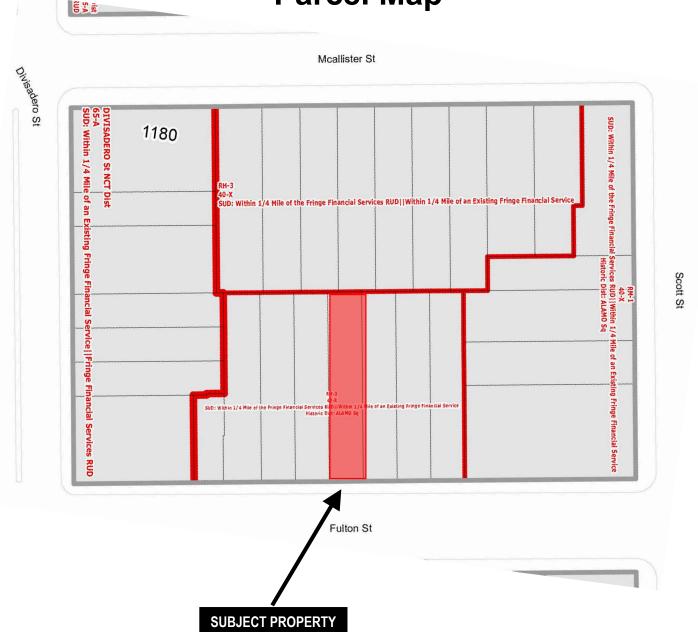



Case Number 2019-021869COA Certificate of Appropriateness Hearing 1216 Fulton Street

Sanborn Map*

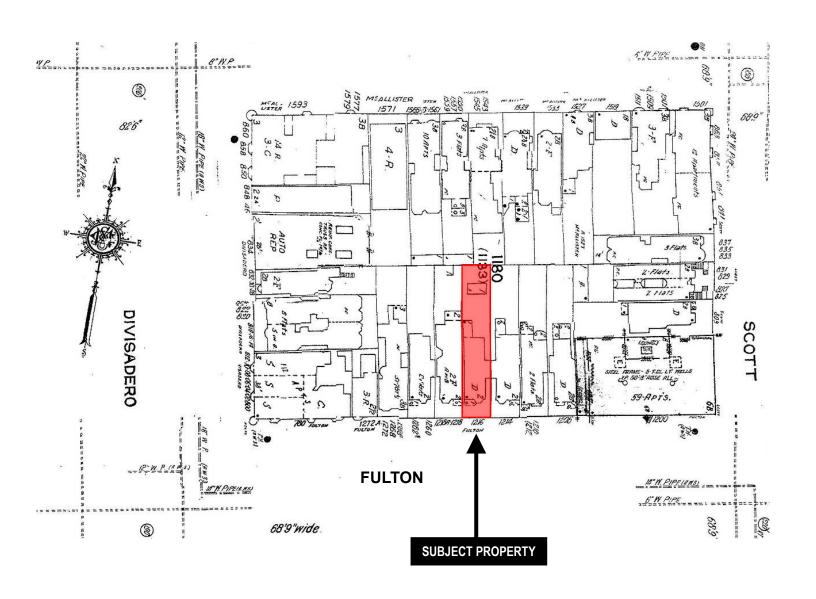

*The Sanborn Maps in San Francisco have not been updated since 1998, and this map may not accurately reflect existing conditions.




Zoning Map






Aerial Photo

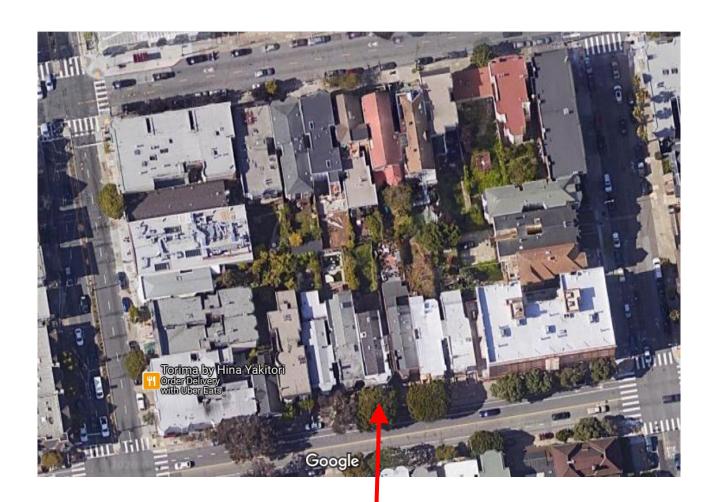

SUBJECT PROPERTY




Site Photo

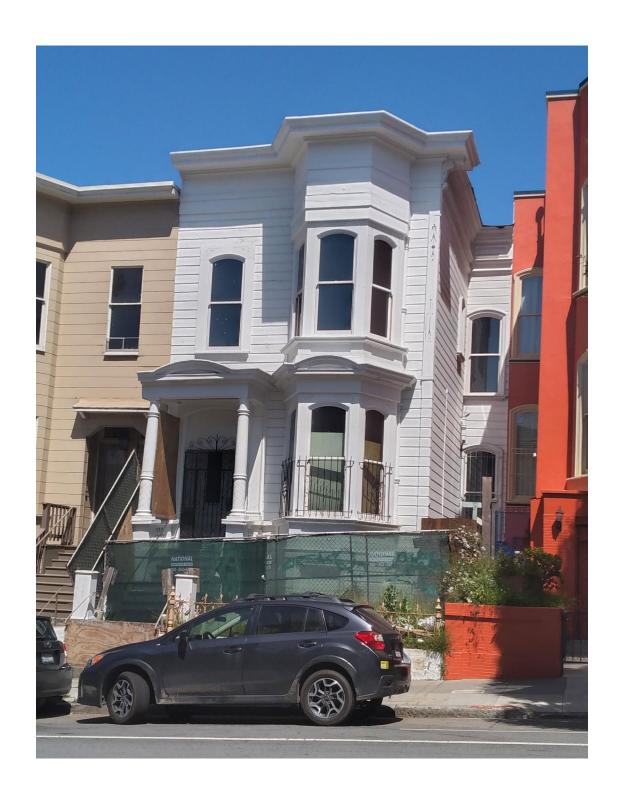

Case Number 2019-021869COA Certificate of Appropriateness Hearing 1216 Fulton Street

Context Photo

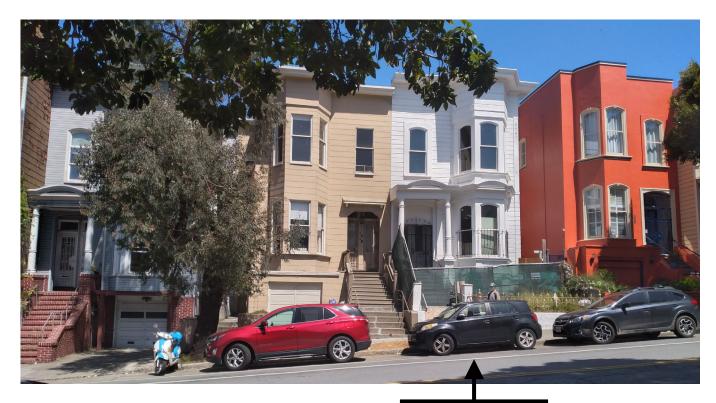

SUBJECT PROPERTY

From: <u>Joan</u>

To: Ferguson, Shannon (CPC)
Subject: 1216 Fulton Street

Date: Saturday, December 05, 2020 10:44:48 AM

This message is from outside the City email system. Do not open links or attachments from untrusted sources.

Ref: Record No 2019-021869COA

Dear Shannon,

I call a few days ago. However I have received a response. I understand with covid restrictions you may not be in the office so I decided to send an email.

This property as you are aware is in the historical block. We are neighbors with concerns about the proposed project.

Each house on this block has a garage with the exception of 1216. We would like a garage to be included as it will be uniform with all other building on this block. We as home owners realize the necessity of providing parking. We have all experienced the need to have our own garages due to the population density increase. This will only add to the already frustration problems attached to parking on our street despite having neighborhood permit parking.

How much protection does the Historical Preservation exert on the entire property. I understand the front of the property is protected. Are there any considerations given to the rear of the building for the proposed changes? We understand some modification to Victorian design but not total modern design that alters original appearance and is not consistent with existing homes.

We believe in the historical protection of Victorian homes and we appreciate your endeavor to protect the remaining historical homes of San Francisco.

Thank you for reviewing our concerns. We look forward to a reply.

Joan and neighbors.

Sent from Mail for Windows 10