Certificate of Appropriateness Executive Summary

HEARING DATE: APRIL 1, 2020

2017-013752COA

Project Address: 1772 VALLEJO ST Landmark: Landmark No. 31

Zoning: RH-2 RESIDENTIAL- HOUSE, TWO FAMILY Zoning District

40-X Height and Bulk District

Block/Lot: 0552/029

Project Sponsor: Ambrose Wong, Garavaglia Architecture

582 Market Street, Suite 1800 San Francisco, CA 94104

Staff Contact: Shannon M. Ferguson - 415-575-9074

Shannon.Ferguson@sfgov.org

415.558.6378 Fax: 415.558.6409

Reception:

1650 Mission St. Suite 400

San Francisco, CA 94103-2479

Planning Information: **415.558.6377**

PROPERTY DESCRIPTION

Record No.:

1772 VALLEJO STREET (subject property) is located on the north side of Vallejo Street between Franklin and Gough streets in San Francisco's Pacific Heights neighborhood. Also known as the Burr House, the subject property is designated as City Landmark No. 31 (1970), holds a Mills Act Contract (2013) and is listed on the National Register of Historic Places (2014).

Designed with a blend of Italianate and Second Empire style influences, the building is a three-story-over-raised-basement single-family dwelling constructed circa 1878 by former San Francisco mayor, Ephraim W. Burr, as a wedding gift for his son, Edmund Burr (a chemical engineer), and his wife Anna Barnard. The design is attributed to the builder, Edmund M. Wharf. The subject property is an extremely rare example of an Italianate and Second Empire style residence located within a large garden setting and exemplifies the type of Gilded Age properties constructed in Pacific Heights during the last quarter of the nineteenth century.

PROJECT DESCRIPTION

The proposed project is a three-story horizontal addition at the rear (north) elevation of the main house. The footprint of the addition will be approximately 9-feet by 33-feet and set in from the east and west elevations of the house. The first and second stories will be nearly the full width of the rear elevation and the third story will extend approximately half the width of the rear elevation. The addition will be clad in plaster at the first story and "V" rusticated siding to match the spacing and align with the existing channel rustic siding. The rear elevation of the addition will have a door with arched transom will be flanked by three arched windows at each side at the first story. Two banks of three arched windows will be located at the second story. The third story will contain a bank of three arched windows. All new windows will have wood, double-hung sash and a plain trim profile. Roof decks with wood railings will be located at the third and fourth stories. The west elevation of the addition will have double doors accessing the trash enclosure and one arched window at the second story. The east elevation of the addition will have one arched

window with wood, double-hung sash at the second story and a door at the third story will access the new roof deck. Please see photographs and plans for details. Please see photographs and plans for details.

COMPLIANCE WITH PLANNING CODE

Planning Code Development Standards.

The proposed project is in compliance with all other provisions of the Planning Code.

In order to proceed, a building permit from the Department of Building Inspection is required.

Applicable Preservation Standards.

The proposal overall, is appropriate for and consistent with the purposes of Article 10, meets the standards of Article 1006.6 of the Planning Code, and complies with the *Secretary of the Interior's Standards for Rehabilitation, in that:*

- the addition will be at the rear elevation of the main house and appears to be minimally visible from the street.
- the addition will remove a substantial portion of the rear elevation. However, the first and second stories have been previously altered with an enclosed room, removal of an enclosed porch and alterations to windows. The previous alterations to the first and second stories of the rear elevation have not acquired significance in their own right. The third story portion of the addition removes one historic window and is notched to retain the second historic window at this elevation. The addition retains visibility of the historic quoining at the sides the house. The roof deck at the third story will be below the bay window, which appears to allow the historic features below the bay window to remain visible. The roof deck at the fourth story is below the brackets of the mansard roof which maintains visibility;
- the massing, size and scale of the new addition is compatible with the house. The arched windows with simple profile trim and V-rusticated siding proposed for the addition is differentiated yet compatible with the size, scale, materials, and architectural features of the house;
- the new addition is constructed in a manner that may be removed in the future. The first and second stories have undergone previous alterations. At the first story, this area was previously enclosed. Also at the first story, windows proposed for infill may be opened in the future. The second story wall will be removed nearly in its entirety; however, this portion of the house has been previously altered. At the third story, one windows will be removed and used as an opening into the addition, while the other will be retained.

The Department has determined that the proposed work will be in conformance with the requirements of Article 10 and the *Secretary of Interior's Standards for Rehabilitation*. Proposed work will not damage or destroy distinguishing original qualities or character of the subject building. The Department finds that the historic character of the building will be retained and preserved and will result in a modest removal of historic fabric.

PUBLIC/NEIGHBORHOOD INPUT

The Department has received no public inquiries for general information about the proposed project at the date of this report.

ISSUES & OTHER CONSIDERATIONS

The Architectural Review Committee (ARC) of the Historic Preservation Commission reviewed the proposed project on January 15, 2020. The ARC commented that the cornice at the addition seemed insubstantial and recommended a more prominent cornice; the metal railing at the roof decks were incompatible with the materials of the subject property and recommended wood railings; the rectangular window on the west elevation of the addition is incompatible with the fenestration pattern of the subject property and recommended the window be arched with trim in a plain profile; and recommended differentiating the first story fenestration from the upper stories at the rear elevation of the addition. The project sponsor has incorporated ARC comments and the revised proposal is supported by Department Staff.

CONDITIONS OF APPROVAL

None

ENVIRONMENTAL REVIEW STATUS

The Project is exempt from the California Environmental Quality Act ("CEQA") as a Class 1 categorical exemption.

BASIS FOR RECOMMENDATION

The Department recommends APPROVAL of the proposed project as it meets the provisions of Article 10 of the Planning Code regarding Major Alteration to a contributing resource in a Landmark District and the Secretary of the Interior Standards for Rehabilitation.

ATTACHMENTS

Draft Motion - Certificate of Appropriateness

Exhibit A – Plans and Renderings

Exhibit B – Environmental Determination

Exhibit C – Maps and Context Photos

Exhibit D - Project Sponsor Brief

Certificate of Appropriateness Draft Motion

HEARING DATE: APRIL 1, 2020

1650 Mission St. Suite 400 San Francisco, CA 94103-2479

Reception: 415.558.6378

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Planning Information:

Record No.: 2017-013752COA

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ADOPTING FINDINGS FOR A CERTIFICATE OF APPROPRIATENESS FOR MAJOR ALTERATIONS DETERMINED TO BE APPROPRIATE FOR AND CONSISTENT WITH THE PURPOSES OF ARTICLE 10 OF THE SAN FRANCISCO PLANNING CODE, AND TO MEET THE SECRETARY OF THE INTERIOR'S STANDARDS FOR REHABILITATION, FOR THE PROPERTY LOCATED ON LOT 029 IN ASSESSOR'S BLOCK 0552 IN A RH-2 RESIDENTIAL- HOUSE, TWO FAMILY ZONING DISTRICT AND A 40-X HEIGHT AND BULK DISTRICT.

PREAMBLE

On September 11, 2017, Ambrose Wong of Garavaglia Architecture (hereinafter "Project Sponsor") filed Application No. 2017-013752COA (hereinafter "Application") with the San Francisco Planning Department (hereinafter "Department") for a Certificate of Appropriateness for a three-story horizontal addition at the rear elevation at the subject building located on Lot 029 in Assessor's Block 0552, which is Landmark No. 31 and locally designated under Article 10 of the Planning Code.

The Project is exempt from the California Environmental Quality Act ("CEQA") as a Class 1 categorical exemption. The Historic Preservation Commission (hereinafter "Commission") has reviewed and concurs with said determination.

On January 15, 2020, the Architectural Review Committee of the Historic Preservation Commission reviewed on commented on the proposed project.

On April 1, 2020, the Historic Preservation Commission conducted a duly noticed public hearing at a regularly scheduled meeting on Certificate of Appropriateness Application No. 2017-013752COA.

The Planning Department Commission Secretary is the custodian of records; the File for Record No. 2017-013752COA is located at 1650 Mission Street, Suite 400, San Francisco, California.

The Commission has heard and considered the testimony presented to it at the public hearing and has further considered written materials and oral testimony presented on behalf of the applicant, Department staff, and other interested parties.

MOVED, that the Commission hereby APPROVES the Certificate of Appropriateness, as requested in Application No. 2017-013752COA in conformance with the architectural plans dated February 12, 2020 and labeled Exhibit B based on the following findings:

FINDINGS

Having reviewed all the materials identified in the recitals above and having heard oral testimony and arguments, this Commission finds, concludes, and determines as follows:

- 1. The above recitals are accurate and also constitute findings of the Commission.
- 2. **Project Description**. The proposed project is a three-story horizontal addition at the rear (north) elevation of the main house. The footprint of the addition will be approximately 9-feet by 33-feet and set in from the east and west elevations of the house. The first and second stories will be nearly the full width of the rear elevation and the third story will extend approximately half the width of the rear elevation. The addition will be clad in plaster at the first story and "V" rusticated siding to match the spacing and align with the existing channel rustic siding. The rear elevation of the addition will have a door with arched transom will be flanked by three arched windows at each side at the first story. Two banks of three arched windows will be located at the second story. The third story will contain a bank of three arched windows. All new windows will have wood, doublehung sash and a plain trim profile. Roof decks with wood railings will be located at the third and fourth stories. The west elevation of the addition will have double doors accessing the trash enclosure and one arched window at the second story. The east elevation of the addition will have one arched window with wood, double-hung sash at the second story and a door at the third story will access the new roof deck. Please see photographs and plans for details.
- 3. **Property Description.** 1772 VALLEJO STREET is located on the north side of Vallejo Street between Franklin and Gough streets in San Francisco's Pacific Heights neighborhood. Also known as the Burr House, the subject property is designated as City Landmark No. 31 (1970), holds a Mills Act Contract (2013) and is listed on the National Register of Historic Places (2014). Designed with a blend of Italianate and Second Empire style influences, the building is a three-story-over-raised-basement single-family dwelling constructed circa 1878 by former San Francisco mayor, Ephraim W. Burr, as a wedding gift for his son, Edmund Burr (a chemical engineer), and his wife Anna Barnard. The design is attributed to the builder, Edmund M. Wharf. The subject property is an extremely rare example of an Italianate and Second Empire style residence located within a large garden setting and exemplifies the type of Gilded Age properties constructed in Pacific Heights during the last quarter of the nineteenth century.

- 4. **Surrounding Properties and Neighborhood.** The neighborhood is predominantly an urban residential area with a mix of single-family homes and small and large apartment buildings.
- 5. **Public Outreach and Comments.** The Department has received no public correspondence at the date of the executive summary.
- 6. **Planning Code Compliance**. The Commission has determined that the proposed work is compatible with the exterior character-defining features of the subject property and meets the requirements of Article 10 of the Planning Code in the following manner:
 - A. **Article 10 of the Planning Code**. Pursuant to Section 1006.6 of the Planning Code, the proposed alteration shall be consistent with and appropriate for the effectuation of the purposes of this Article 10.

The proposed project is consistent with Article 10 of the Planning Code.

- B. Secretary of the Interior's Standards. Pursuant to Section 1006.6(b) of the Planning Code, the proposed work shall comply with the Secretary of the Interior's Standards for the Treatment of Historic Properties for significant and contributory buildings, as well as any applicable guidelines, local interpretations, bulletins, or other policies. Rehabilitation is the act or process of making possible a compatible use for a property through repair, alterations, and additions while preserving those portions or features that convey its historical, cultural, or architectural values. The Rehabilitation Standards provide, in relevant part(s):
 - (1) **Standard 1**: A property shall be used for its historic purpose or be placed in a new use that requires minimal change to the defining characteristics of the building and its site and environment.
 - The property will remain a single family home. The addition will be at the rear elevation of the main house and appears to be minimally visible from the street.
 - (2) Standard 2: The historic character of a property will be retained and preserved. The removal of historic materials or alteration of features and spaces that characterize a property shall be avoided.
 - The addition will remove a substantial portion of the rear elevation. However, the first and second stories have been previously altered with an enclosed room, removal of an enclosed porch and alterations to windows. The third story portion of the addition removes one historic window and is notched to retain the second historic window at this elevation. The addition retains visibility of the historic quoining at the sides the house. The roof deck at the third story will be below the bay window, which appears to allow the historic features below the bay window to remain visible. The roof deck at the fourth story is below the brackets of the mansard roof which maintains visibility.
 - (3) **Standard 3**: Each property will be recognized as a physical record of its time, place and use. Changes that create a false sense of historical development, such as adding conjectural

features or elements from other historic properties, shall not be undertaken.

Not applicable.

(4) **Standard 4:** Most properties change over time; those changes that have acquired historic significance in their own right shall be retained and preserved.

The previous alterations to the first and second stories of the rear elevation have not acquired significance in their own right.

(5) **Standard 5:** Distinctive features, finishes, and construction techniques or examples of fine craftsmanship that characterize a property shall be preserved.

The addition retains visibility of the historic quoining at the sides the house. The roof decks at the third story will be below the bay window and roof bracket, allowing these features remain visible.

(6) **Standard 6:** Deteriorated historic features shall be repaired rather than replaced. Where the severity of deterioration requires replacement of a distinctive feature, the new feature shall match the old in design, color, texture, and other visual qualities and, where possible, materials. Replacement of missing features shall be substantiated by documentary, physical, or pictorial evidence.

Not applicable.

(7) **Standard 7:** Chemical or physical treatments, such as sandblasting, that cause damage to historic materials shall not be used. The surface cleaning of structures, if appropriate, shall be undertaken using the gentlest means possible.

Not applicable.

(8) **Standard 8**: Significant archeological resources affected by a project shall be protected and preserved. If such resources must be disturbed, mitigation measures shall be undertaken.

Not Applicable.

(9) Standard 9: New additions, exterior alterations, or related new construction shall not destroy historic materials that characterize the property. The new work shall be differentiated from the old and shall be compatible with the massing, size, scale, and architectural features to protect the historic integrity of the property and its environment.

The massing, size and scale of the new addition is compatible with the house. The arched windows with simple profile trim and V-rusticated siding proposed for the addition is differentiated yet compatible with the size, scale, materials, and architectural features of the house.

(10) **Standard 10**: New additions and adjacent or related new construction shall be undertaken in such a manner that if removed in the future, the essential form and integrity of the historic property and its environment would be unimpaired.

The new addition is constructed in a manner that may be removed in the future. The first and second stories have undergone previous alterations. At the first story, this area was previously enclosed. Also at the first story, windows proposed for infill may be opened in the future. The second story wall will be removed nearly in its entirety; however, this portion of the house has been previously altered. At the third story, one windows will be removed and used as an opening into the addition, while the other will be retained.

C. **Landmarks.** Article 10 of the Planning Code outlines specific findings for the Commission to consider when evaluating applications for alterations to Landmarks.

Landmarks

1. Pursuant to Section 1006.6(c) of the Planning Code, for applications pertaining to landmark sites, the proposed work shall preserve, enhance or restore, and shall not damage or destroy, the exterior architectural features of the landmark and, where specified in the designating ordinance pursuant to Section 1004(c), its major interior architectural features. The proposed work shall not adversely affect the special character or special historical, architectural or aesthetic interest or value of the landmark and its site, as viewed both in themselves and in their setting, nor of the historic district in applicable cases.

The project is in conformance with Article 10 as the work shall not adversely affect the Landmark site.

7. **General Plan Compliance.** The proposed Certificate of Appropriateness is, on balance, consistent with the following Objectives and Policies of the General Plan:

URBAN DESIGN ELEMENT

THE URBAN DESIGN ELEMENT CONCERNS THE PHYSICAL CHARACTER AND ORDER OF THE CITY, AND THE RELATIONSHIP BETWEEN PEOPLE AND THEIR ENVIRONMENT.

OBJECTIVE 1:

EMPHASIS OF THE CHARACTERISTIC PATTERN WHICH GIVES TO THE CITY AND ITS NEIGHBORHOODS AN IMAGE, A SENSE OF PURPOSE, AND A MEANS OF ORIENTATION.

Policy 1.3

Recognize that buildings, when seen together, produce a total effect that characterizes the city and its districts.

OBJECTIVE 2:

CONSERVATION OF RESOURCES WHICH PROVIDE A SENSE OF NATURE, CONTINUITY WITH THE PAST, AND FREEDOM FROM OVERCROWDING.

Policy 2.4

Preserve notable landmarks and areas of historic, architectural or aesthetic value, and promote the preservation of other buildings and features that provide continuity with past development.

Policy 2.5

Use care in remodeling of older buildings, in order to enhance rather than weaken the original character of such buildings.

Policy 2.7

Recognize and protect outstanding and unique areas that contribute in an extraordinary degree to San Francisco's visual form and character.

The goal of a Certificate of Appropriateness is to provide additional oversight for buildings and districts that are architecturally or culturally significant to the City in order to protect the qualities that are associated with that significance.

The proposed project qualifies for a Certificate of Appropriateness and therefore furthers these policies and objectives by maintaining and preserving the character-defining features of the subject property for the future enjoyment and education of San Francisco residents and visitors.

- 8. **Planning Code Section 101.1(b)** establishes eight priority-planning policies and requires review of permits for consistency with said policies. On balance, the project complies with said policies in that:
 - A) The existing neighborhood-serving retail uses will be preserved and enhanced and future opportunities for resident employment in and ownership of such businesses will be enhanced:
 - The proposed project will not have an impact on neighborhood serving retail uses.
 - B) The existing housing and neighborhood character will be conserved and protected in order to preserve the cultural and economic diversity of our neighborhoods:
 - The proposed project will strengthen neighborhood character by respecting the character-defining features of the building in conformance with the Secretary of the Interior's Standards
 - C) The City's supply of affordable housing will be preserved and enhanced:
 - The project will not affect the City's affordable housing supply.
 - D) The commuter traffic will not impede MUNI transit service or overburden our streets or neighborhood parking:
 - The proposed project will not result in commuter traffic impeding MUNI transit service or overburdening the streets or neighborhood parking.

- E) A diverse economic base will be maintained by protecting our industrial and service sectors from displacement due to commercial office development. And future opportunities for resident employment and ownership in these sectors will be enhanced:
 - The proposed project will not have a direct impact on the displacement of industrial and service sectors.
- F) The City will achieve the greatest possible preparedness to protect against injury and loss of life in an earthquake.
 - All construction will be executed in compliance with all applicable construction and safety measures.
- G) That landmark and historic buildings will be preserved:
 - The proposed project is in conformance with Article 10 of the Planning Code and the Secretary of the Interior's Standards.
- H) Parks and open space and their access to sunlight and vistas will be protected from development:
 - The proposed project will not impact the access to sunlight or vistas for the parks and open space.
- 9. For these reasons, the proposal overall, appears to meet the *Secretary of the Interior's Standards* and the provisions of Article 10 of the Planning Code regarding Major Alterations.

DECISION

That based upon the Record, the submissions by the Applicant, the staff of the Department and other interested parties, the oral testimony presented to this Commission at the public hearings, and all other written materials submitted by all parties, the Commission hereby **APPROVES a Certificate of Appropriateness** for the subject property located at Lot 029 in Assessor's Block 0552 for proposed work in conformance with the architectural submittal dated February 12, 2020 and labeled Exhibit B on file in the docket for Record No. 2017-013752COA.

APPEAL AND EFFECTIVE DATE OF MOTION: The Commission's decision on a Certificate of Appropriateness shall be final unless appealed within thirty (30) days after the date of this Motion No. XXXXXX. Any appeal shall be made to the Board of Appeals, unless the proposed project requires Board of Supervisors approval or is appealed to the Board of Supervisors as a conditional use, in which case any appeal shall be made to the Board of Supervisors (see Charter Section 4.135). For further information, please contact the Board of Appeals in person at 1650 Mission Street, (Room 304) or call (415) 575-6880.

Duration of this Certificate of Appropriateness: This Certificate of Appropriateness is issued pursuant to Article 10 of the Planning Code and is valid for a period of three (3) years from the effective date of approval by the Historic Preservation Commission. The authorization and right vested by virtue of this action shall be deemed void and canceled if, within 3 years of the date of this Motion, a site permit or building permit for the Project has not been secured by Project Sponsor.

THIS IS NOT A PERMIT TO COMMENCE ANY WORK OR CHANGE OF OCCUPANCY UNLESS NO BUILDING PERMIT IS REQUIRED. PERMITS FROM THE DEPARTMENT OF BUILDING INSPECTION (and any other appropriate agencies) MUST BE SECURED BEFORE WORK IS STARTED OR OCCUPANCY IS CHANGED.

I hereby certify that the Historical Preservation Commission ADOPTED the foregoing Motion on April 1, 2020.

Commission Secretary		
AYES:		
NAYS:		
ABSENT:		
ADOPTED:	April 1, 2020	

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EXHIBIT A

AUTHORIZATION UPDATE

This authorization is for a Certificate of Appropriateness to allow Alterations/ New Construction/ located at 1772 Vallejo Street, Block 0552, and Lot 029 pursuant to Planning Code Section(s) 1006 within the RH-2 District and a 40-X Height and Bulk District; in general conformance with plans, dated February 12, 2020, and stamped "EXHIBIT B" included in the docket for Record No. 2017-013752COA and subject to conditions of approval reviewed and approved by the Historic Preservation Commission on April 1, 2020 under Motion No XXXXXX. This authorization and the conditions contained herein run with the property and not with a particular Project Sponsor, business, or operator.

PRINTING OF CONDITIONS OF APPROVAL ON PLANS

The conditions of approval under the 'Exhibit A' of this Historic Preservation Commission Motion No. **XXXXXX** shall be reproduced on the Index Sheet of construction plans submitted with the site or building permit application for the Project. The Index Sheet of the construction plans shall reference to the Certificate of Appropriateness and any subsequent amendments or modifications.

SEVERABILITY

The Project shall comply with all applicable City codes and requirements. If any clause, sentence, section or any part of these conditions of approval is for any reason held to be invalid, such invalidity shall not affect or impair other remaining clauses, sentences, or sections of these conditions. This decision conveys no right to construct, or to receive a building permit. "Project Sponsor" shall include any subsequent responsible party.


CHANGES AND MODIFICATIONS

Changes to the approved plans may be approved administratively by the Zoning Administrator. Significant changes and modifications of conditions shall require Historic Preservation Commission approval of a new Certificate of Appropriateness. In instances when Planning Commission also reviews additional authorizations for the project, Planning Commission may make modifications to the Certificate of Appropriateness based on majority vote and not required to return to Historic Preservation Commission.


CONDITIONS OF APPROVAL

1. None

Parcel Map

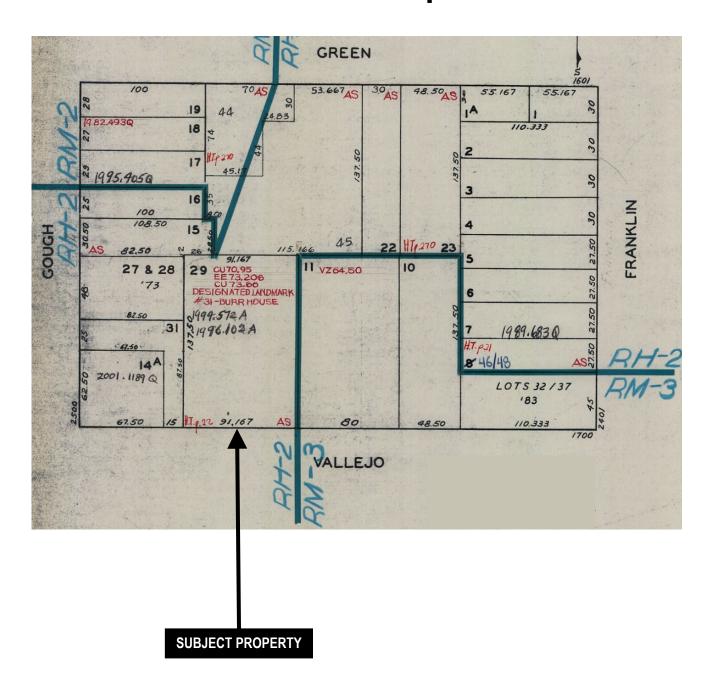

Sanborn Map*

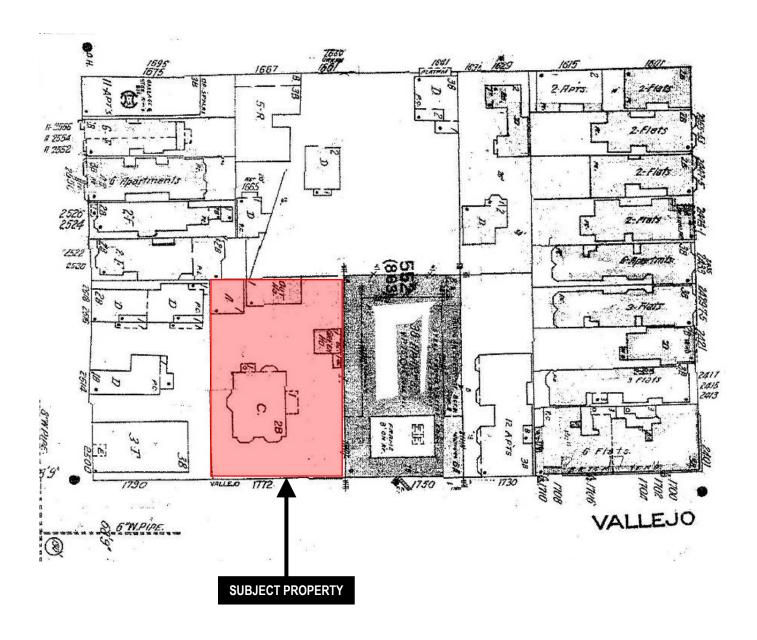


Note: Greenhouse is no longer extant.

*The Sanborn Maps in San Francisco have not been updated since 1998, and this map may not accurately reflect existing conditions.




Aerial Photo - View 1

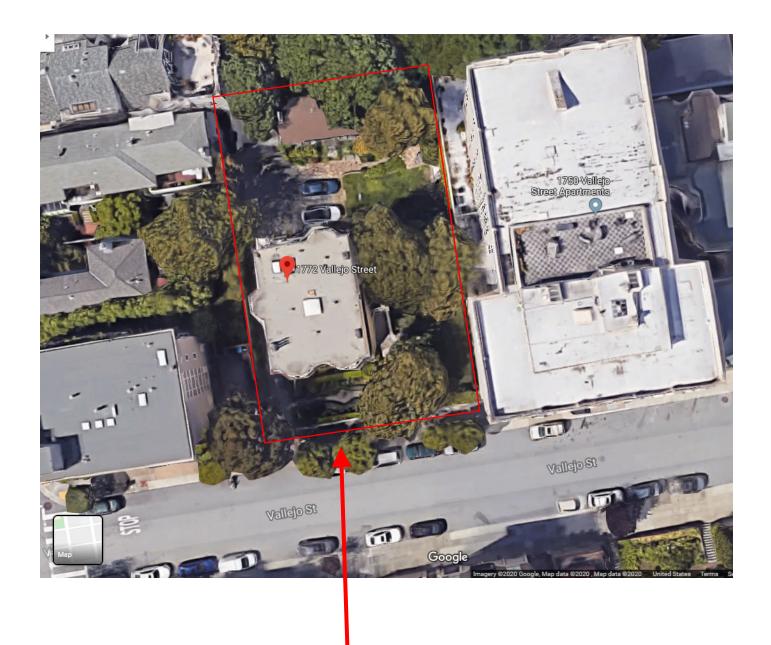

SUBJECT PROPERTY



Site Photo

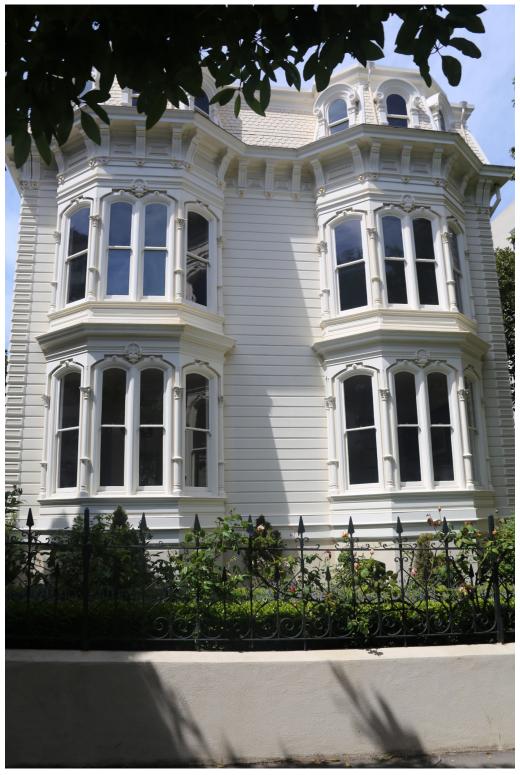


Front (south) elevation

Site Photo




Existing rear (north) elevation

Historic Photo

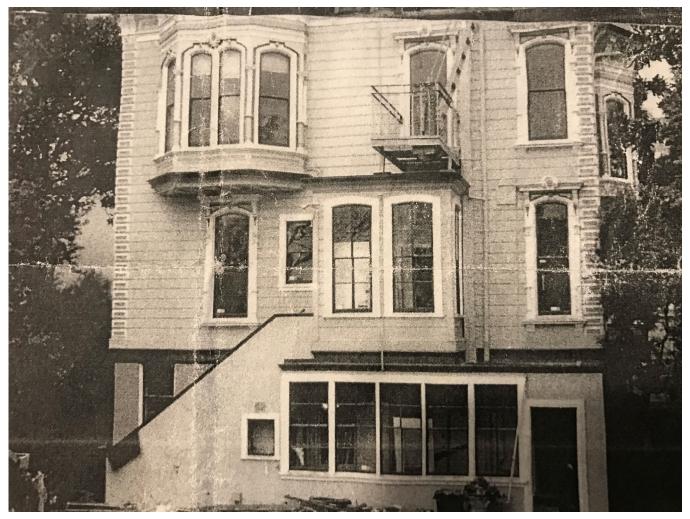

Rear (north) elevation c. 1970

Historic Photo

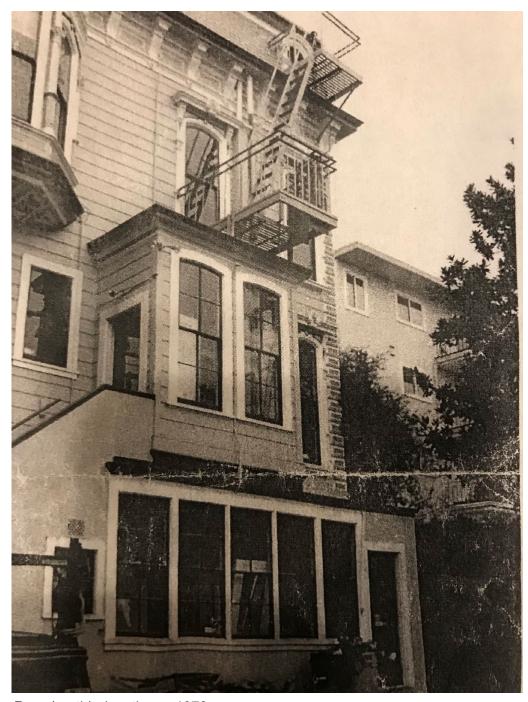

Rear (north) elevation c. 1970



City and County of San Francisco Department of Building Inspection TO THE COUNTY OF THE COUNTY OF

Edwin M. Lee, Mayor Tom C. Hui, S.E., C.B.O., Director GARAVAGLIA INC. 582 MARKET STREET SUITE 1800 SAN FRANCISCO, CA 94104 T: 415.391.9633 F: 415.391.9647 www.garavaglia.com

MORAN RESIDENCE

1772 VALLEJO STREET SAN FRANCISCO, CA 94123

June 9, 2017

Ambrose Wong Garavaglia Architecture 582 Market St. Suite 1800 San Francisco, CA 94104

> 0552 02 APN Block Lo

Dear Ambrose Wong:

In response to your request to be authorized to apply the California Historical Building Code to the building at 1772 Vallejo St., please be advised that the California Historical Building Code, Section 8-101.2 and 8-218, indicates that the building(s) that are on lists or surveys adopted by a national, state or local agency, or buildings that have been deemed eligible for such lists or surveys, may apply the California Historical Building Code.

The subject building was built in 1900 is a designated Landmark and categorized "A – Historic Resource Present" by the San Francisco Planning Department. Based on the historical features of the building, you are entitled to apply the California Historical Building Code to work that takes place in the building and on the site at 1772 Vallejo St.

Any specific application to use the California Historical Building Code must detail the specific provisions of that code that you wish to apply along with an explanation of the reasons as to why the regular building code cannot be applied. State Law requires that the Department of Building Inspection, Fire Department and other enforcing agencies in San Francisco accept reasonable equivalent alternatives to the regular code in dealing with qualified historical buildings. You may also wish to review Administrative Bulletin AB-013, Disabled Access Alternatives for Historical Buildings, which is printed in the "Rules and Regulations" section of the San Francisco Building Code.

ery truly yours,

Associate Engineer
Technical Services Divis

For:
David Leung, Manager, Permit Submittal & Issuance
Dan Lowery, Deputy Director of Permit Services

TECHNICAL SERVICES DIVISION 1660 Mission Street – San Francisco CA 94103 Office (415) 558-6205 – FAX (415) 558-6401 Website: www.sfdbi.org

REHABILITATION & ADDITION

LOCATION MAP

ADDRESS: 1772 VALLEJO STREET



PROJECT INFORMATION

ADDRESS: 1772 VALLEJO STREET SAN FRANCISCO, CA 94123

BLOCK/LOT NO: 0552/029

ZONING: GROUP RH-2 **OCCUPANCY:** GROUP R-3

DESCRIPTION: NEW 9'-4" ADDITION AT REAR OF HOUSE: FIRST, SECOND AND THIRD FLOORS ONLY. MINOR

ALTERATIONS TO EXISTING KITCHEN AND BATHROOMS WITHIN THE EXISTING HOUSE

FOOTPRINT.

CONSTRUCTION

TYPE: TYPE V-B

PROJECT DATA SUMMARY:

EXISTING BUILDING AREA (FOOTPRINT): 2,103 SF
PROPOSED BUILDING AREA (FOOTPRINT): 2,411 SF
NET LOT AREA: 91.67' x 137.5' = 12,605 SF
LOT COVERAGE (PROPOSED): 19 %
ALLOWABLE LOT COVERAGE: %

GROSS FLOOR AREA (SF):

EXISTING ADDT'L PROPOSED TOTAL FIRST FLR. 1,727 2,035 SECOND FLR. 1,769 308 2,077 THIRD FLR. 266 2,063 FOURTH FLR. 1,797 114 1,911 **TOTAL** 7,090 SF 996 SF 8,086 SF

CODE INFORMATION

BUILDING CODE: 2019 CALIFORNIA HISTORICAL BUILDING CODE 2019 CALIFORNIA BUILDING CODE 2019 CALIFORNIA PLUMBING, MECHANICAL,

ELECTRICAL AND ENERGY EFFICIENCY
STANDARDS

GUIDELINES:

FIRE SPRINKLERS ARE REQUIRED (2019 CBC - SECTION 903.2.8, GROUP R, AND 2019 CBC - SECTION 903.2.8.1, GROUP R-3)

FIRE SPRINKLER SYSTEM:

HOUSE IS PROTECTED BY AN EXISTING AUTOMATIC FIRE SPRINKLER SYSTEM.
SUCH SYSTEM MAY BE NFPA 13D (2019 CBC - SECTION 903.3.1.3, AS AMENDED IN CHAPTER 35).

MEANS OF EGRESS:

2 EXITS ARE REQUIRED, BASED ON OCCUPANT LOAD, USE AND NUMBER OF STORIES (2019 CBC - TABLES 1006.2.1, 1006.3.1 AND 1006.3.2(1)).

2 EXITS ARE PROVIDED.

PROJECT DIRECTORY

VNER: JOHN MORAN
CONTACT: JOHN MORAN
1772 VALLEJO STREET
SAN FRANCISCO, CA 94123
TEL: 415-305-1155

EML: johnpmoran1@gmail.com

ARCHITECT: MICHAEL GARAVAGLIA, AIA
GARAVAGLIA ARCHITECTURE, INC.
582 MARKET STREET SUITE 1800
SAN FRANCISCO, CA 94104
CONTACT: AMBROSE WONG
TEL: 415-391-9633
FAX: 415-391-9647

EML: ambrose@garavaglia.com

DRAWING INDEX

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A-2.01 FIRST FLOOR PLAN - DEMOLITION

A-2.02 SECOND FLOOR PLAN - DEMOLITION
A-2.03 THIRD FLOOR PLAN - DEMOLITION
A-2.04 FOURTH FLOOR PLAN - DEMOLITION

A-2.11 FIRST FLOOR PLAN - PROPOSED
A-2.12 SECOND FLOOR PLAN - PROPOSED

A-2.13 THIRD FLOOR PLAN - PROPOSED
A-2.14 FOURTH FLOOR PLAN - PROPOSED
A-3.01 EXTERIOR ELEVATION - DEMOLITION

A-3.02 EXTERIOR ELEVATION - DEMOLITION
A-3.03 EXTERIOR ELEVATION - EXISTING
A-3.04 EXTERIOR ELEVATION - DEMOLITION

A-3.11 EXTERIOR ELEVATION - PROPOSED
A-3.12 EXTERIOR ELEVATION - PROPOSED
A-3.13 EXTERIOR ELEVATION - PROPOSED
A-3.14 EXTERIOR ELEVATION - PROPOSED

A-3.21 LONGITUDINAL SECTION - PROPOSED
A-3.22 STREET ELEVATION

COVER SHEET

PROJ. NO. 2017-003
SCALE NO SCALE
DATE 24 APRIL 2017
PHASE DD
DRAWN

CHECKED

NO. DATE REVISION

18 JUL 2017 PLANNING REVIEW

11 SEP 2017 C.O.A. APPLICATION

11 SEP 2017 C.O.A. APPLICATION
24 DEC 2019 ARC REVIEW
12 FEB 2020 UPDATE COA/311

SHEET NO.

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- THE ARCHITECT/OWNER SHALL SUBMIT DRAWINGS FOR PLAN CHECK. THE OWNER SHALL PAY FOR ALL PLAN CHECK FEES. THE CONTRACTOR SHALL PICK UP PERMITS.
- ALL WORK SHALL CONFORM TO THE 2019 CALIFORNIA HISTORICAL BUILDING CODE, THE 2019 CALIFORNIA BUILDING CODE AS WELL AS TO THE LATEST EDITIONS OF THE ELECTRICAL, PLUMBING, MECHANICAL AND ANY OTHER APPLICABLE CODES. ALL WORK SHALL CONFORM TO THE SECRETARY OF THE INTERIOR STANDARDS FOR REHABILITATION AS OUTLINED ON THIS SHEET.
- 4. ALL WORK SHALL CONFORM TO ALL LOCAL CODES AND/OR ORDINANCES.
- 5. ALL WORK SHALL BE COMPLETED SKILLFULLY AND IN ACCORDANCE WITH ACCEPTED TRADE STANDARDS
- 6. EXCEPT WHERE CONTRACT DOCUMENTS INCLUDE MORE STRINGENT REQUIREMENTS, APPLICABLE INDUSTRY STANDARDS INCLUDING MANUFACTURER STANDARDS AND INSTALLATION INSTRUCTIONS HAVE THE SAME FORCE AND EFFECT AS IF BOUND OR COPIED INTO THE CONTRACT DOCUMENTS. SUCH STANDARDS ARE PART OF THE CONTRACT DOCUMENTS BY REFERENCE. WHERE COMPLIANCE WITH A STANDARD IS REQUIRED, COMPLY WITH THE STANDARD IN EFFECT AS OF THE DATE OF THE CONTRACT DOCUMENTS.
- 7. THE CONTRACTOR SHALL COORDINATE THE VARIOUS CONSTRUCTION ACTIVITIES TO ENSURE EFFICIENT AND ORDERLY INSTALLATION OF EACH PART OF THE WORK. COORDINATE CONSTRUCTION OPERATIONS THAT ARE DEPENDENT UPON EACH OTHER FOR PROPER INSTALLATION, CONNECTION, AND OPERATION.
- 8. CONTRACTOR SHALL COORDINATE WITH OWNER FOR OWNER PROVIDED MATERIALS.
- 9. CONTRACTOR SHALL COORDINATE WITH OWNER FOR REQUIRED SCHEDULING & ORDERING INFORMATION. CONTRACTOR SHALL ASSIST IN DETERMINING QUANTITIES WHEN REQUIRED.
- 10. CONTRACTOR SHALL PROVIDE OWNER W/ REQUESTED DELIVERY DATES FOR ALL P.B.O. PRODUCTS & KEEP OWNER ABREAST OF SCHEDULE REVISIONS. OWNER SHALL DETERMINE LEAD TIME FOR ALL PRODUCTS & HAVE PRODUCTS DELIVERED WHEN NEEDED BY CONTRACTOR.
- 11. CONTRACTOR SHALL INFORM THE ARCHITECT OF SCHEDULE REVISIONS.
- 12. CONTRACTOR SHALL INFORM THE ARCHITECT ON THE PROGRESS OF THE WORK ON A WEEKLY BASIS OR MORE FREQUENTLY AS CONDITIONS WARRANT.
- 13. CONTRACTOR SHALL SCHEDULE MEETINGS WITH THE ARCHITECT ON A TIMELY BASIS AND TO ALLOW FOR TIME REQUIRED TO PROVIDE APPROPRIATE RESPONSE TO ANY QUESTIONS OR SITE CONDITIONS.
- 14. CONTRACTOR SHALL ARRANGE FOR A PRECONSTRUCTION MEETING AND FOR ANOTHER MEETING AFTER DETERMINING THE PROJECT DIMENSIONAL LAYOUT FOR THE REVIEW BY THE ARCHITECT AND OWNER.
- 15. CONTRACTOR SHALL ALLOW TWO WEEKS FOR REVIEW BY THE ARCHITECT OF SUBMITTALS, SHOP DRAWINGS, SUBSTITUTIONS, AND RFI'S BY THE ARCHITECT. CONTRACTOR SHALL REVIEW ALL SUBMITTALS BEFORE ISSUING THEM TO THE ARCHITECT FOR REVIEW.
- 16. THE CONTRACTOR SHALL SUBMIT SHOP DRAWINGS TO THE ARCHITECT FOR REVIEW OF CONFORMANCE WITH DESIGN INTENT.
- 17. ALL CHANGE ORDERS SHALL BE IN WRITING AND SHALL BE SIGNED BY THE OWNER, ARCHITECT, AND CONTRACTOR. CHANGE ORDERS SHALL BE SIGNED PRIOR TO BEGINNING THE WORK OR ORDERING THE MATERIALS ADDRESSED IN THE CHANGE ORDER.
- 18. CONTRACTOR SHALL SUBMIT ALL DESIGN CHANGES OR SUBSTITUTIONS TO THE ARCHITECT FOR APPROVAL. THE ARCHITECT SHALL NOT BE RESPONSIBLE FOR ANY CHANGES IN PLANS, DETAILS, OR SPECIFICATIONS UNLESS APPROVED IN WRITING AND IN ADVANCE BY THE ARCHITECT.
- 19. THE CONTRACTOR SHALL NOTIFY THE ARCHITECT OF ALL MODIFICATIONS REQUESTED BY THE BUILDING DEPARTMENT, OR OFFICIAL HAVING JURISDICTION, AND OF ALL CHANGES REQUESTED BY THE INSPECTOR, OWNER, OR OTHERS. SUBSTITUTIONS WILL BE CONSIDERED, BUT DO NOT SUBSTITUTE DETAILS, EQUIPMENT, OR METHODS WITHOUT SPECIFIC WRITTEN APPROVAL BY THE ARCHITECT.
- 20. CONTRACTOR SHALL VERIFY WITH THE ARCHITECT CODE UPGRADE WORK NOT REQUIRED BY BUILDING INSPECTORS. IF THE CONTRACTOR BELIEVES CODE WORK IS NECESSARY. AND IT HAS NOT BEEN REQUIRED BY BUILDING INSPECTOR, THE ARCHITECT SHALL DETERMINE, WITH OWNER'S CONSENT, WHETHER WORK SHALL BE UNDERTAKEN.
- 21. REMODELING OR REHABILITATION OF AN EXISTING BUILDING REQUIRES THAT CERTAIN ASSUMPTIONS BE MADE REGARDING EXISTING CONDITIONS. BECAUSE SOME OF THE ASSUMPTIONS MAY NOT BE VERIFIABLE WITHOUT DESTROYING ADEQUATE OR SERVICEABLE PORTIONS OF THE BUILDING. THE CONTRACTOR SHALL VERIFY ALL QUESTIONS, CONDITIONS AND PROCEDURES WITH THE ARCHITECT PRIOR TO COMMENCING EACH PORTION OF THE WORK.

- 22. THE CONTRACTOR SHALL CONFIRM ALL EXISTING DIMENSIONS AND CONDITIONS IN THE FIELD PRIOR TO BEGINNING WORK. ANY DISCREPANCIES BETWEEN THE DRAWINGS AND FIELD CONDITIONS MUST BE BROUGHT TO THE IMMEDIATE ATTENTION OF THE ARCHITECT FOR CLARIFICATION PRIOR TO PROCEEDING WITH WORK. THE CONTRACTOR SHALL RESOLVE ANY DISCREPANCY PRIOR TO PROCEEDING WITH WORK.
- 23. WRITTEN DIMENSIONS SHALL TAKE PRECEDENCE OVER SCALED DIMENSIONS. DO NOT SCALE DRAWINGS. DIMENSIONS ARE TO THE FACE OF FINISH, UNLESS OTHERWISE NOTED
- 24. WHERE CONSTRUCTION ABUTS ADJACENT PROPERTY OR AN EXISTING STRUCTURE, THE CONTRACTOR SHALL VERIFY, PRIOR TO THE START OF WORK, IF ANY CONDITIONS WILL AFFECT WORK PROGRESS OR CONFORMANCE TO THESE DOCUMENTS.
- 25. THE REMOVAL OR ALTERING IN ANY WAY OF EXISTING WORK SHALL BE CARRIED ON IN SUCH A MANNER AS TO PREVENT INJURY OR DAMAGE TO ANY PORTION(S) OF THE EXISTING WORK, WHICH REMAIN(S).
- 26. CONTRACTOR SHALL BE RESPONSIBLE FOR ANY DAMAGE INCURRED AS A RESULT OF THE WORK. ANY DAMAGE SHALL BE REPAIRED AT NO ADDITIONAL COST TO OWNER.
- 27. EXECUTE WORK TO ENSURE THE SAFETY OF PERSONS AND ADJACENT PROPERTY FROM DAMAGE CAUSED BY CONSTRUCTION OPERATIONS IN CONNECTION WITH THIS WORK. WHERE EXISTING CONSTRUCTION IS CUT, DAMAGED, OR REMODELED, PATCH OR REPLACE WITH MATERIALS TO MATCH IN KIND, QUALITY, AND PERFORMANCE WITH ADJACENT MATERIALS.
- 28. DO NOT NOTCH, BORE, OR CUT MEMBERS FOR PIPES, DUCTS, OR OTHER REASONS WITHOUT THE SPECIFIC, ADVANCE WRITTEN APPROVAL OF THE STRUCTURAL ENGINEER.
- 29. THE CONTRACTOR IS RESPONSIBLE FOR CAPPING OFF ANY UTILITY LINES DISTURBED DURING THE DEMOLITION AND CONSTRUCTION PROCESS THAT COULD BE A SAFETY HAZARD OR CAUSE DAMAGE TO THE BUILDING
- 30. THE CONTRACTOR IS RESPONSIBLE FOR PROVIDING ALL TEMPORARY SUPPORTS, BARRICADES, AND SHORING AS REQUIRED DURING THE CONSTRUCTION PROCESS.
- 31. UNLESS OTHERWISE INDICATED, ALL NEW WORK SHALL MATCH EXISTING MATERIALS, DETAILS, TRIM, ETC. TO THE FULLEST EXTENT POSSIBLE. PROVIDE PRODUCTS OF THE SAME KIND AND FROM A SINGLE SOURCE.
- 32. PRIOR TO ORDERING OR FABRICATING MATERIAL, EQUIPMENT, OR PRODUCTS, THE CONTRACTOR SHALL DETERMINE THAT THE SIZE AND PRODUCTS INDICATED MEET THE INTENT OF THE CONTRACT DOCUMENTS.
- 33. THE CONTRACTOR SHALL INSPECT MATERIALS AND EQUIPMENT IMMEDIATELY UPON DELIVERY AND AGAIN PRIOR TO INSTALLATION. CONTRACTOR SHALL REJECT DAMAGED AND DEFECTIVE ITEMS.
- 34. CONTRACTOR SHALL INSTALL ALL EQUIPMENT, FIXTURES AND MATERIALS PER MANUFACTURER'S RECOMMENDATIONS. FOLLOW MANUFACTURER'S INSTRUCTIONS CAREFULLY. MANUFACTURER'S INSTRUCTIONS AND GUARANTEES SHALL BE GIVEN TO THE OWNER AT THE END OF THE JOB.
- 35. THE CONTRACTOR SHALL FLASH AND COUNTERFLASH TO S.M.A.C.N.A. STANDARDS, INDUSTRY STANDARDS, AND MANUFACTURER'S SPECIFICATIONS WHEREVER NECESSARY TO PROVIDE A WATERPROOF AND WEATHERPROOF CONSTRUCTION PROJECT.
- 36. IF OPENED IN COURSE OF WORK PROVIDE AND INSTALL NEW FIBERGLASS BATT INSULATION AS FOLLOWS, U.O.N.: R-13 AT (N) EXTERIOR WALLS OR WALLS ADJACENT TO UNCONDITIONED R-19 AT (E) AND (N) FLOORS, R-19 AT (E) AND (N) ATTICS R-19 AT (N) CEILINGS/FLOORS
- 37. WHERE GLASS IS BEING REPLACED IN (E) HISTORIC WINDOWS OR DOORS, PROVIDE AND INSTALL REPLACEMENT GLASS IN KIND. PROVIDE AND INSTALL TEMPERED GLAZING IN (N) NON-HISTORIC OPENINGS WHERE REQUIRED BY CODE.
- 38. CONTRACTOR SHALL INSPECT AND APPROVE STUCCO PLYWOOD SUBSTRATE AND BUILDING PAPER FOR PROPER INSTALLATION. ADEQUATE PREPARATION OF THE SUBSTRATE IS IMPERATIVE FOR PROPER BONDING OF THE PAINT. PREPARE EACH SUBSTRATE AS RECOMMENDED BY THE MANUFACTURER. CLEAN ALL SURFACES THROUGHOUT, REMOVE ANY PAINT WHERE BONDING FAILURE IS EVIDENT & ROUGHEN ANY SURFACES AS REQUIRED FOR ADHESION OF (N) PAINT.
- 39. CONTRACTOR SHALL PROVIDE AND INSTALL 5/8" WATER RESISTANT GYP. BD. AT ALL BATH, TOILET, AND LAUNDRY ROOM WALLS TO BE PAINTED. CONTRACTOR SHALL PROVIDE AND INSTALL CEMENTITIOUS BACKER BOARD, WONDER BOARD OR EQUAL AT ALL WALL AND CEILING SURFACES TO BE FINISHED WITH TILE.
- 40. ALL EXTERIOR EXPOSED WOOD TO BE APPROVED, NATURALLY WEATHER AND PEST RESISTANT, OR PRESSURE TREATED. ALL CUTS SHALL BE TREATED W/ PRESERVATIVE COATING BEFORE INSTALLATION. ALL METAL CONNECTORS AND FASTENERS IN CONTACT WITH TREATED WOOD SHALL BE HOT DIPPED GALVANIZED OR STAINLESS STEEL.

- 41. ALL FINISHES SHALL BE PAINTED AS FOLLOWS: EXTERIOR: THREE COAT STAIN & SEAL WHERE INDICATED INTERIOR: TWO COAT FOR LIGHT INTERIOR. THREE COAT FOR DARK INTERIOR STAIN & SEAL WHERE INDICATED COLORS TO BE SELECTED BY THE ARCHITECT & OWNER. FINAL
- PROVIDE FULL COAT FINISH SAMPLES ON SURFACES WITH A MINIMUM SIZE OF 4 SF FOR APPROVAL BY THE ARCHITECT & OWNER. 42. AS A MINIMUM, ALL INTERIOR WOOD TRIM SHALL BE PAINT GRADE, SOLID

WOOD, (SPECIES TO BE DETERMINED) AND ALL EXTERIOR WOOD TRIM

ACCEPTANCE OF COLORS WILL BE FROM JOB-APPLIED SAMPLES.

43. CONTRACTOR SHALL CONTACT ARCHITECT FOR DECISIONS REGARDING ALL MATERIALS PROVIDED BY CONTRACTOR WHICH REQUIRE COLOR OR

SHALL BE PAINT GRADE, WEATHER-RESISTANT WOOD.

FINISH SELECTIONS.

- 44. PROVIDE COMPLETE FURRING AND SOFFITS TO INSTALL ALL HORIZONTAL AND VERTICAL HVAC DUCTS, VENTING AND PLUMBING. LOCATIONS AND CONFIGURATIONS TO BE REVIEWED BY ARCHITECT
- 45. PLUMBING AND EQUIPMENT VENTING: WHERE FEASIBLE VENT ALL PLUMBING FIXTURES, EXHAUST VENTS, FURNACE, WATER HEATER, EXHAUST VENTS AND PLUMBING FIXTURES TO ROOF - COMBINE WHEN ALLOWED BY CODE. VERIFY ALL LOCATIONS OF VENTS WITH ARCHITECT PRIOR TO INSTALLATION.
- 46. THE CONTRACTOR SHALL KEEP THE JOB SITE CLEAN AND SAFE AT ALL TIMES, INCLUDING CLEANING MATERIALS, PROTECTING CONSTRUCTION IN PROGRESS AND ADJOINING MATERIALS IN PLACE. PROVIDE TEMPORARY, PROTECTIVE COVERINGS WHERE NECESSARY TO ENSURE PROTECTION FROM DAMAGE OR DETERIORATION.
- 47. CONTRACTOR SHALL PERIODICALLY CLEAN AND MAINTAIN COMPLETED CONSTRUCTION ON A REGULAR BASIS. AT THE COMPLETION OF THE PROJECT, PROVIDE A FINAL CLEANING OF ALL SURFACES. POLISH ALL GLASS, BROOM SWEEP EXTERIOR SURFACES, AND VACUUM ALL INTERIOR FLOORS. CONTRACTOR SHALL LEAVE THE PREMISES CLEAN AND ORDERLY AND READY FOR OCCUPANCY.
- 48. CONTRACTOR SHALL DISPOSE OF ALL DEBRIS AND WASTE OFF SITE IN A LEGAL MANNER ON A REGULAR BASIS TO PREVENT EXCESS ACCUMULATION ON SITE.
- 49. CONTRACTOR IS TO INSPECT THE (E) BLDG FOR ANY ADDITIONAL PROBLEMS OR CONCERNS (STRUCTURAL, FINISH, MECHANICAL, ETC.) WHICH ARE NOT REFLECTED IN THE DRAWINGS & NOTATIONS. REPORT ANY FINDINGS TO THE ARCHITECT DURING BID PHASE AND BEFORE PROCEEDING WITH WORK.
- 50. ELECTRICAL, MECHANICAL (HVAC), AND PLUMBING SYSTEMS SHALL BE "DESIGN/BUILD." PERFORMANCE SPECIFICATIONS SHALL BE REVIEWED BY THE ARCHITECT BEFORE COMMENCEMENT OF THE WORK (I.E. FURNACE SIZE AND TYPE, ELECTRICAL PANEL SIZES.)

SECRETARY OF THE INTERIOR STANDARDS FOR REHABILITATION

- 1. A PROPERTY WILL BE USED AS IT WAS HISTORICALLY OR BE GIVEN A NEW USE THAT REQUIRES MINIMAL CHANGE TO ITS DISTINCTIVE MATERIALS, FEATURES, SPACES AND SPATIAL RELATIONSHIPS.
- 2. THE HISTORIC CHARACTER OF A PROPERTY WILL BE RETAINED AND PRESERVED. THE REMOVAL OF DISTINCTIVE MATERIALS OR ALTERATION OF FEATURES, SPACES, AND SPATIAL RELATIONSHIPS THAT CHARACTERIZE A PROPERTY WILL BE AVOIDED.
- 3. EACH PROPERTY WILL BE RECOGNIZED AS A PHYSICAL RECORD OF ITS TIME, PLACE, AND USE. CHANGES THAT CREATE A FALSE SENSE OF HISTORICAL DEVELOPMENT, SUCH AS ADDING CONJECTURAL FEATURES OR ELEMENTS FROM OTHER HISTORIC PROPERTIES, WILL NOT BE UNDERTAKEN.
- 4. CHANGES TO A PROPERTY THAT HAVE ACQUIRED HISTORIC SIGNIFICANCE IN THEIR OWN RIGHT WILL BE RETAINED AND PRESERVED.
- 5. DISTINCTIVE MATERIALS, FEATURES, FINISHES AND CONSTRUCTION TECHNIQUES OR EXAMPLES OF CRAFTSMANSHIP THAT CHARACTERIZE A PROPERTY WILL BE PRESERVED.
- 6. DETERIORATED HISTORIC FEATURES WILL RE REPAIRED RATHER THAN REPLACED. WHERE THE SEVERITY OF DETERIORATION REQUIRES REPLACEMENT OF A DISTINCTIVE FEATURE, THE NEW FEATURE WILL MATCH THE OLD IN DESIGN, COLOR, TEXTURE, AND, WHERE POSSIBLE MATERIALS. REPLACEMENT OF MISSING FEATURES WILL BE SUBSTANTIATED BY DOCUMENTARY AND PHYSICAL EVIDENCE.
- 7. CHEMICAL OR PHYSICAL TREATMENTS, IF APPROPRIATE, WILL BE UNDERTAKEN USING THE GENTLEST MEANS POSSIBLE. TREATMENTS THAT CAUSE DAMAGE TO HISTORIC MATERIALS WILL NOT BE USED
- 8. ARCHEOLOGICAL RESOURCES WILL BE PROTECTED AND PRESERVED IN PLACE. IF SUCH RESOURCES MUST BE DISTURBED, MITIGATION MEASURES WILL BE UNDERTAKEN.

ARCHITECTURAL ABBREVIATIONS

KIT.

KITCHEN

ANGLE

ARCHITECTURAL SYMBOLS

 $\langle A \rangle$

≪xx

X —

CENTER LINE

SECTION

ELEVATION

INTERIOR

ELEVATION

NEW ADDITIONS, EXTERIOR ALTERATIONS, OR RELATED NEW

10. NEW ADDITIONS AND ADJACENT OR RELATED NEW CONSTRUCTION

PROPERTY AND ITS ENVIRONMENT WOULD BE UNIMPAIRED.

FOR COMPLETE TEXT AND GUIDELINES, GO TO PAGE 76:

https://www.nps.gov/tps/standards/treatment-guidelines-2017.pdf

PROPERTY AND ITS ENVIRONMENT.

ARE LISTED ON THIS SHEET.

CONSTRUCTION WILL NOT DESTROY HISTORIC MATERIALS, FEATURES,

THE NEW WORK WILL BE DIFFERENTIATED FROM THE OLD AND WILL BE

AND PROPORTION, AND MASSING TO PROTECT THE INTEGRITY OF THE

COMPATIBLE WITH THE HISTORIC MATERIALS, FEATURES, SIZE, SCALE

WILL BE UNDERTAKEN IN SUCH A MANNER THAT, IF REMOVED IN THE

FUTURE, THE ESSENTIAL FORM AND INTEGRITY OF THE HISTORIC

ARCHITECTURAL REPLACEMENT OF

MISSING HISTORICAL ELEMENTS

1. ALL WORK FOR THIS PROJECT SHALL CONFORM TO THE SECRETARY OF

THE REPLACEMENT OF MISSING HISTORICAL CONSTRUCTION

THE INTERIOR STANDARDS FOR REHABILITATION. THESE STANDARDS

ELEMENTS REQUIRES THE FULL ATTENTION AND COOPERATION OF THE

CONTRACTOR. THE CONTRACTOR SHOULD DEVELOP A SYSTEM OR

EXISTING ELEMENTS. SUCH REPAIR MAY INCLUDE REPLACEMENT OF

TO SURVIVING PROTOTYPES, WILL BE THE BASIS FOR ANY HISTORIC

THE USE OF SALVAGED MATERIALS IS STRONGLY ENCOURAGED AS A

MEANS OF REPLACING FEATURES NO LONGER COMMONLY AVAILABLE.

THIS OPTION SHALL BE GIVEN THE HIGHEST PRIORITY WHEN IT IS NOT

CONTRACTOR SHALL DOCUMENT THE LOCATION, ORIENTATION AND

REINSTALLATION OF AN ELEMENT PRIOR TO REMOVAL AND STORAGE

OF THAT ELEMENT AS REQUIRED BY THE CONTRACT DOCUMENTS OR

AS MIGHT BE REQUIRED TO ALLOW OTHER WORK TO PROCEED.

8. CONTRACTOR SHALL PROVIDE HISTORICAL ELEMENT SHOP DRAWINGS

CONTRACTOR SHALL MEASURE AND DOCUMENT ON HISTORICAL

SHALL ALSO RECORD ON THESE SHOP DRAWINGS ANY OTHER

10. THE CONTRACTOR SHALL NOTE ON THE HISTORICAL ELEMENT SHOP

DRAWINGS THE MATERIALS OF IN SITU ELEMENTS AND PROPOSE

11. THE HISTORICAL ELEMENT SHOP DRAWINGS SHALL SHOW HOW THE

AND SUBMITTED TO THE ARCHITECT FOR REVIEW.

ELEMENT SHOP DRAWINGS THE "GHOSTING" OF MISSING ELEMENTS

REQUIRING REPLACEMENT AND THEIR LOCATIONS. THE CONTRACTOR

RELEVANT INFORMATION REGARDING THESE MISSING ELEMENTS THAT

CAN BE GLEANED FROM THE FIELD. THESE MEASUREMENTS SHALL BE

RECORDED ONTO THESE SHOP DRAWINGS AT AN APPROPRIATE SCALE

ALTERNATIVE MATERIALS. SHOULD THE IN SITU MATERIALS NO LONGER

CONTRACTOR INTENDS TO FABRICATE AND INSTALL THESE ELEMENTS.

SHOP DRAWINGS, THE ARCHITECT AND CONTRACTOR SHALL ARRANGE

A SPECIAL COORDINATION MEETING TO REVIEW THE INTERPRETATION

PROPOSED BY THE ARCHITECT AND THE RECONSTRUCTION METHOD

ELEMENT SHOP DRAWINGS TO THE CONTRACTOR WITH APPROPRIATE

THE ARCHITECT WILL REVIEW THESE SHOP DRAWINGS FOR DESIGN

12. ONCE THE ARCHITECT HAS HAD AN OPPORTUNITY TO REVIEW THESE

13. THE ARCHITECT WILL THEN ISSUE THE REVIEWED HISTORICAL

(E) CONSTRUCTION

(N) 2x WOOD FRAME

CONSTRUCTION

TO BE REMOVED

MASONRY WALL

TÓ REMAIN

---- (E) CONSTRUCTION

CONCRETE WALL

------ Line below

——— PROPERTY

LINE

CMU WALL

LINE ABOVE

ANY OTHER INFORMATION THAT WILL AID IN THE CORRECT

7. PROTECT ALL EXISTING ELEMENTS DURING ALL PHASES OF

CONSTRUCTION WORK.

AS OUTLINED BELOW.

BE AVAILABLE.

PROPOSED BY THE CONTRACTOR.

INTENT.

COMMENTS.

PROCESS OF RECORDATION PRIOR TO THE START OF ANY WORK.

EVERY EFFORT SHALL BE MADE TO REPAIR, RATHER THAN REPLACE.

4. HISTORICAL PHYSICAL AND PICTORIAL DOCUMENTATION, IN ADDITION

RESTORATION. MEASURE AND DOCUMENT ALL EXISTING DETAILS

PRIOR TO START OF ANY REPAIR OR REPLACEMENT WORK,

FEASIBLE TO REPAIR A DETERIORATED ELEMENT.

EXTENSIVELY DETERIORATED OR MISSING ELEMENTS.

AND SPATIAL RELATIONSHIPS THAT CHARACTERIZE THE PROPERTY.

2	ANGLE	KII.	KIICHEN
@	AT	LAM.	LAMINATE
<u>Ç</u>	CENTERLINE	LAV.	LAVATORY
#	POUND OR	L.P.	LOW POINT
	NUMBER	M.O.	MASONRY OPENING
(E)	EXISTING	MAX.	MAXIMUM
(N)	NEW	MECH.	MECHANICAL
A.F.F.	ABOVE	MTL.	METAL
	FLOOR FINISH	MIN.	MINIMUM
ACOUS.	ACOUSTICAL	N.A.	NOT APPLICABLE
ADJ.	ADJUSTABLE	N.I.C.	NOT IN CONTRACT
AGGR.	AGGREGATE	N.T.S.	NOT TO SCALE
ALUM.	ALUMINUM	NO.	NUMBER
APPROX.	APPROXIMATE	O.C.	ON CENTER
ARCH.	ARCHITECTURAL	OPNG.	OPENING
ASPH.	ASPHALT	OPP.	OPPOSITE
BM.	BEAM	0.F.O.S.	OUTSIDE FACE
BTWN.	BETWEEN	0.1 .0.0.	OF STUD
BITUM.	BITUMINOUS	0/	OVER
BLKG.	BLOCKING	O.D.	OUTSIDE DIAMETER
BD.	BOARD	OF.D.	OVERFLOW DRAIN
BOT.	BOTTOM	PTD.	PAINTED
BLDG.	BUILDING	PR.	PAIR
CLG.	CEILING	PART.	PARTITION
CEM.	CEMENT	PERM.	PERMANENT
CER.	CERAMIC	PLAS.	
CLR.	CLEAR	_	PLASTER
CLO.	CLOSET	PL.	PLATE
COL.	COLUMN	PLUMB.	
COL.	CONCRETE	PLYWD.	PLYWOOD
		PT.	POINT
CONT.	CONTINUOUS	PREFIN.	PREFINISHED
CORR.	CORRIDOR	P.T.D.F.	PRESSURE TREATED
DTL.	DETAIL	D D O	DOUGLAS FIR
DIA.	DIAMETER	P.B.O.	PROVIDED
DIM.	DIMENSION	Б	BY OWNER
DR.	DOOR	R.	RADIUS
D.H.	DOUBLE HUNG	R.W.L.	RAIN WATER
			LEVDED
DN	DOWN	DEE	LEADER
DWG.	DRAWING	REF.	REFRIGERATOR
DWG. EA.	DRAWING EACH	REINF.	REFRIGERATOR REINFORCED
DWG. EA. ELEC.	DRAWING EACH ELECTRICAL	REINF. REQ.	REFRIGERATOR REINFORCED REQUIRED
DWG. EA.	DRAWING EACH ELECTRICAL ELEVATION	REINF. REQ. R.D.	REFRIGERATOR REINFORCED REQUIRED ROOF DRAIN
DWG. EA. ELEC. ELEV.	DRAWING EACH ELECTRICAL ELEVATION / ELEVATOR	REINF. REQ. R.D. RM.	REFRIGERATOR REINFORCED REQUIRED ROOF DRAIN ROOM
DWG. EA. ELEC. ELEV.	DRAWING EACH ELECTRICAL ELEVATION / ELEVATOR EQUAL	REINF. REQ. R.D. RM. R.O.	REFRIGERATOR REINFORCED REQUIRED ROOF DRAIN ROOM ROUGH OPENING
DWG. EA. ELEC. ELEV. EQ. E. J.	DRAWING EACH ELECTRICAL ELEVATION / ELEVATOR EQUAL EXPANSION JOINT	REINF. REQ. R.D. RM.	REFRIGERATOR REINFORCED REQUIRED ROOF DRAIN ROOM ROUGH OPENING SEE STRUCTURAL
DWG. EA. ELEC. ELEV. EQ. E. J. EXT.	DRAWING EACH ELECTRICAL ELEVATION / ELEVATOR EQUAL EXPANSION JOINT EXTERIOR	REINF. REQ. R.D. RM. R.O. S.S.D.	REFRIGERATOR REINFORCED REQUIRED ROOF DRAIN ROOM ROUGH OPENING SEE STRUCTURAL DRAWINGS
DWG. EA. ELEC. ELEV. EQ. E. J.	DRAWING EACH ELECTRICAL ELEVATION / ELEVATOR EQUAL EXPANSION JOINT EXTERIOR FACE OF	REINF. REQ. R.D. RM. R.O. S.S.D.	REFRIGERATOR REINFORCED REQUIRED ROOF DRAIN ROOM ROUGH OPENING SEE STRUCTURAL DRAWINGS SHEET
DWG. EA. ELEC. ELEV. EQ. E. J. EXT. F. O. C.	DRAWING EACH ELECTRICAL ELEVATION / ELEVATOR EQUAL EXPANSION JOINT EXTERIOR FACE OF CONCRETE	REINF. REQ. R.D. RM. R.O. S.S.D.	REFRIGERATOR REINFORCED REQUIRED ROOF DRAIN ROOM ROUGH OPENING SEE STRUCTURAL DRAWINGS SHEET SHEET METAL AND
DWG. EA. ELEC. ELEV. EQ. E. J. EXT. F. O. C.	DRAWING EACH ELECTRICAL ELEVATION / ELEVATOR EQUAL EXPANSION JOINT EXTERIOR FACE OF CONCRETE FACE OF FINISH	REINF. REQ. R.D. RM. R.O. S.S.D.	REFRIGERATOR REINFORCED REQUIRED ROOF DRAIN ROOM ROUGH OPENING SEE STRUCTURAL DRAWINGS SHEET SHEET METAL AND AIR CONDITIONING
DWG. EA. ELEC. ELEV. EQ. E. J. EXT. F. O. C. F. O. F. F. O. S.	DRAWING EACH ELECTRICAL ELEVATION / ELEVATOR EQUAL EXPANSION JOINT EXTERIOR FACE OF CONCRETE FACE OF STUD	REINF. REQ. R.D. RM. R.O. S.S.D.	REFRIGERATOR REINFORCED REQUIRED ROOF DRAIN ROOM ROUGH OPENING SEE STRUCTURAL DRAWINGS SHEET SHEET METAL AND
DWG. EA. ELEC. ELEV. EQ. E. J. EXT. F. O. C. F. O. F. F. O. S. FIN.	DRAWING EACH ELECTRICAL ELEVATION / ELEVATOR EQUAL EXPANSION JOINT EXTERIOR FACE OF CONCRETE FACE OF FINISH FACE OF STUD FINISH	REINF. REQ. R.D. RM. R.O. S.S.D.	REFRIGERATOR REINFORCED REQUIRED ROOF DRAIN ROOM ROUGH OPENING SEE STRUCTURAL DRAWINGS SHEET SHEET METAL AND AIR CONDITIONING CONTRACTORS'
DWG. EA. ELEC. ELEV. EQ. E. J. EXT. F. O. C. F. O. F. F. O. S.	DRAWING EACH ELECTRICAL ELEVATION / ELEVATOR EQUAL EXPANSION JOINT EXTERIOR FACE OF CONCRETE FACE OF FINISH FACE OF STUD FINISH FIRE	REINF. REQ. R.D. RM. R.O. S.S.D.	REFRIGERATOR REINFORCED REQUIRED ROOF DRAIN ROOM ROUGH OPENING SEE STRUCTURAL DRAWINGS SHEET SHEET METAL AND AIR CONDITIONING CONTRACTORS' NATIONAL
DWG. EA. ELEC. ELEV. EQ. E. J. EXT. F. O. C. F. O. F. F. O. S. FIN. F.E.	DRAWING EACH ELECTRICAL ELEVATION / ELEVATOR EQUAL EXPANSION JOINT EXTERIOR FACE OF CONCRETE FACE OF FINISH FACE OF STUD FINISH FIRE EXTINGUISHER	REINF. REQ. R.D. RM. R.O. S.S.D. SHT. SMACNA	REFRIGERATOR REINFORCED REQUIRED ROOF DRAIN ROOM ROUGH OPENING SEE STRUCTURAL DRAWINGS SHEET SHEET METAL AND AIR CONDITIONING CONTRACTORS' NATIONAL ASSOCIATION
DWG. EA. ELEC. ELEV. EQ. E. J. EXT. F. O. C. F. O. F. F. O. S. FIN. F.E.	DRAWING EACH ELECTRICAL ELEVATION / ELEVATOR EQUAL EXPANSION JOINT EXTERIOR FACE OF CONCRETE FACE OF FINISH FACE OF STUD FINISH FIRE EXTINGUISHER FLOOR	REINF. REQ. R.D. RM. R.O. S.S.D. SHT. SMACNA	REFRIGERATOR REINFORCED REQUIRED ROOF DRAIN ROOM ROUGH OPENING SEE STRUCTURAL DRAWINGS SHEET SHEET METAL AND AIR CONDITIONING CONTRACTORS' NATIONAL ASSOCIATION SIMILAR
DWG. EA. ELEC. ELEV. EQ. E. J. EXT. F. O. C. F. O. F. F. O. S. FIN. F.E.	DRAWING EACH ELECTRICAL ELEVATION / ELEVATOR EQUAL EXPANSION JOINT EXTERIOR FACE OF CONCRETE FACE OF FINISH FACE OF STUD FINISH FIRE EXTINGUISHER FLOOR FLOOR DRAIN	REINF. REQ. R.D. RM. R.O. S.S.D. SHT. SMACNA SIM. S.H.	REFRIGERATOR REINFORCED REQUIRED ROOF DRAIN ROOM ROUGH OPENING SEE STRUCTURAL DRAWINGS SHEET SHEET METAL AND AIR CONDITIONING CONTRACTORS' NATIONAL ASSOCIATION SIMILAR SINGLE HUNG
DWG. EA. ELEC. ELEV. EQ. E. J. EXT. F. O. C. F. O. F. F. O. S. FIN. F.E. FLR. F. D. FLUOR.	DRAWING EACH ELECTRICAL ELEVATION / ELEVATOR EQUAL EXPANSION JOINT EXTERIOR FACE OF CONCRETE FACE OF FINISH FACE OF STUD FINISH FIRE EXTINGUISHER FLOOR FLOOR DRAIN FLUORESCENT	REINF. REQ. R.D. RM. R.O. S.S.D. SHT. SMACNA SIM. S.H. S.C.	REFRIGERATOR REINFORCED REQUIRED ROOF DRAIN ROOM ROUGH OPENING SEE STRUCTURAL DRAWINGS SHEET SHEET METAL AND AIR CONDITIONING CONTRACTORS' NATIONAL ASSOCIATION SIMILAR SINGLE HUNG SOLID CORE
DWG. EA. ELEC. ELEV. EQ. E. J. EXT. F. O. C. F. O. F. F. O. S. FIN. F.E. FLR. FLUOR. FT.	DRAWING EACH ELECTRICAL ELEVATION / ELEVATOR EQUAL EXPANSION JOINT EXTERIOR FACE OF CONCRETE FACE OF FINISH FACE OF STUD FINISH FIRE EXTINGUISHER FLOOR FLOOR DRAIN FLUORESCENT FOOT OR FEET	REINF. REQ. R.D. RM. R.O. S.S.D. SHT. SMACNA SIM. S.H. S.C. SPEC.	REFRIGERATOR REINFORCED REQUIRED ROOF DRAIN ROOM ROUGH OPENING SEE STRUCTURAL DRAWINGS SHEET SHEET METAL AND AIR CONDITIONING CONTRACTORS' NATIONAL ASSOCIATION SIMILAR SINGLE HUNG SOLID CORE SPECIFICATION
DWG. EA. ELEC. ELEV. EQ. E. J. EXT. F. O. C. F. O. F. F. O. S. FIN. F.E. FLR. F. D. FLUOR. FT. FTG.	DRAWING EACH ELECTRICAL ELEVATION / ELEVATOR EQUAL EXPANSION JOINT EXTERIOR FACE OF CONCRETE FACE OF FINISH FACE OF STUD FINISH FIRE EXTINGUISHER FLOOR FLOOR DRAIN FLUORESCENT FOOT OR FEET FOOTING	REINF. REQ. R.D. RM. R.O. S.S.D. SHT. SMACNA SIM. S.H. S.C. SPEC. SQ.	REFRIGERATOR REINFORCED REQUIRED ROOF DRAIN ROOM ROUGH OPENING SEE STRUCTURAL DRAWINGS SHEET SHEET METAL AND AIR CONDITIONING CONTRACTORS' NATIONAL ASSOCIATION SIMILAR SINGLE HUNG SOLID CORE SPECIFICATION SQUARE
DWG. EA. ELEC. ELEV. EQ. E. J. EXT. F. O. C. F. O. F. F. O. S. FIN. F.E. FLR. F. D. FLUOR. FT. FTG. F.A.U.	DRAWING EACH ELECTRICAL ELEVATION / ELEVATOR EQUAL EXPANSION JOINT EXTERIOR FACE OF CONCRETE FACE OF FINISH FACE OF STUD FINISH FIRE EXTINGUISHER FLOOR FLOOR DRAIN FLUORESCENT FOOT OR FEET FOOTING FORCED AIR UNIT	REINF. REQ. R.D. RM. R.O. S.S.D. SHT. SMACNA SIM. S.H. S.C. SPEC. SQ. S.S. STOR.	REFRIGERATOR REINFORCED REQUIRED ROOF DRAIN ROOM ROUGH OPENING SEE STRUCTURAL DRAWINGS SHEET SHEET METAL AND AIR CONDITIONING CONTRACTORS' NATIONAL ASSOCIATION SIMILAR SINGLE HUNG SOLID CORE SPECIFICATION SQUARE STAINLESS STEEL STORAGE
DWG. EA. ELEC. ELEV. EQ. E. J. EXT. F. O. C. F. O. F. F. O. S. FIN. F.E. FLR. F. D. FLUOR. FT. FTG. F.A.U. FDN.	DRAWING EACH ELECTRICAL ELEVATION / ELEVATOR EQUAL EXPANSION JOINT EXTERIOR FACE OF CONCRETE FACE OF FINISH FACE OF STUD FINISH FIRE EXTINGUISHER FLOOR FLOOR DRAIN FLUORESCENT FOOT OR FEET FOOTING	REINF. REQ. R.D. RM. R.O. S.S.D. SHT. SMACNA SIM. S.H. S.C. SPEC. SQ. STOR. STRUCT.	REFRIGERATOR REINFORCED REQUIRED ROOF DRAIN ROOM ROUGH OPENING SEE STRUCTURAL DRAWINGS SHEET SHEET METAL AND AIR CONDITIONING CONTRACTORS' NATIONAL ASSOCIATION SIMILAR SINGLE HUNG SOLID CORE SPECIFICATION SQUARE STAINLESS STEEL STORAGE STRUCTURAL
DWG. EA. ELEC. ELEV. EQ. E. J. EXT. F. O. C. F. O. F. F. O. S. FIN. F.E. FLR. F. D. FLUOR. FT. FTG. F.A.U.	DRAWING EACH ELECTRICAL ELEVATION / ELEVATOR EQUAL EXPANSION JOINT EXTERIOR FACE OF CONCRETE FACE OF FINISH FACE OF STUD FINISH FIRE EXTINGUISHER FLOOR FLOOR DRAIN FLUORESCENT FOOT OR FEET FOOTING FORCED AIR UNIT	REINF. REQ. R.D. RM. R.O. S.S.D. SHT. SMACNA SIM. S.H. S.C. SPEC. SQ. S.S. STOR. STRUCT. SUSP.	REFRIGERATOR REINFORCED REQUIRED ROOF DRAIN ROOM ROUGH OPENING SEE STRUCTURAL DRAWINGS SHEET SHEET METAL AND AIR CONDITIONING CONTRACTORS' NATIONAL ASSOCIATION SIMILAR SINGLE HUNG SOLID CORE SPECIFICATION SQUARE STAINLESS STEEL STORAGE STRUCTURAL SUSPENDED
DWG. EA. ELEC. ELEV. EQ. E. J. EXT. F. O. C. F. O. F. F. O. S. FIN. F.E. FLR. F. D. FLUOR. FT. FTG. F.A.U. FDN.	DRAWING EACH ELECTRICAL ELEVATION / ELEVATOR EQUAL EXPANSION JOINT EXTERIOR FACE OF CONCRETE FACE OF FINISH FACE OF STUD FINISH FIRE EXTINGUISHER FLOOR FLOOR DRAIN FLUORESCENT FOOT OR FEET FOOTING FORCED AIR UNIT FOUNDATION	REINF. REQ. R.D. RM. R.O. S.S.D. SHT. SMACNA SIM. S.H. S.C. SPEC. SQ. S.S. STOR. STRUCT. SUSP. SYM.	REFRIGERATOR REINFORCED REQUIRED ROOF DRAIN ROOM ROUGH OPENING SEE STRUCTURAL DRAWINGS SHEET SHEET METAL AND AIR CONDITIONING CONTRACTORS' NATIONAL ASSOCIATION SIMILAR SINGLE HUNG SOLID CORE SPECIFICATION SQUARE STAINLESS STEEL STORAGE STRUCTURAL SUSPENDED SYMBOL
DWG. EA. ELEC. ELEV. EQ. E. J. EXT. F. O. C. F. O. F. F. O. S. FIN. F.E. FLR. F. D. FLUOR. FT. FTG. FTG. FON. FURR. GALV. GA.	DRAWING EACH ELECTRICAL ELEVATION / ELEVATOR EQUAL EXPANSION JOINT EXTERIOR FACE OF CONCRETE FACE OF FINISH FACE OF STUD FINISH FIRE EXTINGUISHER FLOOR FLOOR DRAIN FLUORESCENT FOOT OR FEET FOOTING FORCED AIR UNIT FOUNDATION FURRING GALVANIZED GAUGE	REINF. REQ. R.D. RM. R.O. S.S.D. SHT. SMACNA SIM. S.H. S.C. SPEC. SQ. S.S. STOR. STRUCT. SUSP. SYM. TEL.	REFRIGERATOR REINFORCED REQUIRED ROOF DRAIN ROOM ROUGH OPENING SEE STRUCTURAL DRAWINGS SHEET SHEET METAL AND AIR CONDITIONING CONTRACTORS' NATIONAL ASSOCIATION SIMILAR SINGLE HUNG SOLID CORE SPECIFICATION SQUARE STAINLESS STEEL STORAGE STRUCTURAL SUSPENDED SYMBOL TELEPHONE
DWG. EA. ELEC. ELEV. EQ. E. J. EXT. F. O. C. F. O. F. F. O. S. FIN. F.E. FLR. F. D. FLUOR. FT. FTG. FTG. FON. FURR. GALV. GA. GL.	DRAWING EACH ELECTRICAL ELEVATION / ELEVATOR EQUAL EXPANSION JOINT EXTERIOR FACE OF CONCRETE FACE OF FINISH FACE OF STUD FINISH FIRE EXTINGUISHER FLOOR FLOOR DRAIN FLUORESCENT FOOT OR FEET FOOTING FORCED AIR UNIT FOUNDATION FURRING GALVANIZED	REINF. REQ. R.D. RM. R.O. S.S.D. SHT. SMACNA SIM. S.C. SPEC. SQ. S.S. STOR. STRUCT. SUSP. SYM. TEL. TOI.	REFRIGERATOR REINFORCED REQUIRED ROOF DRAIN ROOM ROUGH OPENING SEE STRUCTURAL DRAWINGS SHEET SHEET METAL AND AIR CONDITIONING CONTRACTORS' NATIONAL ASSOCIATION SIMILAR SINGLE HUNG SOLID CORE SPECIFICATION SQUARE STAINLESS STEEL STORAGE STRUCTURAL SUSPENDED SYMBOL TELEPHONE TOILET
DWG. EA. ELEC. ELEV. EQ. E. J. EXT. F. O. C. F. O. F. F. O. S. FIN. F.E. FLR. F. D. FLUOR. FT. FTG. FTG. FON. FURR. GALV. GA.	DRAWING EACH ELECTRICAL ELEVATION / ELEVATOR EQUAL EXPANSION JOINT EXTERIOR FACE OF CONCRETE FACE OF FINISH FACE OF STUD FINISH FIRE EXTINGUISHER FLOOR FLOOR DRAIN FLUORESCENT FOOT OR FEET FOOTING FORCED AIR UNIT FOUNDATION FURRING GALVANIZED GAUGE	REINF. REQ. R.D. RM. R.O. S.S.D. SHT. SMACNA SIM. S.H. S.C. SPEC. SQ. S.S. STOR. STRUCT. SUSP. SYM. TEL.	REFRIGERATOR REINFORCED REQUIRED ROOF DRAIN ROOM ROUGH OPENING SEE STRUCTURAL DRAWINGS SHEET SHEET METAL AND AIR CONDITIONING CONTRACTORS' NATIONAL ASSOCIATION SIMILAR SINGLE HUNG SOLID CORE SPECIFICATION SQUARE STAINLESS STEEL STORAGE STRUCTURAL SUSPENDED SYMBOL TELEPHONE
DWG. EA. ELEC. ELEV. EQ. E. J. EXT. F. O. C. F. O. F. F. O. S. FIN. F.E. FLR. F. D. FLUOR. FT. FTG. FTG. FON. FURR. GALV. GA. GL.	DRAWING EACH ELECTRICAL ELEVATION / ELEVATOR EQUAL EXPANSION JOINT EXTERIOR FACE OF CONCRETE FACE OF FINISH FACE OF STUD FINISH FIRE EXTINGUISHER FLOOR FLOOR DRAIN FLUORESCENT FOOT OR FEET FOOTING FORCED AIR UNIT FOUNDATION FURRING GALVANIZED GAUGE GLASS	REINF. REQ. R.D. RM. R.O. S.S.D. SHT. SMACNA SIM. S.H. S.C. SPEC. SQ. S.S. STOR. STRUCT. SUSP. SYM. TEL. TOI. T.& G.	REFRIGERATOR REINFORCED REQUIRED ROOF DRAIN ROOM ROUGH OPENING SEE STRUCTURAL DRAWINGS SHEET SHEET METAL AND AIR CONDITIONING CONTRACTORS' NATIONAL ASSOCIATION SIMILAR SINGLE HUNG SOLID CORE SPECIFICATION SQUARE STAINLESS STEEL STORAGE STRUCTURAL SUSPENDED SYMBOL TELEPHONE TOILET TONGUE
DWG. EA. ELEC. ELEV. EQ. E. J. EXT. F. O. C. F. O. S. FIN. F.E. FLR. F. D. FLUOR. FT. FTG. FTG. FON. FURR. GALV. GA. GL. GYP.	DRAWING EACH ELECTRICAL ELEVATION / ELEVATOR EQUAL EXPANSION JOINT EXTERIOR FACE OF CONCRETE FACE OF FINISH FACE OF STUD FINISH FIRE EXTINGUISHER FLOOR FLOOR DRAIN FLUORESCENT FOOT OR FEET FOOTING FORCED AIR UNIT FOUNDATION FURRING GALVANIZED GAUGE GLASS GYPSUM	REINF. REQ. R.D. RM. R.O. S.S.D. SHT. SMACNA SIM. S.H. S.C. SPEC. SQ. S.S. STOR. STRUCT. SUSP. SYM. TEL. TOI. T.& G. T.O.	REFRIGERATOR REINFORCED REQUIRED ROOF DRAIN ROOM ROUGH OPENING SEE STRUCTURAL DRAWINGS SHEET SHEET METAL AND AIR CONDITIONING CONTRACTORS' NATIONAL ASSOCIATION SIMILAR SINGLE HUNG SOLID CORE SPECIFICATION SQUARE STAINLESS STEEL STORAGE STRUCTURAL SUSPENDED SYMBOL TELEPHONE TOILET TONGUE AND GROOVE TOP OF
DWG. EA. ELEC. ELEV. EQ. E. J. EXT. F. O. C. F. O. F. F. O. S. FIN. F.E. FLR. F. D. FLUOR. FT. FTG. FTG. FA.U. FDN. FURR. GALV. GA. GL. GYP. HT.	DRAWING EACH ELECTRICAL ELEVATION / ELEVATOR EQUAL EXPANSION JOINT EXTERIOR FACE OF CONCRETE FACE OF FINISH FACE OF STUD FINISH FIRE EXTINGUISHER FLOOR FLOOR DRAIN FLUORESCENT FOOT OR FEET FOOTING FORCED AIR UNIT FOUNDATION FURRING GALVANIZED GAUGE GLASS GYPSUM HEIGHT	REINF. REQ. R.D. RM. R.O. S.S.D. SHT. SMACNA SIM. S.H. S.C. SPEC. SQ. S.S. STOR. STRUCT. SUSP. SYM. TEL. TOI. T.& G. T.O.C.	REFRIGERATOR REINFORCED REQUIRED ROOF DRAIN ROOM ROUGH OPENING SEE STRUCTURAL DRAWINGS SHEET SHEET METAL AND AIR CONDITIONING CONTRACTORS' NATIONAL ASSOCIATION SIMILAR SINGLE HUNG SOLID CORE SPECIFICATION SQUARE STAINLESS STEEL STORAGE STRUCTURAL SUSPENDED SYMBOL TELEPHONE TOILET TONGUE AND GROOVE TOP OF CURB
DWG. EA. ELEC. ELEV. EQ. E. J. EXT. F. O. C. F. O. S. FIN. F.E. FLR. F. D. FLUOR. FT. FTG. F.A.U. FDN. FURR. GALV. GA. GL. GYP. HT. H.P.	DRAWING EACH ELECTRICAL ELEVATION / ELEVATOR EQUAL EXPANSION JOINT EXTERIOR FACE OF CONCRETE FACE OF FINISH FACE OF STUD FINISH FIRE EXTINGUISHER FLOOR FLOOR DRAIN FLUORESCENT FOOT OR FEET FOOTING FORCED AIR UNIT FOUNDATION FURRING GALVANIZED GAUGE GLASS GYPSUM HEIGHT HIGH POINT	REINF. REQ. R.D. RM. R.O. S.S.D. SHT. SMACNA SIM. S.H. S.C. SPEC. SQ. S.S. STOR. STRUCT. SUSP. SYM. TEL. TOI. T.& G. T.O. T.O.C. T.O.W.	REFRIGERATOR REINFORCED REQUIRED ROOF DRAIN ROOM ROUGH OPENING SEE STRUCTURAL DRAWINGS SHEET SHEET METAL AND AIR CONDITIONING CONTRACTORS' NATIONAL ASSOCIATION SIMILAR SINGLE HUNG SOLID CORE SPECIFICATION SQUARE STAINLESS STEEL STORAGE STRUCTURAL SUSPENDED SYMBOL TELEPHONE TOILET TONGUE AND GROOVE TOP OF TOP OF CURB TOP OF WALL
DWG. EA. ELEC. ELEV. EQ. E. J. EXT. F. O. C. F. O. S. FIN. F.E. FLUOR. FT. FTG. FTG. FTG. FURR. GALV. GALV. GAL. GYP. HT. H.P. H.C.	DRAWING EACH ELECTRICAL ELEVATION / ELEVATOR EQUAL EXPANSION JOINT EXTERIOR FACE OF CONCRETE FACE OF FINISH FACE OF STUD FINISH FIRE EXTINGUISHER FLOOR FLOOR DRAIN FLUORESCENT FOOT OR FEET FOOTING FORCED AIR UNIT FOUNDATION FURRING GALVANIZED GAUGE GLASS GYPSUM HEIGHT HIGH POINT HOLLOW CORE	REINF. REQ. R.D. RM. R.O. S.S.D. SHT. SMACNA SIM. S.H. S.C. SPEC. SQ. S.S. STOR. STRUCT. SUSP. SYM. TEL. TOI. T.& G. T.O. T.O.C. T.O.W. TYP.	REFRIGERATOR REINFORCED REQUIRED ROOF DRAIN ROOM ROUGH OPENING SEE STRUCTURAL DRAWINGS SHEET SHEET METAL AND AIR CONDITIONING CONTRACTORS' NATIONAL ASSOCIATION SIMILAR SINGLE HUNG SOLID CORE SPECIFICATION SQUARE STAINLESS STEEL STORAGE STRUCTURAL SUSPENDED SYMBOL TELEPHONE TOILET TONGUE AND GROOVE TOP OF TOP OF CURB TOP OF WALL TYPICAL
DWG. EA. ELEC. ELEV. EQ. E. J. EXT. F. O. C. F. O. S. FIN. F.E. FLUOR. FT. FTG. FA.U. FDN. FURR. GALV. GA. GL. GYP. H.P. H.C. H.B.	DRAWING EACH ELECTRICAL ELEVATION / ELEVATOR EQUAL EXPANSION JOINT EXTERIOR FACE OF CONCRETE FACE OF FINISH FACE OF STUD FINISH FIRE EXTINGUISHER FLOOR FLOOR DRAIN FLUORESCENT FOOT OR FEET FOOTING FORCED AIR UNIT FOUNDATION FURRING GALVANIZED GAUGE GLASS GYPSUM HEIGHT HIGH POINT HOLLOW CORE HOSE BIBB	REINF. REQ. R.D. RM. R.O. S.S.D. SHT. SMACNA SIM. S.H. S.C. SPEC. SQ. S.S. STOR. STRUCT. SUSP. SYM. TEL. TOI. T.& G. T.O. T.O.C. T.O.W.	REFRIGERATOR REINFORCED REQUIRED ROOF DRAIN ROOM ROUGH OPENING SEE STRUCTURAL DRAWINGS SHEET SHEET METAL AND AIR CONDITIONING CONTRACTORS' NATIONAL ASSOCIATION SIMILAR SINGLE HUNG SOLID CORE SPECIFICATION SQUARE STAINLESS STEEL STORAGE STRUCTURAL SUSPENDED SYMBOL TELEPHONE TOILET TONGUE AND GROOVE TOP OF TOP OF CURB TOP OF WALL
DWG. EA. ELEC. ELEV. EQ. E. J. EXT. F. O. F. F. O. S. FIN. F.E. FLUOR. FT. FTG. FLUOR. FTG. FURR. GALV. GALV. GAL. H.P. H.P. H.P. H.B. HR.	DRAWING EACH ELECTRICAL ELEVATION / ELEVATOR EQUAL EXPANSION JOINT EXTERIOR FACE OF CONCRETE FACE OF FINISH FACE OF STUD FINISH FIRE EXTINGUISHER FLOOR FLOOR DRAIN FLUORESCENT FOOT OR FEET FOOTING FORCED AIR UNIT FOUNDATION FURRING GALVANIZED GAUGE GLASS GYPSUM HEIGHT HIGH POINT HOLLOW CORE HOSE BIBB HOUR	REINF. REQ. R.D. RM. R.O. S.S.D. SHT. SMACNA SIM. S.H. S.C. SPEC. SQ. S.S. STOR. STRUCT. SUSP. SYM. TEL. TOI. T.& G. T.O. T.O.C. T.O.W. TYP.	REFRIGERATOR REINFORCED REQUIRED ROOF DRAIN ROOM ROUGH OPENING SEE STRUCTURAL DRAWINGS SHEET SHEET METAL AND AIR CONDITIONING CONTRACTORS' NATIONAL ASSOCIATION SIMILAR SINGLE HUNG SOLID CORE SPECIFICATION SQUARE STAINLESS STEEL STORAGE STRUCTURAL SUSPENDED SYMBOL TELEPHONE TOILET TONGUE AND GROOVE TOP OF TOP OF CURB TOP OF WALL TYPICAL UNLESS OTHERWISE NOTED
DWG. EA. ELEC. ELEV. EQ. E. J. EXT. F. O. F. F. O. S. FIN. F.E. FLUOR. FT. FTG. FTA.U. FDN. FURR. GALV. GAL. GYP. HT. H.P. H.C. H.B. HR. INSUL.	DRAWING EACH ELECTRICAL ELEVATION / ELEVATOR EQUAL EXPANSION JOINT EXTERIOR FACE OF CONCRETE FACE OF FINISH FACE OF STUD FINISH FIRE EXTINGUISHER FLOOR FLOOR DRAIN FLUORESCENT FOOT OR FEET FOOTING FORCED AIR UNIT FOUNDATION FURRING GALVANIZED GAUGE GLASS GYPSUM HEIGHT HIGH POINT HOLLOW CORE HOSE BIBB HOUR INSULATION	REINF. REQ. R.D. RM. R.O. S.S.D. SHT. SMACNA SIM. S.H. S.C. SPEC. SQ. S.S. STOR. STRUCT. SUSP. SYM. TEL. TOI. T.& G. T.O.C. T.O.C. T.O.W. TYP. U.O.N. VERT.	REFRIGERATOR REINFORCED REQUIRED ROOF DRAIN ROOM ROUGH OPENING SEE STRUCTURAL DRAWINGS SHEET SHEET METAL AND AIR CONDITIONING CONTRACTORS' NATIONAL ASSOCIATION SIMILAR SINGLE HUNG SOLID CORE SPECIFICATION SQUARE STAINLESS STEEL STORAGE STRUCTURAL SUSPENDED SYMBOL TELEPHONE TOILET TONGUE AND GROOVE TOP OF TOP OF CURB TOP OF WALL TYPICAL UNLESS OTHERWISE NOTED VERTICAL
DWG. EA. ELEC. ELEV. EQ. E. J. EXT. F. O. F. F. O. S. FIN. F.E. FLUOR. FT. FTG. F.A.U. FDN. FURR. GALV. GA. GL. GYP. H.P. H.C. H.B. HR. INSUL. INT.	DRAWING EACH ELECTRICAL ELEVATION / ELEVATOR EQUAL EXPANSION JOINT EXTERIOR FACE OF CONCRETE FACE OF FINISH FACE OF STUD FINISH FIRE EXTINGUISHER FLOOR FLOOR DRAIN FLUORESCENT FOOT OR FEET FOOTING FORCED AIR UNIT FOUNDATION FURRING GALVANIZED GAUGE GLASS GYPSUM HEIGHT HIGH POINT HOLLOW CORE HOSE BIBB HOUR INSULATION INTERIOR	REINF. REQ. R.D. RM. R.O. S.S.D. SHT. SMACNA SIM. S.C. SPEC. SQ. S.S. STOR. STRUCT. SUSP. SYM. TEL. TOI. T.& G. T.O.C. T.O.W. TYP. U.O.N.	REFRIGERATOR REINFORCED REQUIRED ROOF DRAIN ROOM ROUGH OPENING SEE STRUCTURAL DRAWINGS SHEET SHEET METAL AND AIR CONDITIONING CONTRACTORS' NATIONAL ASSOCIATION SIMILAR SINGLE HUNG SOLID CORE SPECIFICATION SQUARE STAINLESS STEEL STORAGE STRUCTURAL SUSPENDED SYMBOL TELEPHONE TOILET TONGUE AND GROOVE TOP OF TOP OF CURB TOP OF WALL TYPICAL UNLESS OTHERWISE NOTED

GARAVAGLIA ARCHITECTURE

582 MARKET STREET SUITE 1800 SAN FRANCISCO, CA 94104 T: 415.391.9633 F: 415.391.9647 www.garavaglia.com

MORAN RESIDENCE

1772 VALLEJO STREET SAN FRANCISCO, CA 94123

GENERAL NOTES

PROJ. NO. 2017-003 NO SCALE 24 APRIL 2017 DATE PHASE DDDRAWN

CHECKED REVISION NO. DATE

PLANNING REVIEW 18 JUL 2017 11 SEP 2017 C.O.A. APPLICATION 24 DEC 2019 ARC REVIEW

12 FEB 2020 UPDATE COA/311

KEYNOTE

REVISION

COLUMN

CEILING

HEIGHT

GRID

WITH

WITHOUT

WOOD

0'-0"

W/O

WD.

DOOR TYPE

WINDOW TYP

WALL TYPE

ELEVATION POINT

DATUM LAYOUT


POINT

ELEVATION

LAYOUT POINT

SHEET NO.

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SCALE: 1/8" = 1'-0"

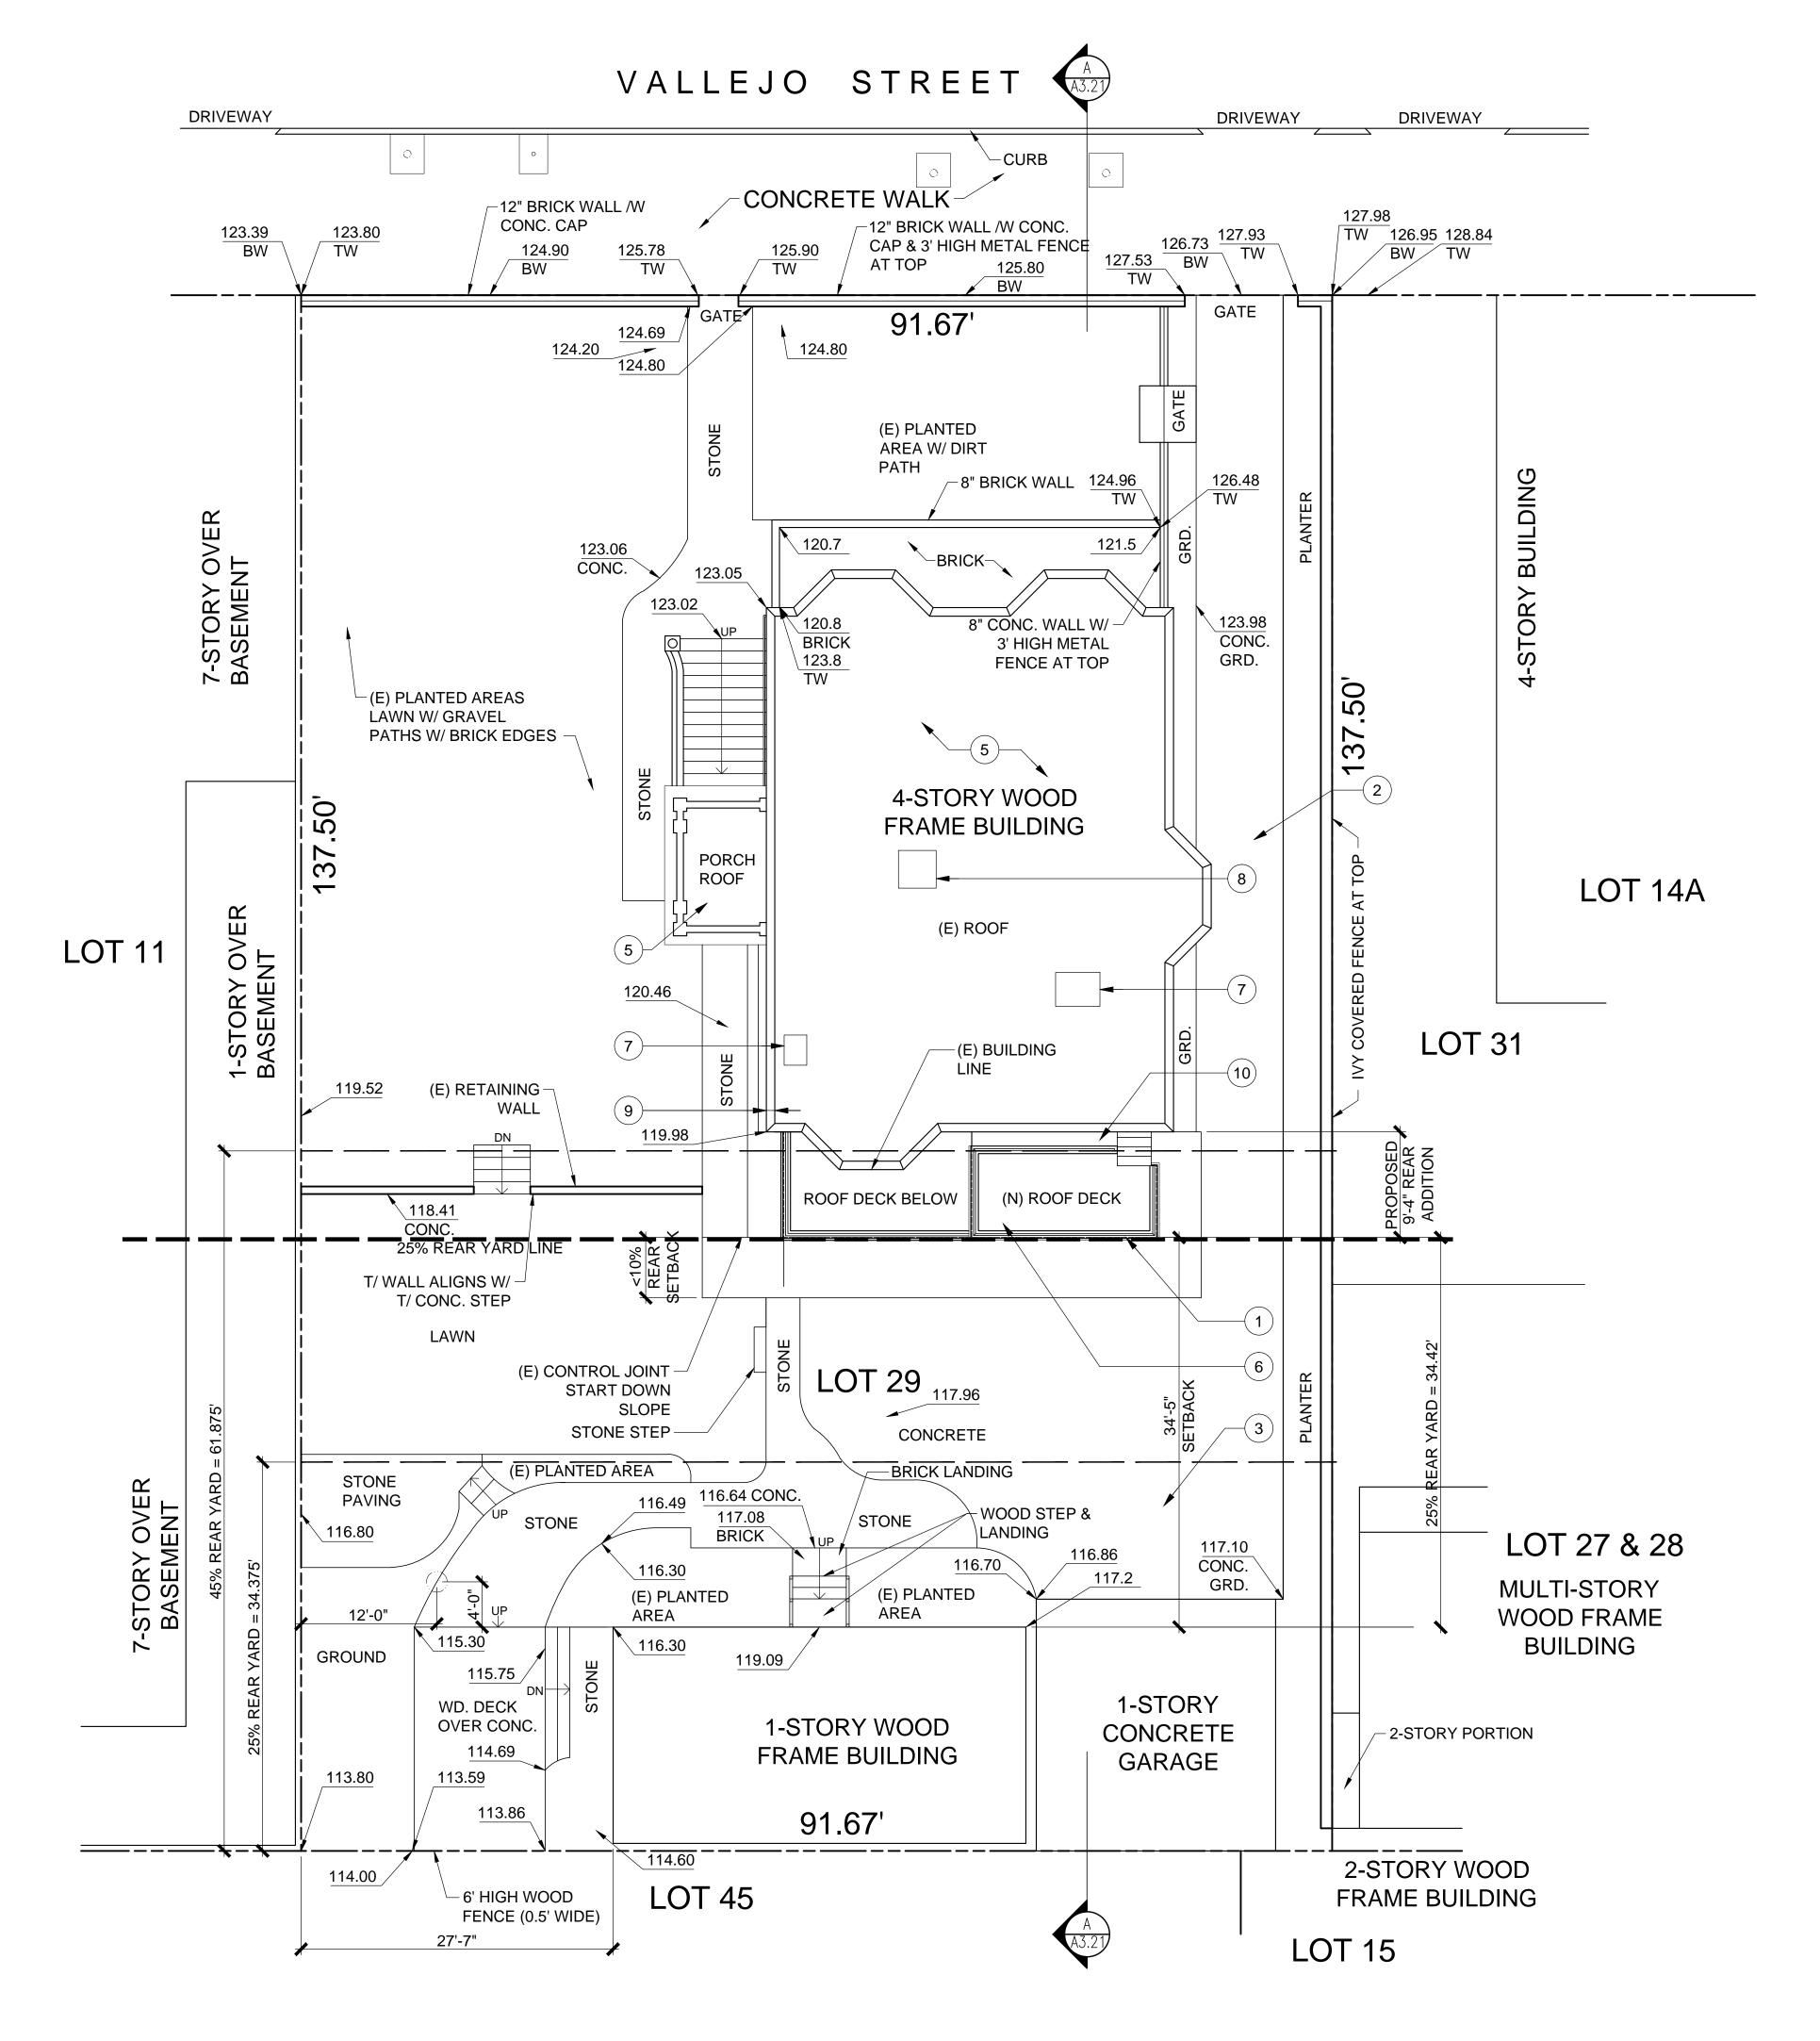

SHEET NOTES

PROPERTY LINES, EXISTING STRUCTURE LOCATION, SITE FEATURES, CONTOURS& SPOT **ELEVATIONS ARE BASED ON A SURVEY** PREPARED BY MARTIN M. RON ASSOCIATES, DATED 11/22/94.



www.garavaglia.com

SUITE 1800

T: 415.391.9633

F: 415.391.9647

SAN FRANCISCO, CA 94104

SETBACKS SHOWN ARE PER ZONING CODE SECTION 134, APPLICABLE FOR PROPOSED USE.

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KEY NOTES

- (N) REAR ADDITION
- (E) DRIVEWAY
- (3) (E) PARKING AREA
- NOT USED
- REROOF w/ TPO ROOFING
- (N) ROOF TOP REAR DECK
- 7 REMOVE (E) CHIMNEY, FRAME **OPENING AS REQUIRED**
- (E) SKYLIGHT
- 9 (E) MANSARD ROOF
- (10) (N) SKYLIGHT BELOW


SITE PLAN

PROPOSED


PROJ. NO. 2017-003 1/8"=1'-0" SCALE 20 JUNE 2017 DATE

PHASE \underline{SD} DRAWN HA CHECKED AW

NO. DATE REVISION

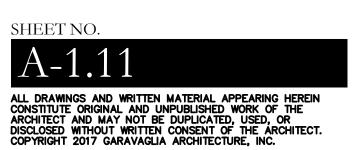



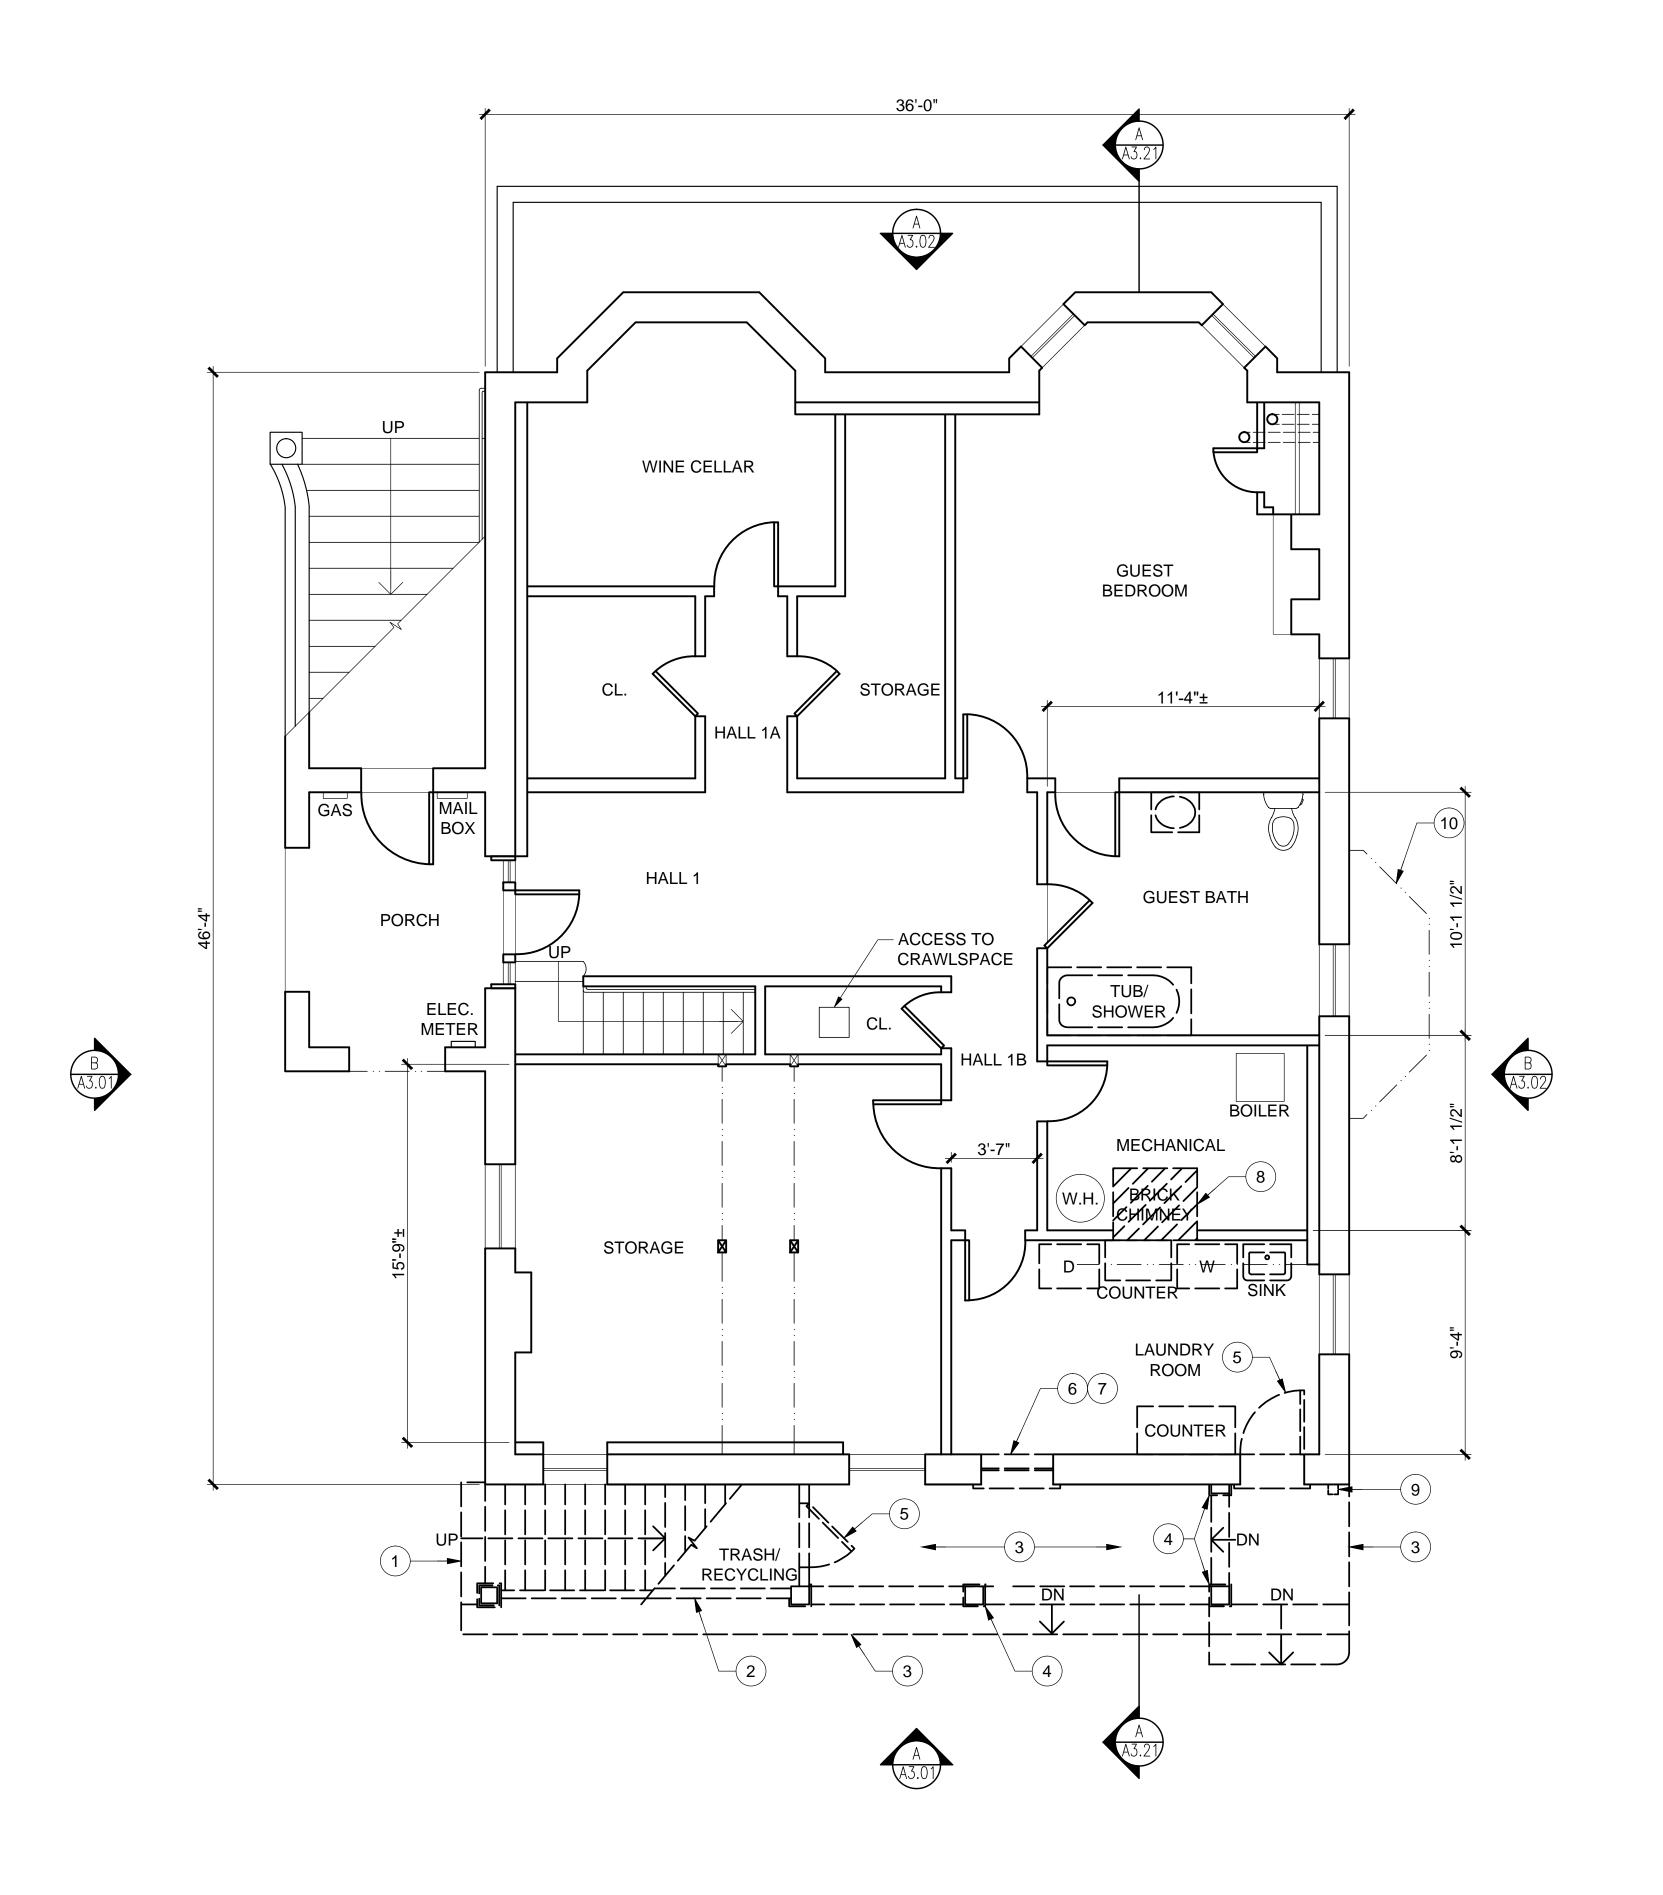





- 1. PRIOR TO START OF REMOVAL, PROTECT IN PLACE ALL EXISTING (E) ELEMENTS TO REMAIN, TO PREVENT DAMAGE DURING CONSTRUCTION OF (N) WORK IN ADJACENT AREAS.
- 2. DEMOLISH AND REMOVE COMPLETE, ITEMS SHOWN DASHED AND NOTED FOR DEMOLITION.
- 3. MOVE ITEMS NOTED FOR SALVAGE TO OWNER'S DESIGNATED STORAGE LOCATION, PROTECTED FROM WEATHER AND RAISED ABOVE GROUND SURFACE, U.O.N.
- WALL FINISH NOTED FOR DEMOLITION TO BE REMOVED BACK TO FACE OF STUD, U.O.N.
- 5. COORDINATE DEMOLITION SCOPE W/ STRUCTURAL DRAWINGS FOR LOCATIONS OF NEW STRUCTURAL ELEMENTS.
- 6. REFER TO ARCHITECTURAL GENERAL NOTES FOR ADDITIONAL DEMOLITION-SPECIFIC REQUIREMENTS.

GARAVAGLIA 582 MARKET STREET

ARCHITECTURE

SUITE 1800 SAN FRANCISCO, CA 94104 T: 415.391.9633 F: 415.391.9647 www.garavaglia.com

MORAN RESIDENCE

1772 VALLEJO STREET SAN FRANCISCO, CA 94123

KEY NOTES

- 1) REMOVE (E) STAIRS TO 2ND FLOOR.
- 2 REMOVE (E) WALLS AT STORAGE ROOM.
- 3 REMOVE (E) CONC. STEPS, LANDING & PORCH FLOOR.
- 4 REMOVE (E) WD. POSTS & TRIM.
- 5 REMOVE & (E) WD. DOOR, FRAME & TRIM.
- 6 REMOVE & (E) WD. WINDOW, FRAME & TRIM.
- AFTER REMOVAL OF (E) WINDOW, ENLARGE OPENING TO ACCOMMODATE PROPOSED (N) DOOR.
- (8) REMOVE (E) BRICK CHIMNEY, FROM TOP TO 6" BELOW FINISH FLOOR LEVEL. PATCH (E) FLOOR TO MATCH ADJACENT
- 9 REMOVE (E) "JOMY" FIRE ESCAPE LADDER.
- (E) BAY WINDOW ABOVE TO REMAIN. PROTECT IN PLACE.

FLOOR PLAN


DEMOLITION 1ST FLOOR


PROJ. NO. 2017-003 SCALE 1/4"=1'-0" 24 APRIL 2017 DATE PHASE <u>SD</u> DRAWN HA CHECKED AW

NO. DATE REVISION 18 JUL 2017 PLANNING REVIEW

11 SEPT 2017 C.O.A. APPLICATION 24 DEC 2019 ARC REVIEW <u>12 FEB 2020</u> UPDATE COA/311



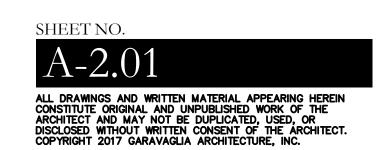

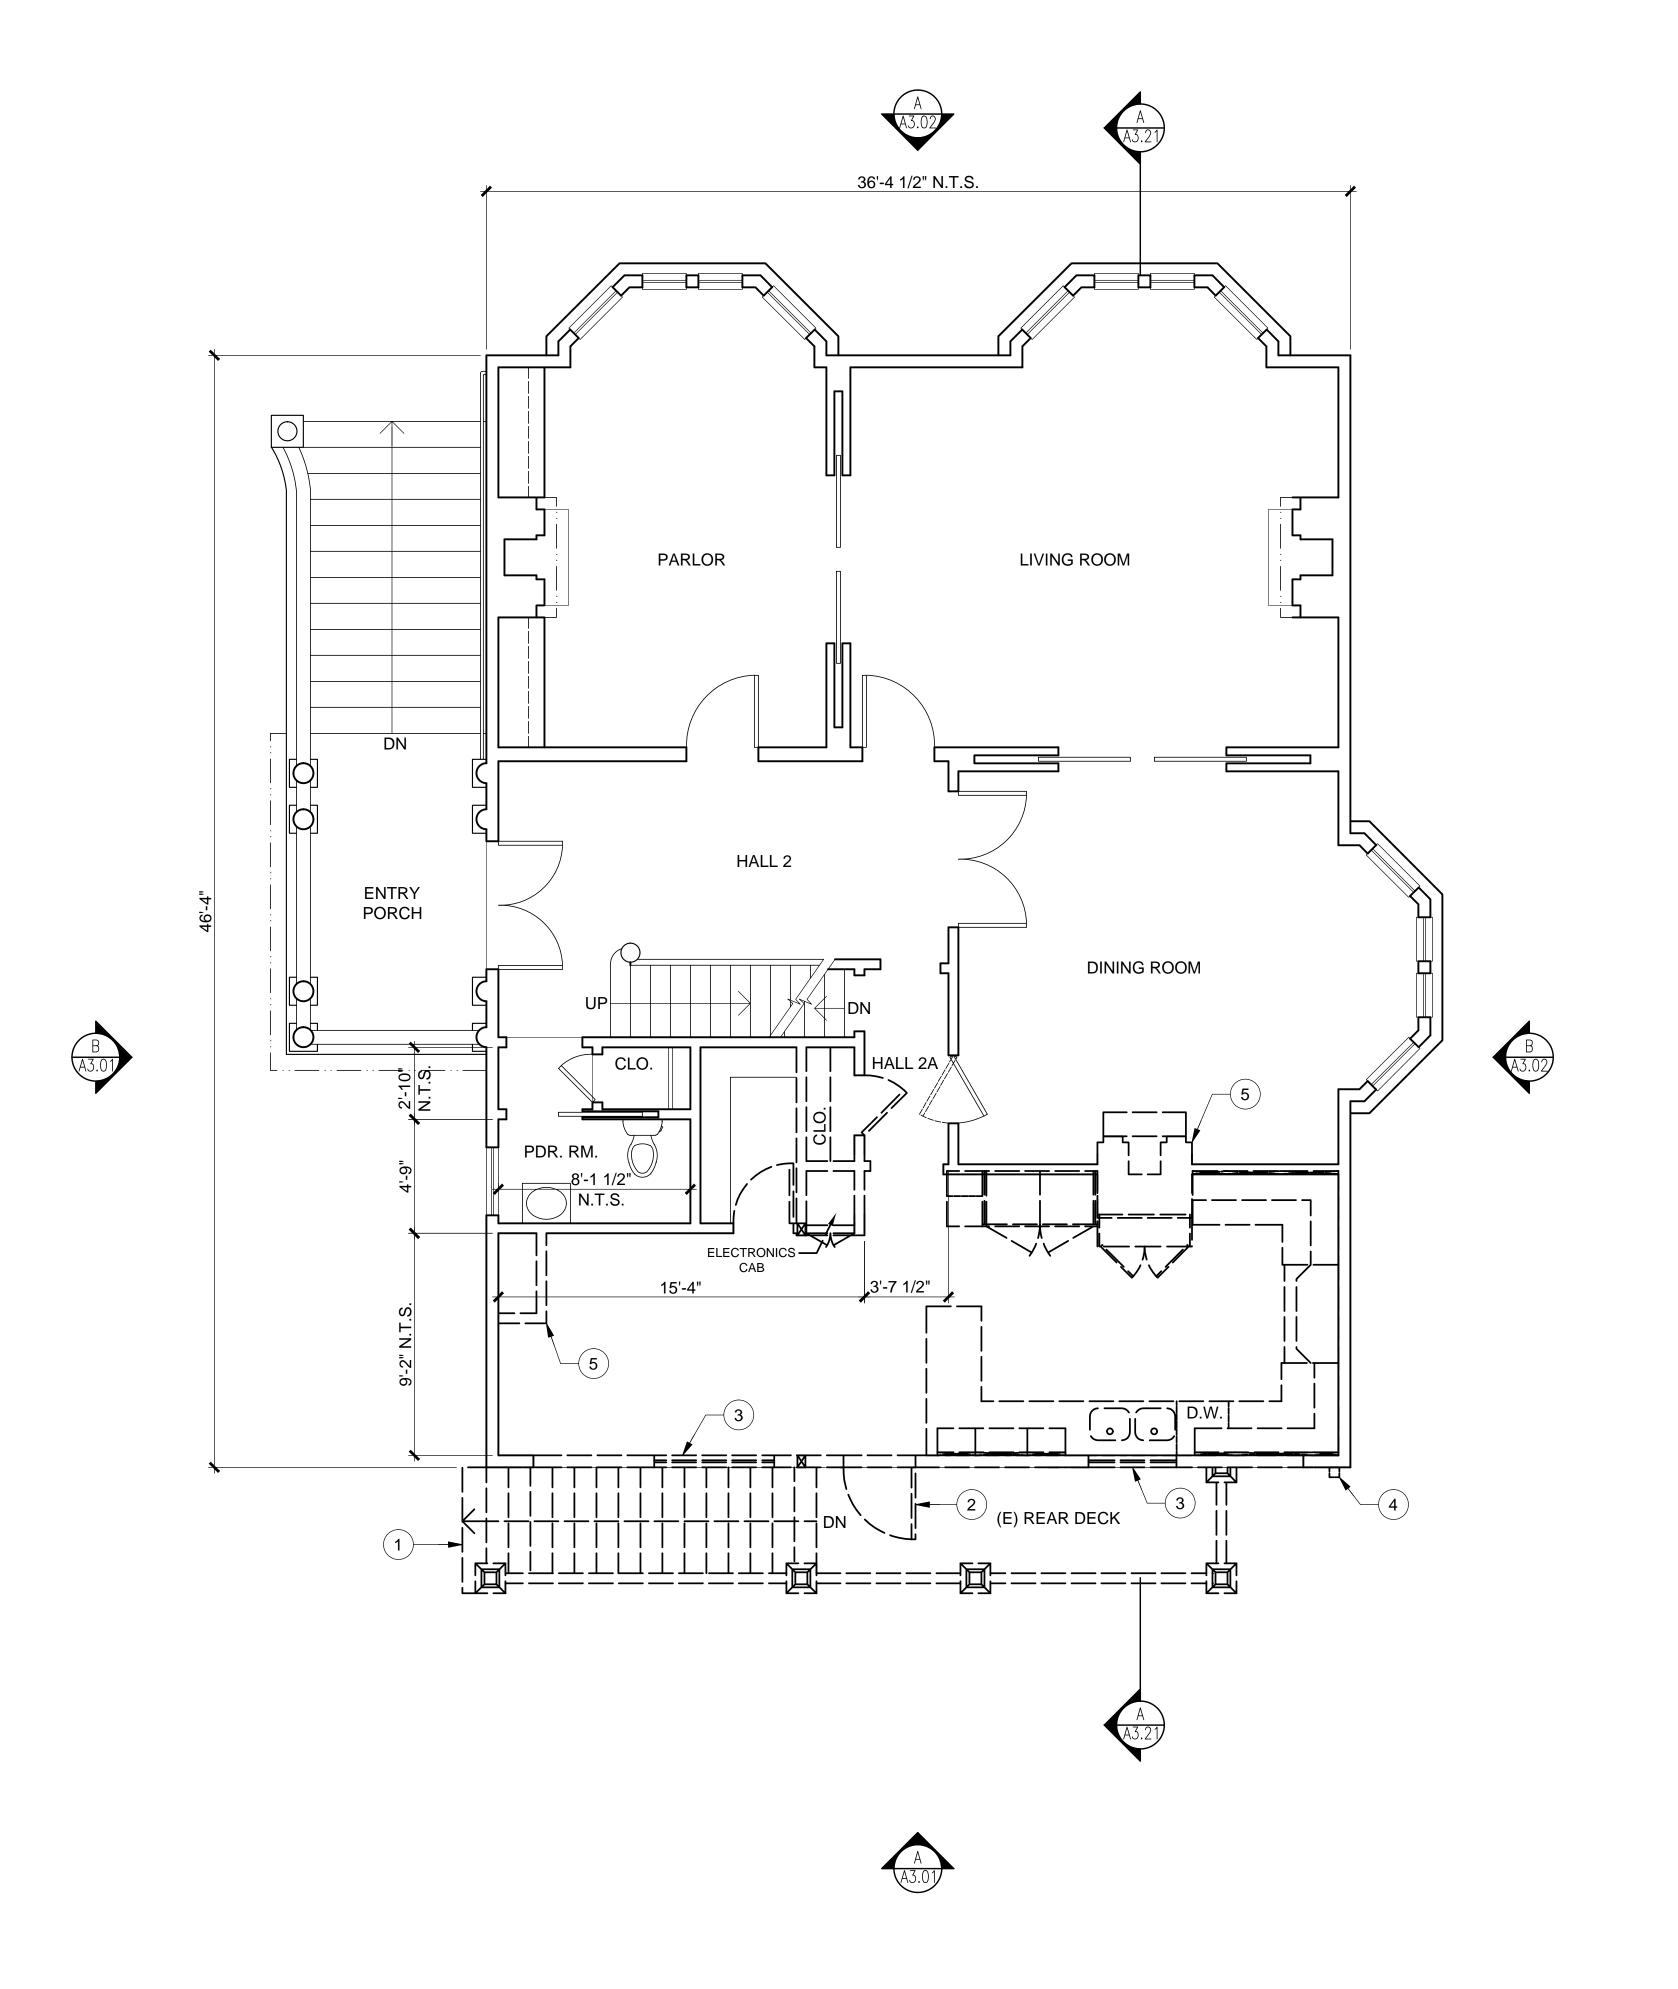

SECOND FLOOR PLAN



SHEET NOTES

- 1. PRIOR TO START OF REMOVAL, PROTECT IN PLACE ALL EXISTING (E) ELEMENTS TO REMAIN, TO PREVENT DAMAGE DURING CONSTRUCTION OF (N) WORK IN ADJACENT AREAS.
- 2. DEMOLISH AND REMOVE COMPLETE, ITEMS SHOWN DASHED AND NOTED FOR DEMOLITION.
- 3. MOVE ITEMS NOTED FOR SALVAGE TO OWNER'S DESIGNATED STORAGE LOCATION, PROTECTED FROM WEATHER AND RAISED ABOVE GROUND SURFACE, U.O.N.
- 4. WALL FINISH NOTED FOR DEMOLITION TO BE REMOVED BACK TO FACE OF STUD, U.O.N.
- 5. COORDINATE DEMOLITION SCOPE W/ STRUCTURAL DRAWINGS FOR LOCATIONS OF NEW STRUCTURAL ELEMENTS.
- 6. REFER TO ARCHITECTURAL GENERAL NOTES FOR ADDITIONAL DEMOLITION-SPECIFIC REQUIREMENTS.



ARCHITECTURE

GARAVAGLIA 582 MARKET STREET SAN FRANCISCO, CA 94104 T: 415.391.9633 F: 415.391.9647 www.garavaglia.com

MORAN RESIDENCE

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KEY NOTES


- 1 REMOVE (E) REAR DECK & STAIRS TO
- (2) REMOVE (E) WD. DOOR, FRAME & TRIM.
- 3 REMOVE (E) WD. WINDOW, FRAME & TRIM.
- REMOVE (E) "JOMY" FIRE ESCAPE LADDER.
- 5 REMOVE (E) MASONRY CHIMNEY; SALVAGE MANTLE & SURROUND WHERE OCCURS

FLOOR PLAN


DEMOLITION 2ND FLOOR

PROJ. NO. 2017-003 SCALE 1/4"=1'-0" 20 JUNE 2017 DATE PHASE $\underline{\mathrm{SD}}$ DRAWN <u>HA</u> CHECKED AW

NO. DATE	REVISION
18 JUL 2017	PLANNING REVIEW
11 SEPT 2017	C.O.A. APPLICATION
24 DEC 2019	ARC REVIEW
<u>12 FEB 2020</u>	UPDATE COA/311

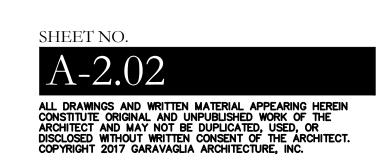




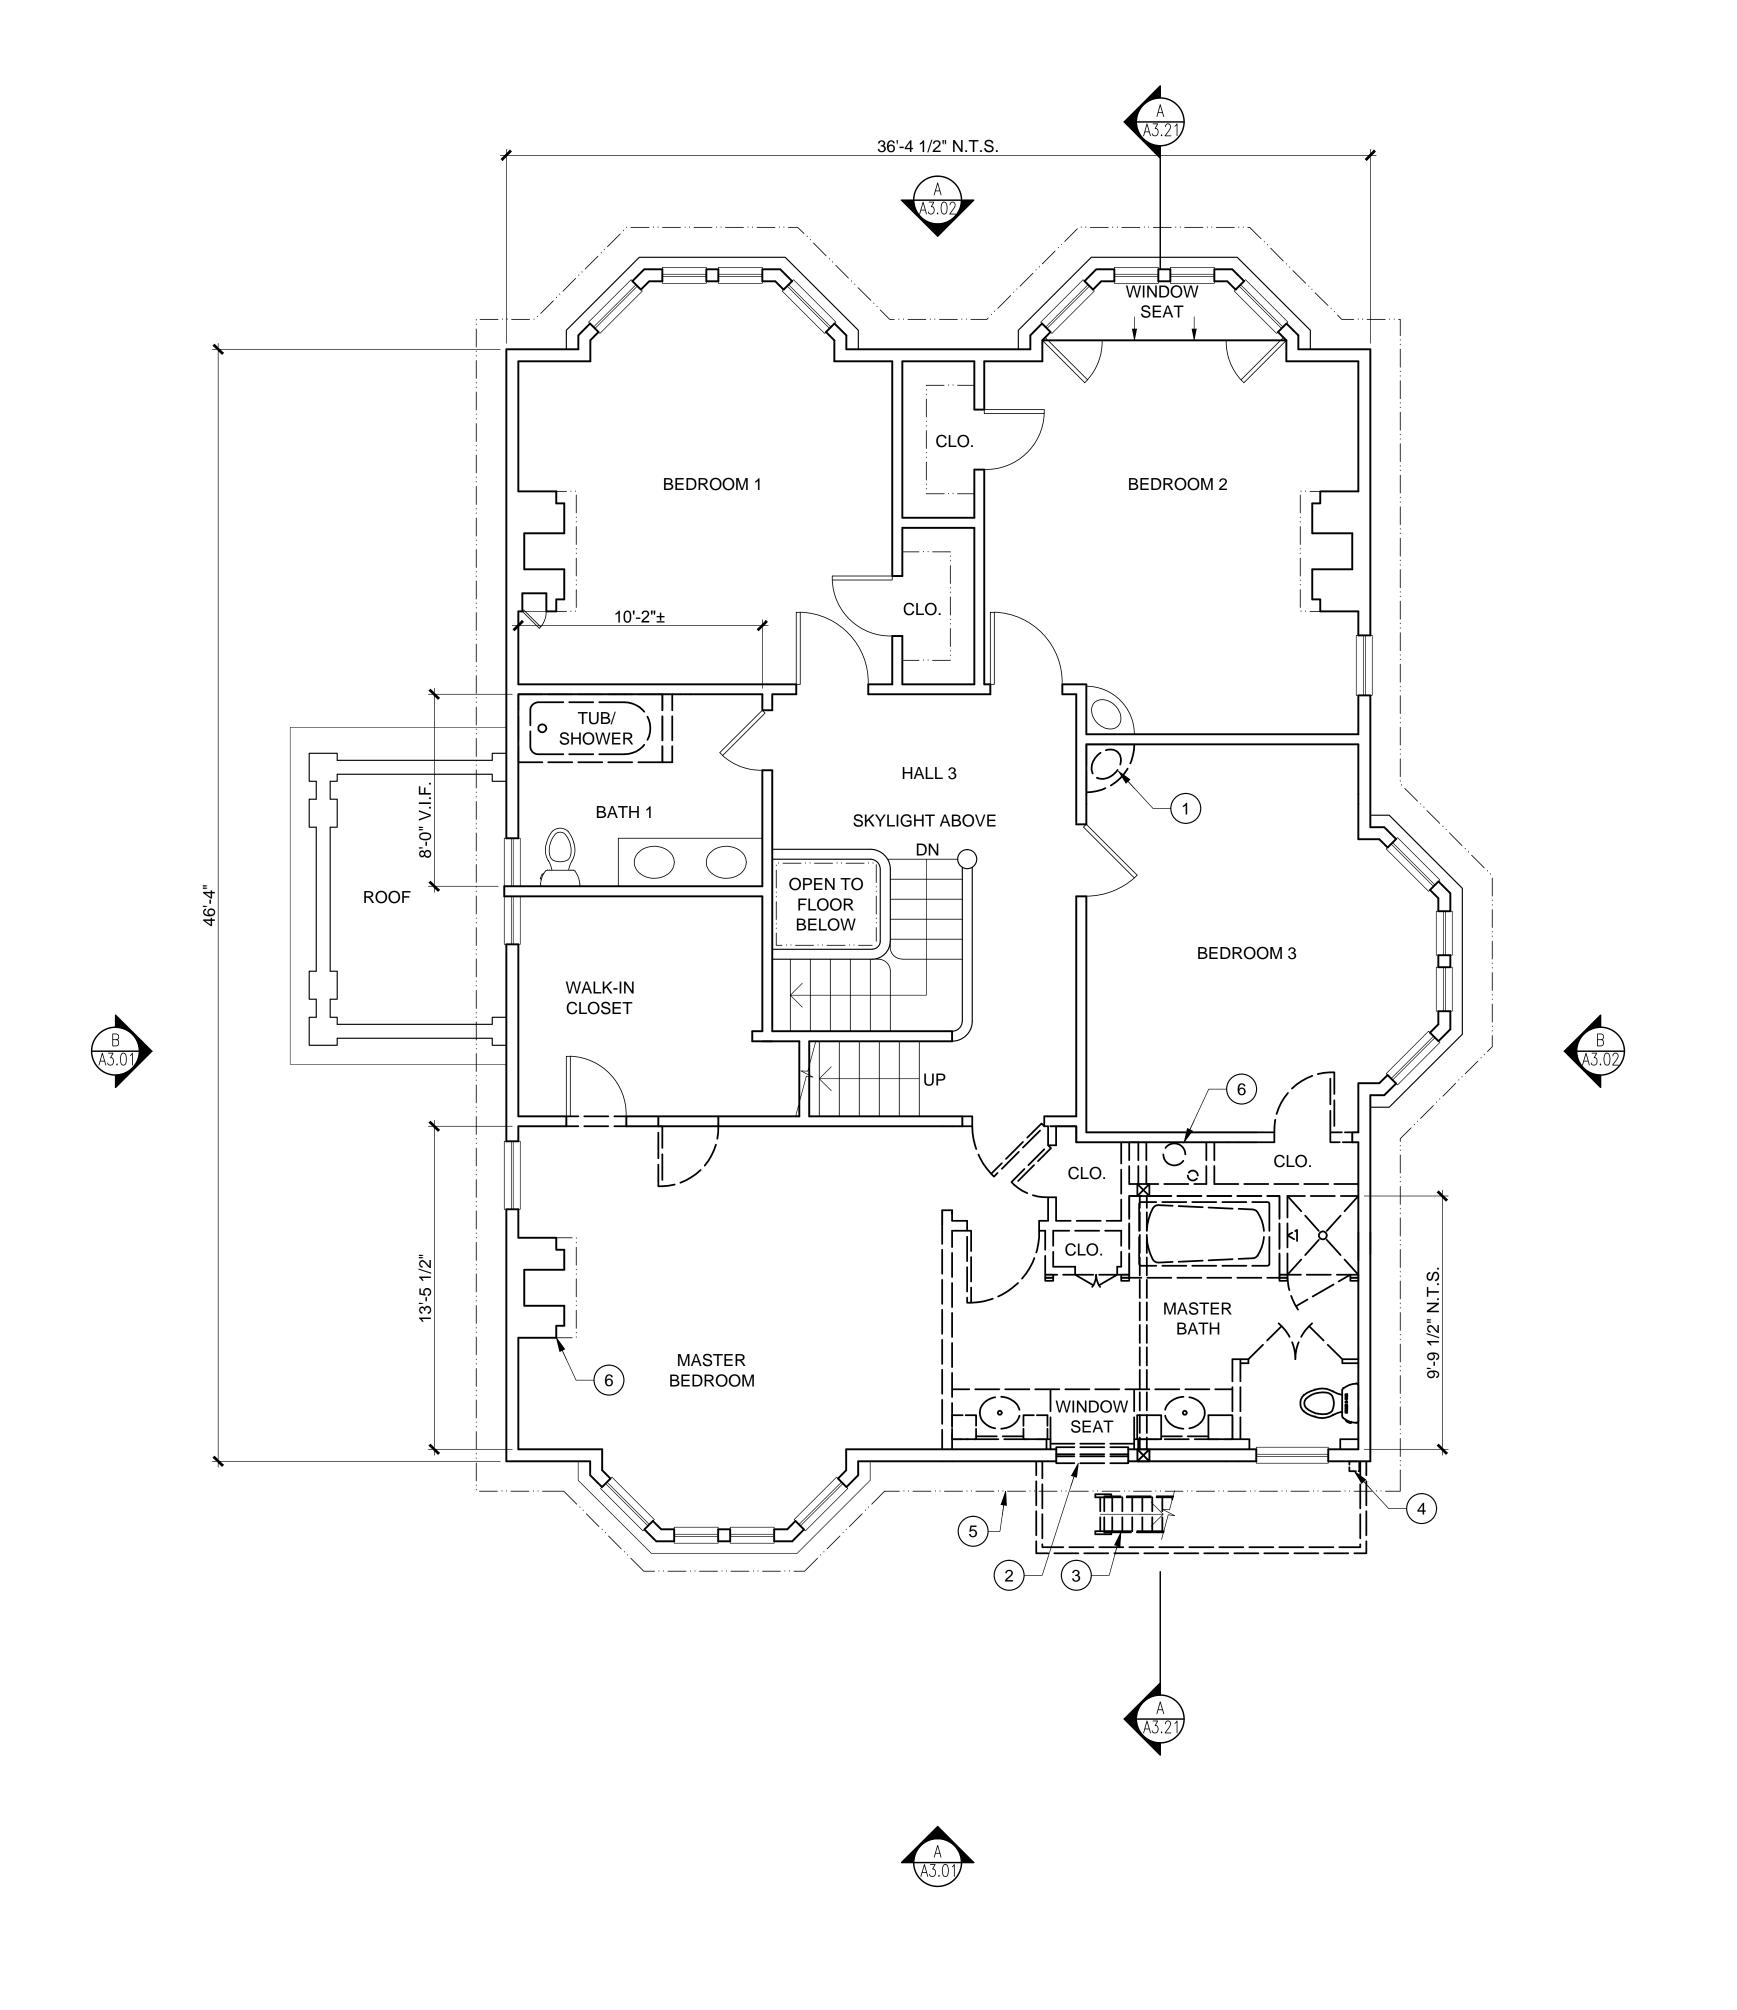

THIRD FLOOR PLAN

SCALE: 1/4" = 1'-0"

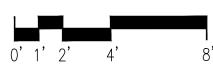

SHEET NOTES

- 1. PRIOR TO START OF REMOVAL, PROTECT IN PLACE ALL EXISTING (E) ELEMENTS TO REMAIN, TO PREVENT DAMAGE DURING CONSTRUCTION OF (N) WORK IN ADJACENT AREAS.
- 2. DEMOLISH AND REMOVE COMPLETE, ITEMS SHOWN DASHED AND NOTED FOR DEMOLITION.
- MOVE ITEMS NOTED FOR SALVAGE TO OWNER'S DESIGNATED STORAGE LOCATION, PROTECTED FROM WEATHER AND RAISED ABOVE GROUND SURFACE, U.O.N.
- 4. WALL FINISH NOTED FOR DEMOLITION TO BE REMOVED BACK TO FACE OF STUD, U.O.N.
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MORAN RESIDENCE

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KEY NOTES

- 1 REMOVE & SALVAGE (E) SINK & CABINET; STORE PER OWNER INSTRUCTIONS
- 2 REMOVE & SALVAGE (E) WOOD WINDOW.
- 3 REMOVE (E) FIRE ESCAPE.
- 4 REMOVE (E) "JOMY" FIRE ESCAPE LADDER.
- 5 OVERHANG OF (E) ROOF CORNICE ABOVE.
- 6 REMOVE (E) MASONRY CHIMNEY; SALVAGE MANTLE & SURROUND WHERE OCCURS

FLOOR PLAN


DEMOLITION 3RD FLOOR

PROJ. NO. 2017-003 SCALE 1/4"=1'-0" DATE <u>20 JUNE 2017</u> PHASE <u>SD</u> DRAWN <u>HA</u>


CHECKED <u>AW</u>

NO. DATE REVISION



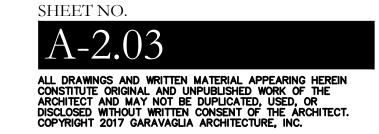



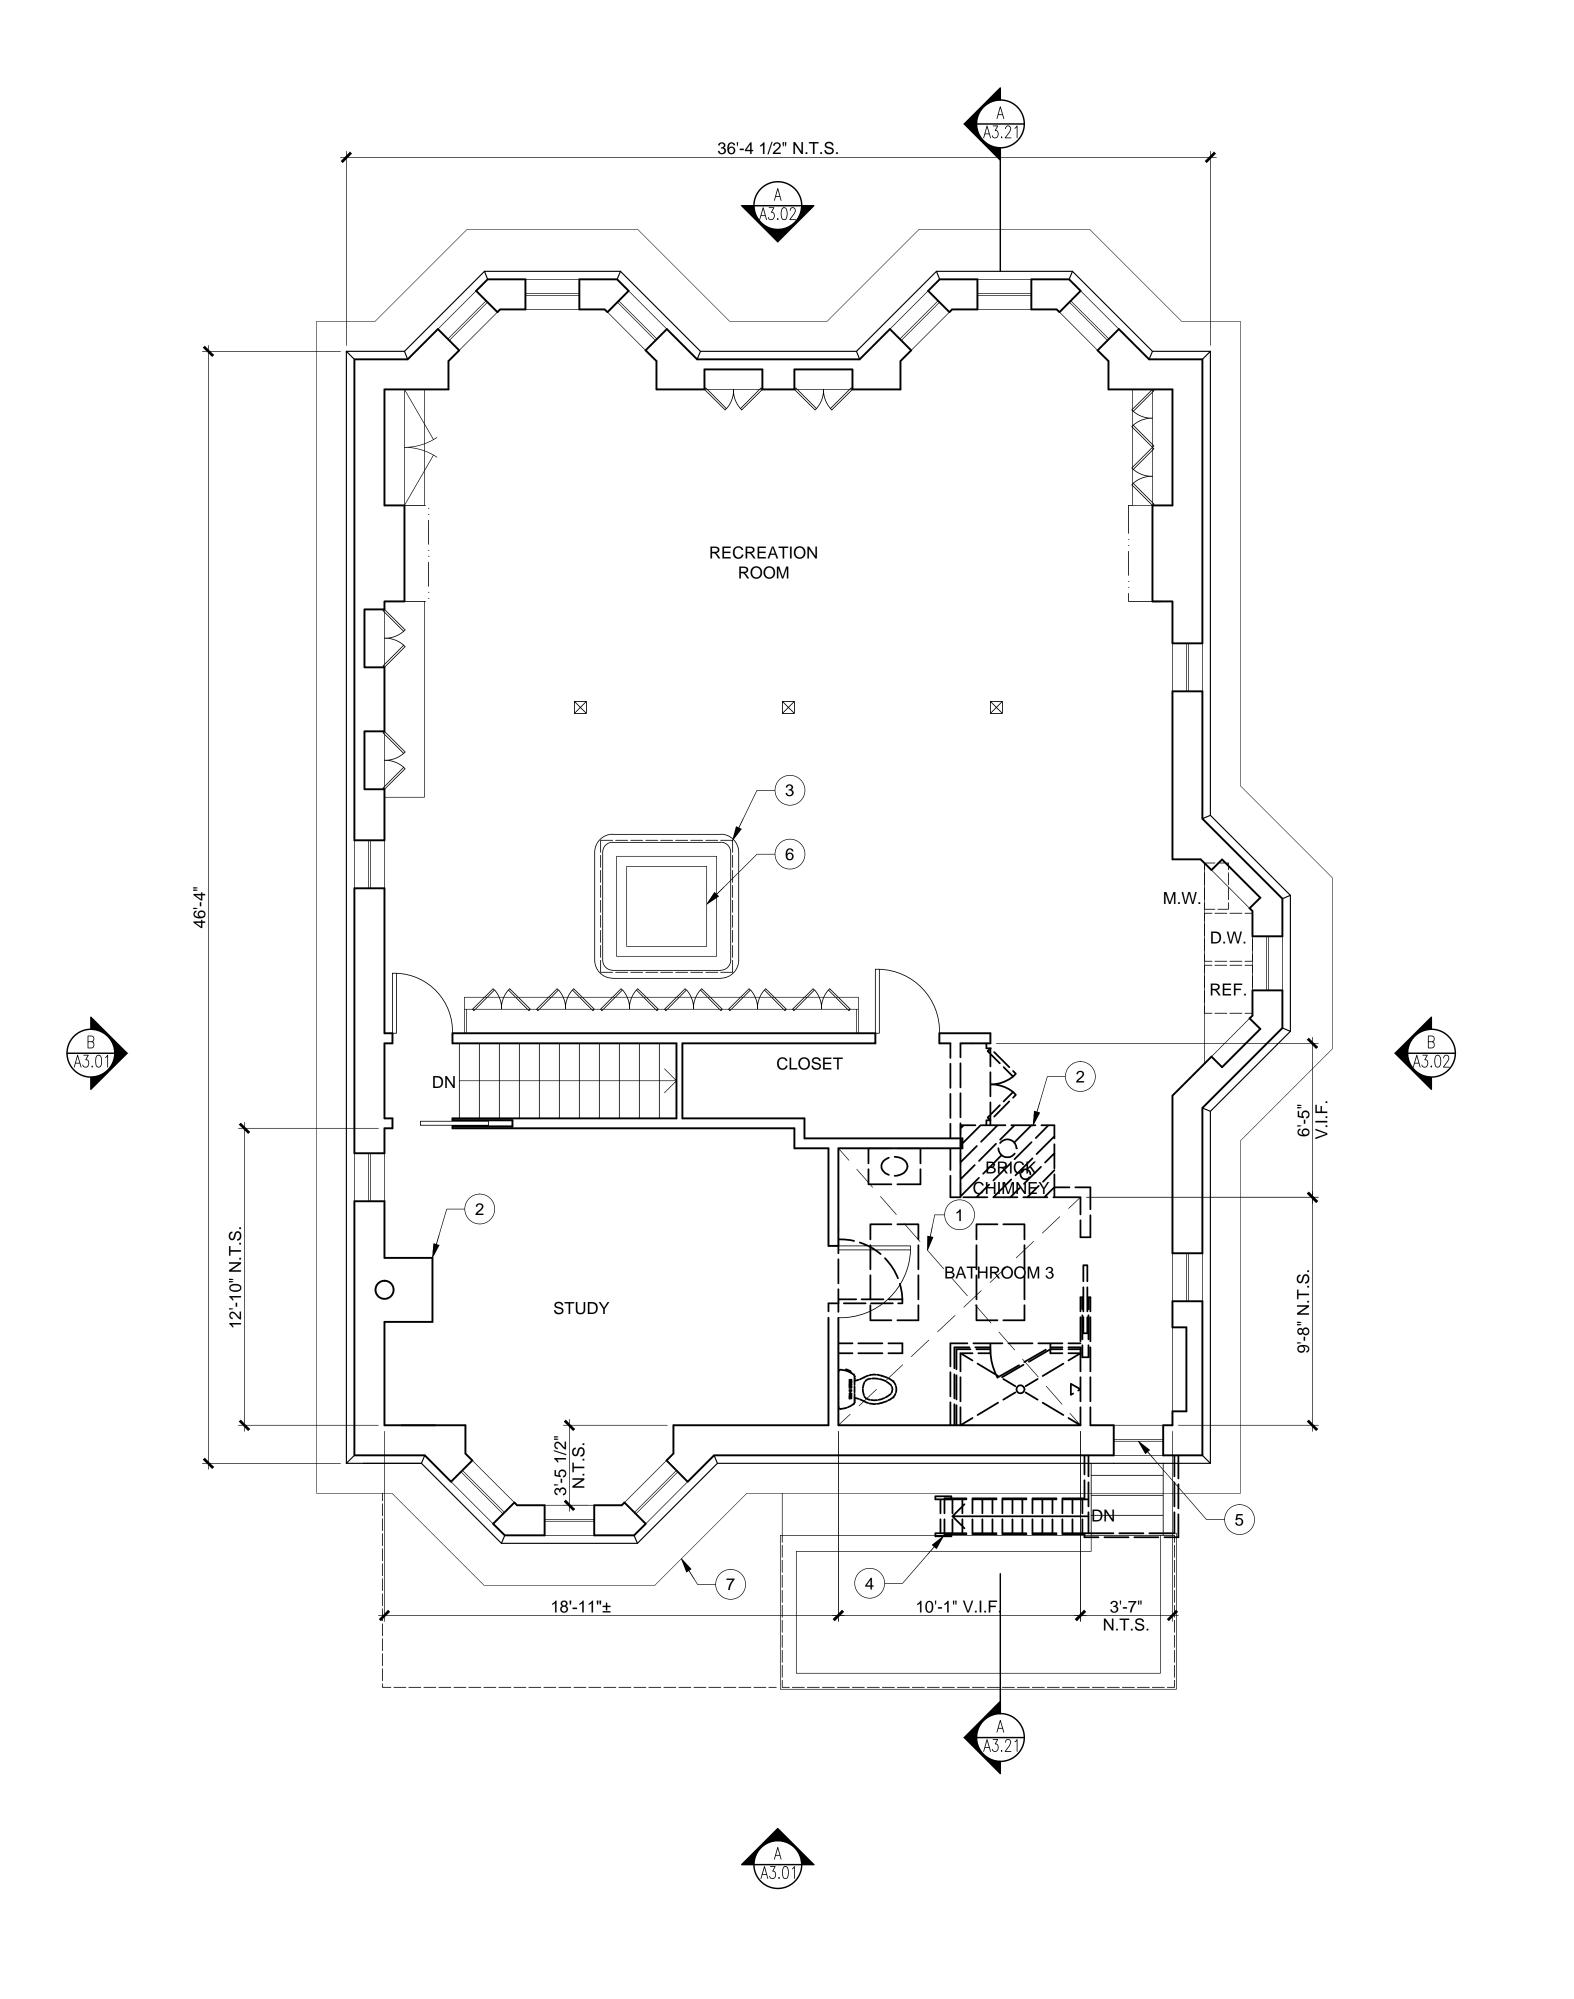

FOURTH FLOOR PLAN SCALE: 1/4" = 1'-0"



SHEET NOTES

- 1. PRIOR TO START OF REMOVAL, PROTECT IN PLACE ALL EXISTING (E) ELEMENTS TO REMAIN, TO PREVENT DAMAGE DURING CONSTRUCTION OF (N) WORK IN ADJACENT AREAS.
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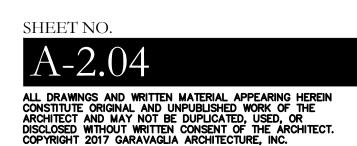
KEY NOTES

- 1 REMOVE FIXTURES & FINISHES BACK TO FOS &T.O. SUBFLOOR
- 2 REMOVE (E) BRICK CHIMNEY COMPLETE
- (E) SKYLIGHT ABOVE; PROTECT IN PLACE.
- 4 REMOVE (E) FIRE ESCAPE & LADDER.
- (E) WD WINDOW TO REMAIN. PROTECT IN PLACE.
- (E) STAINED GLASS SKYLIGHT AT FLOOR LEVEL w/ (E) WOOD RAILING TO REMAIN
- 7 (E) BAY WINDOW AND CORNICE TO REMAIN


FLOOR PLAN

DEMOLITION 4TH FLOOR


PROJ. NO. 2017-003 SCALE 1/4''=1'-0''20 JUNE 2017 DATE PHASE <u>SD</u> DRAWN HA CHECKED AW





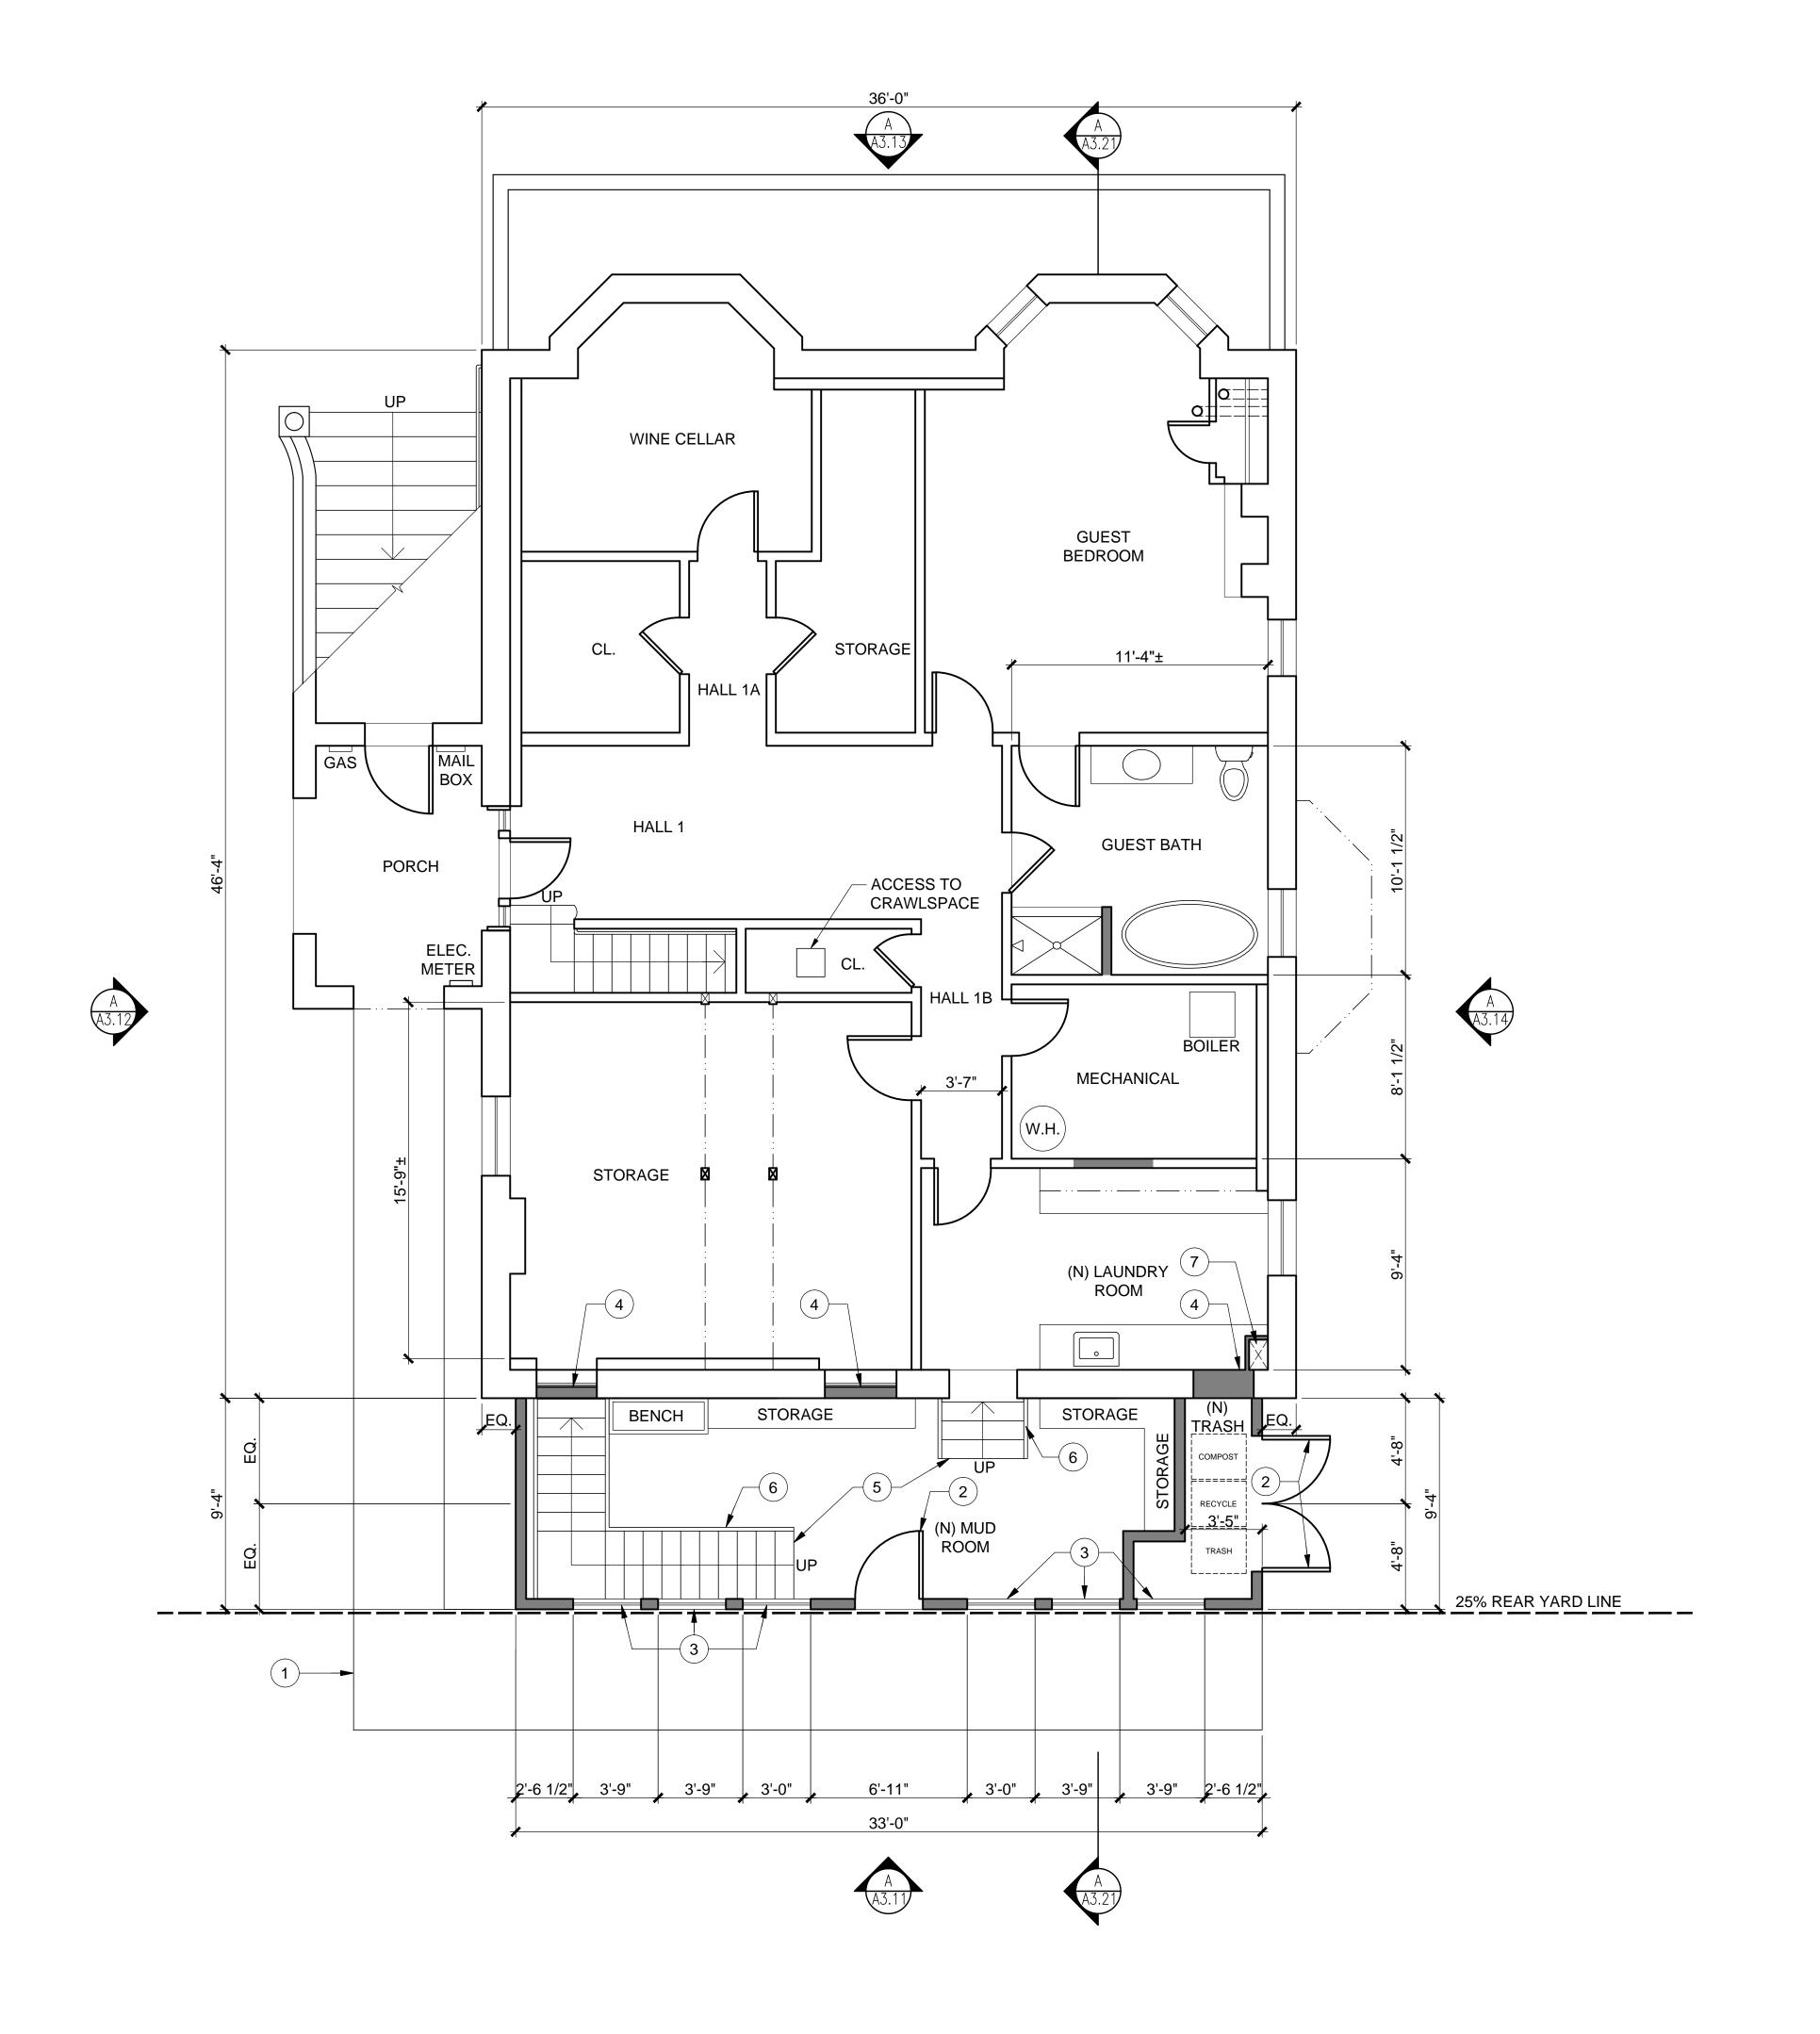

FIRST FLOOR PLAN SCALE: 1/4" = 1'-0"

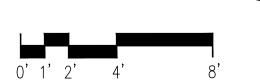



SHEET NOTES

- 1. PROTECT IN PLACE ALL EXISTING (E) ELEMENTS TO REMAIN, TO PREVENT DAMAGE DURING CONSTRUCTION OF (N) WORK IN ADJACENT AREAS.
- 2. BUILD WALLS, DOORWAYS AND WINDOW OPENINGS AS LOCATED.
- 3. COORDINATE PROPOSED SCOPE OF WORK W/ ENGINEERING DRAWINGS FOR LOCATIONS OF STRUCTURAL & OTHER BUILDING ELEMENTS.
- 4. ALL (E) HISTORIC WINDOWS & DOORS, TRIM & OTHER SIMILAR ELEMENTS ARE TO REMAIN IN PLACE & BE PROTECTED FROM DAMAGE FOR THE DURATION OF CONSTRUCTION, UON.



SUITE 1800 SAN FRANCISCO, CA 94104 T: 415.391.9633 F: 415.391.9647 www.garavaglia.com

MORAN RESIDENCE

1772 VALLEJO STREET SAN FRANCISCO, CA 94123

KEY NOTES

- 1 REQUIRED LEVEL LANDING
- (N) DOORWAY
- (N) WINDOW OPENING
- (N) WALL INFILL AT (E) OPENING
- (5) (N) STAIR
- (6) (N) STAIR RAILING
- (N) LAUNDRY CHUTE


FLOOR PLAN

PROPOSED 1ST FLOOR


PROJ. NO. 2017-003 SCALE 1/4"=1'-0" 20 JUNE 2017 DATE PHASE \underline{SD}

DRAWN HA CHECKED <u>AW</u>

REVISION NO. DATE

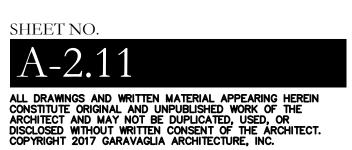



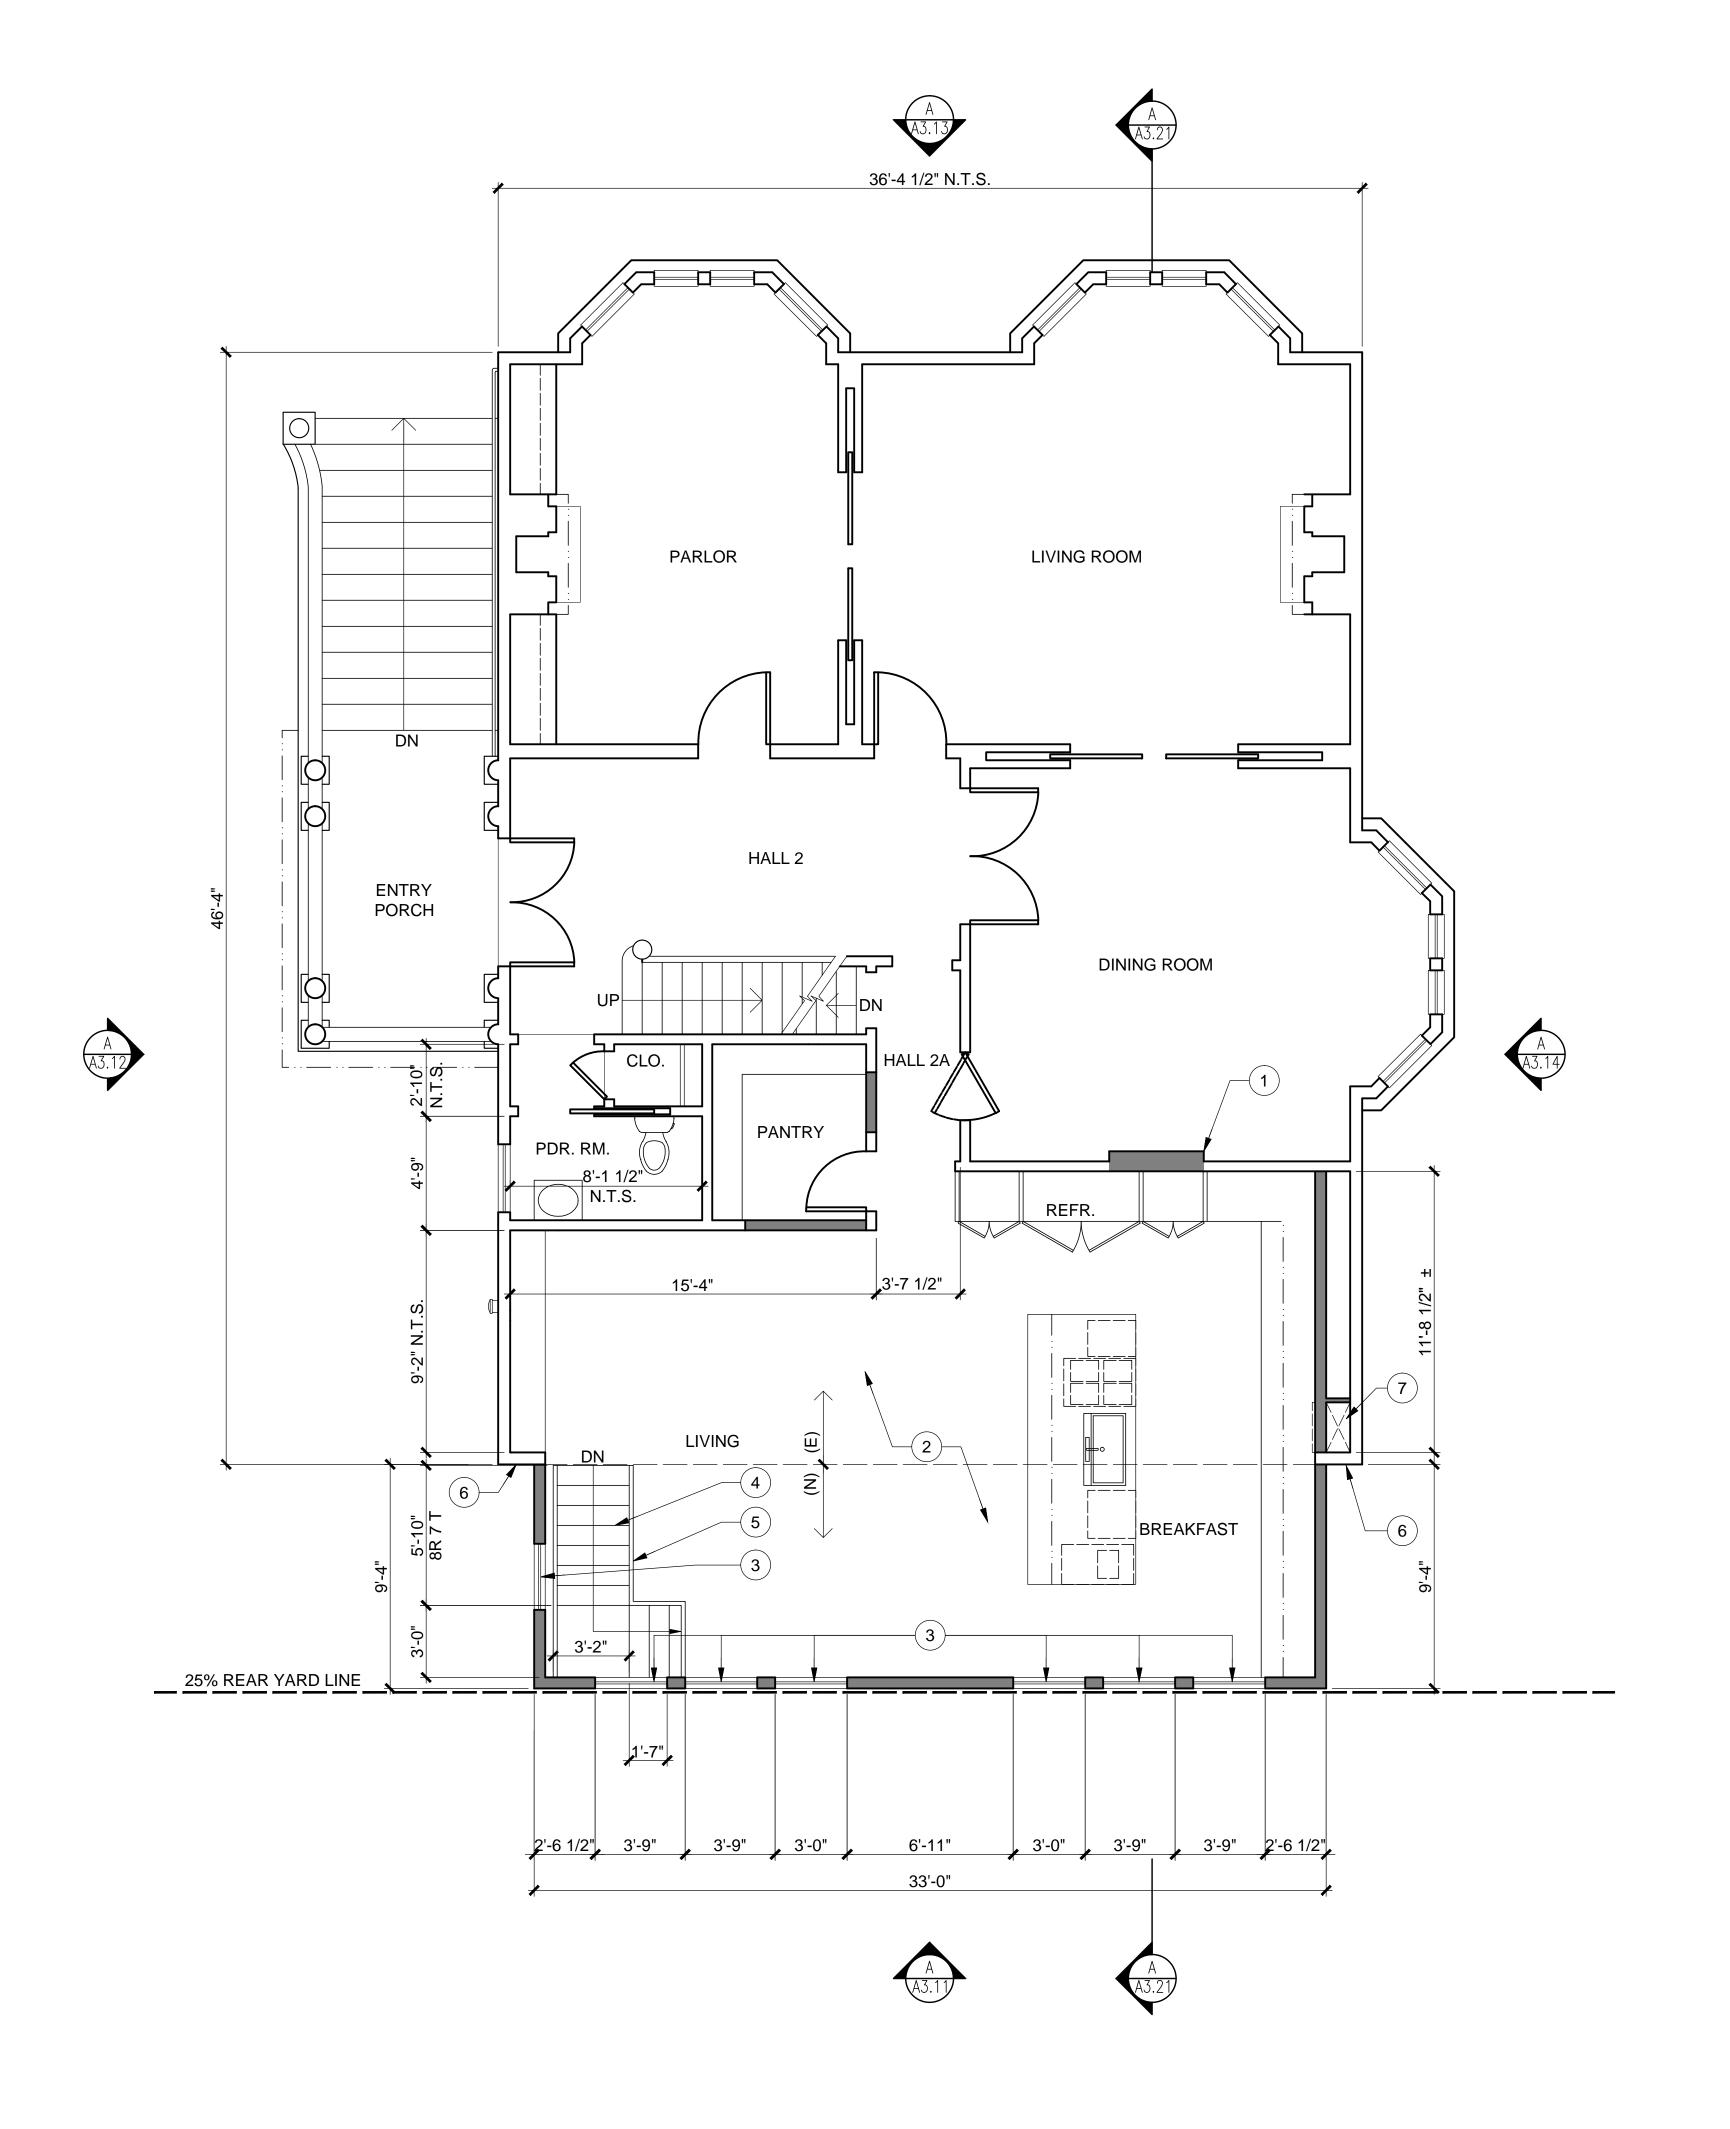

SECOND FLOOR PLAN

SCALE: 1/4" = 1'-0"



SHEET NOTES

- 1. PROTECT IN PLACE ALL EXISTING (E) ELEMENTS TO REMAIN, TO PREVENT DAMAGE DURING CONSTRUCTION OF (N) WORK IN ADJACENT AREAS.
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- 4. ALL (E) HISTORIC WINDOWS & DOORS, TRIM & OTHER SIMILAR ELEMENTS ARE TO REMAIN IN PLACE & BE PROTECTED FROM DAMAGE FOR THE DURATION OF CONSTRUCTION, UON.



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MORAN RESIDENCE

1772 VALLEJO STREET SAN FRANCISCO, CA 94123

KEY NOTES

- 1 REINSTALL SALVAGED ORIGINAL MANTLE AND SURROUND
- (2) (N) SOFFITED CEILING ABOVE
- (N) WINDOWS, TYP.
- 4 (N) STAIR
- (N) STAIR RAILING
- (E) QUOINS TO REMAIN
- 7 (N) LAUNDRY CHUTE


FLOOR PLAN


PROPOSED 2ND FLOOR


PROJ. NO. 2017-003 SCALE 1/4"=1'-0" 20 JUNE 2017 DATE PHASE \underline{SD} DRAWN HA

CHECKED <u>AW</u>

REVISION NO. DATE

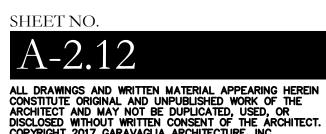

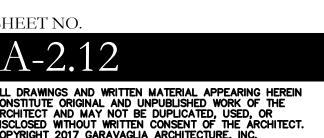

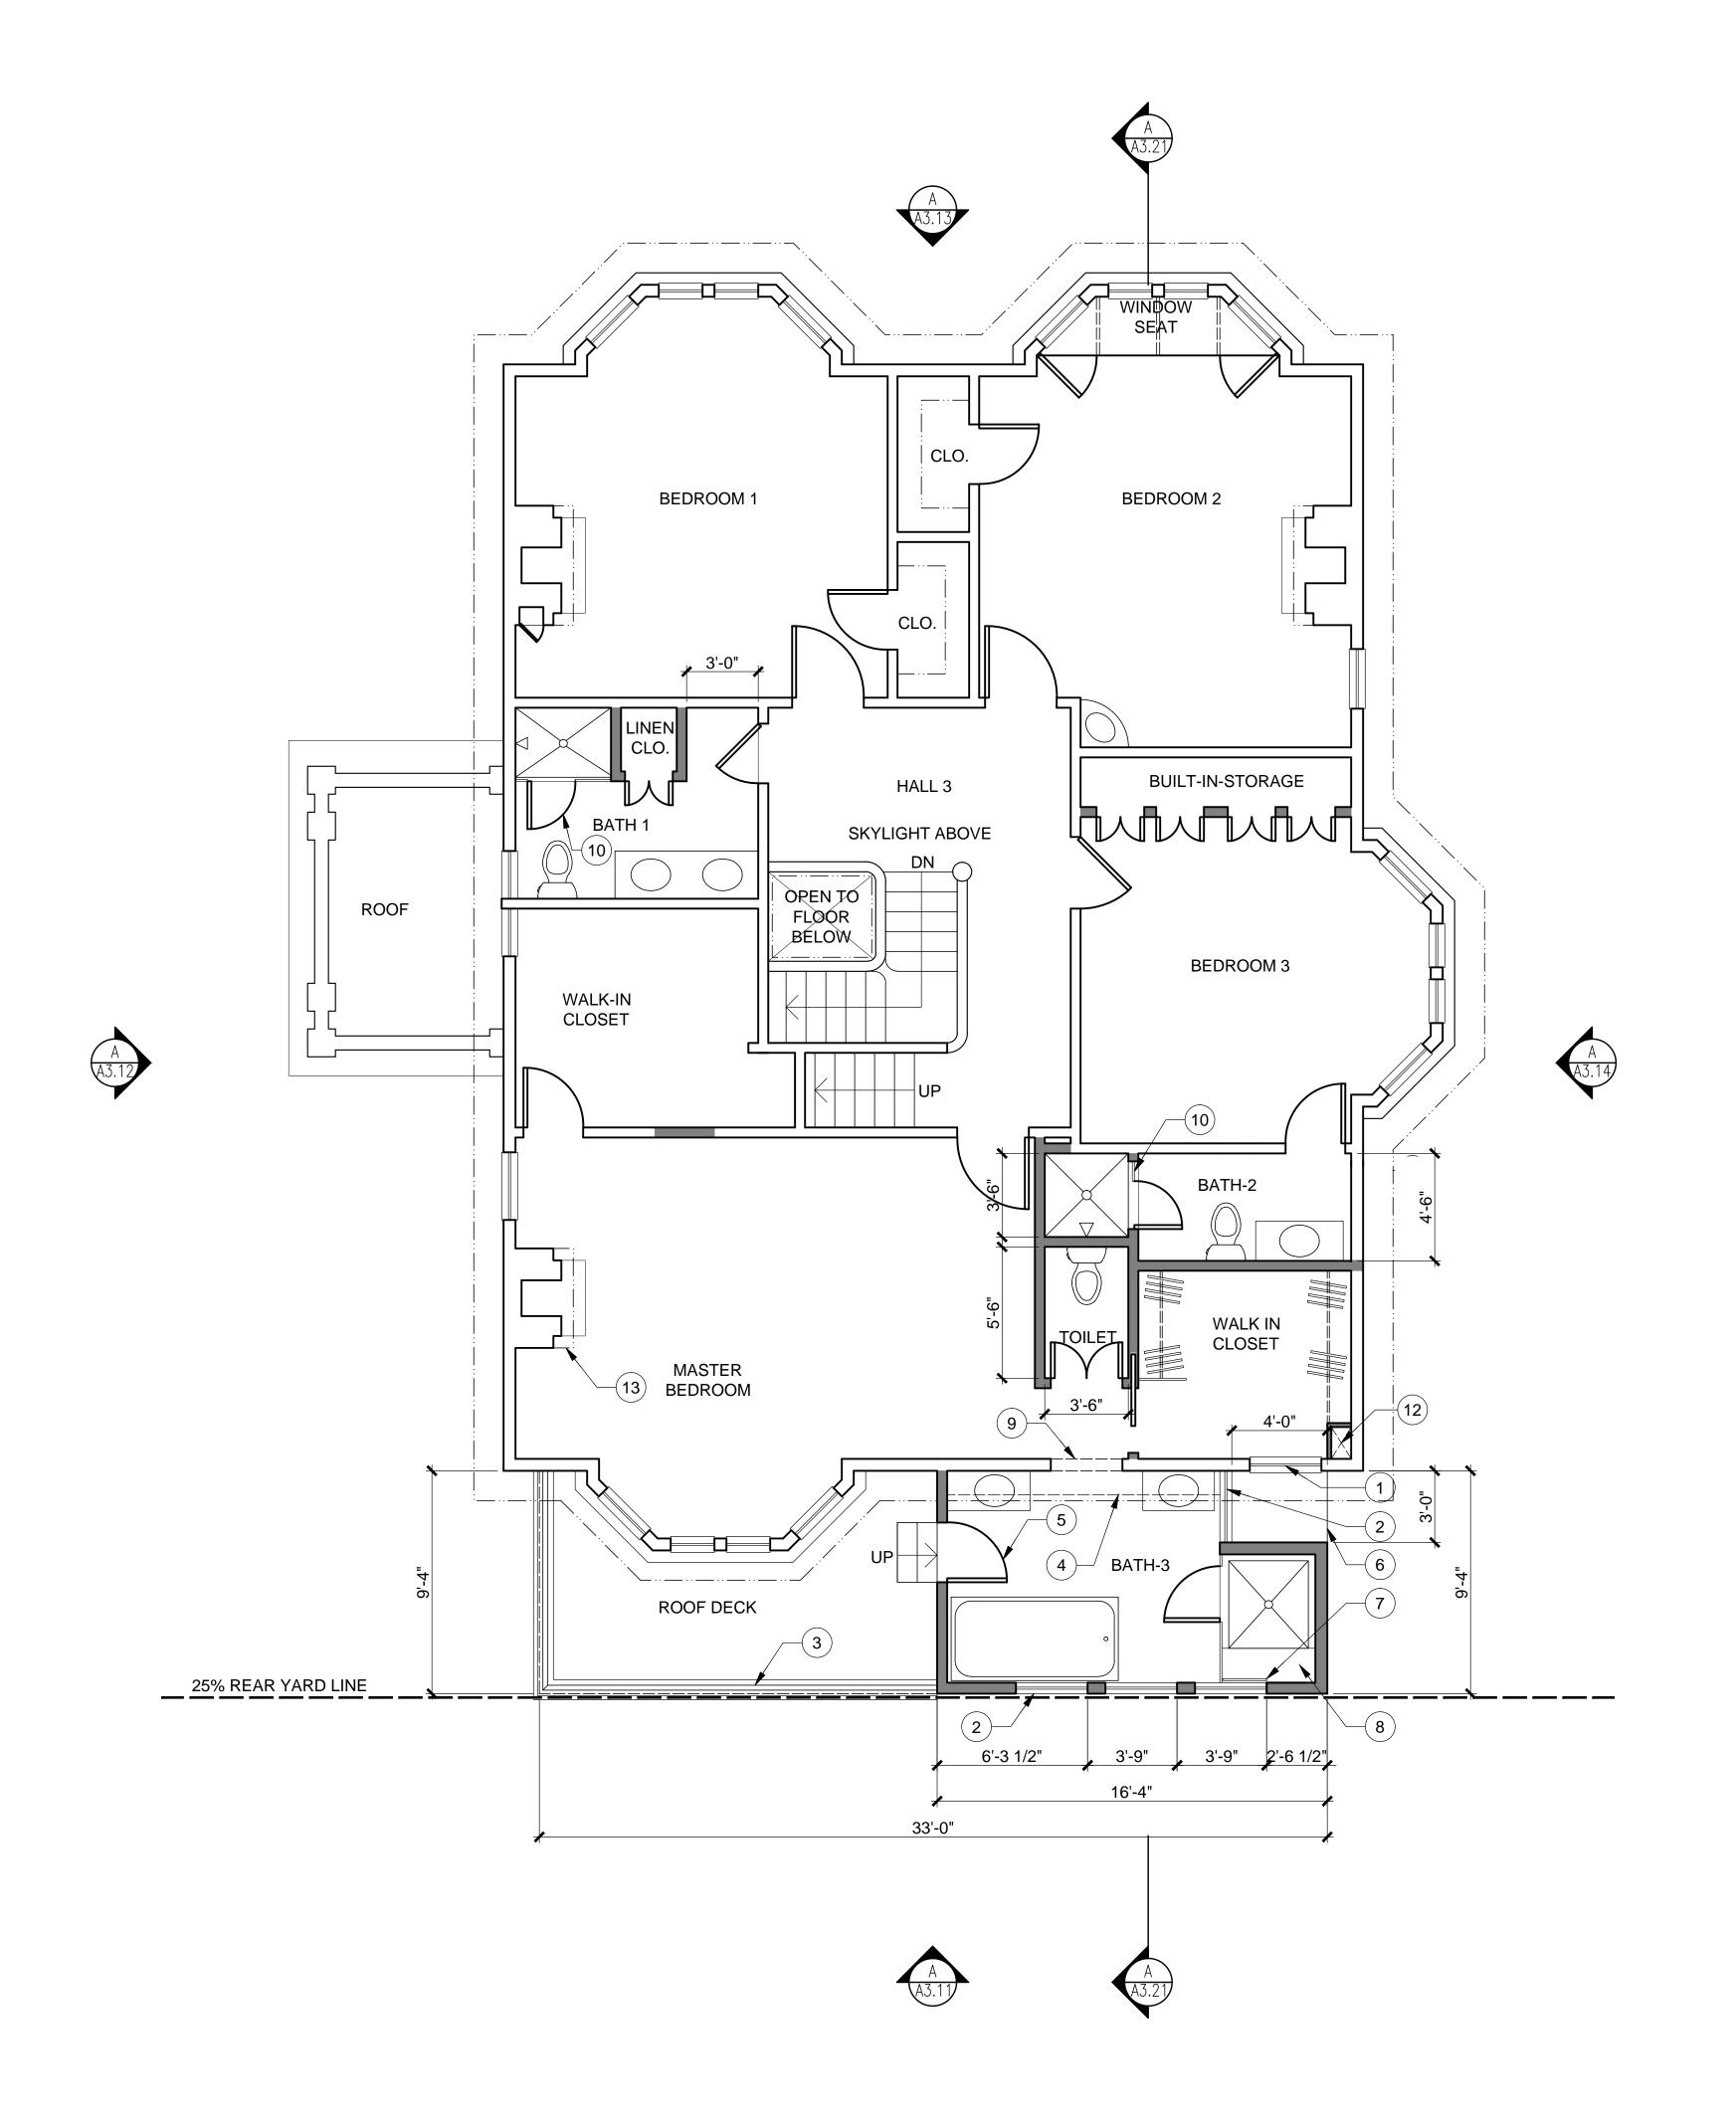

THIRD FLOOR PLAN

SCALE: 1/4" = 1'-0"



SHEET NOTES

- 1. PROTECT IN PLACE ALL EXISTING (E) ELEMENTS TO REMAIN, TO PREVENT DAMAGE DURING CONSTRUCTION OF (N) WORK IN ADJACENT AREAS.
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- 4. ALL (E) HISTORIC WINDOWS & DOORS, TRIM & OTHER SIMILAR ELEMENTS ARE TO REMAIN IN PLACE & BE PROTECTED FROM DAMAGE FOR THE DURATION OF CONSTRUCTION, UON.



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MORAN RESIDENCE

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KEY NOTES

- (E) WINDOW TO REMAIN; PROTECT IN PLACE
- (N) WINDOWS, TYP.
- (3) WOOD RAILING
- (4) (N) SKYLIGHT ABOVE AT HYPHEN
- (5) BLIND DOOR
- 6 ROOF BELOW
- 7 TEMPERED GLASS PANEL
- 8 SHOWER SEAT
- (9) (E) WINDOW OPENED AS DOOR
- (10) SHOWER GLASS ENCLOSURE & GLASS DOOR
- 11 NOT USED
- (12) (N) LAUNDRY CHUTE
- 13 REINSTALL SALVAGED ORIGINAL MANTLE AND SURROUND


FLOOR PLAN


PROPOSED 3RD FLOOR

PROJ. NO. <u>2017-003</u> SCALE 1/4"=1'-0"DATE 20 JUNE 2017

PHASE <u>SD</u> DRAWN <u>HA</u> CHECKED <u>AW</u>


NO. DATE REVISION

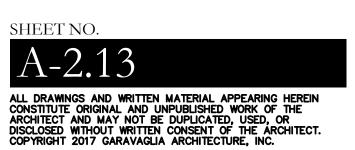

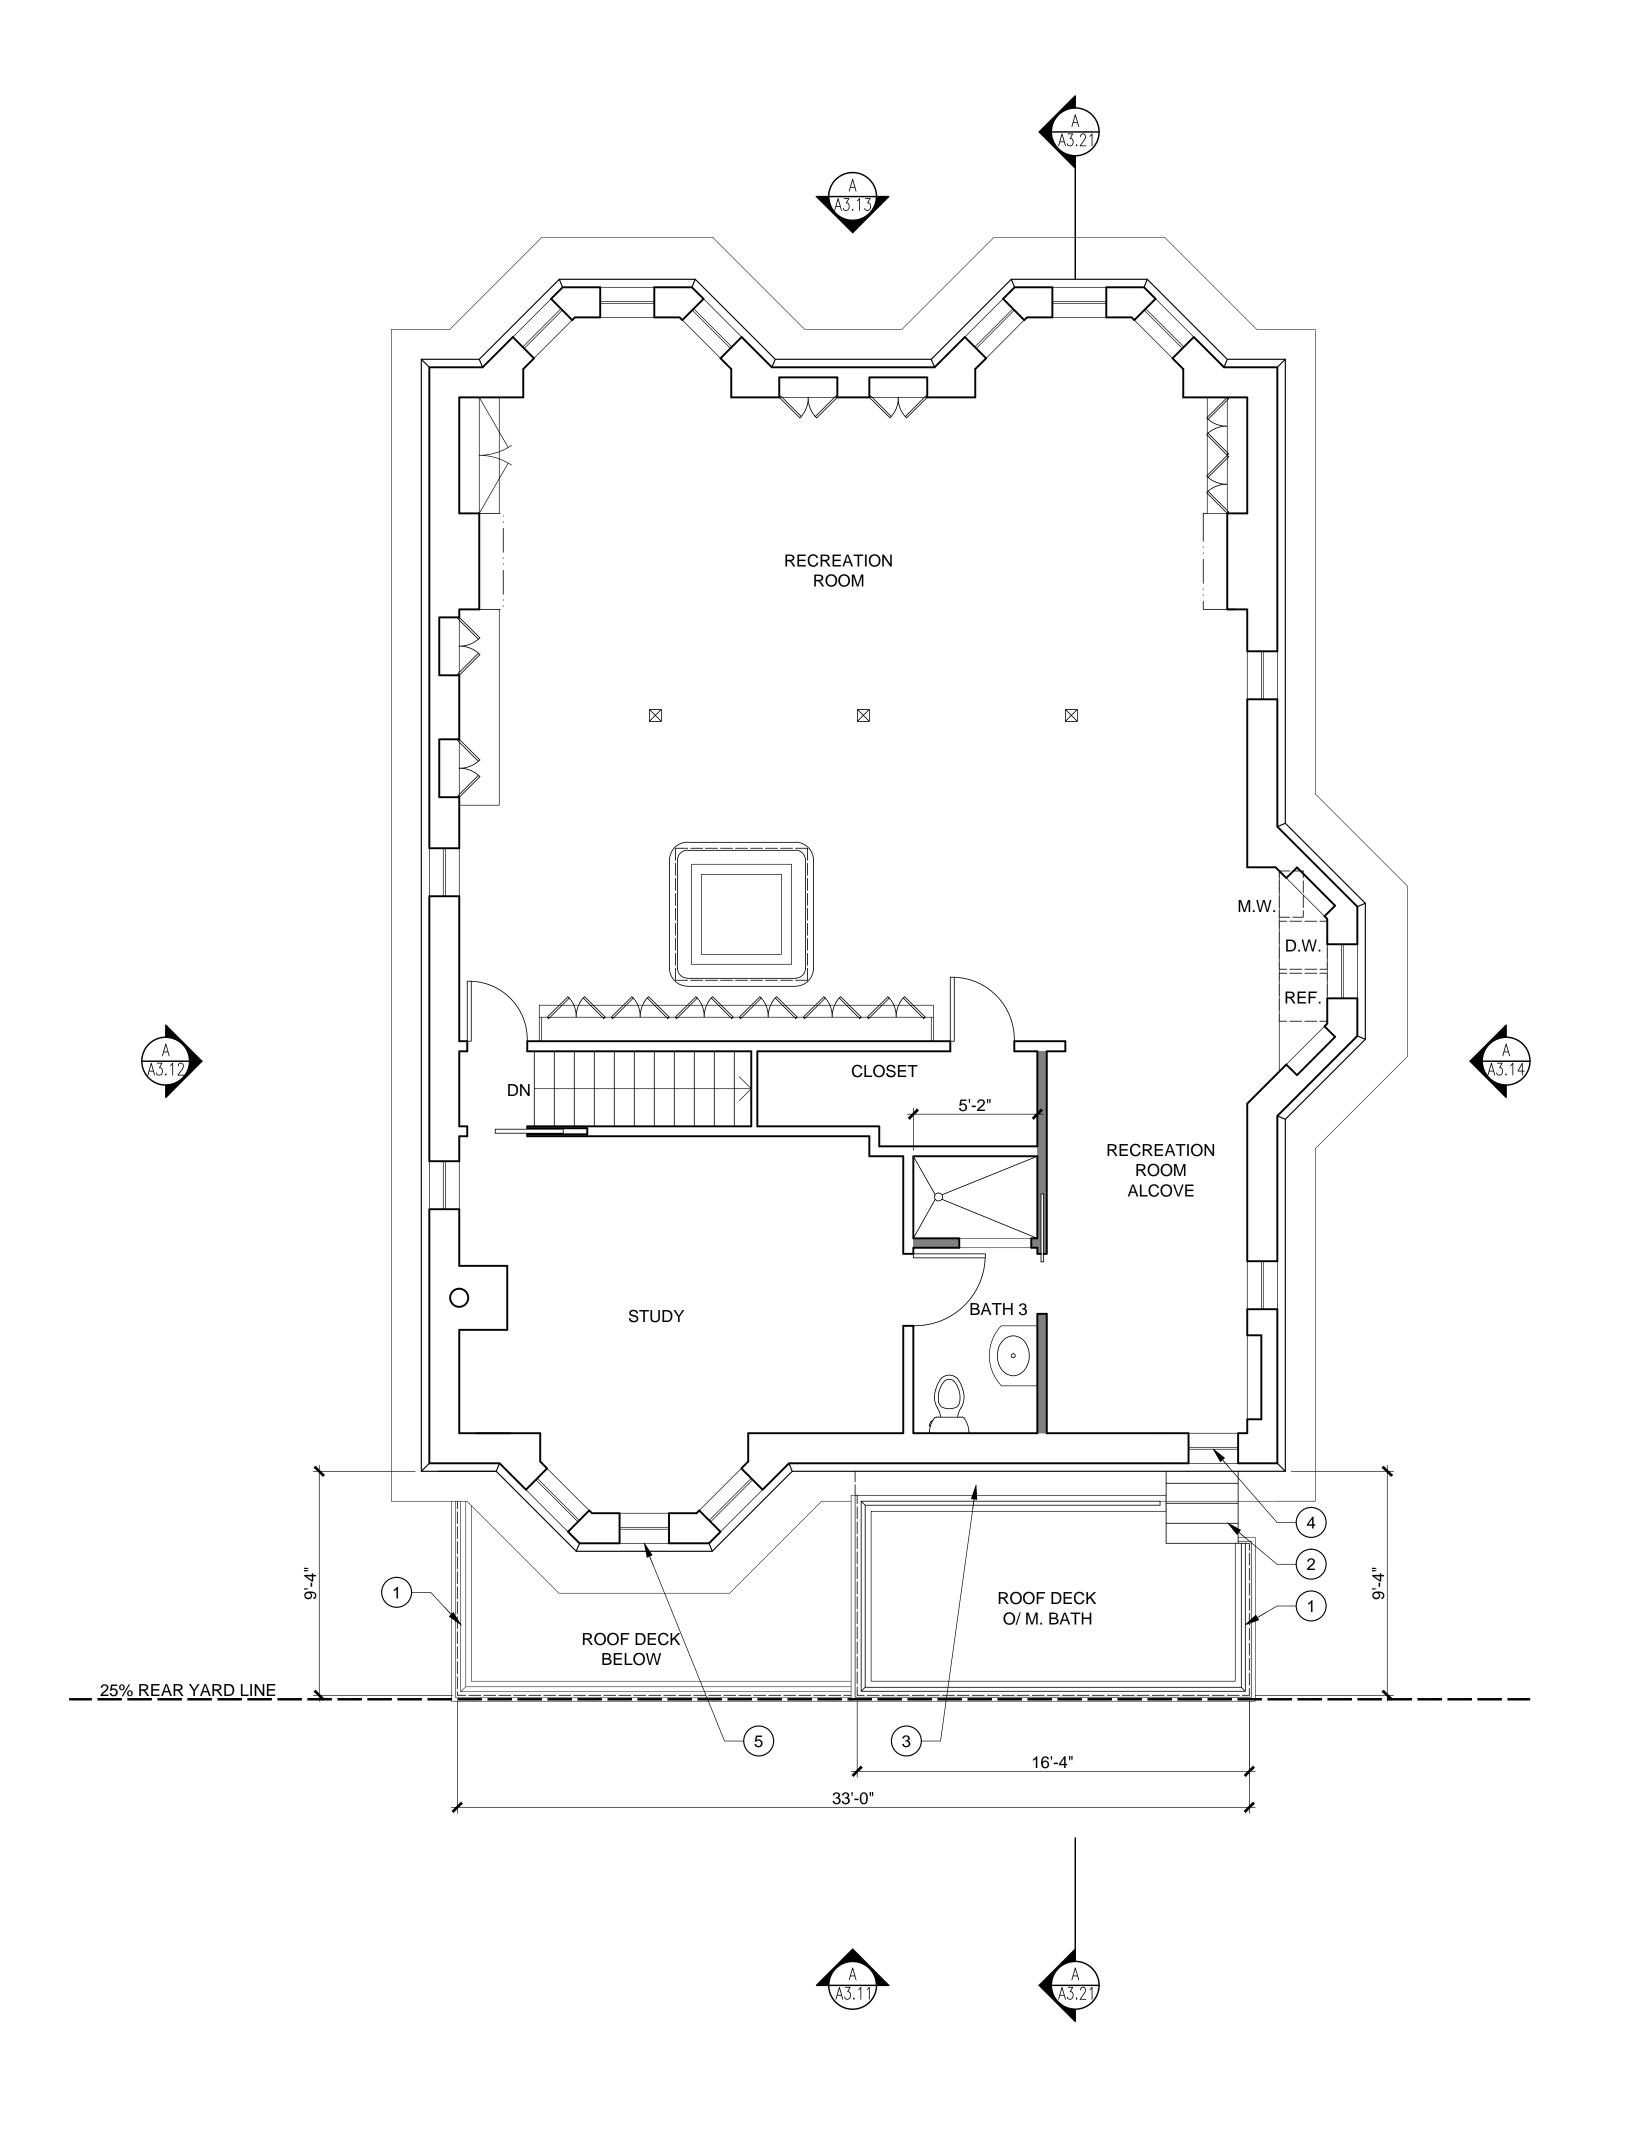

FOURTH FLOOR PLAN

SCALE: 1/4" = 1'-0"

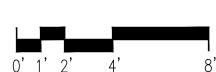

SHEET NOTES

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- 3. COORDINATE PROPOSED SCOPE OF WORK W/ ENGINEERING DRAWINGS FOR LOCATIONS OF STRUCTURAL& OTHER BUILDING ELEMENTS.
- 4. ALL (E) HISTORIC WINDOWS & DOORS, TRIM & OTHER SIMILAR ELEMENTS ARE TO REMAIN IN PLACE & BE PROTECTED FROM DAMAGE FOR THE DURATION OF CONSTRUCTION, UON.



582 MARKET STREET SUITE 1800 SAN FRANCISCO, CA 94104 T: 415.391.9633 F: 415.391.9647 www.garavaglia.com

MORAN RESIDENCE

1772 VALLEJO STREET SAN FRANCISCO, CA 94123

KEY NOTES

- 1 (N) WOOD RAILING
- 2 (N) STAIRS TO ROOF DECK
- 3 (N) SKYLIGHT AT HYPHEN
- (E) WINDOW TO REMAIN
- (E) BAY WINDOW

PROGRESS PRINT NOT FOR CONSTRUCTION

13 SEPT 2017


FLOOR PLAN

PROPOSED 4TH FLOOR


PROJ. NO. <u>2017-003</u> SCALE 1/4''=1'-0''20 JUNE 2017 DATE PHASE DRAWN <u>HA</u>

CHECKED <u>AW</u>

NO. DATE REVISION

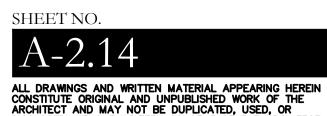



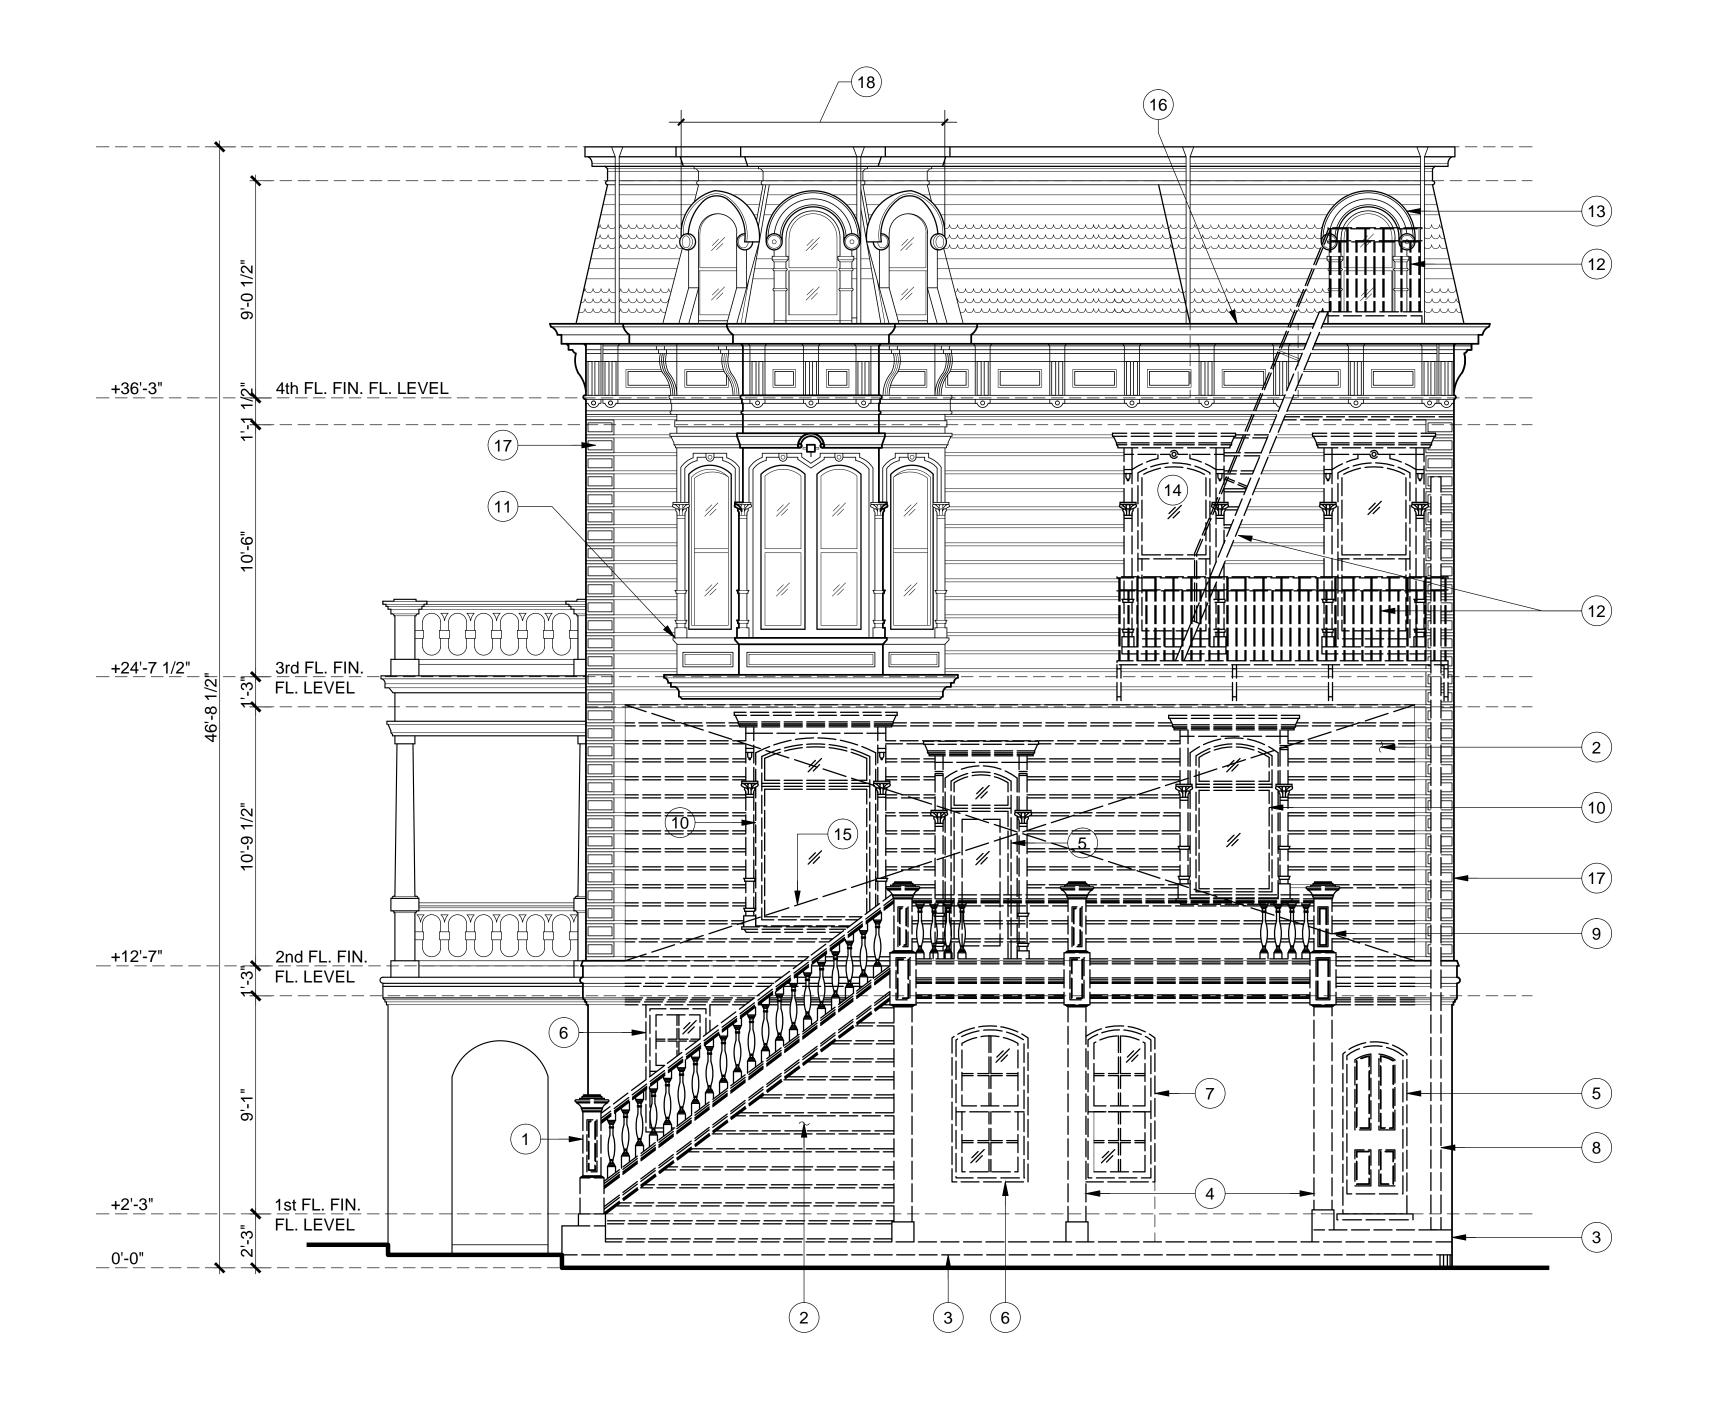





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KEY NOTES

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- 2 REMOVE (E) WALLS AT STORAGE ROOM.
- (3) REMOVE (E) CONC. STEPS, LANDING & PORCH FLOOR.
- (4) REMOVE & (E) WD. POSTS & TRIM.
- (5) REMOVE & (E) WD. DOOR, FRAME &
- 6 REMOVE & (E) WD. WINDOW, FRAME & TRIM.
- 7 ENLARGE (E) WINDOW OPENING TO ACCOMMODATE PROPOSED (N) DOOR.
- (8) REMOVE (E) "JOMY" FIRE ESCAPE LADDER.
- (9) REMOVE (E) REAR DECK.
- 10 REMOVE (E) WD. WINDOW, FRAME &
- (11) PROTECT (E) BAY WINDOW DURING ALL
- (12) REMOVE (E) FIRE ESCAPE & LADDER.
- (E) WD. WINDOW TO REMAIN. PROTECT IN PLACE.
- (14) REMOVE & SALVAGE (E) WINDOW AND STORE WHERE DIRECTED BY OWNER; REMOVE SILL OF OPENING FOR (N) DOORWAY.
- (15) CUT OPENING FOR CONNECTION TO (N) ADDITION.
- (16) (E) CORNICE AT MANSARD TO REMAIN, PROTECT IN PLACE DURING ALL WORK.
- (17) (E) QUOINS TO REMAIN. PROTECT IN PLACE.
- (18) (E) BAY WINDOW AT MANSARD TO REMAIN; PROTECT IN PLACE DURING ALL WORK.

EXTERIOR ELEVATION


DEMOLITION

PROJ. NO. 2017-003 SCALE 1/4''=1'-0''20 JUNE 2017 DATE PHASE SD

DRAWN HA CHECKED AW

REVISION NO. DATE 18 JUL 2017 PLANNING REVIEW 11 SEPT 2017 C.O.A. APPLICATION 24 DEC 2019 ARC REVIEW <u>12 FEB 2020</u> <u>UPDATE COA/311</u>

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MORAN RESIDENCE
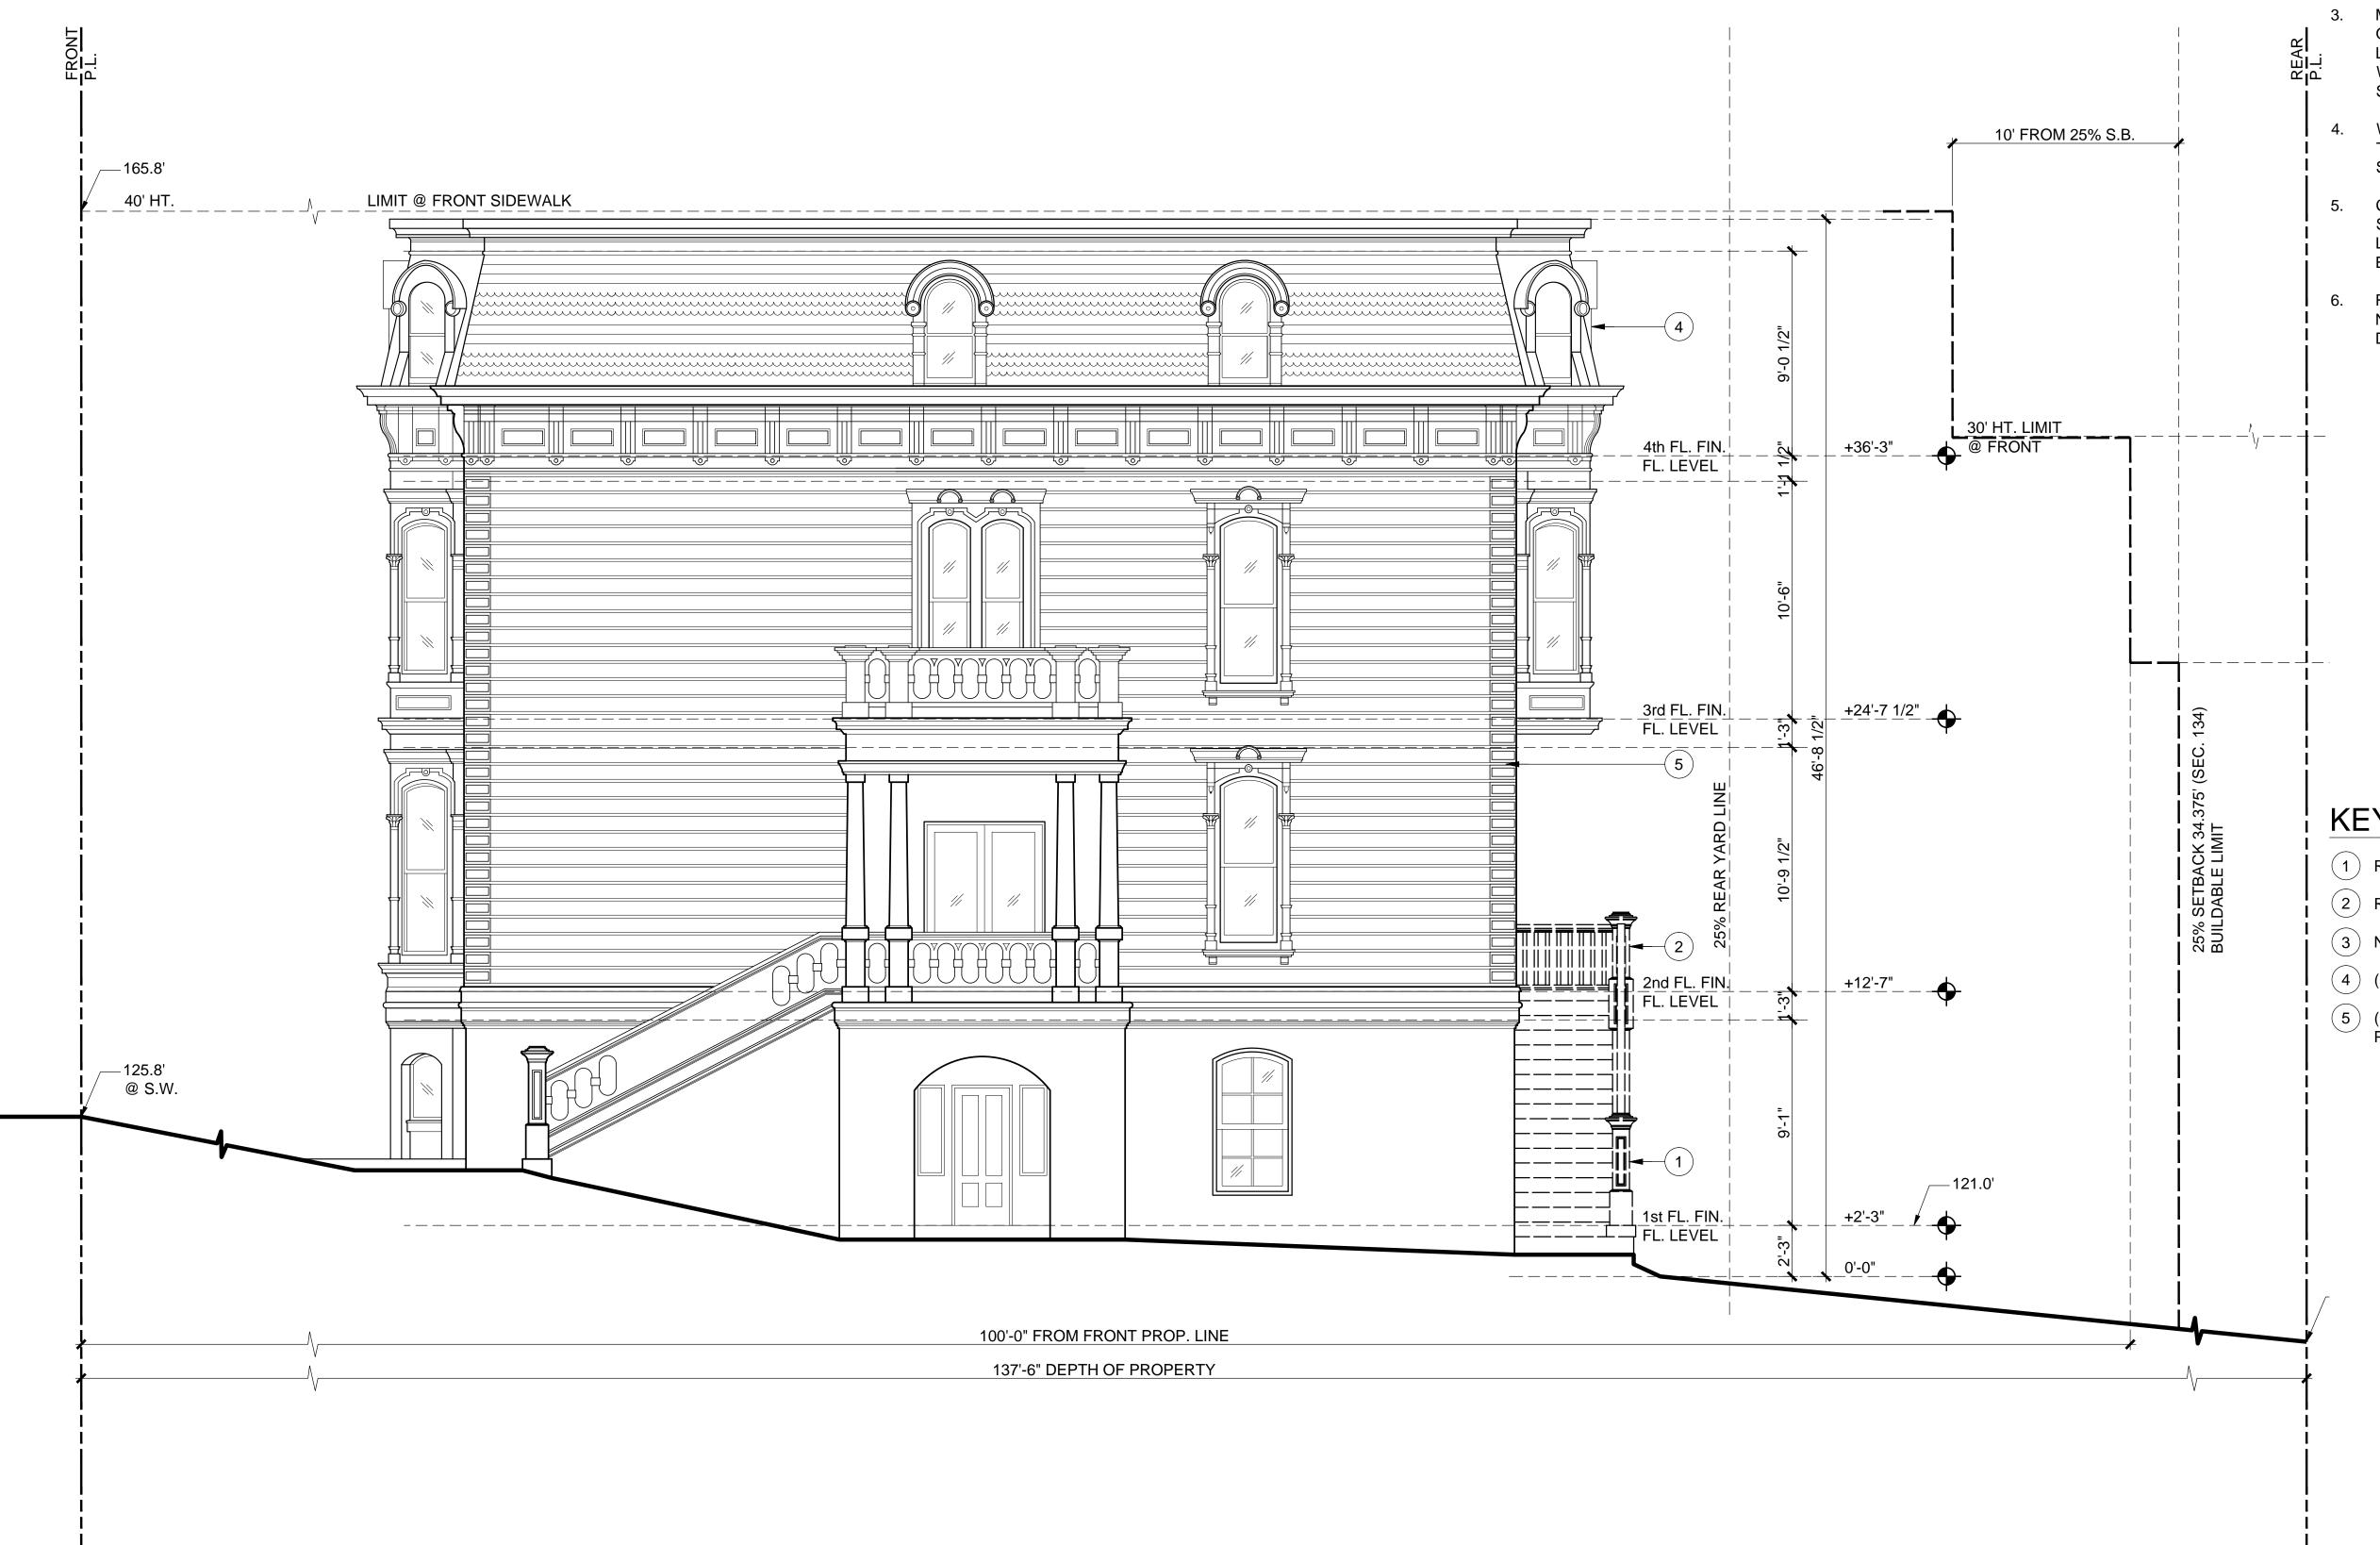
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KEY NOTES

- (1) REMOVE (E) STAIRS TO 2ND FLOOR.
- (2) REMOVE (E) REAR DECK.
- (3) NOT USED
- (4) (E) BAY WINDOW TO REMAIN.
- (5) (E) QUOINS TO REMAIN. PROTECT IN PLACE.

EXTERIOR ELEVATION


DEMOLITION

PROJ. NO. 2017-003 SCALE 1/4"=1'-0" 20 JUNE 2017 PHASE <u>SD</u> DRAWN HA

CHECKED AW

SHEET NO.



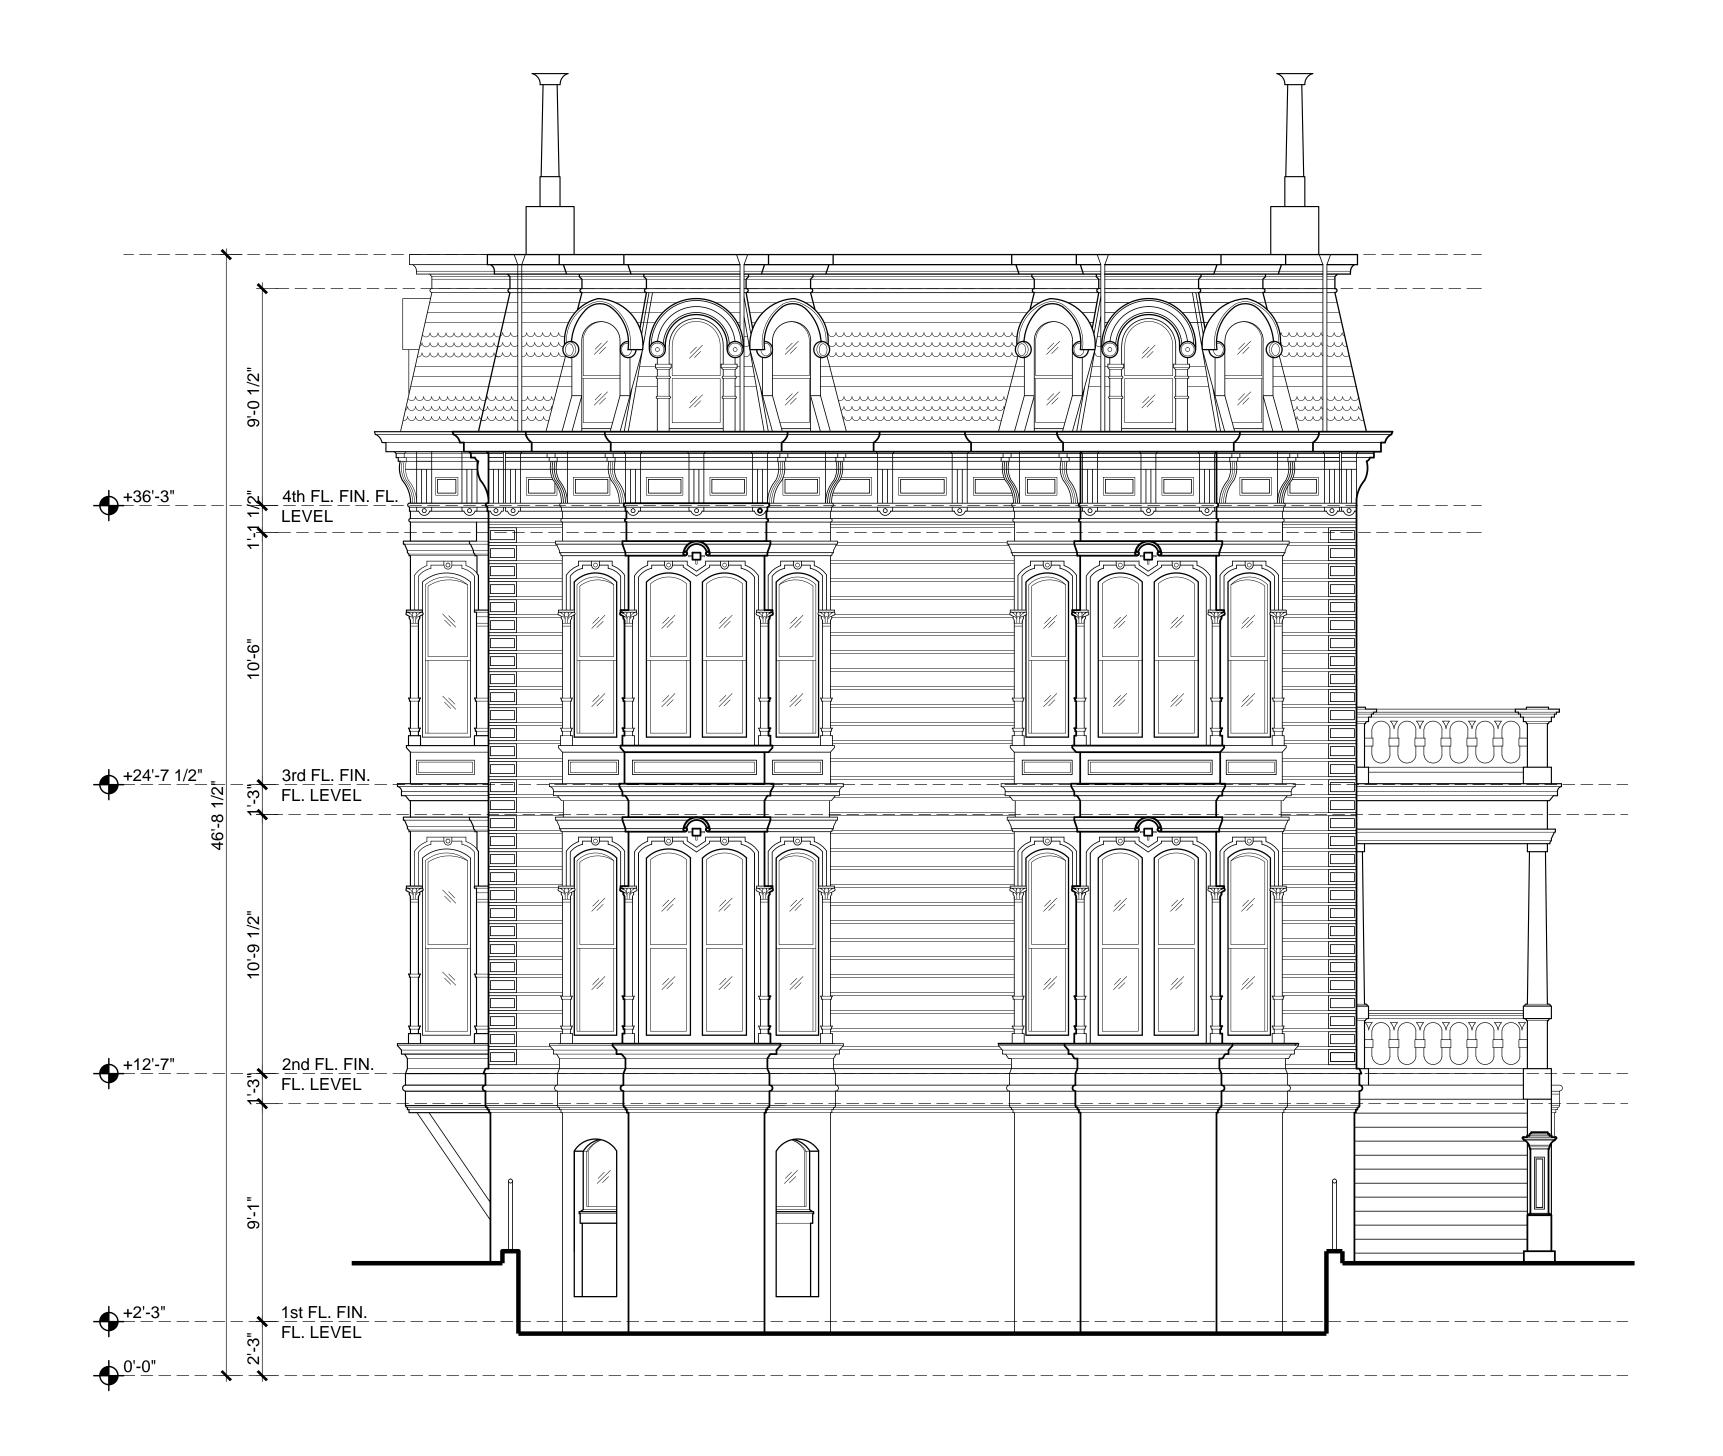





NO SHEET NOTES APPLICABLE TO THIS ELEVATION. ALL EXISTING ELEMENTS TO REMAIN IN PLACE.



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MORAN RESIDENCE

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KEY NOTES


1 NO KEY NOTES APPLICABLE TO THIS ELEVATION. ALL EXISTING ELEMENTS TO REMAIN IN PLACE.

EXTERIOR ELEVATION

EXISTING


PROJ. NO. <u>2017-003</u> SCALE 1/4"=1'-0"20 JUNE 2017 PHASE <u>SD</u> DRAWN <u>HA</u> CHECKED <u>AW</u>

NO. DATE	REVISION
18 JUL 2017	PLANNING REVIEW
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- 6. REFER TO ARCHITECTURAL GENERAL NOTES FOR ADDITIONAL DEMOLITION-SPECIFIC REQUIREMENTS.

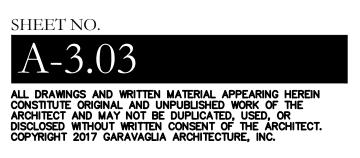

ARCHITECTURE

SAN FRANCISCO, CA 94104 T: 415.391.9633 F: 415.391.9647 www.garavaglia.com

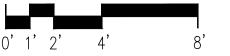MORAN RESIDENCE

1772 VALLEJO STREET SAN FRANCISCO, CA 94123

KEY NOTES


- (1) REMOVE (E) WALLS AT STORAGE ROOM.
- (2) REMOVE (E) CONC. STEPS, LANDING & PORCH FLOOR.
- (3) REMOVE (E) WD. POSTS & TRIM.
- (4) REMOVE (E) WD. DOOR, FRAME & TRIM.
- 5 REMOVE(E) "JOMY" FIRE ESCAPE LADDER
- (6) REMOVE (E) REAR DECK
- 7 REMOVE (E) FIRE ESCAPE & LADDER.
- 8 (E) QUOINS TO REMAIN. PROTECT IN PLACE.


EXTERIOR ELEVATION

DEMOLITION

PROJ. NO. 2017-003 SCALE 1/4"=1'-0" 20 JUNE 2017 PHASE SD DRAWN HA

CHECKED AW

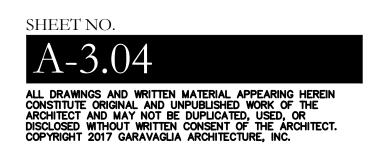

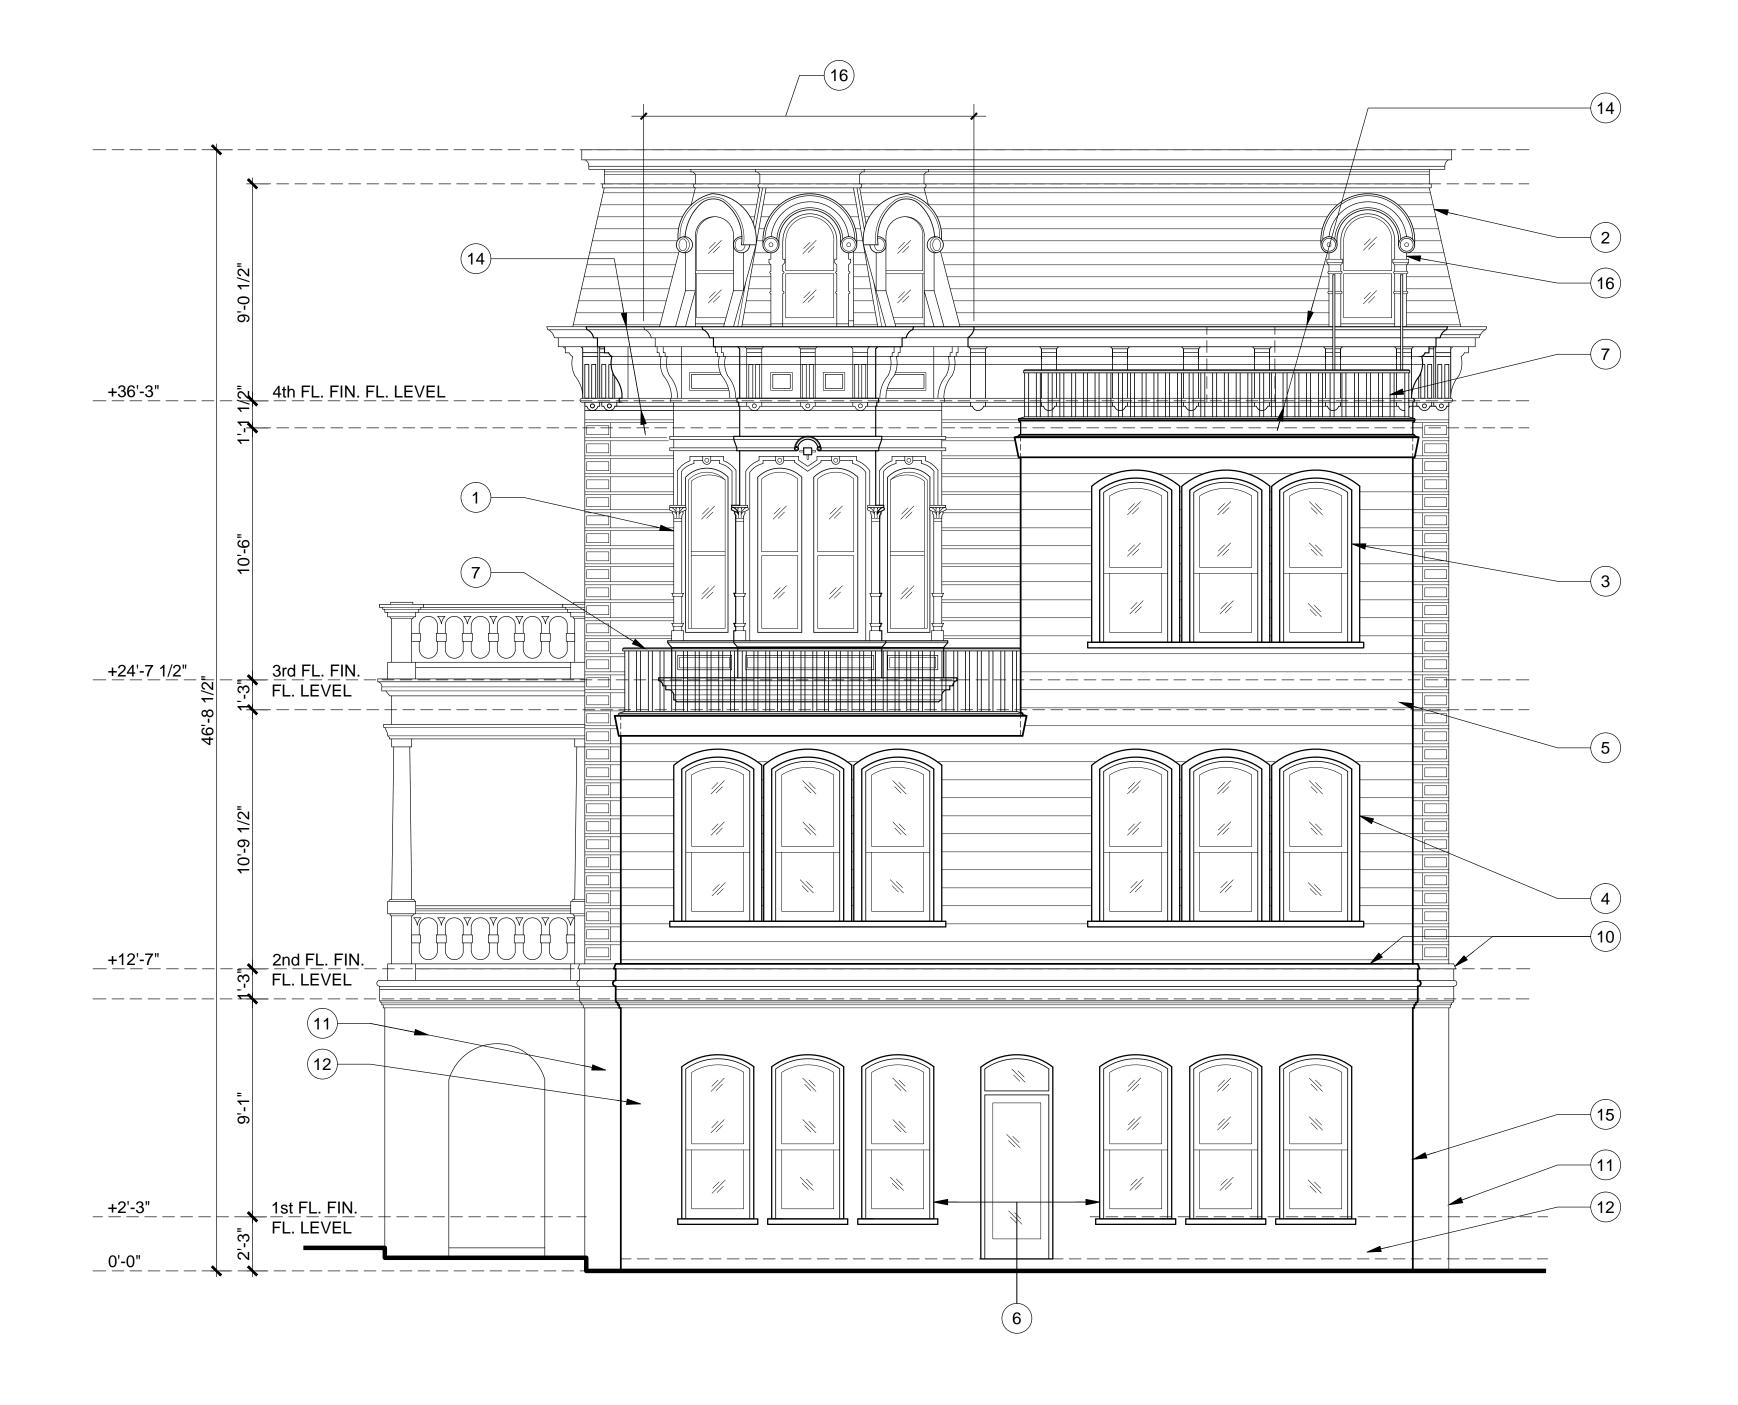





- 1. PROTECT IN PLACE ALL EXISTING (E) ELEMENTS TO REMAIN, TO PREVENT DAMAGE DURING WORK IN ADJACENT AREAS.
- 2. COORDINATE PROPOSED SCOPE OF WORK W/ ENGINEERING DRAWINGS FOR LOCATIONS OF (N) STRUCTURAL & OTHER BUILDING ELEMENTS.
- 3. ALL (E) HISTORIC WINDOWS & DOORS, TRIM & OTHER SIMILAR ELEMENTS THAT ARE TO REMAIN IN PLACE MUST BE PROTECTED FROM DAMAGE FOR THE DURATION OF CONSTRUCTION.
- 4. ALL SIDING & TRIM TO BE PRIMED AND PAINTED PER FINISH SCHEDULE WITH EXPOSED FOUNDATION TO BE PAINTED ADJACENT BODY COLOR.
- 5. FURNISH REQUIRED ATTIC VENTILATION, PER CBC SECTION 1203 IN LOCATIONS NOTED.



SUITE 1800 SAN FRANCISCO, CA 94104 T: 415.391.9633 F: 415.391.9647 www.garavaglia.com

MORAN RESIDENCE

1772 VALLEJO STREET SAN FRANCISCO, CA 94123

KEY NOTES

- (E) BAY WINDOW & CORNICE TO REMAIN; PROTECT IN PLACE
- (E) MANSARD ROOF ASSEMBLY TO ŘÉMAIN
- (N) WINDOWS TO BE ARCH TOP SIMILAR TO (E) HISTORIC
- (4) (N) WINDOW TRIM TO BE SIMILAR BUT WITH PLAIN PROFILE COMPARED TO (E) HISTORIC TRIM
- (5) (N) "V" RUSTICSIDING TO MATCH SPACING AND ALIGN w/ (E) CHANNEL **RUSTIC SIDING**
- 6 NO WINDOW TRIM AT CEMENT PLASTER OPENINGS
- 7 (N) TURNED WOOD BALUSTER RAILING
- 8 NOT USED
- 9 NOT USED
- (N) CORNICE TO ALIGN w/ (E) CORNICE
- (E) BRICK WALL
- (N) CEMENT PLASTER WALL FINISH AT ADDITION
- 13 NOT USED
- 14) PROTECT (E) CORNICE, TYPICAL
- (15) (N) TRASH/RECYCLE ROOM FIN. FLOOR LEVEL TO MATCH ADJACENT GRADE.
- (16) (E) WINDOW TO REMAIN




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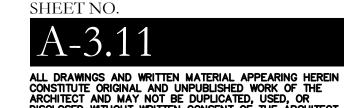
PROJ. NO. 2017-003 SCALE 1/4"=1'-0" 20 JUNE 2017 DATE


PHASE <u>SD</u> DRAWN <u>HA</u> CHECKED AW

REVISION NO. DATE 18 JUL 2017 PLANNING REVIEW 11 SEPT 2017 C.O.A. APPLICATION 24 DEC 2019 ARC REVIEW

<u>12 FEB 2020</u> UPDATE COA/311



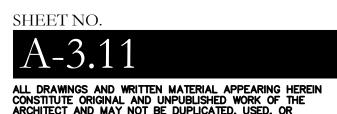

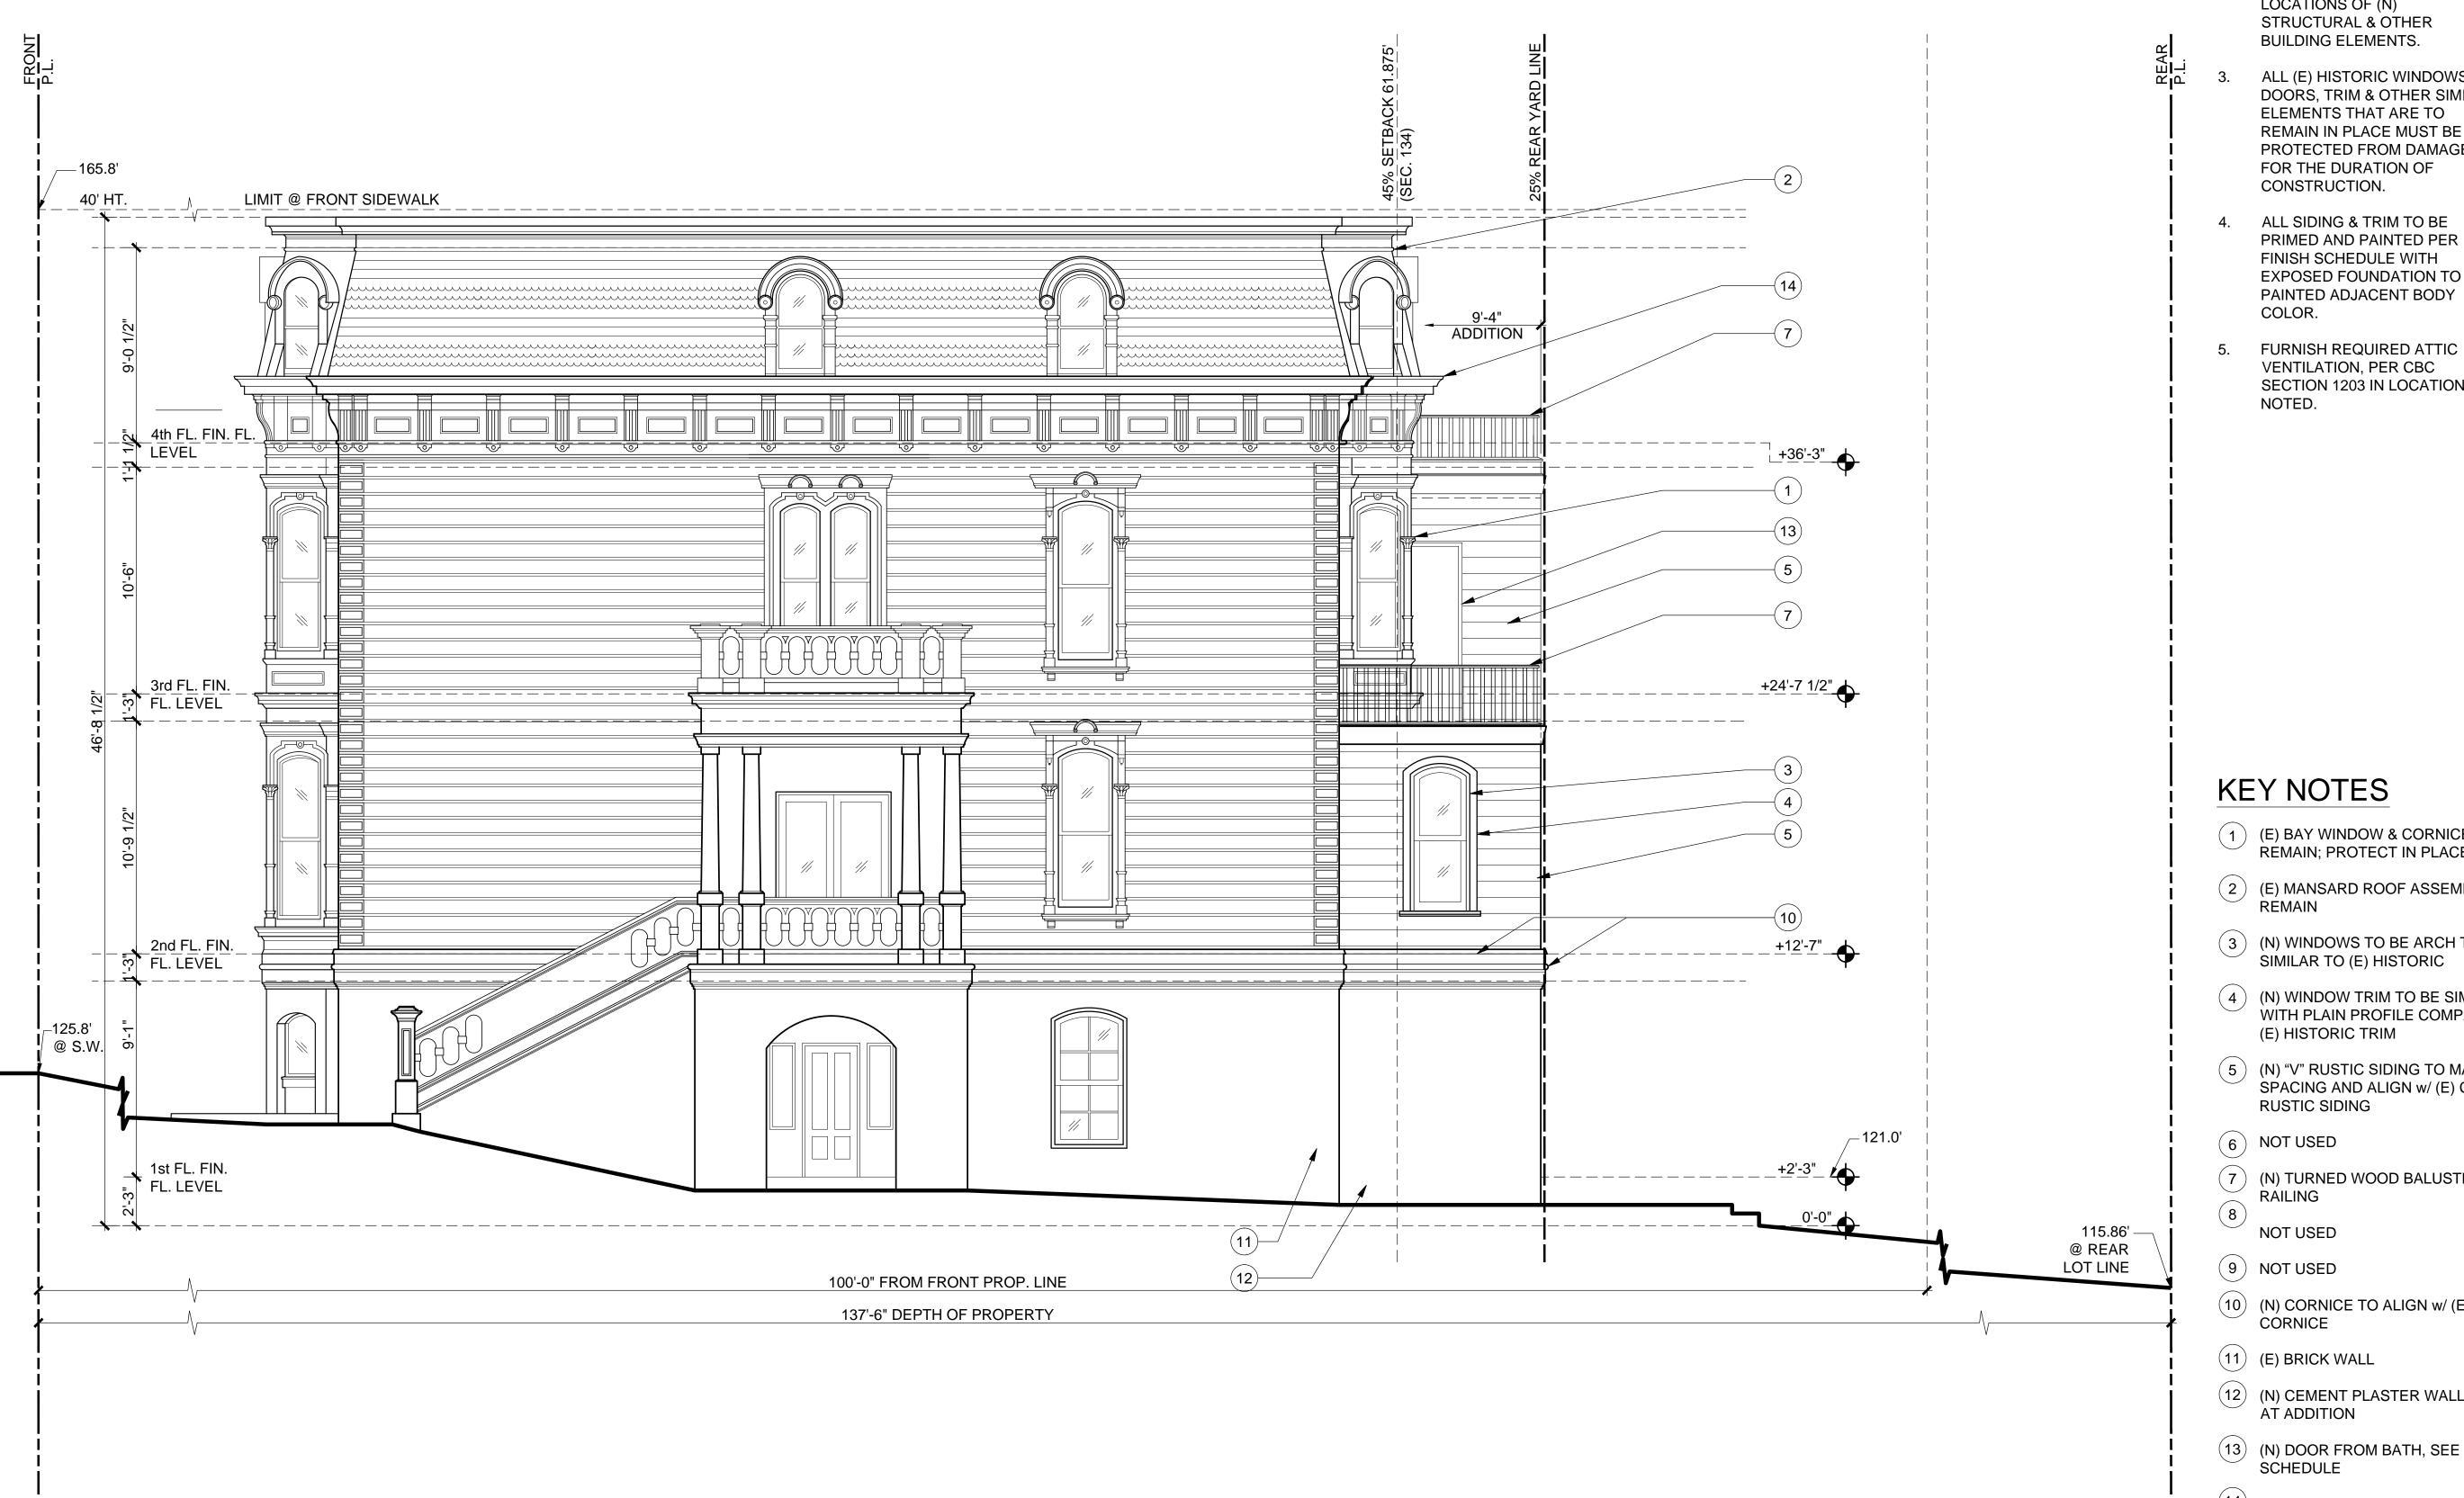

- 1. PROTECT IN PLACE ALL EXISTING (E) ELEMENTS TO REMAIN, TO PREVENT DAMAGE DURING WORK IN ADJACENT AREAS.
- 2. COORDINATE PROPOSED SCOPE OF WORK W/ ENGINEERING DRAWINGS FOR LOCATIONS OF (N) STRUCTURAL & OTHER BUILDING ELEMENTS.
- ALL (E) HISTORIC WINDOWS & DOORS, TRIM & OTHER SIMILAR ELEMENTS THAT ARE TO REMAIN IN PLACE MUST BE PROTECTED FROM DAMAGE FOR THE DURATION OF CONSTRUCTION.
- 4. ALL SIDING & TRIM TO BE PRIMED AND PAINTED PER FINISH SCHEDULE WITH **EXPOSED FOUNDATION TO BE** PAINTED ADJACENT BODY COLOR.

VENTILATION, PER CBC

NOTED.

SECTION 1203 IN LOCATIONS



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MORAN RESIDENCE

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KEY NOTES


- (E) BAY WINDOW & CORNICE TO RÉMAIN: PROTECT IN PLACE
- (2) (E) MANSARD ROOF ASSEMBLY TO RÉMAIN
- (3) (N) WINDOWS TO BE ARCH TOP SIMILAR TO (E) HISTORIC
- (4) (N) WINDOW TRIM TO BE SIMILAR BUT WITH PLAIN PROFILE COMPARED TO (E) HISTORIC TRIM
- (5) (N) "V" RUSTIC SIDING TO MATCH SPACING AND ALIGN w/ (E) CHANNEL RUSTIC SIDING
- 6 NOT USED
- 7 (N) TURNED WOOD BALUSTER
- RAILING
- NOT USED
- (9) NOT USED
- (N) CORNICE TO ALIGN w/ (E) CORNICE
- (11) (E) BRICK WALL
- (N) CEMENT PLASTER WALL FINISH AT ADDITION
- (13) (N) DOOR FROM BATH, SEE SCHEDULE
- (14) PROTECT (E) CORNICE, TYPICAL

EXTERIOR ELEVATION


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PROJ. NO. 2017-003 SCALE 1/4"=1'-0" 20 JUNE 2017 DATE PHASE SD DRAWN HA


CHECKED AW REVISION NO. DATE



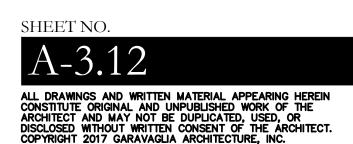



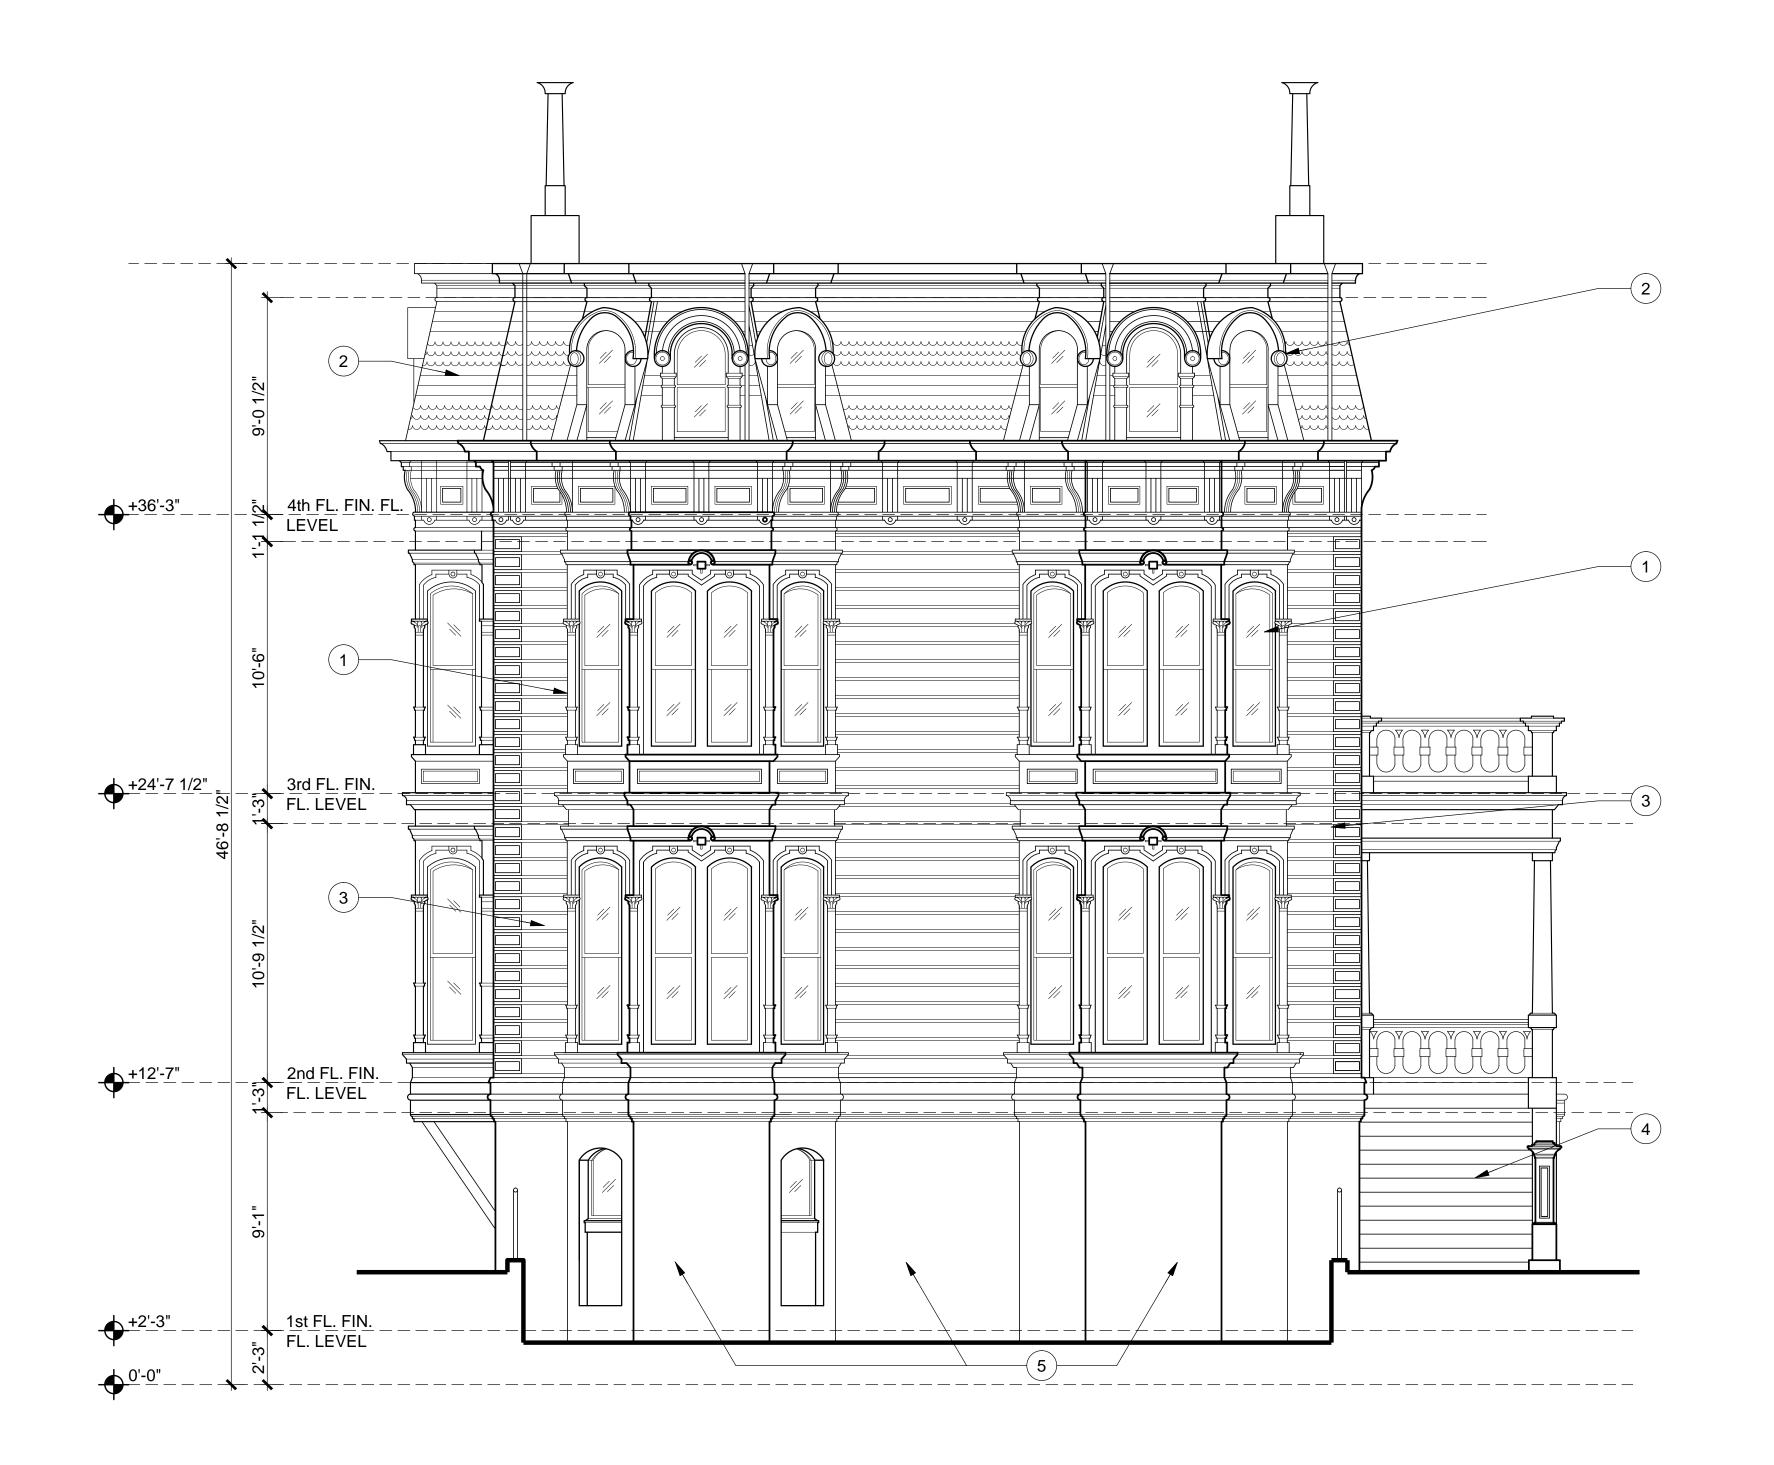

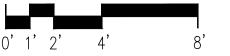

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KEY NOTES


- 1 (E) BAY WINDOW
- (E) MANSARD ROOF ASSEMBLY TO REMAIN
- 3 (E) SIDING
- 4 (E) ENTRY STAIRS
- 5 (E) BRICK WALL


EXTERIOR ELEVATION

PROPOSED

PROJ. NO. <u>2017-003</u> SCALE 1/4''=1'-0''20 JUNE 2017 PHASE <u>SD</u> DRAWN <u>HA</u> CHECKED <u>AW</u>

NO. DATE	REVISION
18 JUL 2017	PLANNING REVIEW
11 SEPT 2017	C.O.A. APPLICATION
24 DEC 2019	ARC REVIEW
12 FEB 2020	UPDATE COA/311

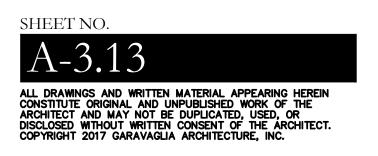

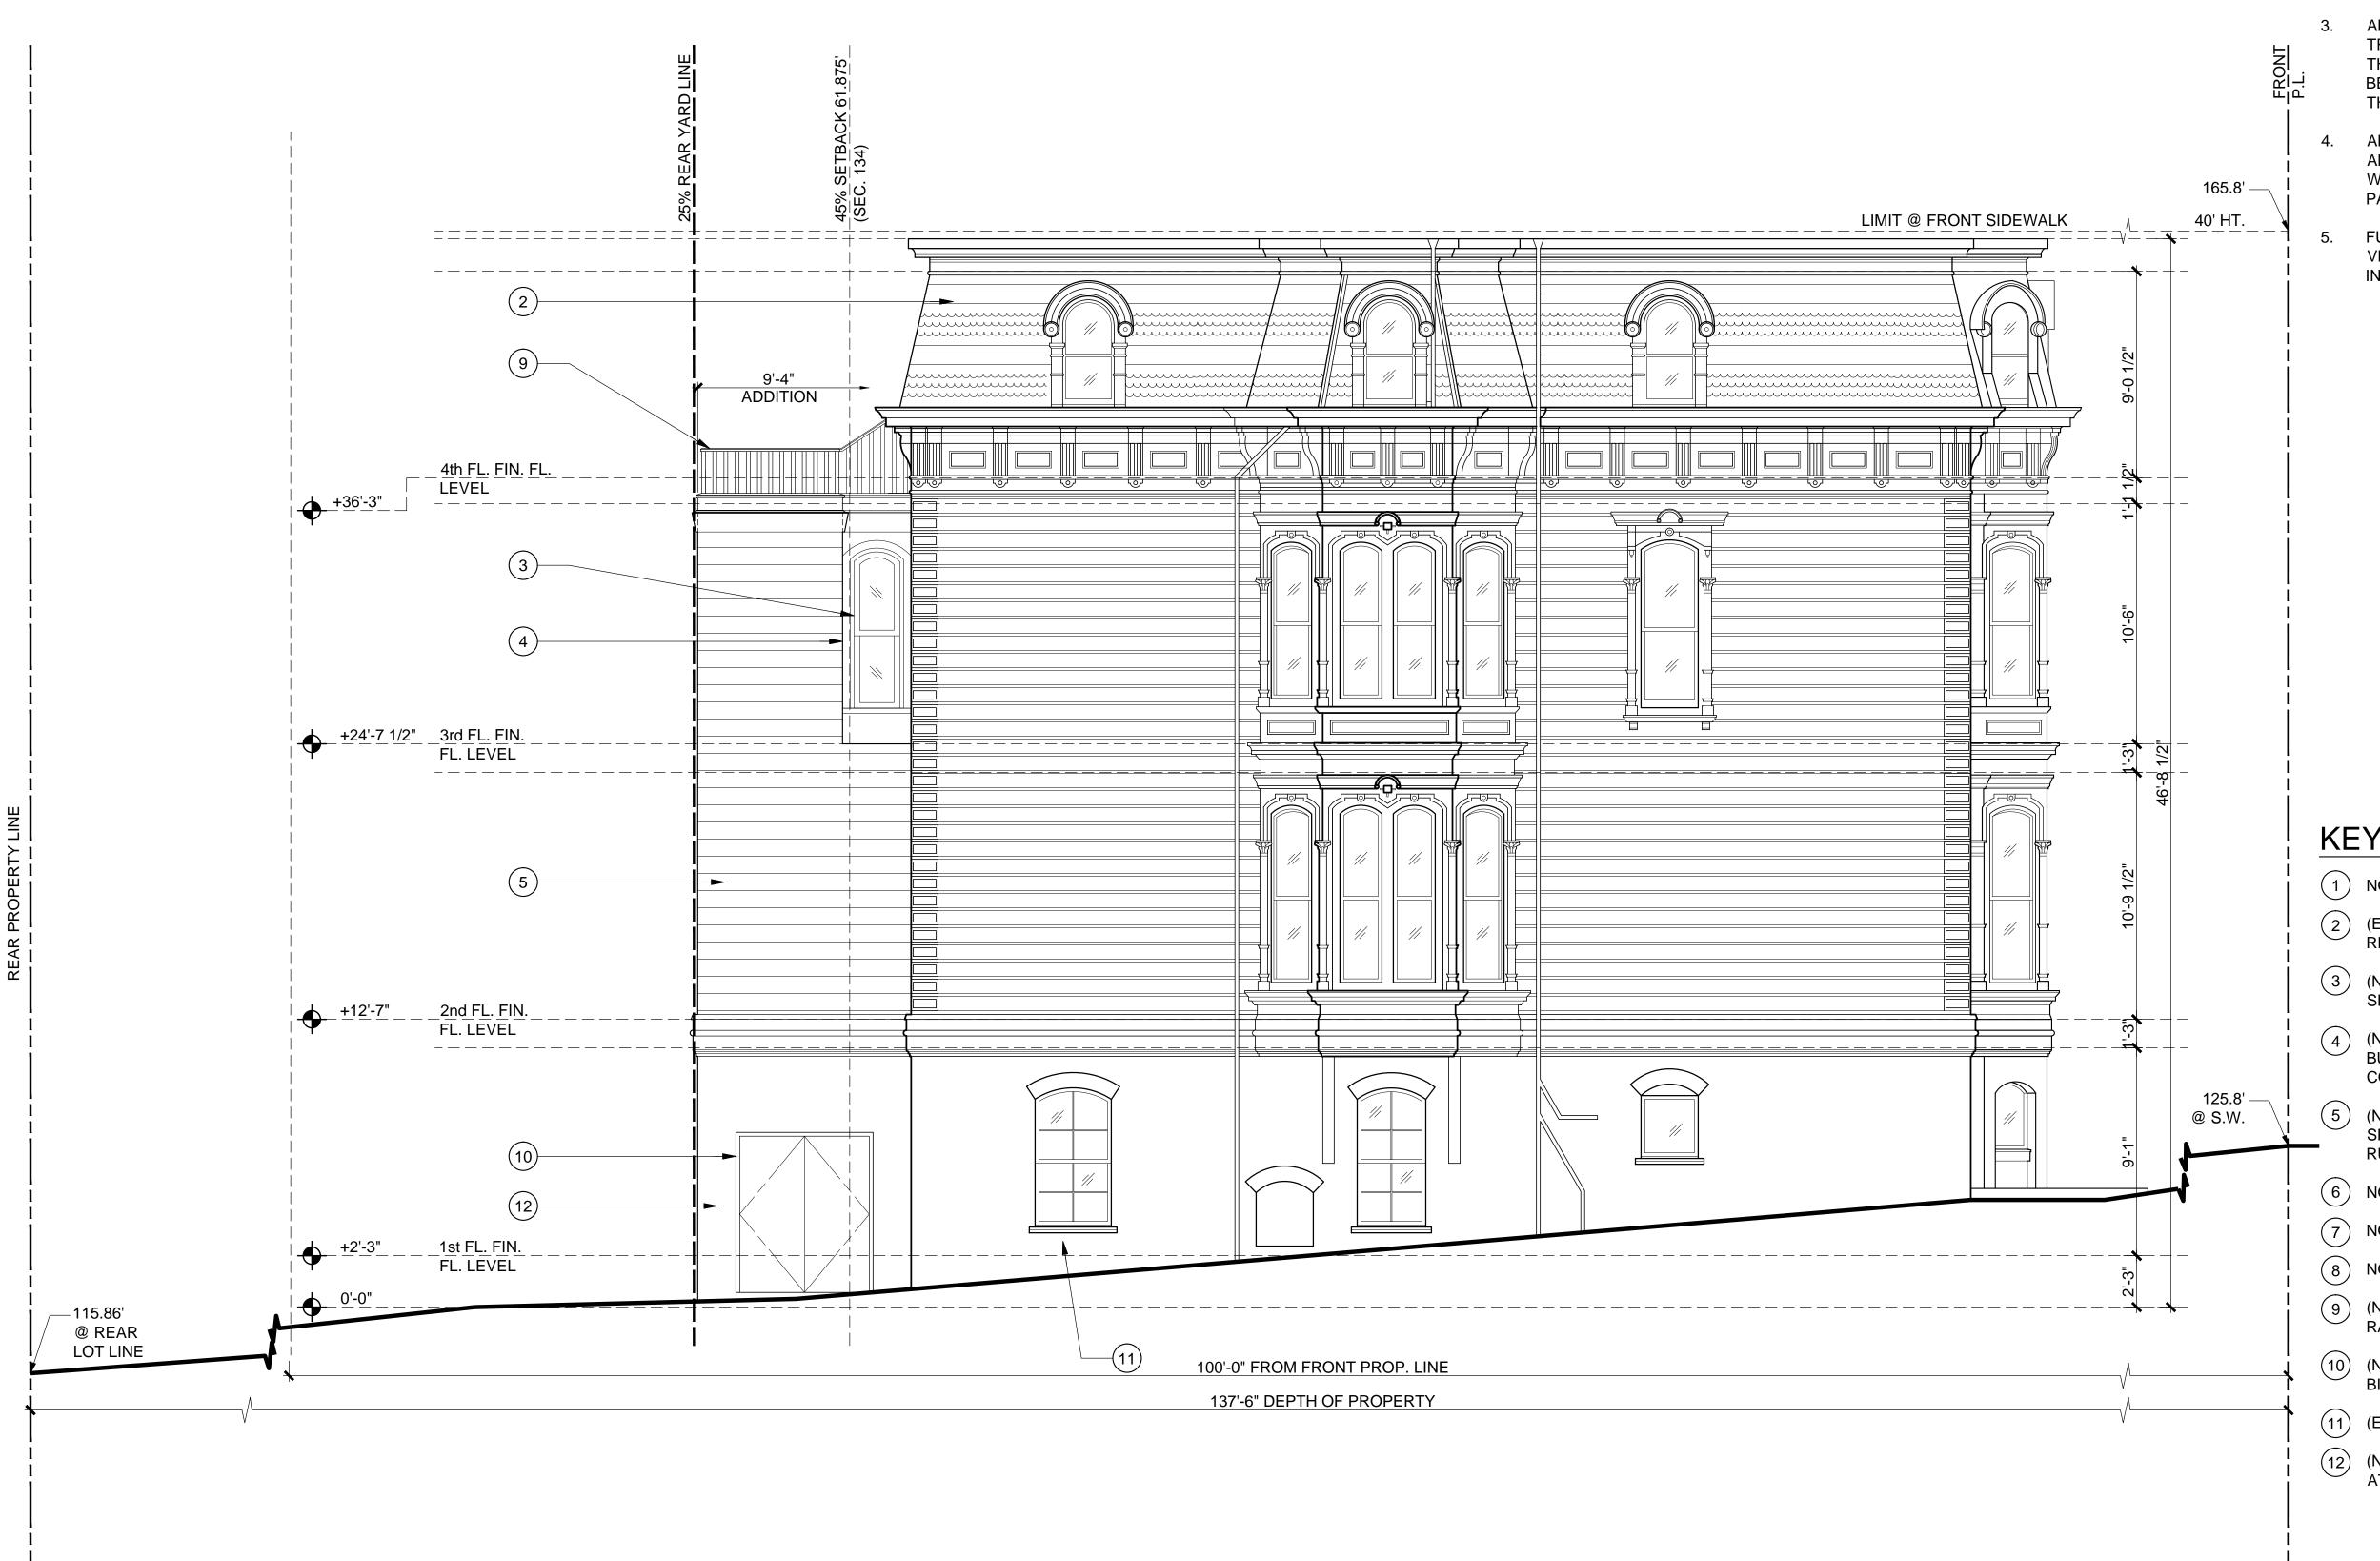

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ARCHITECTURE

582 MARKET STREET SUITE 1800 SAN FRANCISCO, CA 94104 T: 415.391.9633 F: 415.391.9647 www.garavaglia.com

MORAN RESIDENCE

1772 VALLEJO STREET SAN FRANCISCO, CA 94123

KEY NOTES

- 1 NOT USED
- (E) MANSARD ROOF ASSEMBLY TO
- (N) WINDOWS TO BE ARCH TOP SIMILAR TO (E) HISTORIC
- (N) WINDOW TRIM TO BE SIMILAR
 BUT WITH PLAIN PROFILE
 COMPARED TO (E) HISTORIC TRIM
- (N) "V" RUSTIC SIDING TO MATCH SPACING AND ALIGN w/ (E) CHANNEL RUSTIC SIDING
- 6 NOT USED
- 7 NOT USED
- 8 NOT USED
- 9 (N) TURNED WOOD BALUSTER RAILING
- (N) DOORS TO TRASH / RECYCLING BIN ENCLOSURE
- (11) (E) BRICK WALL
- (N) CEMENT PLASTER WALL FINISH AT ADDITION

EXTERIOR ELEVATION

PROPOSED

PROJ. NO. 2017-003
SCALE 1/4"=1'-0"
DATE 20 JUNE 2017
PHASE

DRAWN <u>HA</u> CHECKED <u>AW</u>

NO. DATE REVISION


18 JUL 2017 PLANNING REVIEW

 11 SEPT 2017
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 24 DEC 2019
 ARC REVIEW

 12 FEB 2020
 UPDATE COA/311

SHEET NO.

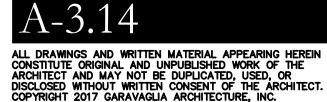


SCALE: 1/4" = 1'-0"



582 MARKET STREET
SUITE 1800
SAN FRANCISCO, CA 94104
T: 415.391.9633
F: 415.391.9647 www.garavaglia.com

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KEY NOTES

PROGRESS PRINT NOT FOR CONSTRUCTION 13 SEPT 2017

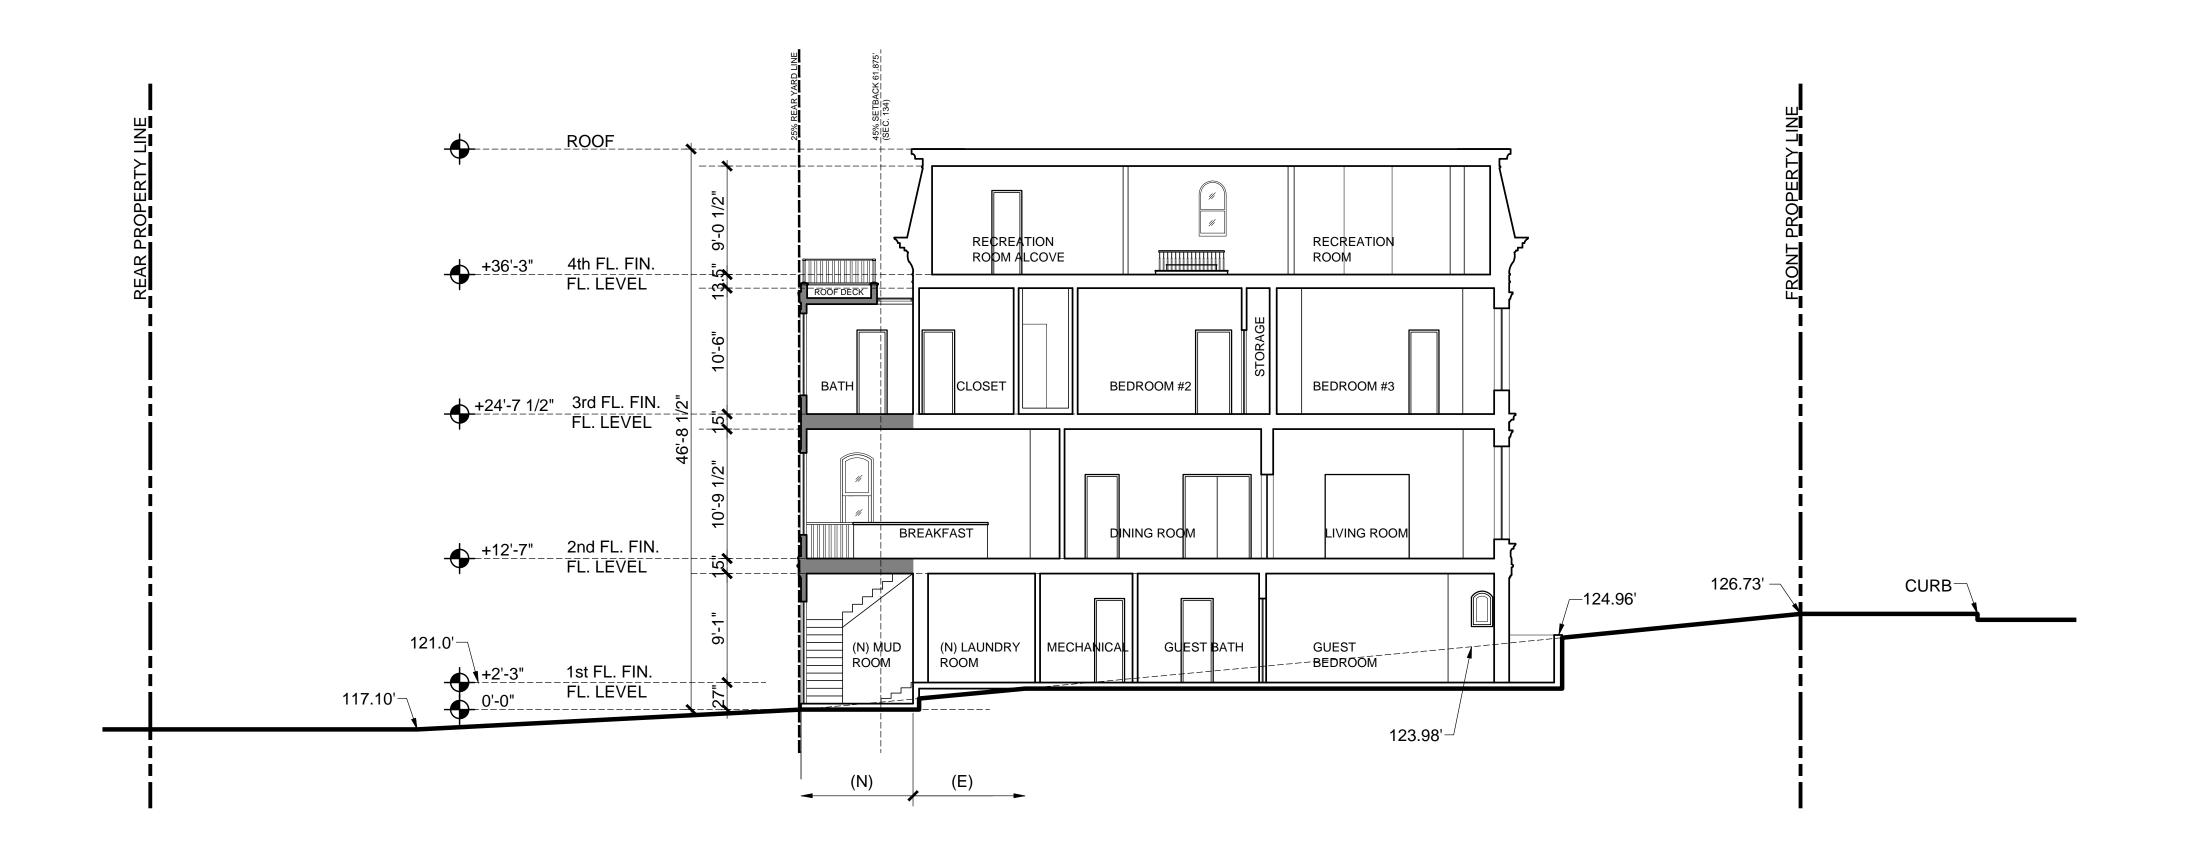BUILDING SECTION

PROPOSED


PROJ. NO. <u>2017-003</u> SCALE <u>AS NOTED</u> DATE <u>8 FEB 2017</u> PHASE <u>SD</u> DRAWN <u>HA</u> CHECKED <u>AW</u>


NO. DATE REVISION


18 JUL 2017 PLANNING REVIEW 11 SEPT 2017 C.O.A. APPLICATION 24 DEC 2019 ARC REVIEW <u>12 FEB 2020</u> <u>UPDATE COA/311</u>



SECTION

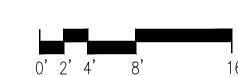

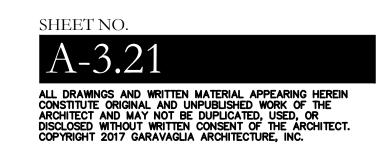

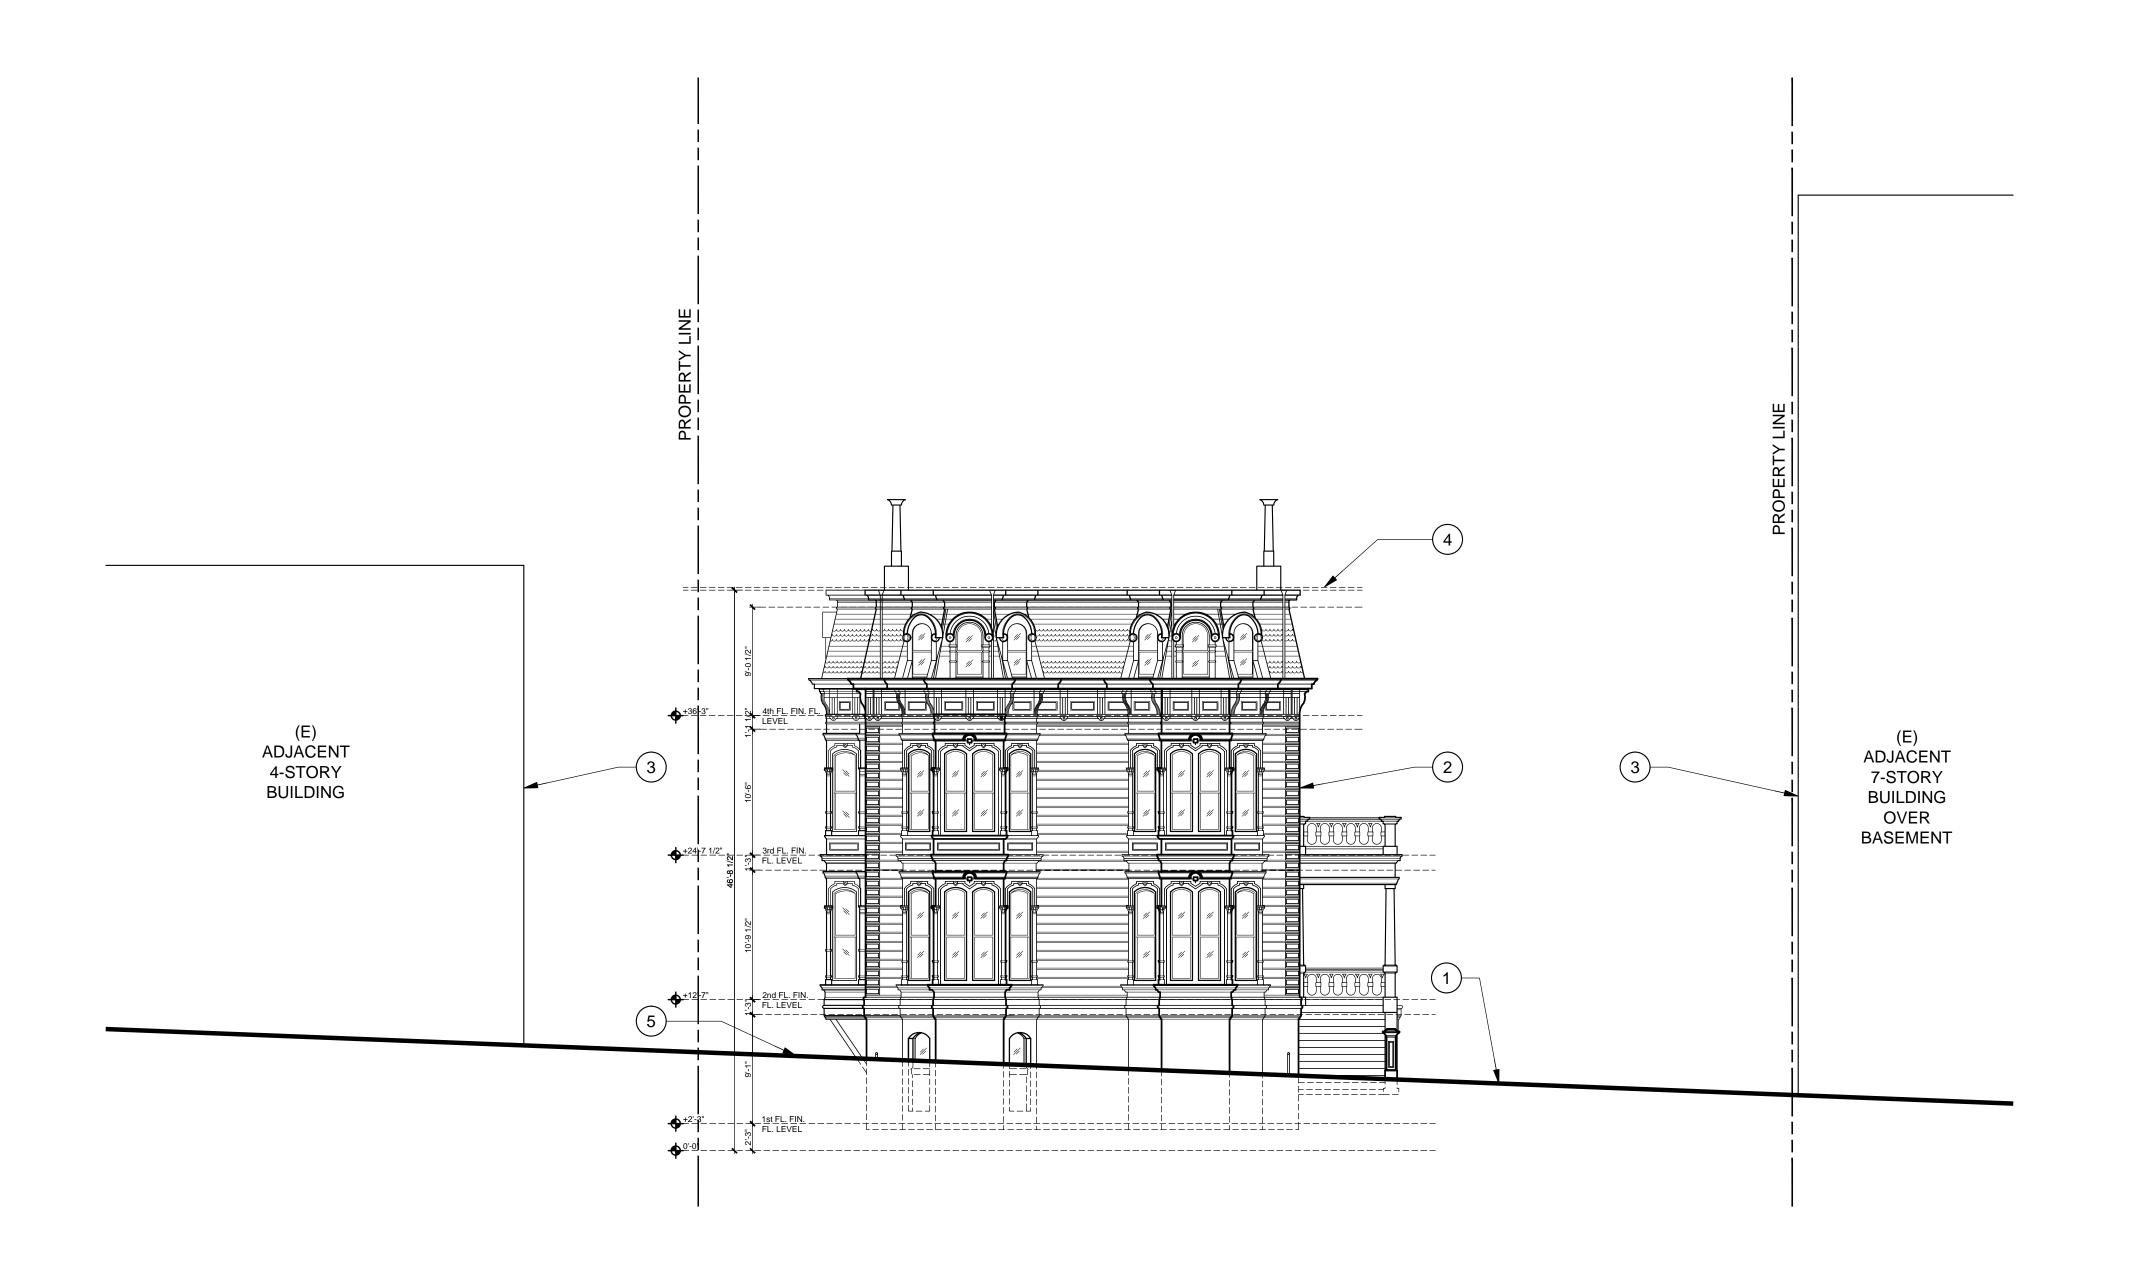

STREET ELEVATION



SHEET NOTES

1. HEIGHTS OF (E) ADJACENT BUILDINGS SHOWN ARE APPROXIMATE BASED ON AVAILABLE INFORMATION, NEITHER WERE NOT FIELD MEASURED



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KEY NOTES

- 1 LINE OF (E) SIDEWALK
- (E) PROJECT BUILDING
- (E) ADJACENT NEIGHBOR BUILDING
- 4 LINE OF 40' HEIGHT LIMIT AS MEASURED AT FRONT PROPERTY LINE
- 5 (E) DRIVEWAY ACCESS

STREET ELEVATION

PROJ. NO. <u>2017-003</u> SCALE AS NOTED DATE <u>05 MAR 2020</u> <u>PLANNING</u> PHASE DRAWN <u>FP</u>

CHECKED

NO. DATE REVISION

