

SAN FRANCISCO PLANNING DEPARTMENT

Certificate of Appropriateness Case Report

HEARING DATE: JANUARY 17, 2018

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| Filing Date: | August 2, 2017 |
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| Case No.: | 2017-007097COA |
| Project Address: | 3639 20th Street |
| Historic Landmark: | Liberty-Hill Landmark District |
| Zoning: | RH-3 (Residential-House, Three Family) |
| | 40-X Height and Bulk District |
| Block/Lot: | 3608 / 068 |
| Applicant: | Blake Evans |
| | Martinkovic Milford Architects |
| | 101 Montgomery Street, Suite 650 |
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PROPERTY DESCRIPTION

3639 20th STREET is a contributing building within the Liberty-Hill Landmark District. The subject property is located on the south side of 20th Street between Guerrero and Valencia Streets, on Assessor's Block 3608, Lot 068. The property's lot has approximately 25 feet of frontage on 20th Street, and is 115 feet deep. 3639 20th Street was constructed in 1895 by architect Charles J. Devlin. The property's facade was substantially altered in 1939. The subject property is a two-story over high-basement, wood-frame, twofamily altered Queen Anne-style residence. The Liberty-Hill Landmark District was designated in 1985.

PROJECT DESCRIPTION

The proposed project is to remove a portion of the existing gabled roof at the rear of the building; replace the historic window sashes at the 20th Street facade in kind; replace the non-historic garage door and secondary entrance door at the 20th Street façade; modify existing window and door openings at the side and rear elevations; install new skylights; remove a non-historic rear deck; modify the rear yard landscaping; and related interior alterations. Specifically, the proposal includes:

- Removal of the rear 9'-9" portion of the existing gabled roof at the rear of the building at the attic • level only, to accommodate the construction of a new rear roof deck at the attic level.
- In-kind replacement of nine (9) one-over-one single-hung offset wood window sashes with shorter upper sashes at the 20th Street façade.

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- In-kind replacement of the non-historic garage door and non-historic recessed secondary basement-level entrance door at the 20th Street façade.
- Modifications to existing window and door openings at the non-visible side and rear elevations, including the following:
 - At the east side elevation, expansion of two (2) existing window openings at the east light well at the first and second floors to install fixed wood single-lite windows; and the creation of one (1) new window opening with a wood one-over-one slider unit at the basement level at the south end of the east elevation.
 - At the rear south elevation, modifications to all existing window and door openings to allow for the installation of one (1) set of paired wood sliding glazed doors and one (1) one-over-one double-hung wood window at the first floor; one (1) wood window assembly consisting of fixed and awning windows, one (1) single-lite wood awning window, and one (1) dryer vent at the second floor; and one (1) set of paired wood sliding glazed doors at the attic level.
 - At the west side elevation, removal of two (2) existing window openings.

For all modifications to existing window and door openings, the maximum possible amount of historic painted wood siding will be retained around the openings, and any necessary new siding will match the historic painted wood siding in terms of materials, dimensions, and profiles.

- Installation of six (6) new skylights at the rear portion of the roof, to be mounted low to the roof with frames painted to match the surrounding roof cladding.
- Removal of the existing non-historic wood deck at the first floor at the rear elevation.
- Modifications to the existing rear yard, including excavation of approximately 262 square feet (851.5 cubic feet) of soil at the rear yard to support the creation of two terraces at the rear yard; replacement of an existing non-historic concrete staircase leading from the basement level to the rear yard with a new concrete stair; the construction of a second concrete stair to lead to the new upper terrace in the rear yard; the installation of a stucco retaining wall topped with a 42-inch-tall guardrail separating the lower terrace from the upper terrace; and the installation of a new perimeter fence around the rear yard.
- Interior alterations at all floors related to the remodeling of the interior spaces, while maintaining the current unit count.

Please see photographs and plans for details.

OTHER ACTIONS REQUIRED

None.

COMPLIANCE WITH THE PLANNING CODE PROVISIONS

The proposed project is in compliance with all other provisions of the Planning Code.

APPLICABLE PRESERVATION STANDARDS

ARTICLE 10

Pursuant to Section 1006.2 of the Planning Code, unless exempt from the Certificate of Appropriateness requirements or delegated to Planning Department Preservation staff through the Administrative Certificate Appropriateness process, the Historic Preservation Commission is required to review any applications for the construction, alteration, removal, or demolition of any designated Landmark for which a City permit is required. Section 1006.6 states that in evaluating a request for a Certificate of Appropriateness for an individual landmark or a contributing building within a historic district, the Historic Preservation Commission must find that the proposed work is in compliance with the *Secretary of the Interior's Standards for the Treatment of Historic Properties*, as well as the designating Ordinance and any applicable guidelines, local interpretations, bulletins, related appendices, or other policies.

Article 10, Appendix F–Liberty-Hill Landmark District

In reviewing an application for a Certificate of Appropriateness, the Historic Preservation Commission must consider whether the proposed work would be compatible with the character of the Liberty-Hill Landmark District as described in Appendix F of Article 10 of the Planning Code. Per Appendix F of Article 10, the character of the Landmark District shall mean the exterior architectural features of the Liberty-Hill Landmark District.

THE SECRETARY OF THE INTERIOR'S STANDARDS

Rehabilitation is the act or process of making possible a compatible use for a property through repair, alterations, and additions while preserving those portions or features that convey its historical, cultural, or architectural values. The Rehabilitation Standards provide, in relevant part(s):

Standard 1: A property shall be used for its historic purpose or be placed in a new use that requires minimal change to the defining characteristics of the building and its site and environment.

The proposed project does not involve a change in use of the property. Therefore, the proposed project complies with Rehabilitation Standard 1.

Standard 2: The historic character of a property shall be retained and preserved. The removal of historic materials or alteration of features and spaces that characterize a property shall be avoided.

While the proposed project involves the removal of a 9'-9" portion of the historic roof, the area of the roof to be removed is at the rear of the building, and will not constitute a significant alteration of the features or spaces of the historic building. The roof is not unusual in its form or construction, and will appear unchanged when viewed from a public right-of-way. The proposed project also includes the replacement of all of the historic one-over-one single-hung wood window sashes at the 20th Street facade. While these window sashes are a character-defining feature of the building, they will be replaced in kind with new wood sashes matching the materials, details,

configuration, and operation of the historic sashes. The historic window frames and brick molding will remain.

The replacement of the non-historic garage door and secondary basement-level entrance at the 20th Street facade; changes to window and door openings at the rear and side elevations; addition of skylights at the roof; removal of a non-historic rear deck; modifications to the rear yard landscaping; and interior alterations will not remove character-defining features of the building. With the exception of the in-kind replacement of the non-historic garage and secondary entrance doors at the 20th Street façade, this additional work will not be visible from a public right-of-way, and will not alter the features or spaces that characterize the property. Therefore, the proposed project complies with Rehabilitation Standard 2.

Standard 3: Each property will be recognized as a physical record of its time, place and use. Changes that create a false sense of historical development, such as adding conjectural features or architectural elements from other buildings, shall not be undertaken.

The proposed project does not include the addition of conjectural elements or architectural features from other buildings. Therefore, the proposed project complies with Rehabilitation Standard 3.

Standard 4: Most properties change over time; those changes that have acquired historic significance in their own right shall be retained and preserved.

The proposed project does not involve alterations to changes to the property that have acquired significance in their own right. Therefore, the proposed project complies with Rehabilitation Standard 4.

Standard 5: Distinctive features, finishes, and construction techniques or examples of fine craftsmanship that characterize a property will be preserved.

The 9'-9" portion of the roof to be removed does not exhibit any distinctive features, finishes, or construction techniques, and will appear unchanged when viewed from a public right-of-way. Although the historic window sashes at the 20th Street facade to be replaced in kind are character-defining features of the building, they are not distinctive in their features or construction, as they consist of simple one-over-one single-hung windows. None of the other proposed work will destroy distinctive features of the property. Therefore, the proposed project complies with Rehabilitation Standard 5.

Standard 6: Deteriorated historic features will be repaired rather than replaced. Where the severity of deterioration requires replacements of a distinctive feature, the new feature will match the old in design, color, texture and other visual qualities and, where possible, materials. Replacement of missing features shall be substantiated by documentary, physical, or pictorial evidence.

The proposed project calls for the replacement of the historic window sashes at the 20th Street facade. While historic, these window sashes are not distinctive in their detailing or construction methods, and will be replaced with new sashes matching the historic sashes in terms of their material, design, and operation. The project also calls for the replacement of wood siding at the side and rear elevations that is too deteriorated to be repaired, as well as the installation of new wood siding matching the historic wood siding at select locations where window and door openings are being altered. The project does not include the replacement of any missing features at the building. Therefore, the proposed project complies with Rehabilitation Standard 6.

Standard 7: Chemical or physical treatments, such as sandblasting, that cause damage to historic materials shall not be used. The surface cleaning of structures, if appropriate, shall be undertaken using the gentlest means possible.

The proposed project would not involve chemical or physical treatments that would cause damage to historic materials. Therefore, the proposed project complies with Rehabilitation Standard 7.

Standard 8: Significant archaeological resources affected by a project shall be protected and preserved. If such resources must be disturbed, mitigation measures will be undertaken.

While the proposed project does include limited excavation at the rear yard, the property is not in an archaeologically sensitive area, and the amount of excavation is not significant enough to require additional environmental review per CEQA requirements. Therefore, the proposed project complies with Rehabilitation Standard 8.

Standard 9: New additions, exterior alterations, or related new construction will not destroy historic materials, features, and spatial relationships that characterize the property. The new work will be differentiated from the old and will be compatible with the historic materials, features, size, scale and proportion, and massing to protect the integrity of the property and its environment.

The proposed project will not destroy historic materials, features, or spatial relationships that characterize the property. Although the proposed removal of a rear portion of the roof will alter this historic feature of the building, the 9'-9" portion of roof to be removed does not display any distinctive characteristics, and is not visible from a public right-of-way. The new roof deck to be created by the removal of the rear portion of the roof will be simple in design, will be located within the historic footprint of the building, and will not be visible from a public right-of-way. The proposed new window and door openings at the rear and side elevations will be compatible with the property's historic windows though their shared material, but will be differentiated by their details and configuration from the historic windows. Therefore, the proposed project complies with Rehabilitation Standard 9.

Standard 10: New additions and adjacent or related new construction shall be undertaken in such a manner that if removed in the future, the essential form and integrity of the historic property and its environment would be unimpaired.

The proposed project would not affect the essential form and integrity of the building. The work visible from a public right-of-way is limited to the in-kind replacement of the historic window sashes and non-historic garage door and secondary entrance door at the 20th Street facade. Although a rear 9'-9" portion of the roof is proposed to be removed, altering the volume of the roof, it would be possible to rebuild this portion of the roof in the future to restore the roof to its previous form. The other work proposed as part of this project could be removed in the future without impacting the essential form and integrity of the landmark. Therefore, the proposed project complies with Rehabilitation Standard 10.

Summary: The Department finds that the overall project is consistent with the *Secretary of the Interior Standards for Rehabilitation.*

PUBLIC/NEIGHBORHOOD INPUT

To date, the Department has received no public input on the project at the date of this report.

ISSUES & OTHER CONSIDERATIONS

None.

STAFF ANALYSIS

Included as an exhibit are architectural drawings of the existing building and the proposed project. Based on the requirements of Article 10 and the *Secretary of Interior's Standards*, Department staff has determined the following:

The proposed project would retain the existing residential use of the building and would cause minimal changes to the form of the building.

Removal of a Rear 9'-9" Portion of the Roof

Staff finds that although the proposed project involves the removal of a 9'-9" portion of the historic roof, the area of the roof to be removed is at the rear of the building, and will not constitute a significant alteration of the features or spaces of the historic building. The roof is not unusual in its form or construction, and the portion to be removed is not visible from a public right-of-way. The new roof deck to be created by the removal of the rear portion of the roof will be simple in design, will be located within the historic footprint of the building, and will not be visible from a public right-of-way.

Window Sash Replacement at the 20th Street Facade

Staff finds that while the historic one-over-one single-hung wood window sashes at the 20th Street facade. are a character-defining feature of the building, they will be replaced in kind with new wood sashes matching the materials, details, configuration, and operation of the historic sashes. The window sashes proposed to be replaced are not distinctive in their features or construction, as they consist of simple one-over-one single-hung wood windows. The historic window frames and brick molding will remain at the 20th Street facade. As a condition of approval, the Planning Department recommends that the Project

Sponsor provide shop drawings of the proposed new window sashes for the 20th Street façade that compare the details and dimensions of the historic sashes with the new sashes, and clarify how the new sashes will be installed within the existing historic frames.

Siding Replacement

Staff finds that the replacement of wood siding at the side and rear elevations will be limited only to areas where it is too deteriorated to be repaired, as well as at select locations where window and door openings are being altered. As a condition of approval, the Planning Department recommends that the project sponsor consult with the Planning Department prior to the removal of any historic wood siding to set up a site visit for staff to review and approve the areas where removal is proposed, and recommends that Planning staff review and approve any new wood siding to be used at the property.

Additional Work

Staff finds that the remainder of the work proposed for this project—including the replacement of the non-historic garage door and secondary basement-level entrance at the 20th Street facade; changes to window and door openings at the rear and side elevations; installation of new skylights at the roof; removal of a non-historic rear deck; modifications to the rear yard landscaping; and interior alterations will not remove character-defining features of the building. With the exception of the in-kind replacements of the non-historic garage and secondary entrance doors at the 20th Street façade, this additional work will not be visible from a public right-of-way. While the proposed project does include limited excavation at the rear yard, the property is not in an archaeologically sensitive area, and the amount of excavation is not significant enough to require additional environmental review per CEQA requirements. The proposed new window and door openings at the rear and side elevations will be compatible with the property's historic windows though their shared material, but will be differentiated by their details and configuration from the historic windows. Overall, the proposed work will not alter the features or spaces that characterize the property. As a condition of approval, the Planning Department recommends that the Project Sponsor provide cut sheets for the following work at the 20th Street facade: new light fixtures; new hardware for the historic entrance doors; replacement garage door; and replacement secondary entrance door. In addition, the Planning Department recommends that the project sponsor provide cut sheets for the new skylights proposed to be installed at the rear of the roof.

Department staff finds that proposed work will be in conformance with the Secretary's Standards and requirements of Article 10, and that the proposed work is compatible with the character-defining features of the subject site and with the Liberty-Hill Landmark District.

ENVIRONMENTAL REVIEW STATUS

The Planning Department has determined that the proposed project is exempt/excluded from environmental review, pursuant to CEQA Guideline Section 15301 (Class One-Minor Alteration of Existing facility) because the project is a minor alteration of an existing structure and meets the *Secretary of the Interior's Standards*.

PLANNING DEPARTMENT RECOMMENDATION

Planning Department staff recommends APPROVAL WITH CONDITIONS of the proposed project as it

appears to meet the *Secretary of the Interior's Standards for Rehabilitation* and the requirements of Appendix F of Article 10 of the Planning Code for the Liberty-Hill Landmark District.

CONDITIONS OF APPROVAL

To ensure that the proposed work is undertaken in conformance with this Certificate of Appropriateness, staff recommends the following conditions:

- 1. As part of the Building Permit, the Project Sponsor shall provide shop drawings of the proposed new window sashes for the 20th Street façade that compare the details and dimensions of the historic sashes with the new sashes, and clarify how the new sashes will be installed within the existing historic frames.
- 2. As part of the Building Permit, the Project Sponsor shall provide cut sheets for the following work at the 20th Street facade: new light fixtures; new hardware for the historic entrance doors; replacement garage door; and replacement secondary entrance door. In addition, the Project Sponsor shall provide cut sheets for the new skylights proposed to be installed at the rear of the roof.
- 3. As part of the Building Permit, the Project Sponsor shall provide a physical sample of the proposed replacement wood siding to be used at limited areas of the side and rear elevations, and will notify staff before any historic wood siding is removed to set up a site visit for staff to review and approve the areas where removal is proposed.

ATTACHMENTS

Draft Motion Exhibits:

- Parcel Map
- Sanborn Map
- Liberty-Hill Landmark District Map
- Existing Conditions Photographs and Aerial Views

Project Sponsor submittal, including:

Reduced Plans



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Historic Preservation Commission Draft Motion

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ADOPTING FINDINGS FOR A CERTIFICATE OF APPROPRIATENESS FOR PROPOSED WORK DETERMINED TO BE APPROPRIATE FOR AND CONSISTENT WITH THE PURPOSES OF ARTICLE 10, TO MEET THE STANDARDS OF ARTICLE 10 AND TO MEET THE SECRETARY OF INTERIOR'S STANDARDS FOR REHABILITATION, FOR THE PROPERTY LOCATED ON LOT 068 IN ASSESSOR'S BLOCK 3608, WITHIN AN RH-3 (RESIDENTIAL HOUSE, THREE FAMILY) ZONING DISTRICT AND A 40-X HEIGHT AND BULK DISTRICT.

PREAMBLE

WHEREAS, on August 2, 2017, Blake Evans of Martinkovic Milford Architects (Project Sponsor) filed an application with the San Francisco Planning Department (hereinafter "Department") for a Certificate of Appropriateness for the following work at the subject property located on lot 068 in Assessor's Block 3608:

- Removal of the rear 9'-9" portion of the existing gabled roof at the rear of the building at the attic level only, to accommodate the construction of a new rear roof deck at the attic level.
- In-kind replacement of nine (9) one-over-one single-hung offset wood window sashes with shorter upper sashes at the 20th Street façade.
- In-kind replacement of the non-historic garage door and non-historic recessed secondary basement-level entrance door at the 20th Street façade.
- Modifications to existing window and door openings at the non-visible side and rear elevations, including the following:

- At the east side elevation, expansion of two (2) existing window openings at the east light well at the first and second floors to install fixed wood single-lite windows; and the creation of one (1) new window opening with a wood one-over-one slider unit at the basement level at the south end of the east elevation.
- At the rear south elevation, modifications to all existing window and door openings to allow for the installation of one (1) set of paired wood sliding glazed doors and one (1) one-over-one double-hung wood window at the first floor; one (1) wood window assembly consisting of fixed and awning windows, one (1) single-lite wood awning window, and one (1) dryer vent at the second floor; and one (1) set of paired wood sliding glazed doors at the attic level.
- At the west side elevation, removal of two (2) existing window openings.

For all modifications to existing window and door openings, the maximum possible amount of historic painted wood siding will be retained around the openings, and any necessary new siding will match the historic painted wood siding in terms of materials, dimensions, and profiles.

- Installation of six (6) new skylights at the rear portion of the roof, to be mounted low to the roof with frames painted to match the surrounding roof cladding.
- Removal of the existing non-historic wood deck at the first floor at the rear elevation.
- Modifications to the existing rear yard, including excavation of approximately 262 square feet (851.5 cubic feet) of soil at the rear yard to support the creation of two terraces at the rear yard; replacement of an existing non-historic concrete staircase leading from the basement level to the rear yard with a new concrete stair; the construction of a second concrete stair to lead to the new upper terrace in the rear yard; the installation of a stucco retaining wall topped with a 42-inch-tall guardrail separating the lower terrace from the upper terrace; and the installation of a new perimeter fence around the rear yard.
- Interior alterations at all floors related to the remodeling of the interior spaces, while maintaining the current unit count.

WHEREAS, the Project was determined by the Department to be categorically exempt from environmental review. The Historic Preservation Commission (hereinafter "Commission") has reviewed and concurs with said determination.

WHEREAS, on January 17, 2018, the Commission conducted a duly noticed public hearing on the current project, Case No. 2017-007097COA ("Project") for its appropriateness.

WHEREAS, in reviewing the Application, the Commission has had available for its review and consideration case reports, plans, and other materials pertaining to the Project contained in the Department's case files, has reviewed and heard testimony and received materials from interested parties during the public hearing on the Project.

MOVED, that the Commission hereby grants the Certificate of Appropriateness, in conformance with the architectural plans dated December 20, 2017 and labeled Exhibit A on file in the docket for Case No. 2017-007097COA based on the following findings:

CONDITIONS OF APPROVAL

To ensure that the proposed work is undertaken in conformance with this Certificate of Appropriateness, staff recommends the following conditions:

- 1. As part of the Building Permit, the Project Sponsor shall provide shop drawings of the proposed new window sashes for the 20th Street façade that compare the details and dimensions of the historic sashes with the new sashes, and clarify how the new sashes will be installed within the existing historic frames.
- 2. As part of the Building Permit, the Project Sponsor shall provide cut sheets for the following work at the 20th Street facade: new light fixtures; new hardware for the historic entrance doors; replacement garage door; and replacement secondary entrance door. In addition, the Project Sponsor shall provide cut sheets for the new skylights proposed to be installed at the rear of the roof.
- 3. As part of the Building Permit, the Project Sponsor shall provide a physical sample of the proposed replacement wood siding to be used at limited areas of the side and rear elevations, and will notify staff before any historic wood siding is removed to set up a site visit for staff to review and approve the areas where removal is proposed.

FINDINGS

Having reviewed all the materials identified in the recitals above and having heard oral testimony and arguments, this Commission finds, concludes, and determines as follows:

- 1. The above recitals are accurate and also constitute findings of the Commission.
- 2. Findings pursuant to Article 10:

The Historical Preservation Commission has determined that the proposed work is compatible with the character of the landmark district as described in the designation report dated October 15, 1985.

- The project would retain the existing residential use of the building.
- The project would not impact the historic character of the subject property, and does not involve the removal of historic materials or alterations of features and spaces that characterize the subject property. Although the proposed project involves the removal of a 9'-9" portion of the historic roof, the area of the roof to be removed is at the rear of the building, and will not constitute a significant alteration of the features or spaces of the historic building. The roof is not unusual in its form or construction, and the portion to be removed is not visible from a public right-of-way. The new roof deck to be created by the removal of the

rear portion of the roof will be simple in design, will be located within the historic footprint of the building, and will not be visible from a public right-of-way.

- While the historic one-over-one single-hung wood window sashes at the 20th Street facade proposed to be replaced are a character-defining feature of the building, they will be replaced in kind with new wood sashes matching the materials, details, configuration, and operation of the historic sashes. The window sashes proposed to be replaced are not distinctive in their features or construction, as they consist of simple one-over-one single-hung wood windows. The historic window frames and brick molding will remain at the 20th Street facade.
- The proposed replacement of wood siding at the side and rear elevations will be limited only to areas where it is too deteriorated to be repaired, as well as at select locations where window and door openings are being altered. The project sponsor will consult with the Planning Department prior to the removal of any historic wood siding to set up a site visit for staff to review and approve the areas where removal is proposed, and Planning staff will review and approve any new wood siding to be used at the property.
- The remainder of the work proposed for this project—including the replacement of the non-historic garage door and secondary basement-level entrance at the 20th Street facade; changes to window and door openings at the rear and side elevations; installation of new skylights at the roof; removal of a non-historic rear deck; modifications to the rear yard landscaping; and interior alterations—will not remove character-defining features of the building. With the exception of the in-kind replacements of the non-historic garage and secondary entrance doors at the 20th Street façade, this additional work will not be visible from a public right-ofway. Overall, this work will not obstruct or substantially alter any historic fabric at the subject property.
- The project would preserve the essential form and integrity of the subject property, and the district and its environment would be unimpaired if the proposed alterations and site work were to be removed at a future date.
- The proposed project meets the requirements of Article 10, Appendix F, of the Planning Code.
- The proposed project meets the following Secretary of the Interior's Standards for Rehabilitation:

Standard 1.

A property shall be used for its historic purpose or be placed in a new use that requires minimal change to the defining characteristics of the building and its site and environment.

Standard 2.

The historic character of a property shall be retained and preserved. The removal of historic materials or alteration of features and spaces that characterize a property shall be avoided.

Standard 3.

Each property will be recognized as a physical record of its time, place, and use. Changes that create a false sense of historical development, such as adding conjectural features or elements from other historic properties, will not be undertaken.

Standard 4.

Changes to a property that have acquired historic significance in their own right will be retained and preserved.

Standard 5.

Distinctive features, finishes, and construction techniques or examples of craftsmanship that characterize a property shall be preserved.

Standard 6:

Deteriorated historic features will be repaired rather than replaced. Where the severity of deterioration requires replacements of a distinctive feature, the new feature will match the old in design, color, texture and other visual qualities and, where possible, materials. Replacement of missing features shall be substantiated by documentary, physical, or pictorial evidence.

Standard 9.

New additions, exterior alterations, or related new construction will not destroy historic materials, features, and spatial relationships that characterize the property. The new work will be differentiated from the old and will be compatible with the historic materials, features, size, scale and proportion, and massing to protect the integrity of the property and its environment.

Standard 10.

New additions and adjacent or related new construction shall be undertaken in such a manner that if removed in the future, the essential form and integrity of the historic property and its environment would be unimpaired.

3. **General Plan Compliance.** The proposed Certificate of Appropriateness is, on balance, consistent with the following Objectives and Policies of the General Plan:

I. URBAN DESIGN ELEMENT

THE URBAN DESIGN ELEMENT CONCERNS THE PHYSICAL CHARACTER AND ORDER OF THE CITY, AND THE RELATIONSHIP BETWEEN PEOPLE AND THEIR ENVIRONMENT.

GOALS

The Urban Design Element is concerned both with development and with preservation. It is a concerted effort to recognize the positive attributes of the city, to enhance and conserve those attributes, and to improve the living environment where it is less than satisfactory. The Plan is a definition of quality, a definition based upon human needs.

OBJECTIVE 1

EMPHASIS OF THE CHARACTERISTIC PATTERN WHICH GIVES TO THE CITY AND ITS NEIGHBORHOODS AN IMAGE, A SENSE OF PURPOSE, AND A MEANS OF ORIENTATION.

POLICY 1.3

Recognize that buildings, when seen together, produce a total effect that characterizes the city and its districts.

OBJECTIVE 2

CONSERVATION OF RESOURCES WHICH PROVIDE A SENSE OF NATURE, CONTINUITY WITH THE PAST, AND FREEDOM FROM OVERCROWDING.

POLICY 2.4

Preserve notable landmarks and areas of historic, architectural or aesthetic value, and promote the preservation of other buildings and features that provide continuity with past development.

POLICY 2.5

Use care in remodeling of older buildings, in order to enhance rather than weaken the original character of such buildings.

POLICY 2.7

Recognize and protect outstanding and unique areas that contribute in an extraordinary degree to San Francisco's visual form and character.

The goal of a Certificate of Appropriateness is to provide additional oversight for buildings and districts that are architecturally or culturally significant to the City in order to protect the qualities that are associated with that significance.

The proposed project qualifies for a Certificate of Appropriateness and therefore furthers these policies and objectives by maintaining and preserving the character-defining features of the Liberty-Hill Landmark District for the future enjoyment and education of San Francisco residents and visitors.

- 4. The proposed project is generally consistent with the eight General Plan priority policies set forth in Section 101.1 in that:
 - A) The existing neighborhood-serving retail uses will be preserved and enhanced and future opportunities for resident employment in and ownership of such businesses will be enhanced:

The proposed project will not have any impact on neighborhood serving retail uses.

B) The existing housing and neighborhood character will be conserved and protected in order to preserve the cultural and economic diversity of our neighborhoods:

The proposed project will strengthen neighborhood character by respecting the character-defining features of the landmark district in conformance with the Secretary of the Interior's Standards.

C) The City's supply of affordable housing will be preserved and enhanced:

The project will not reduce the affordable housing supply as the existing units will be retained and three new housing units will be added as part of the proposed work.

D) The commuter traffic will not impede MUNI transit service or overburden our streets or neighborhood parking:

The proposed project will not result in commuter traffic impeding MUNI transit service or overburdening the streets or neighborhood parking.

E) A diverse economic base will be maintained by protecting our industrial and service sectors from displacement due to commercial office development. And future opportunities for resident employment and ownership in these sectors will be enhanced:

The proposed project will not have any impact on industrial and service sector jobs.

F) The City will achieve the greatest possible preparedness to protect against injury and loss of life in an earthquake.

Preparedness against injury and loss of life in an earthquake is improved by the proposed work. The work will be executed in compliance with all applicable construction and safety measures.

G) That landmark and historic buildings will be preserved:

The proposed project is in conformance with Article 10 of the Planning Code and the Secretary of the Interior's Standards.

H) Parks and open space and their access to sunlight and vistas will be protected from development:

The proposed project will not impact the access to sunlight or vistas for the parks and open space.

5. For these reasons, the proposal overall, is appropriate for and consistent with the purposes of Article 10, meets the standards of Article 10, and the Secretary of Interior's Standards for Rehabilitation, General Plan and Prop M findings of the Planning Code.

DECISION

That based upon the Record, the submissions by the Applicant, the staff of the Department and other interested parties, the oral testimony presented to this Commission at the public hearings, and all other written materials submitted by all parties, the Commission hereby **APPROVES a Certificate of Appropriateness** for the property located at Lot 068 in Assessor's Block 3608 for proposed work in conformance with the renderings and architectural sketches dated December 20, 2017 and labeled Exhibit A on file in the docket for Case No. 2017-007097COA.

APPEAL AND EFFECTIVE DATE OF MOTION: The Commission's decision on a Certificate of Appropriateness shall be final unless appealed within thirty (30) days. Any appeal shall be made to the Board of Appeals, unless the proposed project requires Board of Supervisors approval or is appealed to the Board of Supervisors as a conditional use, in which case any appeal shall be made to the Board of Supervisors (see Charter Section 4.135).

Duration of this Certificate of Appropriateness: This Certificate of Appropriateness is issued pursuant to Article 10 of the Planning Code and is valid for a period of three (3) years from the effective date of approval by the Historic Preservation Commission. The authorization and right vested by virtue of this action shall be deemed void and canceled if, within 3 years of the date of this Motion, a site permit or building permit for the Project has not been secured by Project Sponsor.


THIS IS NOT A PERMIT TO COMMENCE ANY WORK OR CHANGE OF OCCUPANCY UNLESS NO BUILDING PERMIT IS REQUIRED. PERMITS FROM THE DEPARTMENT OF BUILDING INSPECTION (and any other appropriate agencies) MUST BE SECURED BEFORE WORK IS STARTED OR OCCUPANCY IS CHANGED.

I hereby certify that the Historical Preservation Commission APPROVES the foregoing Motion on January 17, 2018.

Jonas P. Ionin Commission Secretary


- AYES: X NAYS: X ABSENT: X
- ADOPTED: January 17, 2018

Parcel Map

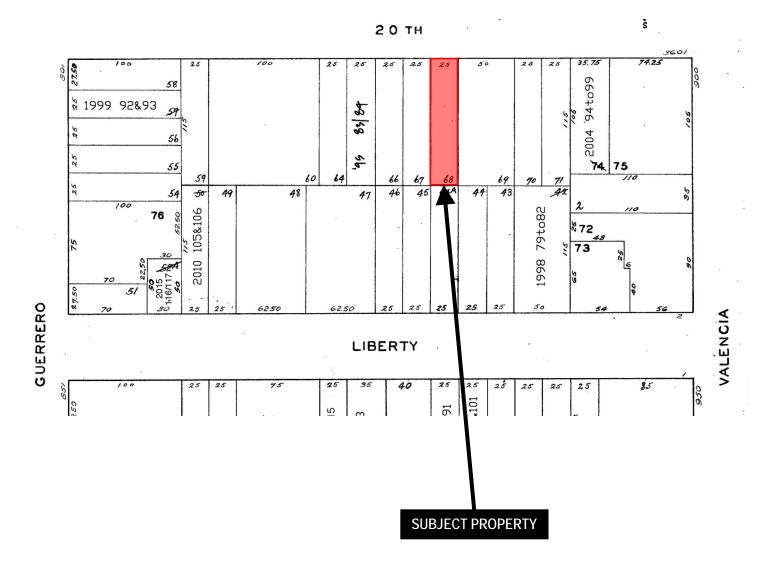



Sanborn Map*

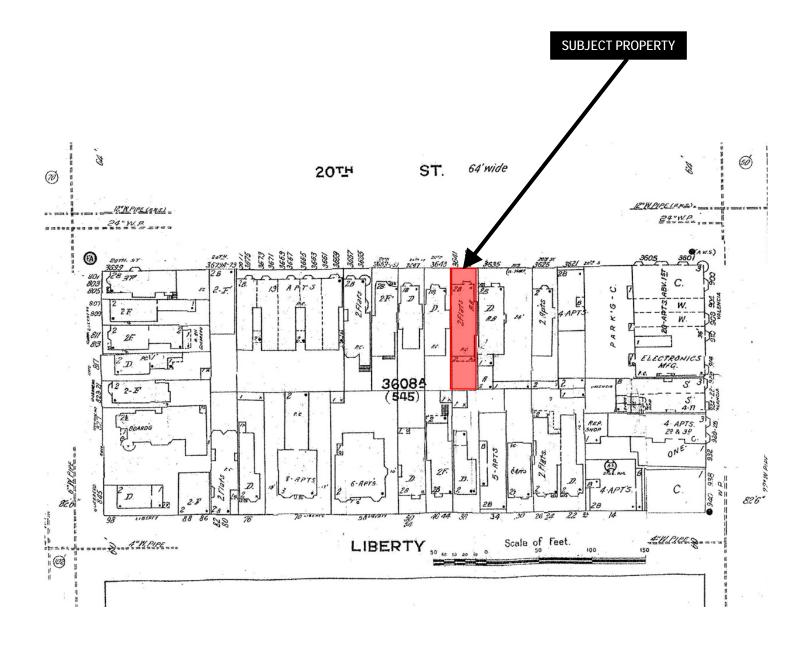

*The Sanborn Maps in San Francisco have not been updated since 1998, and this map may not accurately reflect existing conditions.

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Liberty-Hill Landmark District Map



Aerial Photo








Aerial Oblique Photo of Rear Elevation


SUBJECT PROPERTY

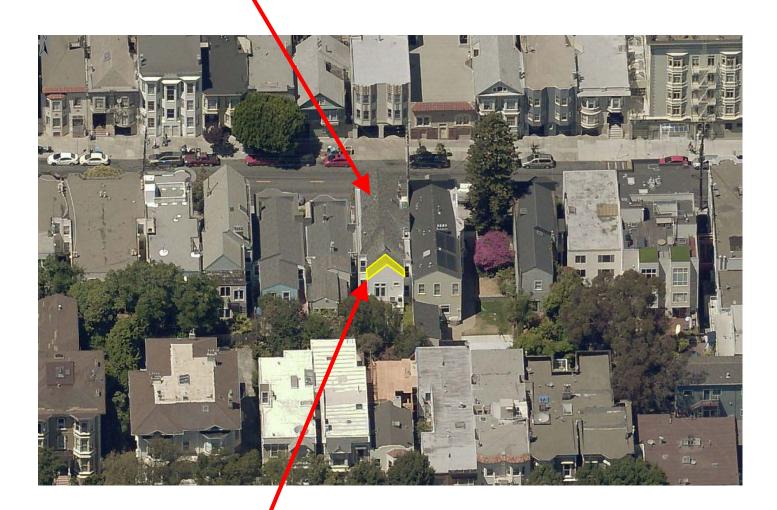


APPROXIMATE AREA OF ROOF PROPOSED FOR REMOVAL FOR NEW ROOF DECK

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Site Photo: Front of Building

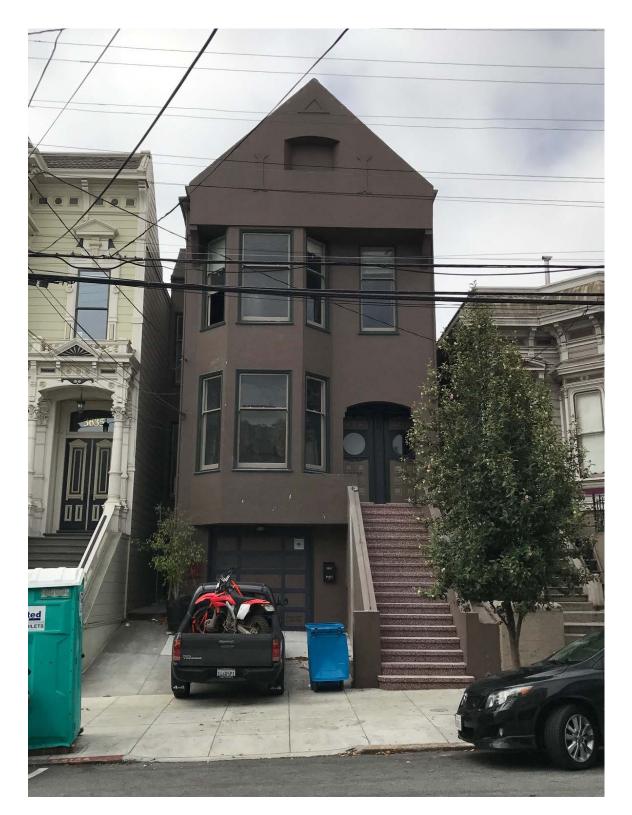

Site Photo: Rear of Building



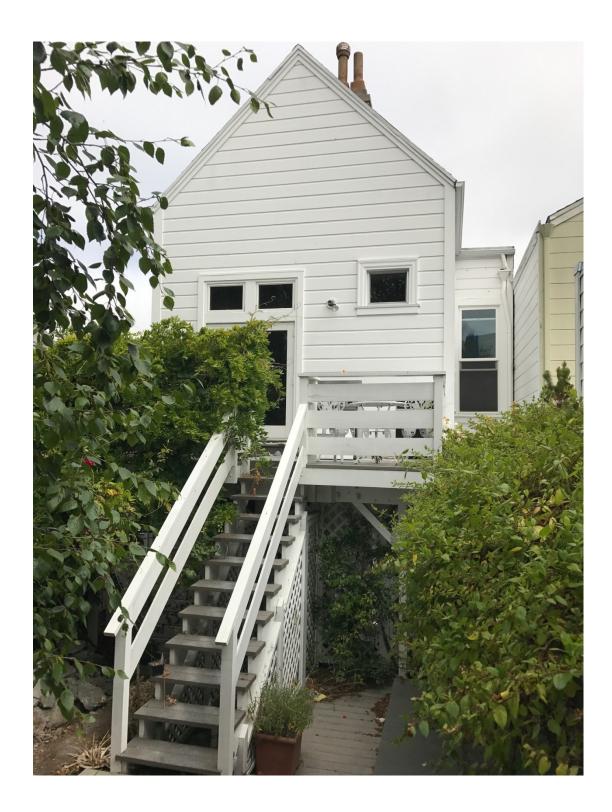

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APPLICABLE CODES

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2016 SAN FRANCISCO BUILDING CODE AMENDMENTS 2016 SAN FRANCISCO ELECTRICAL CODE AMENDMENTS 2016 SAN FRANCISCO MECHANICAL CODE AMENDMENTS 2016 SAN FRANCISCO PLUMBING CODE AMENDMENTS 2016 SAN FRANCISCO FIRE CODE AMENDMENTS 2016 SAN FRANCISCO GREEN BUILDING CODE AMENDMENTS 2016 SAN FRANCISCO HOUSING CODE AMENDMENTS

EXISTING & PROPOSED AREAS

UNIT 1 EXISTING : 1,558 SF UNIT 1 PROPOSED: 2,274.3 SF UNIT 2 EXISTING: 2,228 SF UNIT2 PROPOSED: 2,310.2 SF UNIT 2 EXTERIOR DECK: 166.6 SF EXISTING GARAGE: 424 SF PROPOSED GARAGE: 542.5 SF EXISTING SHARED STORAGE AND MECH: 479 SF PROPOSED STORAGE AND MECH: 78.5 SF


TOTAL EXISTING BUILDING AREA: 4,689 SF TOTAL PROPOSED BUILDING AREA: 5,255.1 SF

DEMOLITION CALCULATIONS


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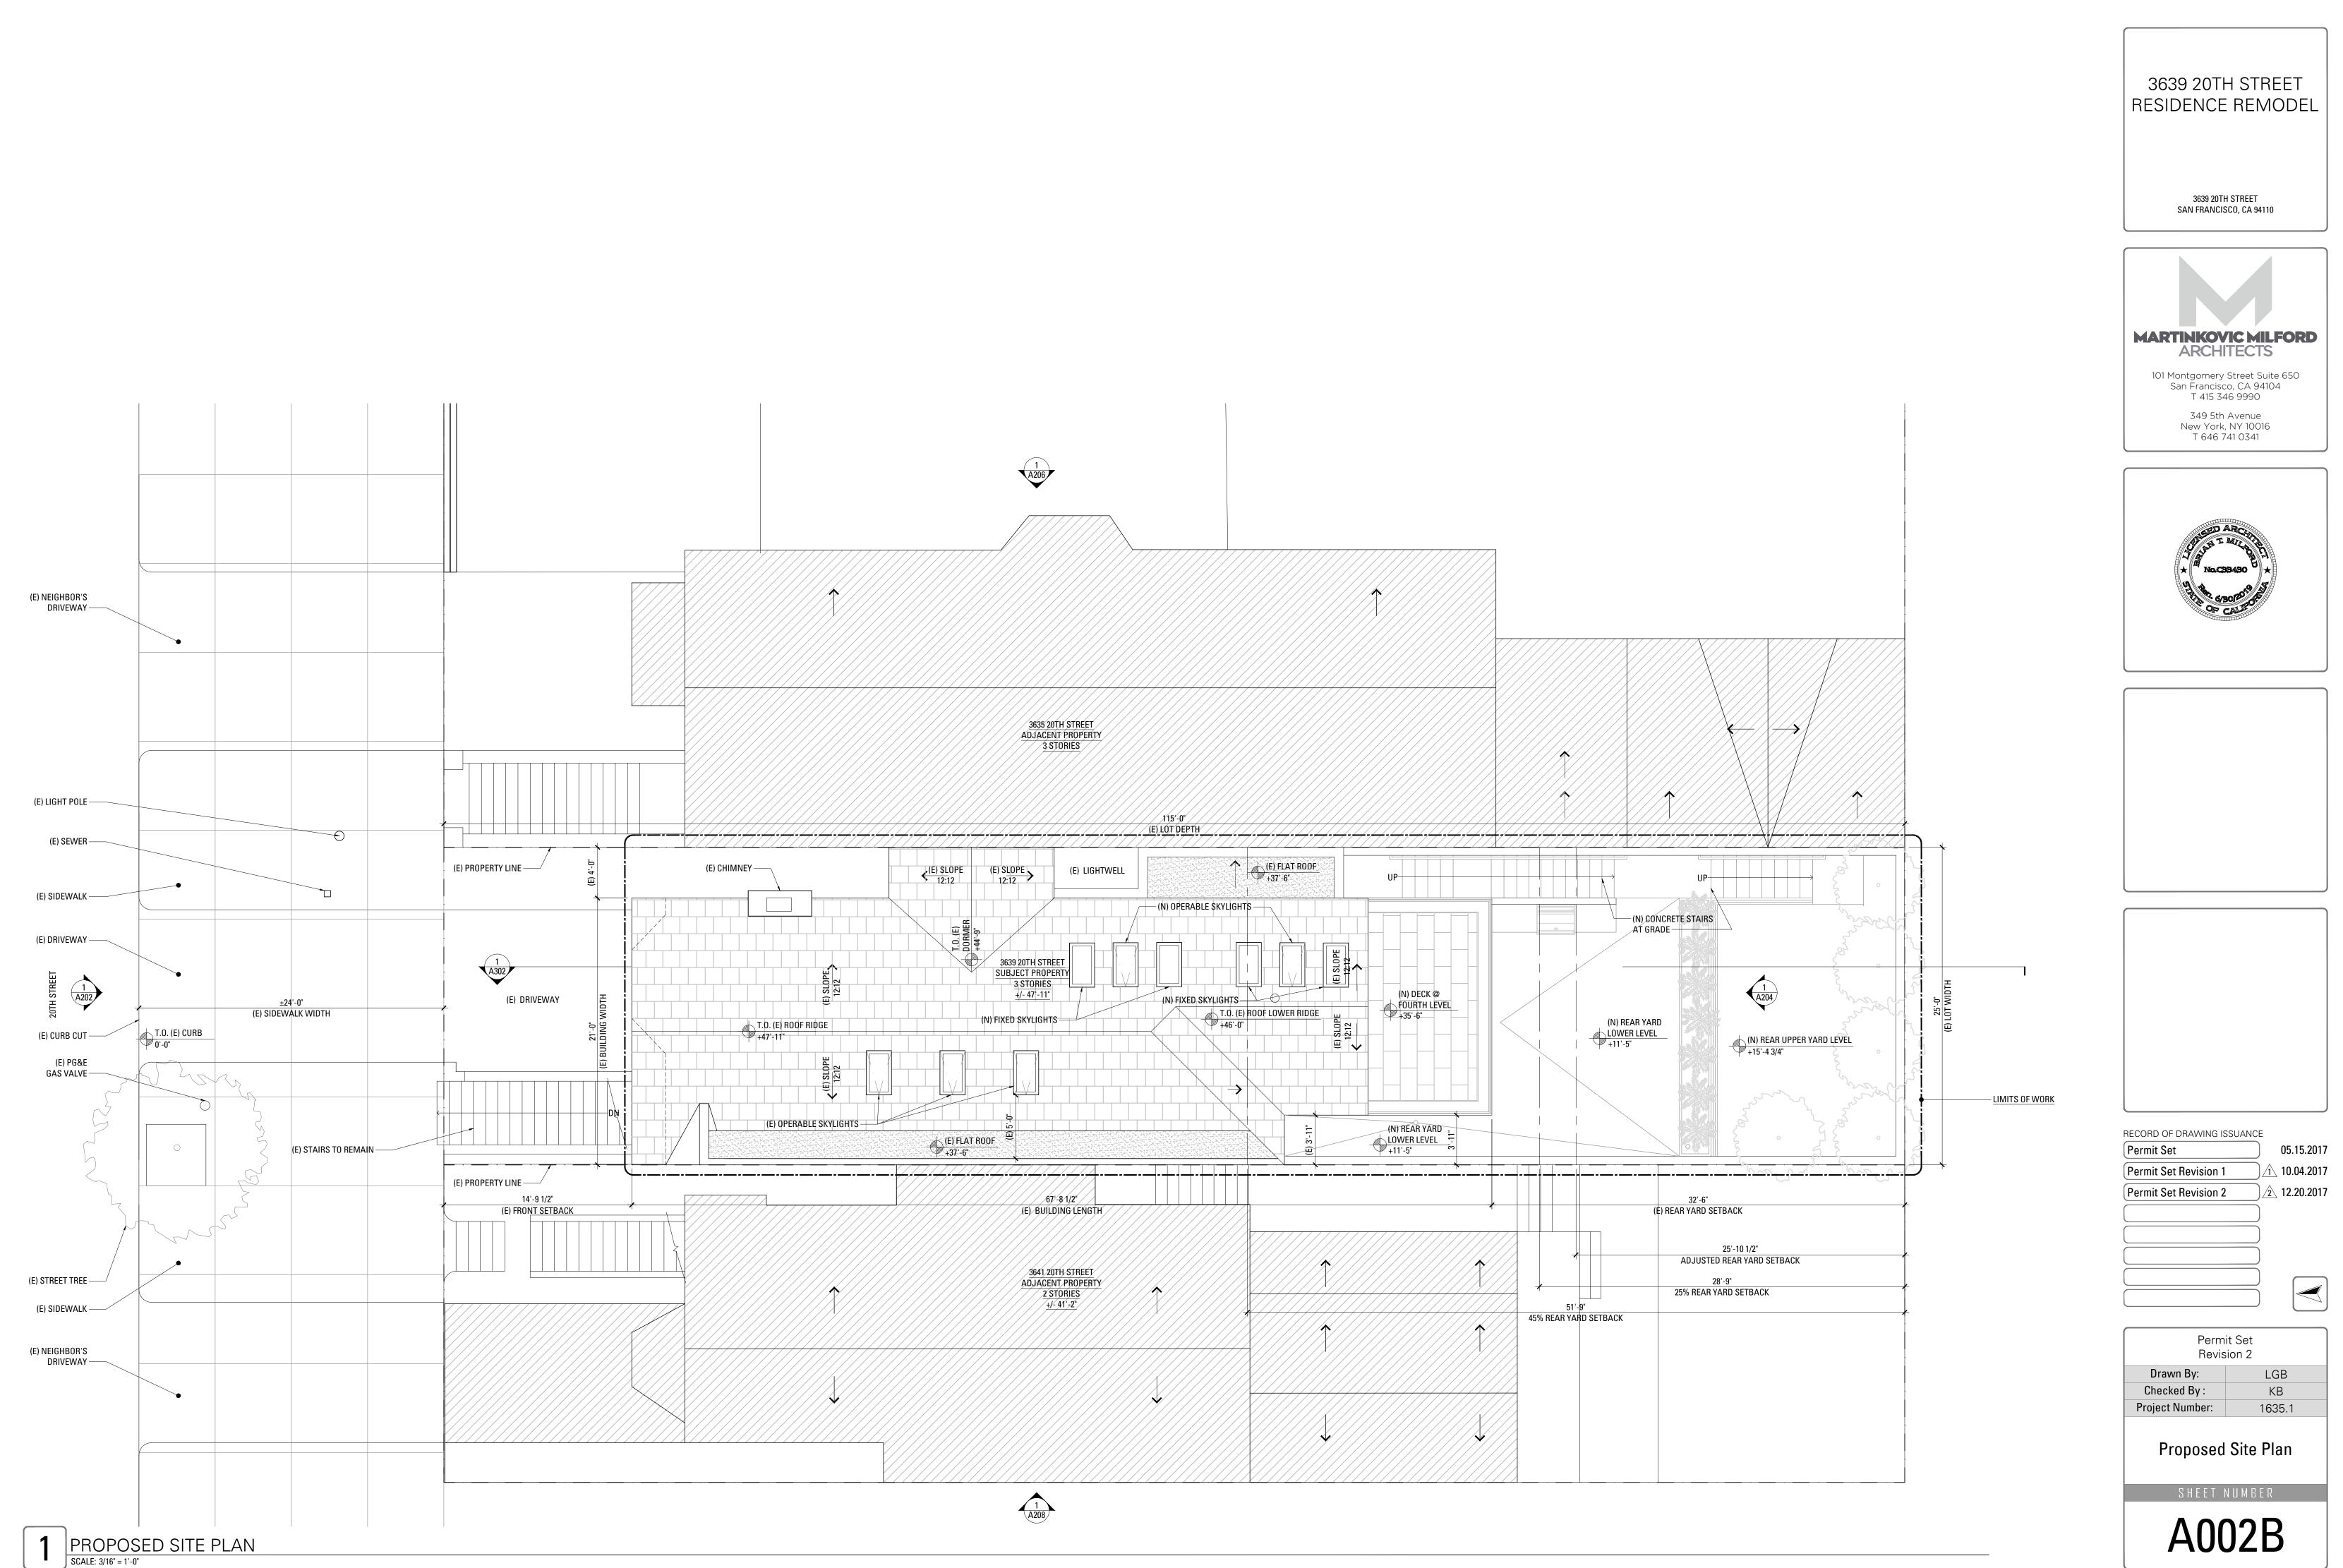
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3639 20TH STREET SAN FRANCISCO, CALIFORNIA 94110



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City and County of San Francisco Green Building Submittal **Residential Additions and Alterations**

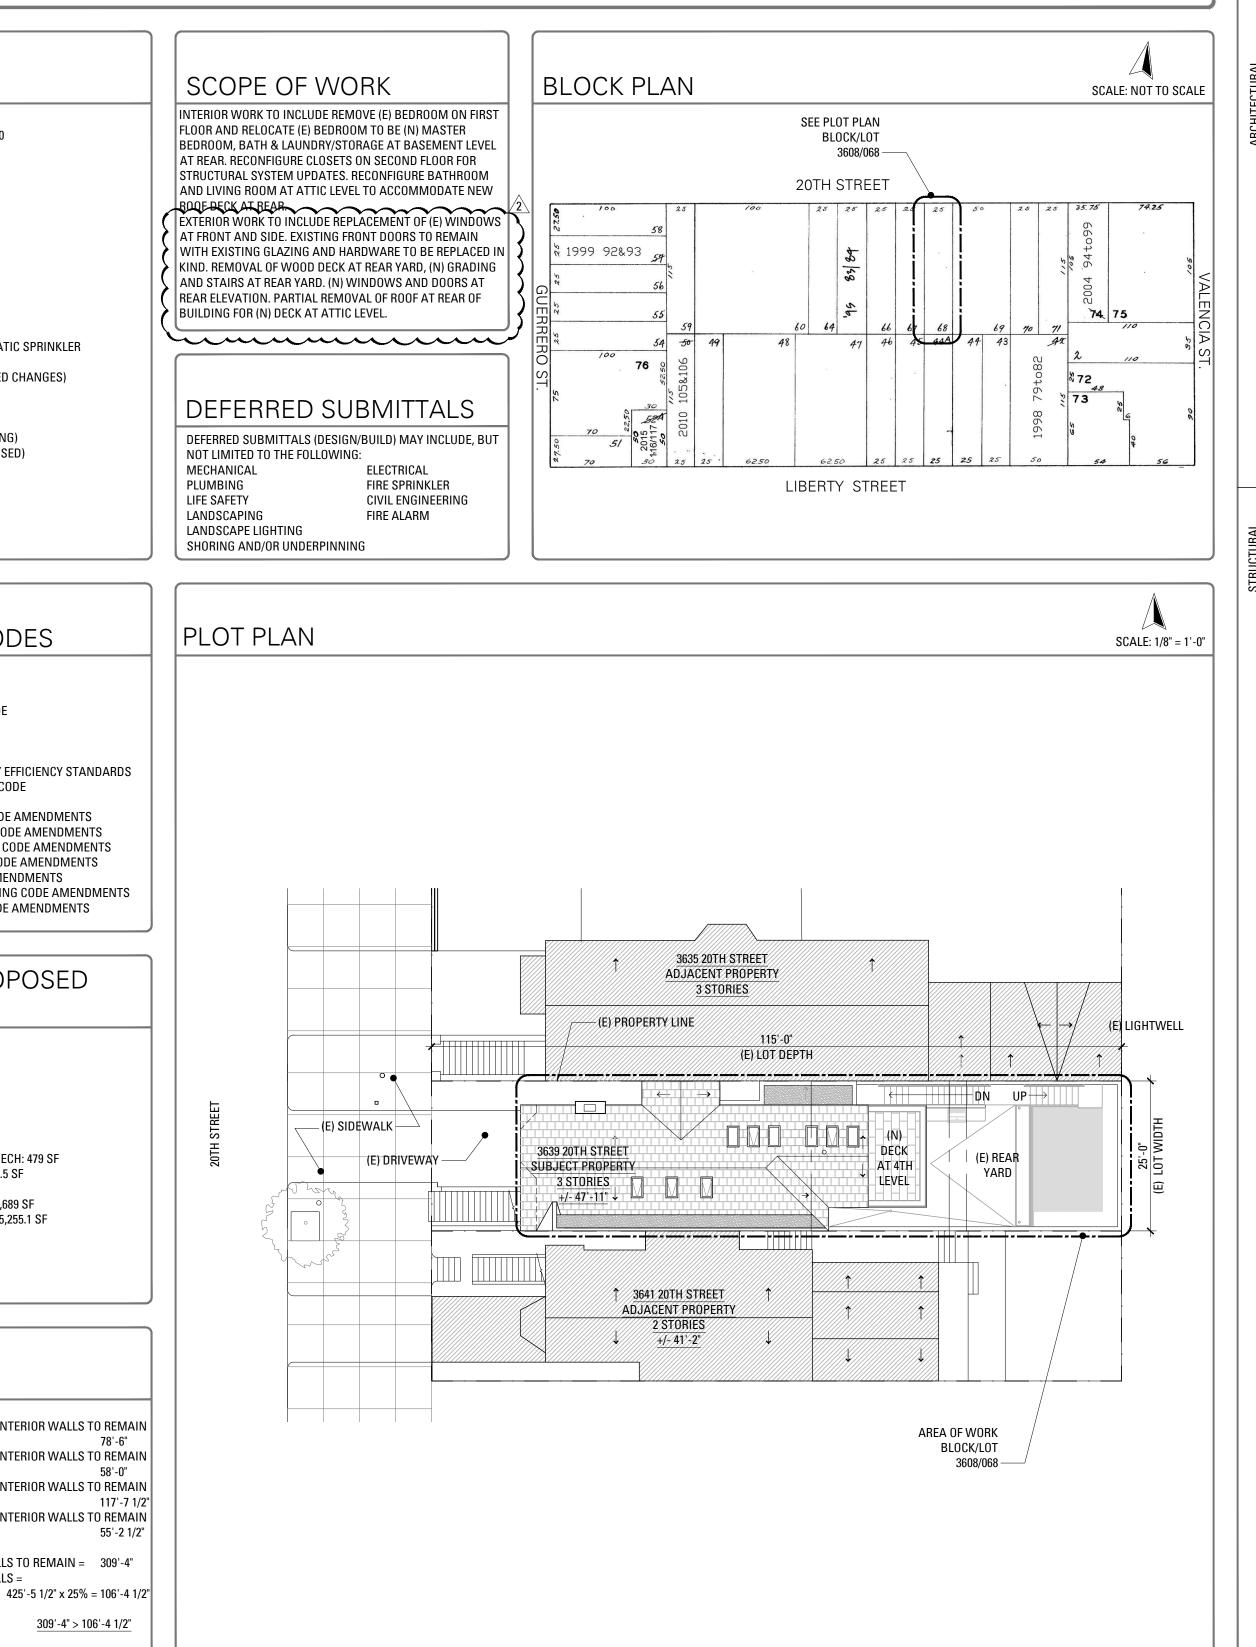REQUIREMENTS

The following items are required for all additions and alterations to residential occupancy which increase conditioned area, volume, or size of a residential building. Requirements apply only to areas and systems within the scope of addition and alteration, with the exception of "Existing Noncompliant Plumbing Fixtures" (below). An abbreviated summary of each requirement is included for reference. To determine if this form is appropriate for a project, see Administrative Bulleting 93, Attachment A, Table 1. Projects required to meet a LEED standard must use C-3 "Submittal for LEED Projects" and projects required to meet GreenPoint Rated must use the C-4 "Submittal for GreenPoint Rated Projects." Projects seeking certification may use the C-3 "Submittal for LEED Projects" or C-4 "Submittal for GreenPoint Rated" as alternatives to this form.

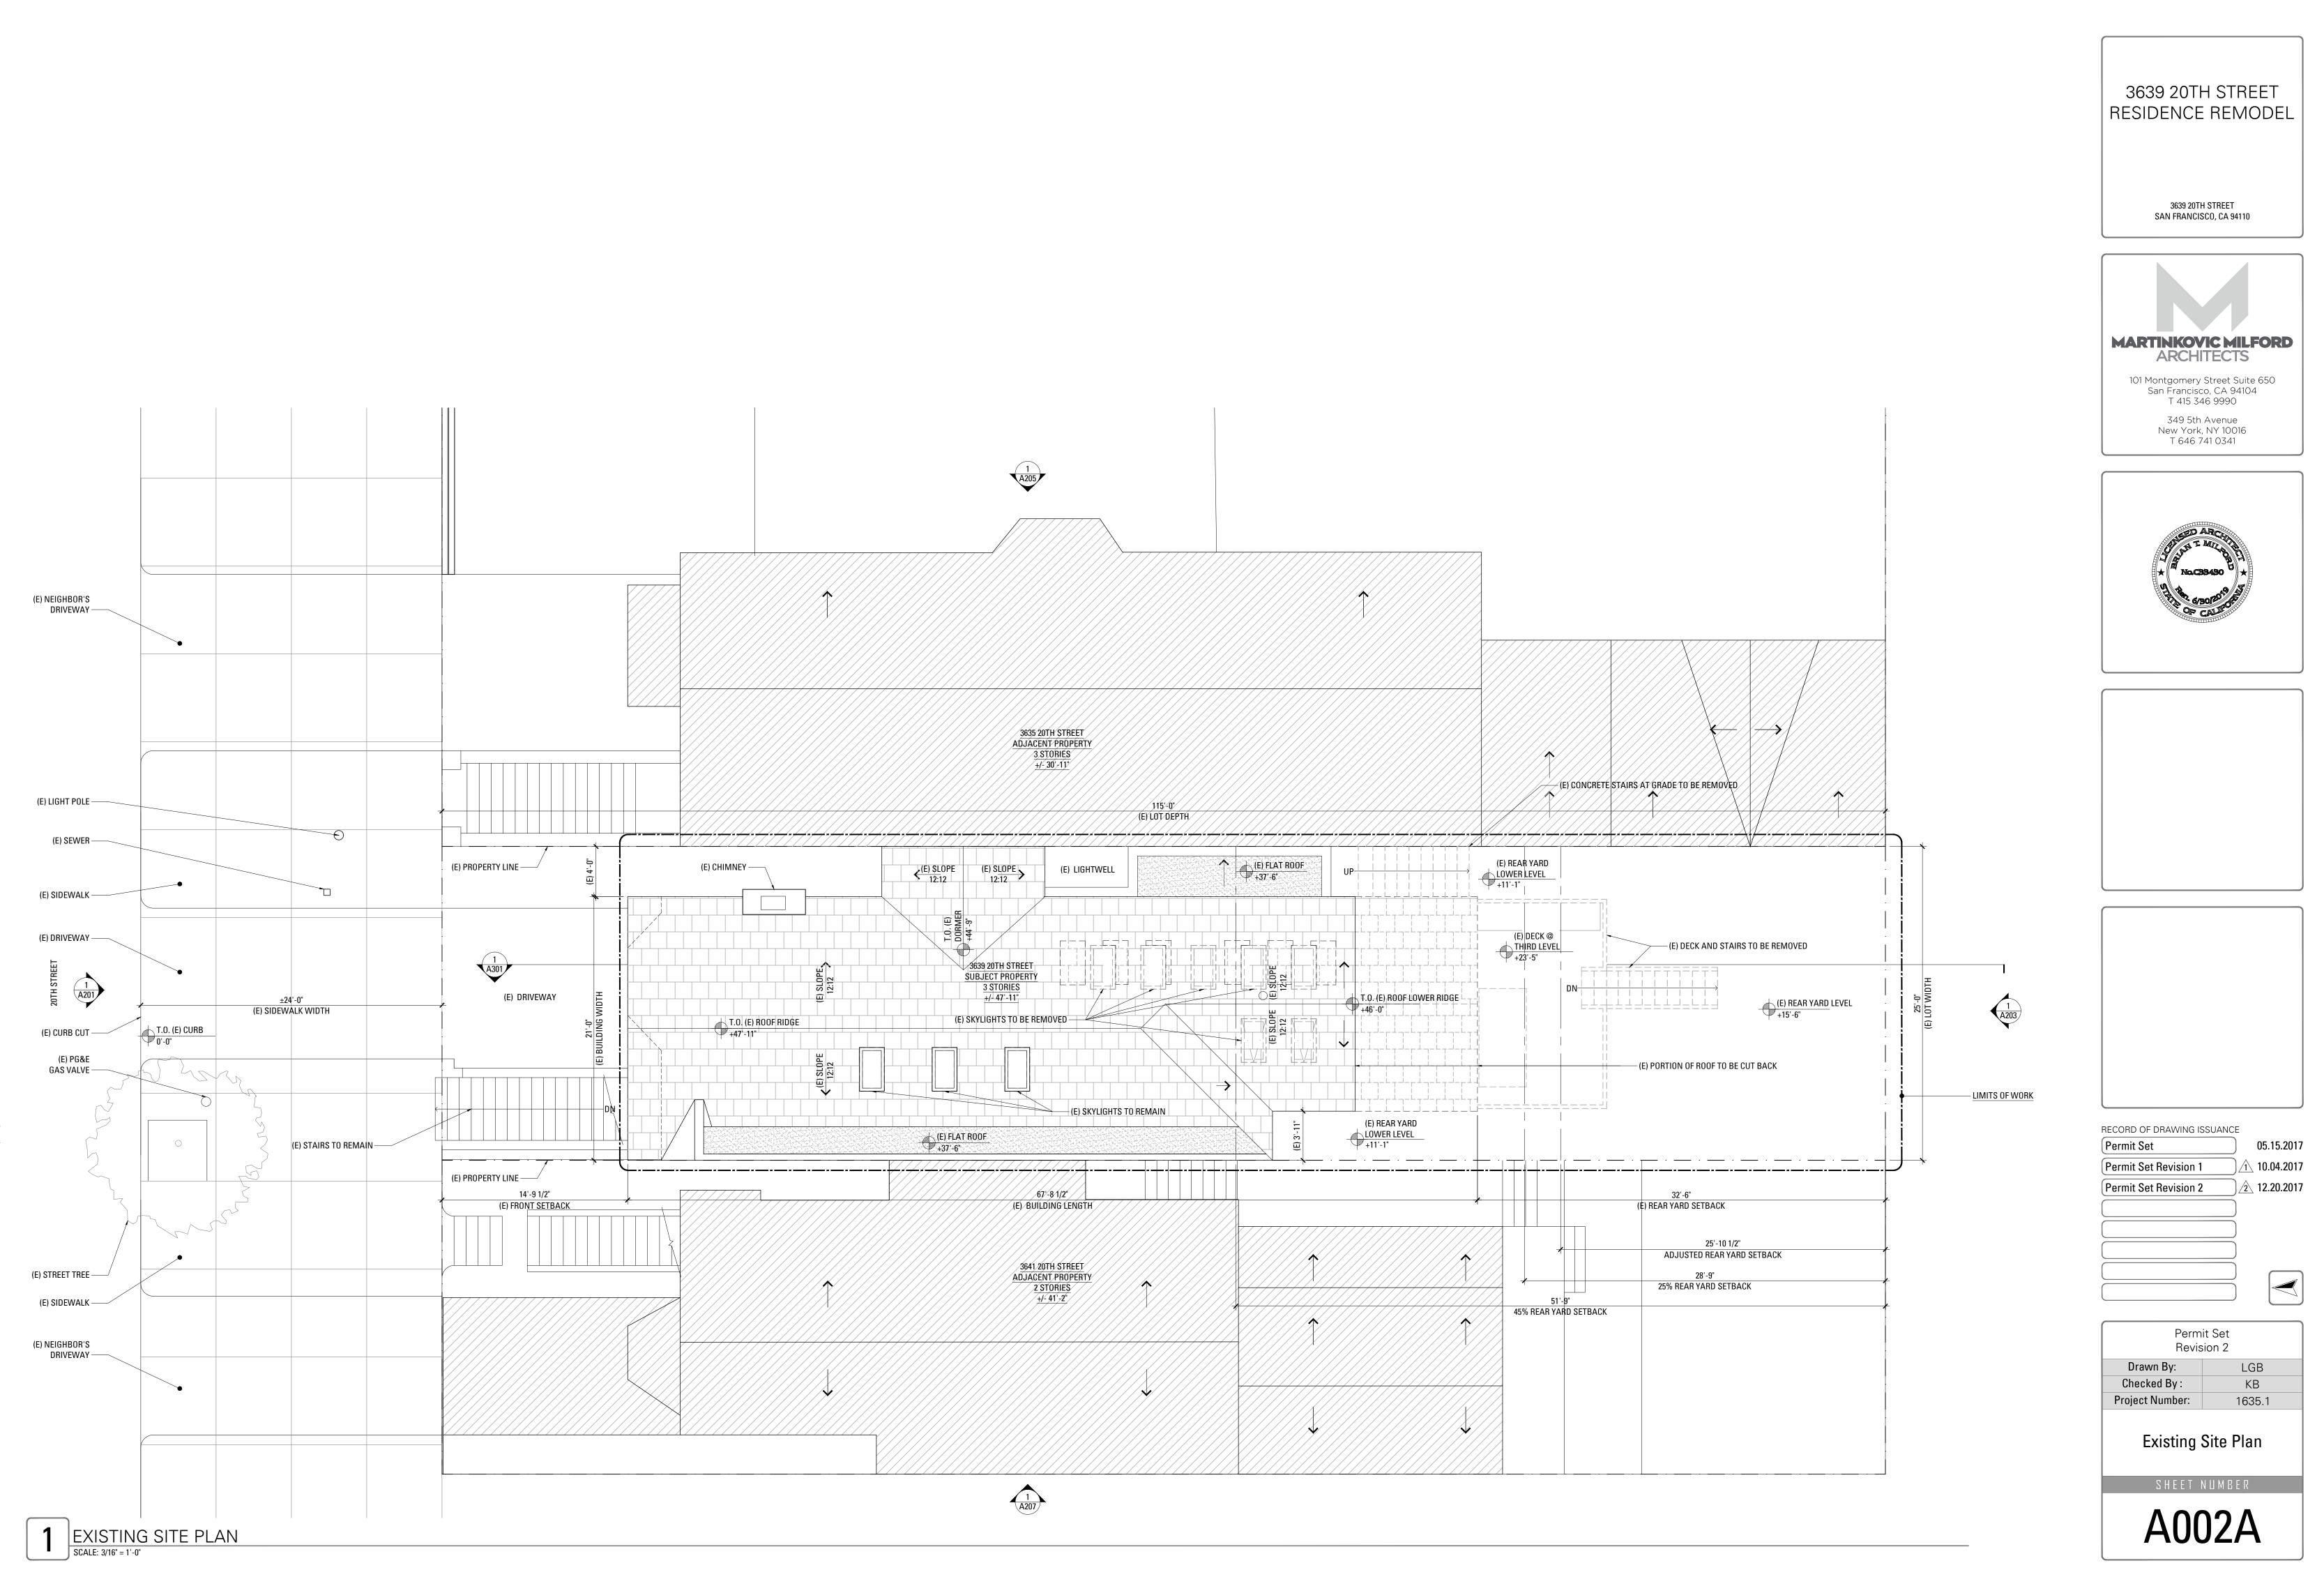Construction and Demolition Debris: 100% of mixed debris must be transported by a registered hauler to a registered facility and be processed for recycling, in compliance with the San Francisco Construction & Demolition Debris Ordinance (San Francisco Building Code Chapter 13B and Environment Code Chapter 14)

Recycling by Occupants: Provide adequate space and equal access for storage, collection and loading of compostable, recyclable and landfill materials. - See Administrative Bulletin 088. Water Efficient Irrigation: Projects that include ≥ 1,000 square feet of new or modified landscape must comply with the San Francisco Water Efficient Irrigation Ordinance. (See www.sfwater.org/landscape)

Stormwater Control Plan: Projects disturbing ≥ 5,000 square feet must implement a Stormwater Control Plan meeting SFPUC Stormwater Design Guidelines. (See www.sfwater.org/sdg)

Grading and paving: Construction plans shall indicate how the site grading or drainage system will manage surface water flows to keep water from entering the building, such as swales, drains, or water retention gardens. (CalGreen 4.106.3)

Smart Irrigation Controller: Automatically adjust irrigation based on weather and soil moisture. Controllers must have either an integral or separate rain sensors that connects or communicates with the controller. (CalGreen 4.304.1

Indoor Water Efficiency: Install water-efficient fixtures and fittings as summarized in CalGreen 4.303 (See "Indoor Water Efficiency" at left.) Replace all noncompliant fixtures in project area (CalGreen 3.301.1.1, San Francisco Housing Code 12A

Energy Efficiency: Comply with California Energy Code (Title 24, Part 6 2013)

Rodent Proofing: Annular spaces around pipes, electric cables, conduits, or other openings in sole/bottom plates at exterior walls shall be protected against the passage of rodents by closing with cement mortar, concrete masonry, or a similar method acceptable to the San Francisco Department of Building Inspection. (CalGreen 4.406.1)

Moisture content: Verify wall and floor framing shall be verified to not exceed 19% moisture content prior to enclosure as detailed below. Materials with visible signs of moisture damage shall not be installed. (CalGreen 4.505.3) 1) Moisture content shall be determined with either a probe-type or a contact-type moisture meter. Equivalent moisture verification methods may be approved by the enforcing agency and shall satisfy requirements in Section 101.8. 2) Moisture readings shall be taken at a point 2 feet (610 mm) to 4 feet (1219 mm) from the grade-stamped end of each piece to be verified. 3) At least three random moisture readings shall be performed on wall and floor framing with documentation acceptable to the enforcing agency provided at the time of approval to enclose the wall and floor framing. Insulation products which are visibly wet or have a high moisture content shall be replaced or allowed to dry prior to enclosure in wall or floor cavities. Manufacturers' drying recommendations shall be followed for wet-applied insulation products prior to enclosure

Capillary break for concrete slab on grade: Concrete slab on grade foundations required to have a vapor retarder must also have a capillary break, including at least one of the following: (CalGreen 4.505.2) 1) A 4-inch (101.6 mm) thick base of 1/2-inch (12.7 mm) or larger clean aggregate shall be provided with a vapor retarder in direct contact with concrete and a concrete mix design which will address bleeding, shrinkage and curling shall be used. For additional information, see American Concrete Institute, ACI 302.2R-06. 2) A slab design specified by a licensed design professional.

Fireplaces and woodstoves: Install only direct-vent or sealed-combustion appliances; comply with US EPA Phase II limits. (CalGreen 4.503.1)

Design and Install HVAC System to ACCA Manual J, D, and S (CalGreen 4.507.2)

HVAC Installer Qualifications: HVAC system installers must be trained and certified in the proper installation of HVAC systems, such as via a state certified apprenticeship program, public utility training program (with certification as installer qualification), or other program acceptable to the Department of Building Inspection. (CalGreen 702.1)

Covering duct openings and protecting mechanical equipment during construction: Duct openings and other air distribution component openings shall covered during all phases of construction with tape, plastic, sheetmetal, or other acceptable methods to reduce the amount of water, dust, and debris entering the system. (CalGreen 4.504.1)

ENERGY STAR Compliant Bathroom exhaust fans: Must be ENERGY STAR compliant, ducted to terminate outside the building, and controlled by humidistat capable of adjustment between relative humidity of less than 50% to maximum of 80%. Humidity control may be a separate component from the exhaust fan. (CalGreen 4.506.1)

- **Carpet:** All carpet must meet one of the following: (CalGreen 4.504.3)
- 1. Carpet and Rug Institute Green Label Plus Program,
- 2. California Department of Public Health Standard Practice for the testing of VOCs (Specification 01350),
- 3. NSF/ANSI 140 at the Gold level,
- 4. Scientific Certifications Systems Sustainable Choice, OR
- 5. California Collaborative for High Performance Schools EQ 2.2 and listed in the CHPS High Performance Product Database AND carpet cushion must meet Carpet and Rug Institute Green Label, AND indoor carpet adhesive & carpet pad adhesive must not exceed 50 g/L VOC content.
- **Resilient flooring systems:** For 80% of floor area receiving resilient flooring, install resilient flooring complying with (CalGreen 4.504.4):
- 1. Certified under the Resilient Floor Covering Institute (RFCI) FloorScore program,
- 2. Compliant with the VOC-emission limits and testing requirements of California Department of Public Health 2010 Standard Method for the Testing and Evaluation Chambers v.1.1,
- 3. Compliant with the Collaborative for High Performance Schools (CHPS) EQ2.2 and listed in the CHPS High Performance Product Database, OR
- 4. Certified under the Greenguard Children & Schools Program to comply with California Department of Public Health criteria.

Composite wood products: Hardwood plywood, particleboard, and medium density fiberboard composite wood products used on interior or exterior shall meet CARB Air Toxics Control Measure for Composite Wood. See CalGreen Table 4.504.5.

Interior paints and coatings: Comply with VOC limits in the Air Resources Board Architectural Coatings Suggested Control Measure and California Code of Regulations Title 17 for aerosol paints. See CalGreen Table 4.504.3.

Low-VOC aerosol paints and coatings: Meet BAAQMD VOC limits (Regulation 8, Rule 49) and Product-Weighted MIR Limits for ROC. (CalGreen 4.504.2.3.)

Low VOC Caulks, Construction adhesives, and Sealants: Meet SCAQMD Rule 1168. See CalGreen Tables 4.504.1 and 4.504.2. (CalGreen 4.504.2.1)

INDOOR WATER USE

All fixtures must not exceed the following flow rates (CalGreen Section 4.303.1):

| Fixture Type | Maximum Prescriptive Flow Rate | Referenced Standard from California Plumbing Code Table 1401.1 | |
|--|---|---|--|
| Showerheads ² | 2.0 gpm @ 80 psi per valve and per showerhead ² | n/a | |
| Lavatory faucets - residential | 1.5 gpm @ 60 psi | n/a | |
| Lavatory faucets - common and public use areas | 0.5 gpm @ 60 psi | n/a | |
| Metering faucets | .25 gallons/cycle | ASME A112.18.1/CSA B125.1 | |
| Kitchen faucets | 1.8 gpm @ 60 psi default, allowed to temporarily increase to 2.2 gpm | n/a | |
| Tank-type water closets | 1.28 gallons/flush ¹ and EPA WaterSense Certified | U.S. EPA WaterSense Tank-Type High-Efficiency Toilet Specification | |
| Flushometer valve water closets | 1.28 gallons/flush ¹ | ASME A112.19.2/CSA B45.1 - 1.28 gal | |
| Urinals | 0.5 gallons/flush | ASME A112.19.2/CSA B45.1 - 0.5 gal | |

A112.19.14 and USEPA WaterSense Tank-Type High Efficiency Toilet Specification – 1.28 gal (4.8 L) 2) The combined flow rate of all showerheads in one shower stall not exceed the maximum flow rate for one showerhead, or the shower shall be designed to allow only one showerhead to be in operation at a time. (CalGreen 4.303.1.3)

EXISTING NONCOMPLIANT PLUMBING FIXTURES

All fixtures that are not compliant with the San Francisco Residential Water Conservation Ordinance that serve or are located within the project area must be replaced with fixtures or fittings meeting the maximum flow rate and standards at left. For more information, see the DBI brochure, "San Francisco's Residential Energy and Water Conservation Requirements", available at SFDBI.org, and also see the "Residential Water Conservation" section of the SFPUC website - SFWATER.org.

Noncompliant plumbing fixtures include:

- Any toilet manufactured for use more than 1.6 gallons of water per flush.
- Any urinal manufactured for use more than 1 gallon of water per flush.
- Any showerhead manufactured to have a flow capacity of more than 2.5 gallons of water per minute.
- Any interior faucet that emits more than 2.2 gallons of water per minute.

Exceptions to this requirement are limited to situations where replacement of fixture(s) would detract from the historic integrity of the building, as determined by the Department of Building Inspection pursuant to San Francisco Building Code Chapter 13A.

Indicate below who is conditioned floor area of Record as describe <1,000 square feet, the required.

FINAL COMPLIANCE

3639 20th st RESIDENTIAL REM **Project Name**

3608/068 Block/Lot

3639 20th st SAN FRANCISCO, Address

Primary Occupa 5,057 SF

Gross Building

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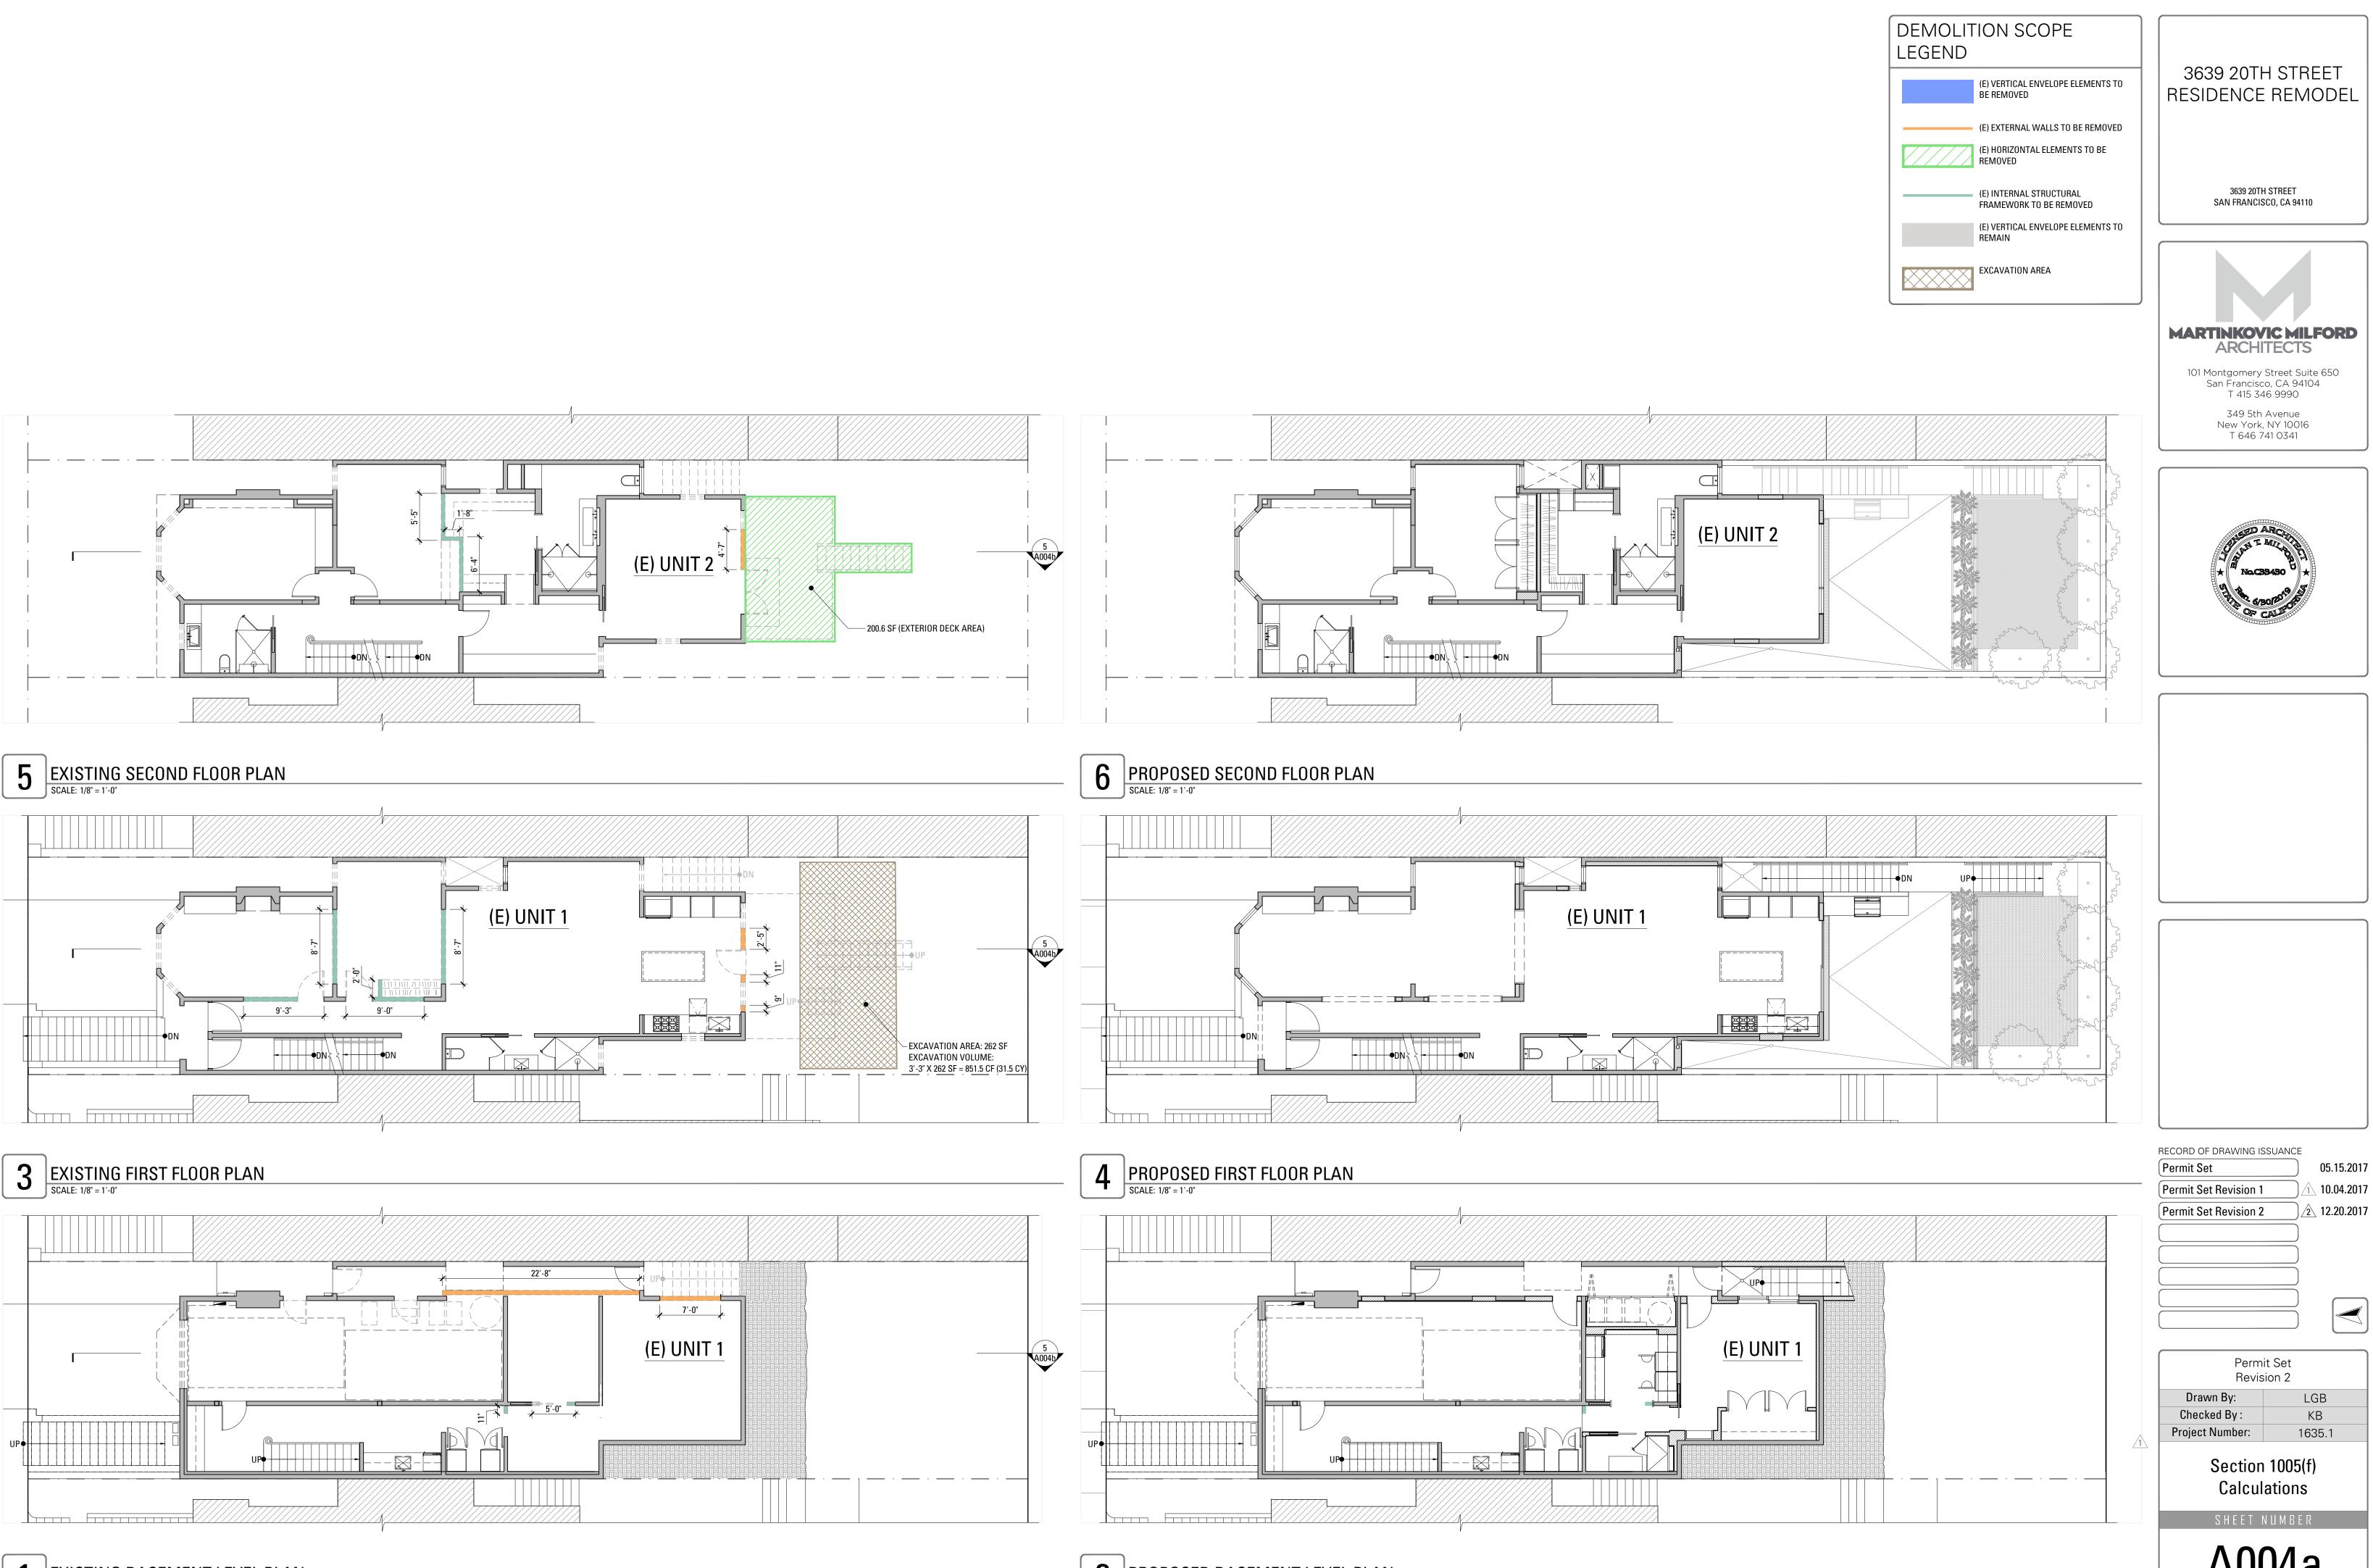
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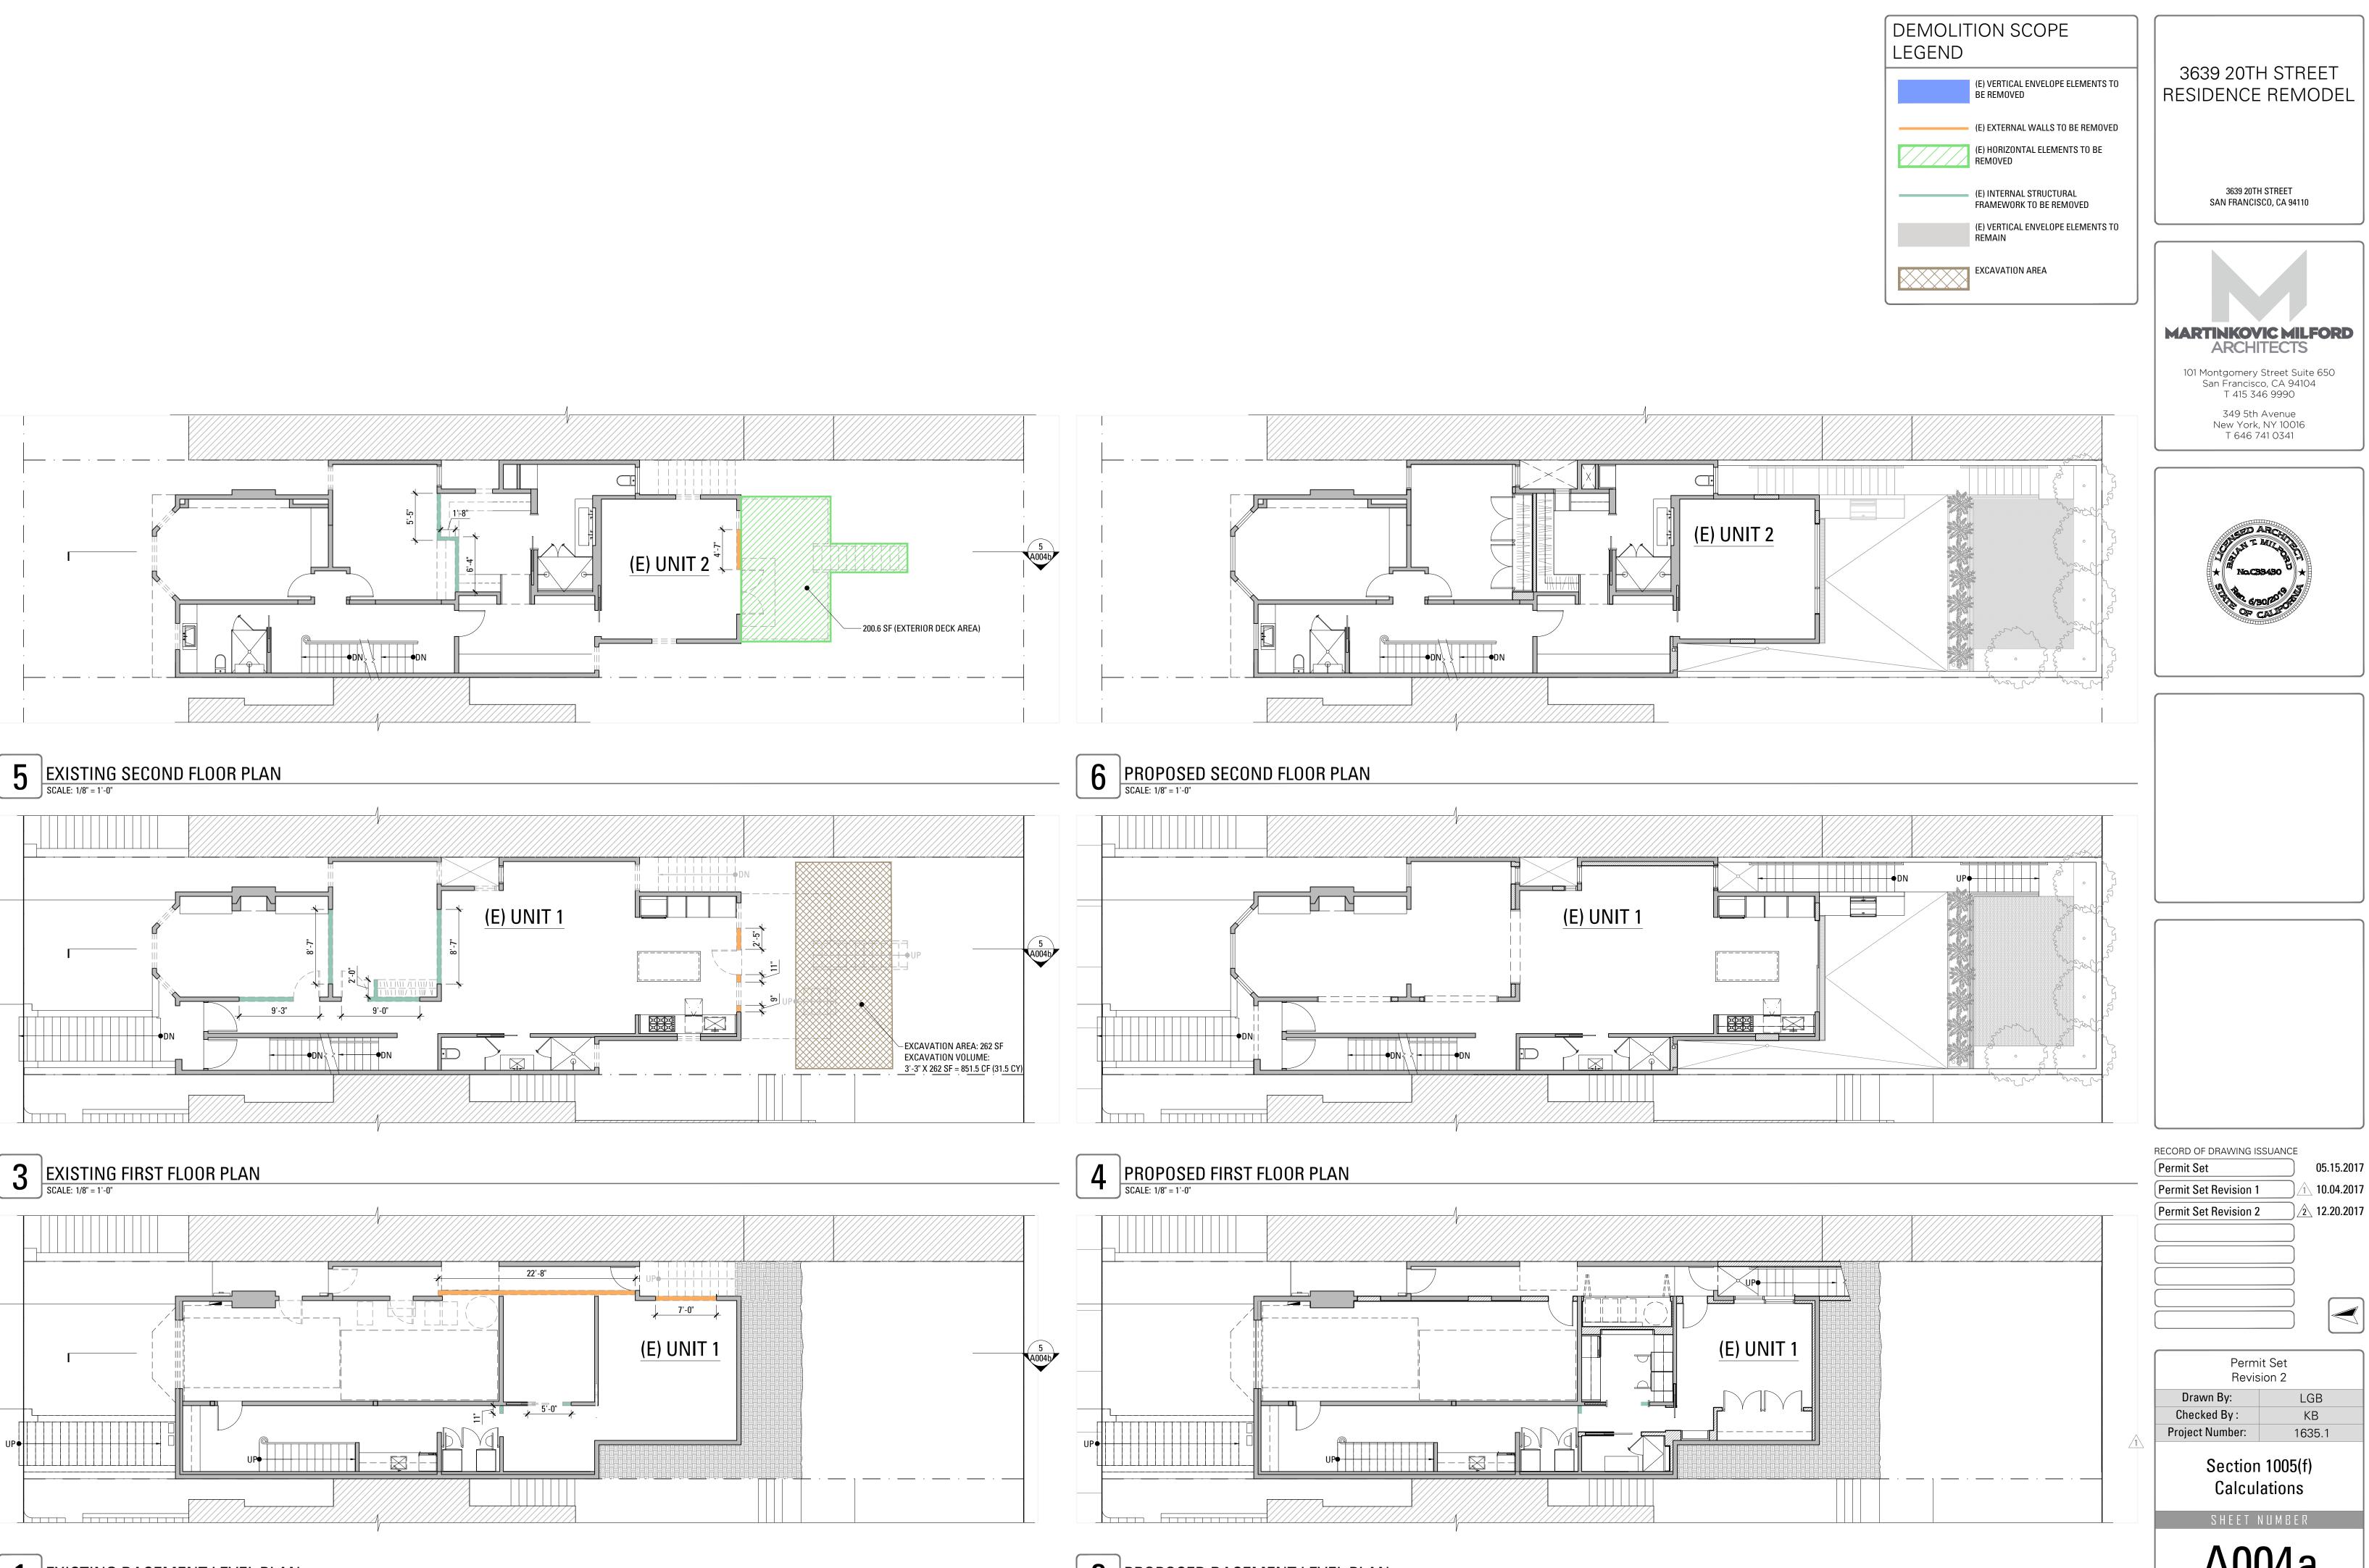
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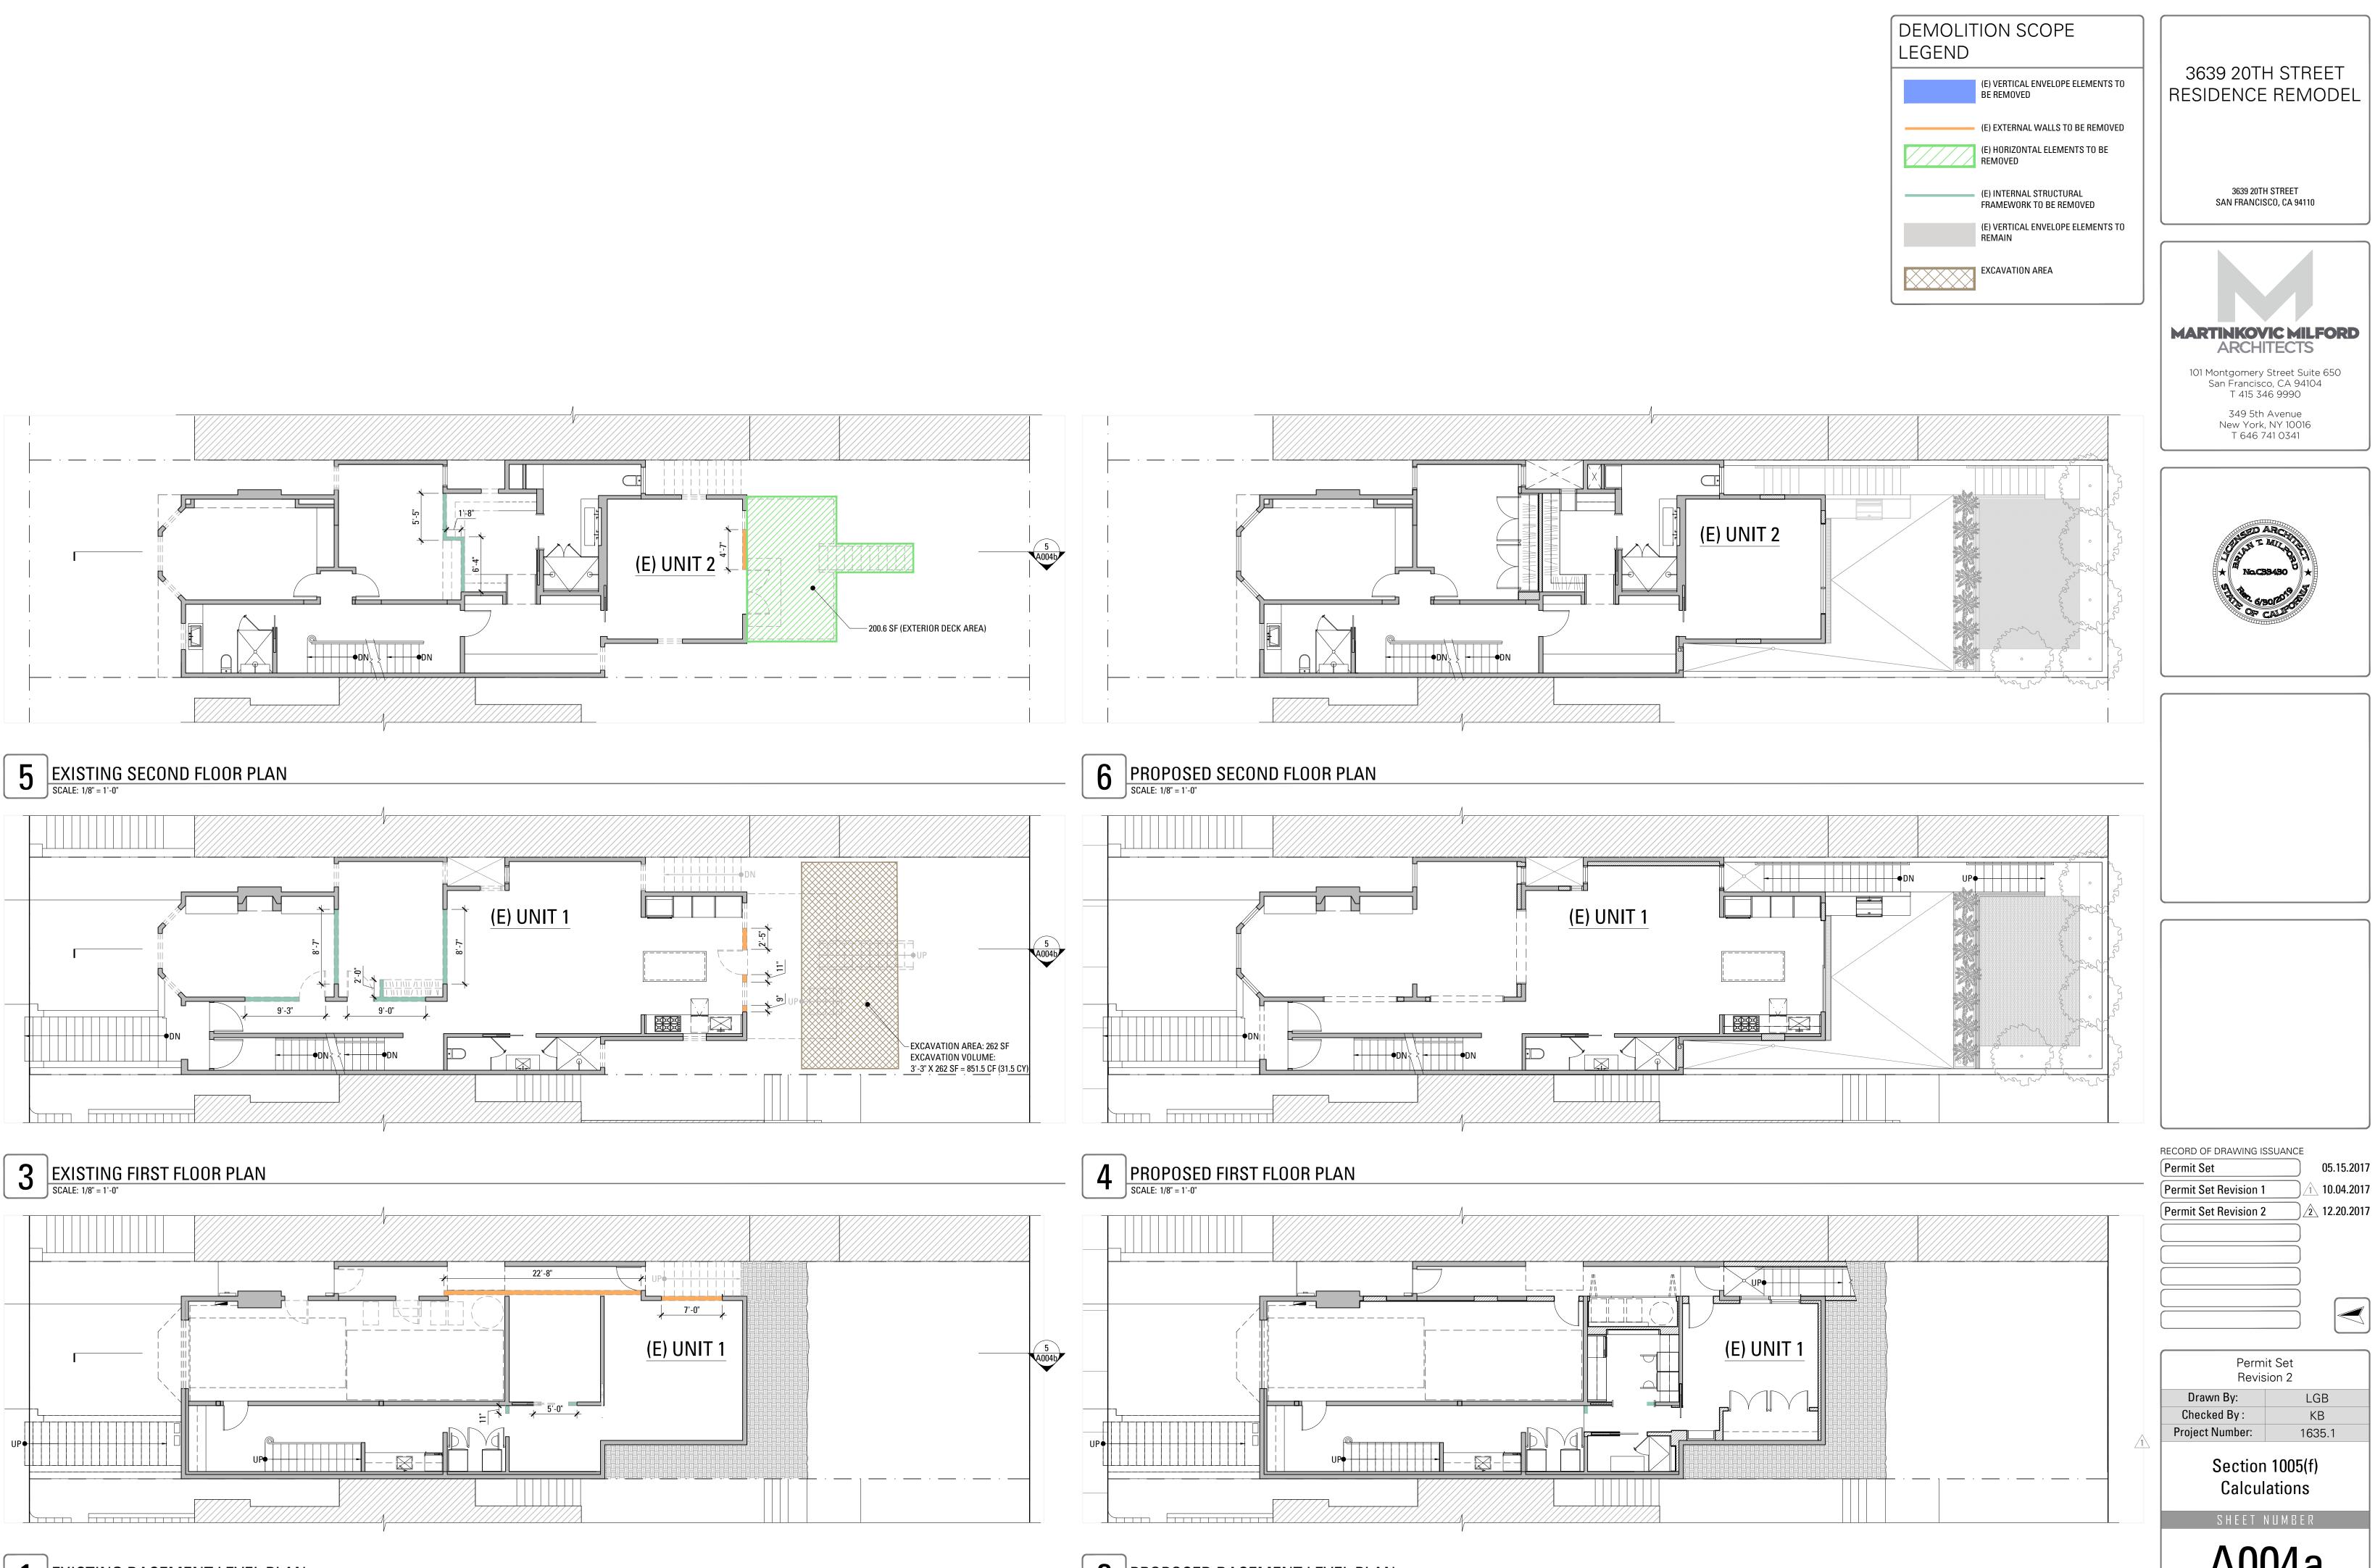
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| | 3639 20TH STREET RESIDENCE REMODEL |
|---|--|
| VERIFICATION responsible for ensuring green building requirements are met. Projects that increase total by ≥1,000 square feet are required to have a Green Building Compliance Professional ed in Administrative Bulletin 93. For projects that increase total conditioned floor area by e applicant or design professional may sign below, and no license or special qualifications are | 3639 20TH STREET SAN FRANCISCO, CA 94110 |
| VERIFICATION form will be required prior to Certificate of Completion. | MARTINKOVIC MILFORD |
| CA 94110 | ARCHITECTS 101 Montgomery Street Suite 650 San Francisco, CA 94104 T 415 346 9990 349 5th Avenue New York, NY 10016 |
| ancy | T 646 741 0341 |
| Area | |
| nditioned Floor Area | CONSELUTION TO MULTING |
| at approved construction documents and construction fulfill the of San Francisco Green Building Code. It is my professional e requirements of the San Francisco Green Building Code will otify the Department of Building Inspection if the project will, for a substantially comply with these requirements, if I am no longer ding Compliance Professional of Record for the project, or if I o longer responsible for assuring the compliance of the project ancisco Green Building Code. | |
| ssional: Sign & Date e applicant when less than 1,000 square feet is added.) | |
| al stamp: | |
| | |
| | RECORD OF DRAWING ISSUANCE Permit Set 05.15.2017 Permit Set Revision 1 1 10.04.2017 |
| crease total conditioned floor area by ≥1,000 square feet: Iding Compliance Professional of Record for this project is: | Permit Set Revision 2 2 12.20.2017 |
| Compliance Professional - Name and Contact Phone Number | |
| Compliance Professional - Firm | Permit Set Revision 2 |
| ED Accredited Professional eenPoint Rater CC Certified CalGreen Inspector | Drawn By:LGBChecked By :KBProject Number:1635.1Attachment C-7 -Residential Addition andAltoration |
| Compliance Professional - Sign & Date | Alteration SHEET NUMBER |
| onal holding at least one of the above certifications is required. If the Licensed Professional does or green design and/or inspection, this section may be completed by another party who will verify ements are met. | A003 |








EXISTING BASEMENT LEVEL PLAN SCALE: 1/8" = 1'-0"




2 PROPOSED BASEMENT LEVEL PLAN SCALE: 1/8" = 1'-0"


A004a

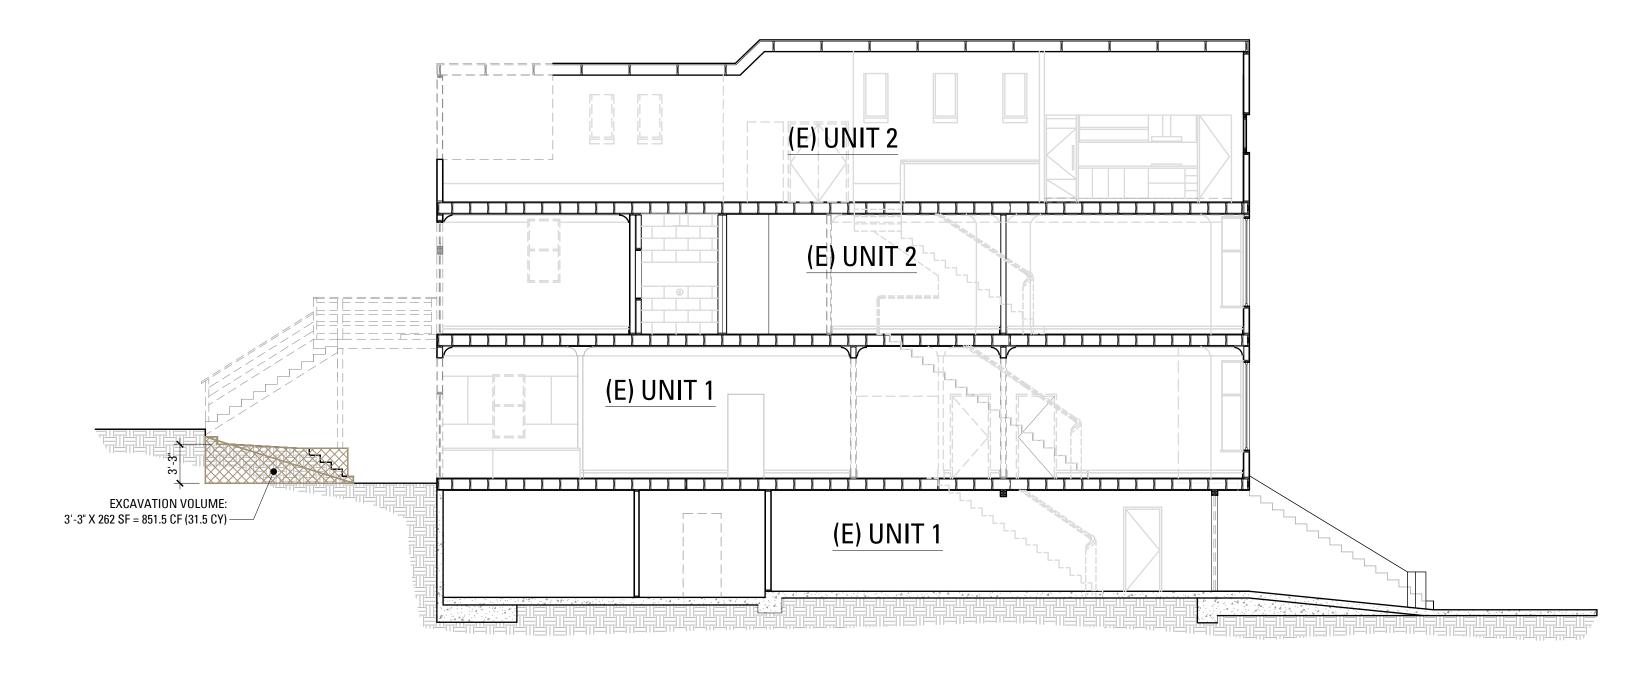

5 EXISTING BUILDING SECTION: 31.5 CY PROPOSED EXCAVATION

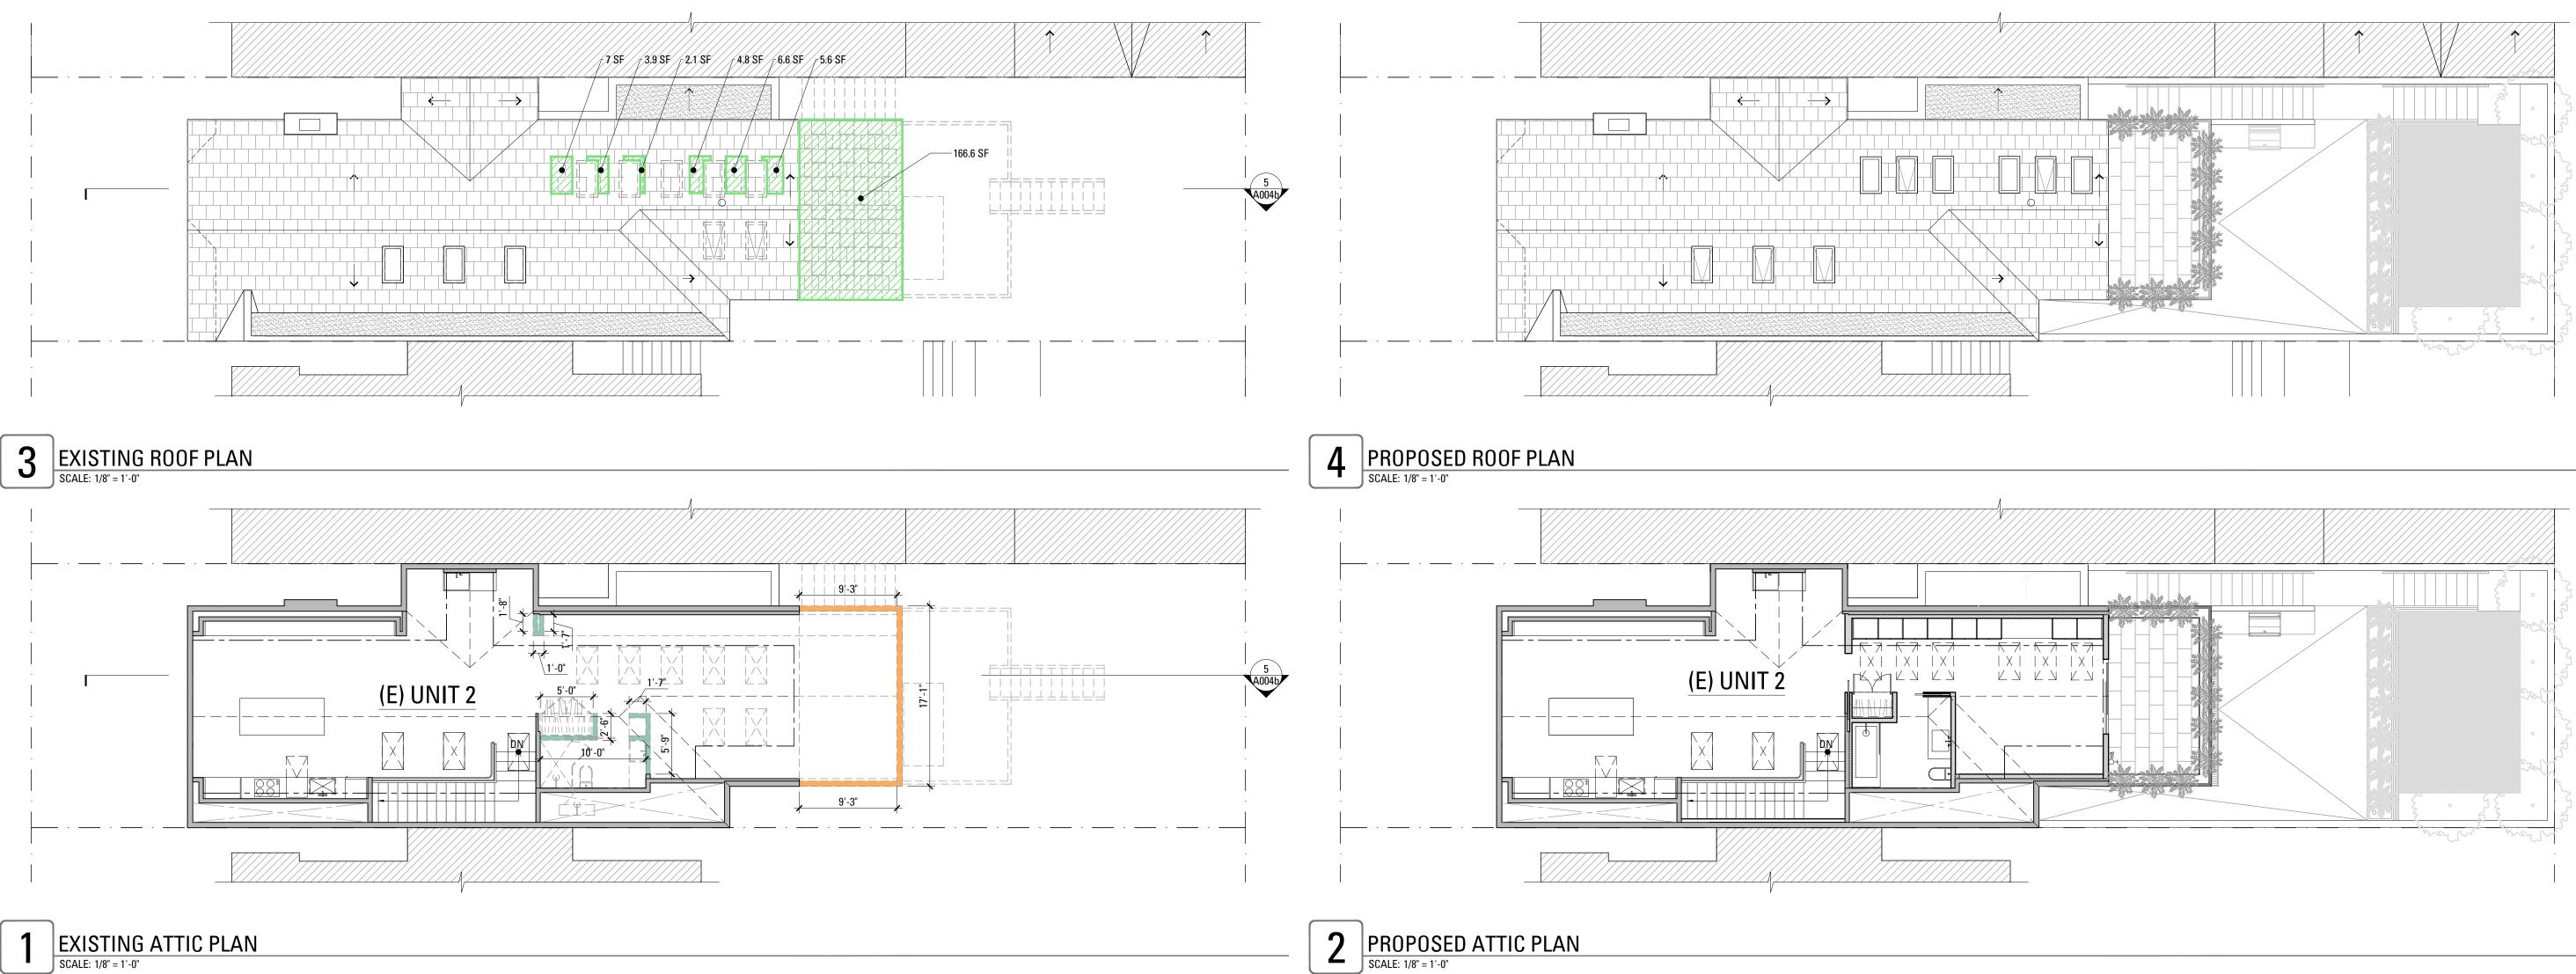



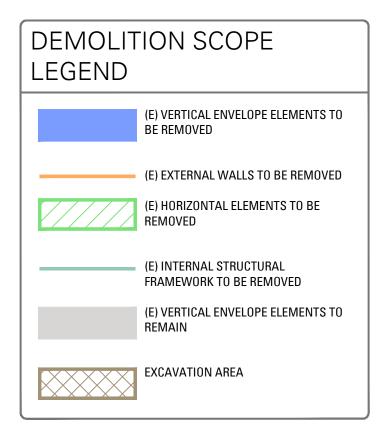



DEMOLITION CALCULATIONS TABLE

| IOVAL OF ELEMENTS DEMOLITION AREA OR LINEAR FT LIMITS | | EXISTING PROJECT TOTAL SF OR LINEAR FT | PROPOSED PROJECT TOTAL % | PROPOSED PROJECT TOTAL SF OR LINEAR FT | MEET PLANNING CODE? | | |
|---|---|--|--------------------------------|---|------------------------|-----|--|
| TICAL ENVELOPE ELEME | ENTS (s.f. of surface | e area) | | | | | |
| FRONT ELEVATION | 0 sf | E00/ or more | | | | | |
| REAR ELEVATION | EAR ELEVATION 112.4 sf (function as | | E 67E 2 of | c 0/ | 010.0 (| VEO | |
| EAST ELEVATION | 199.9 sf | external walls) OR | 5,675.3 sf | 6% | 312.3 sf | YES | |
| WEST ELEVATION | 0 sf | | | | | | |
| ERNAL WALLS (used for external <u>or</u> internal wall functions) | | | | | | | |
| BASEMENT LEVEL | BASEMENT LEVEL 29'-8" | | | | | | |
| FIRST FLOOR SECOND FLOOR | 4'-1" | 25% or more OR | 771'-6" | 10% | 73'-11" | YES | |
| | 4'-7" | | | | | | |
| ATTIC LEVEL | 35'-7" | | | | | | |
| RIZONTAL ELEMENTS (ro | IZONTAL ELEMENTS (roof area, floor plates, except at/below grade) | | | | | | |
| FIRST FLOOR | 0 sf | 75% or more | 5,761.9 sf | 6.9% | 397.2 sf | YES | |
| SECOND FLOOR | 200.6 sf | (combined internal structural frame work or floor | | | | | |
| ATTIC LEVEL | 0 sf | | | | | | |
| ROOF | 196.6 sf | plates) | | | | | |
| ERNAL STRUCTURAL FRAMEWORK (interior partitions, etc.) | | | | | | | |
| BASEMENT LEVEL | 5'-11" | 75% or more | | | 87'-8" | | |
| FIRST FLOOR | 38'-5" | (combined internal | A10' 0" | 010/ | | YES | |
| SECOND FLOOR | 13'-5" | structural frame work or floor | 418'-2" | 21% | | YES | |
| ATTIC LEVEL | 29'-11" | plates) | | | | | |
| | | | | | | | |






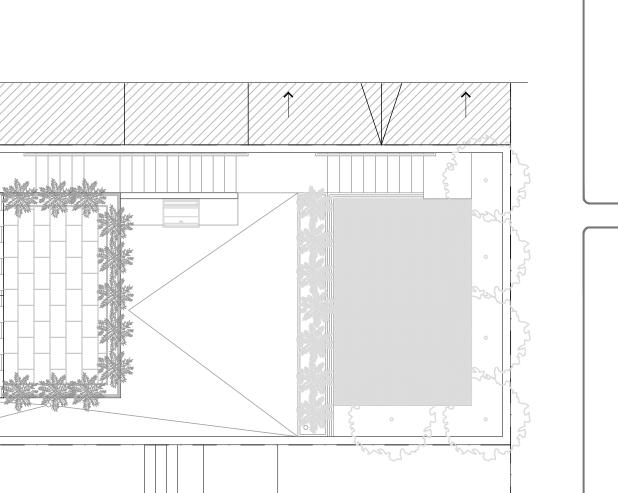

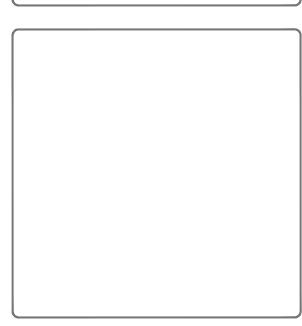

| RECORD OF DRAWING ISSUANCE | | | | |
|---------------------------------|--|--|--|--|
| 05.15.2017 | | | | |
| | | | | |
| 12.20.2017 | | | | |
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| 1635.1 | | | | |
| Section 1005(f) Calculations | | | | |
| SHEET NUMBER | | | | |
| | | | | |
| A004b | | | | |
| | | | | |



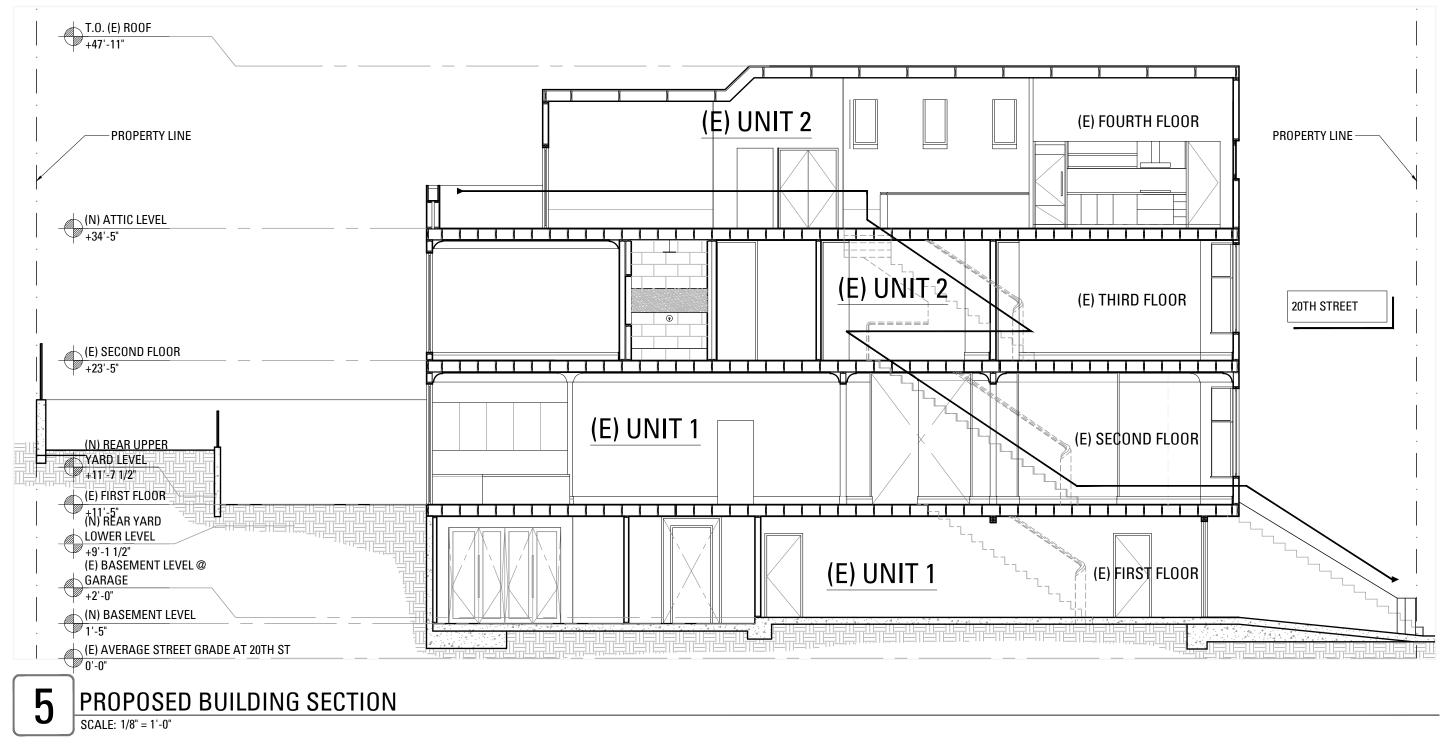

NOTE:


| - | REPRESENTS RESCUE WINDOW |
|---|------------------------------------|
| | REPRESENTS COMMON PATH OF EGRESS |
| | REPRESENTS EXIT ACCESS TRAVEL PATH |


NOTE:


THIS BUILDING IS FULLY FIRE SPRINKLED WITH AN AUTOMATIC SPRINLER SYSTEM IN ACCORDANCE WITH CBC SECTION 903.3.1.1 OR 903.3.1.2 AND PROVIDED WITH EMERGENCY ESCAPE AND RESCUE OPENINGS IN ACCORDANCE WITH CBC SECTION 1030.


| TRAVEL DISTANCE (PER CBC TABLE 1006.3.2(1) | |
|--|---|
| UNIT 1 PATH OF TRAVEL TO PUBLIC WAY FIRST FLOOR: 23'-0" + 9'-0" + 36'-0" " TOTAL COMMON EXIT TRAVEL DISTANCE: 2 EXITS PROVIDED | = <u>68'-0"</u> = <u>68'-0"</u> < 125'-0" |
| UNIT 2 PATH OF TRAVEL FROM ATTIC TO PUBLIC WAY ATTIC: 8'-0"+ 33'-0" + 12'-0" + 13'-0" THIRD FLOOR: 3'-0"+ 4'-6"+ 17'-6" + 4'-6" + 6'-6" SECOND FLOOR: 13'-6" " TOTAL COMMON EXIT TRAVEL DISTANCE: 1 EXIT PROVIDED | = 66'-0" = 36'-0" = 13'-6" = 115'-6" < 125'-0" |
| 1 EXIT PROVIDED | |
| | |



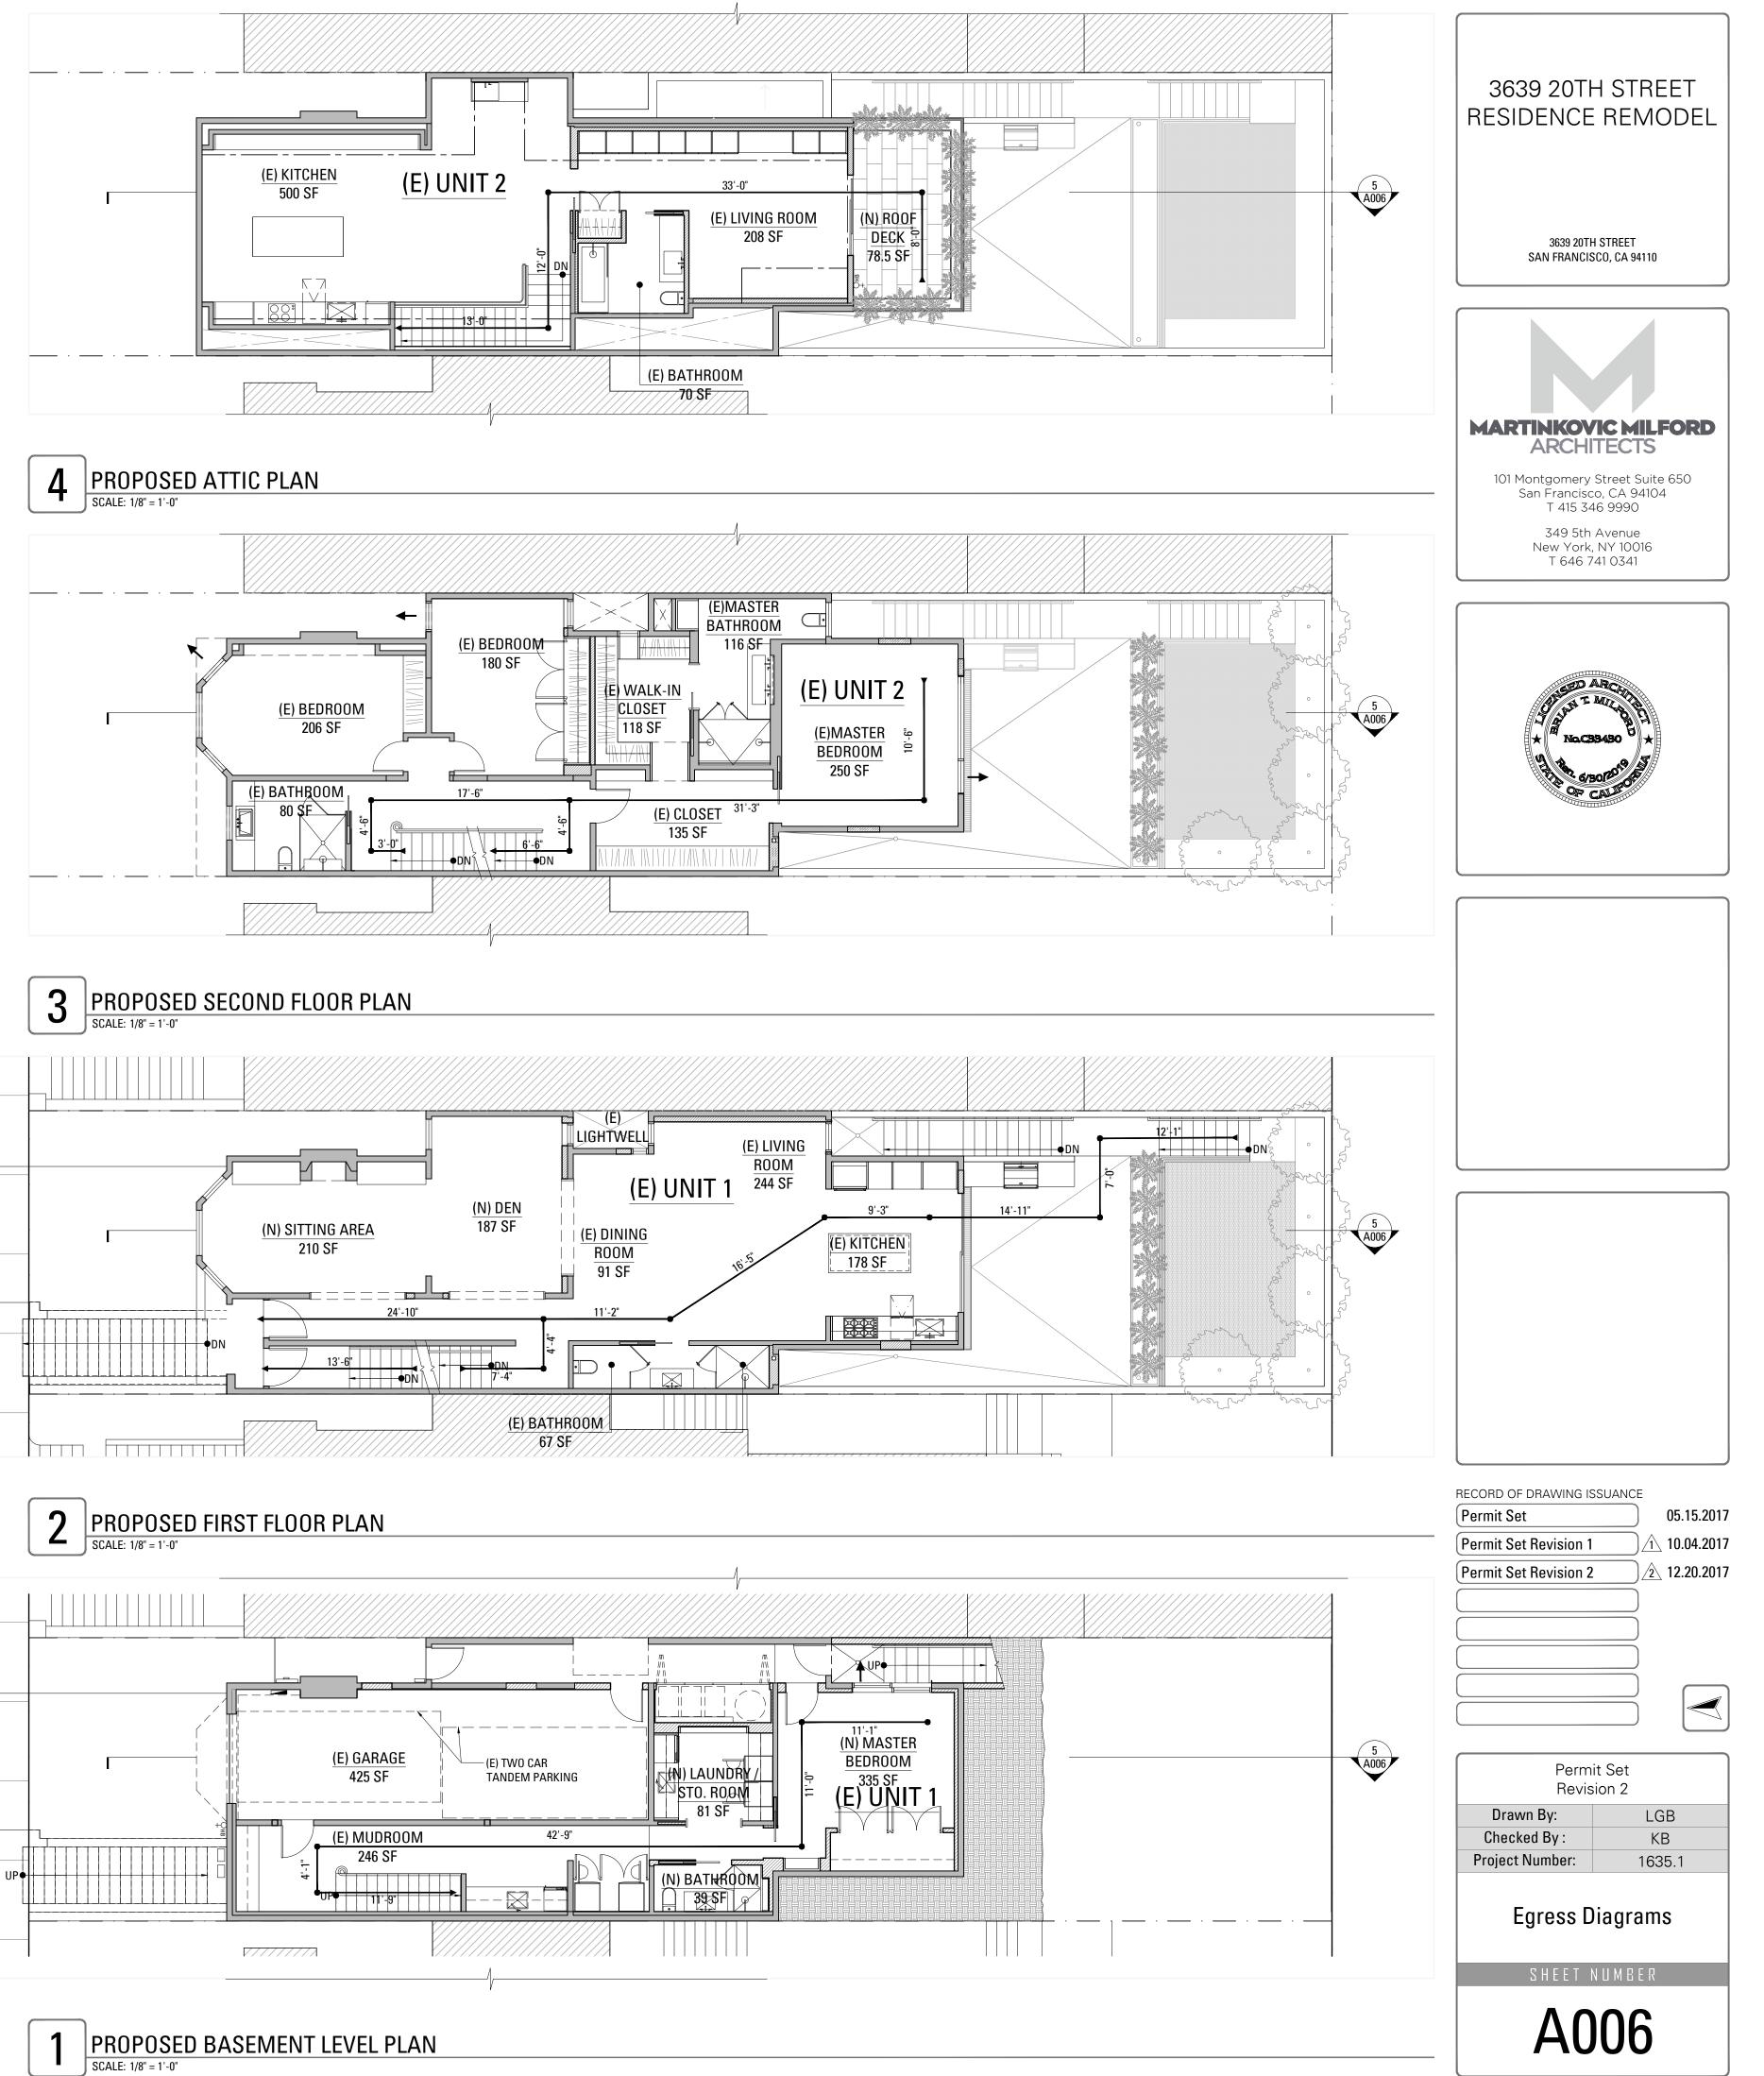

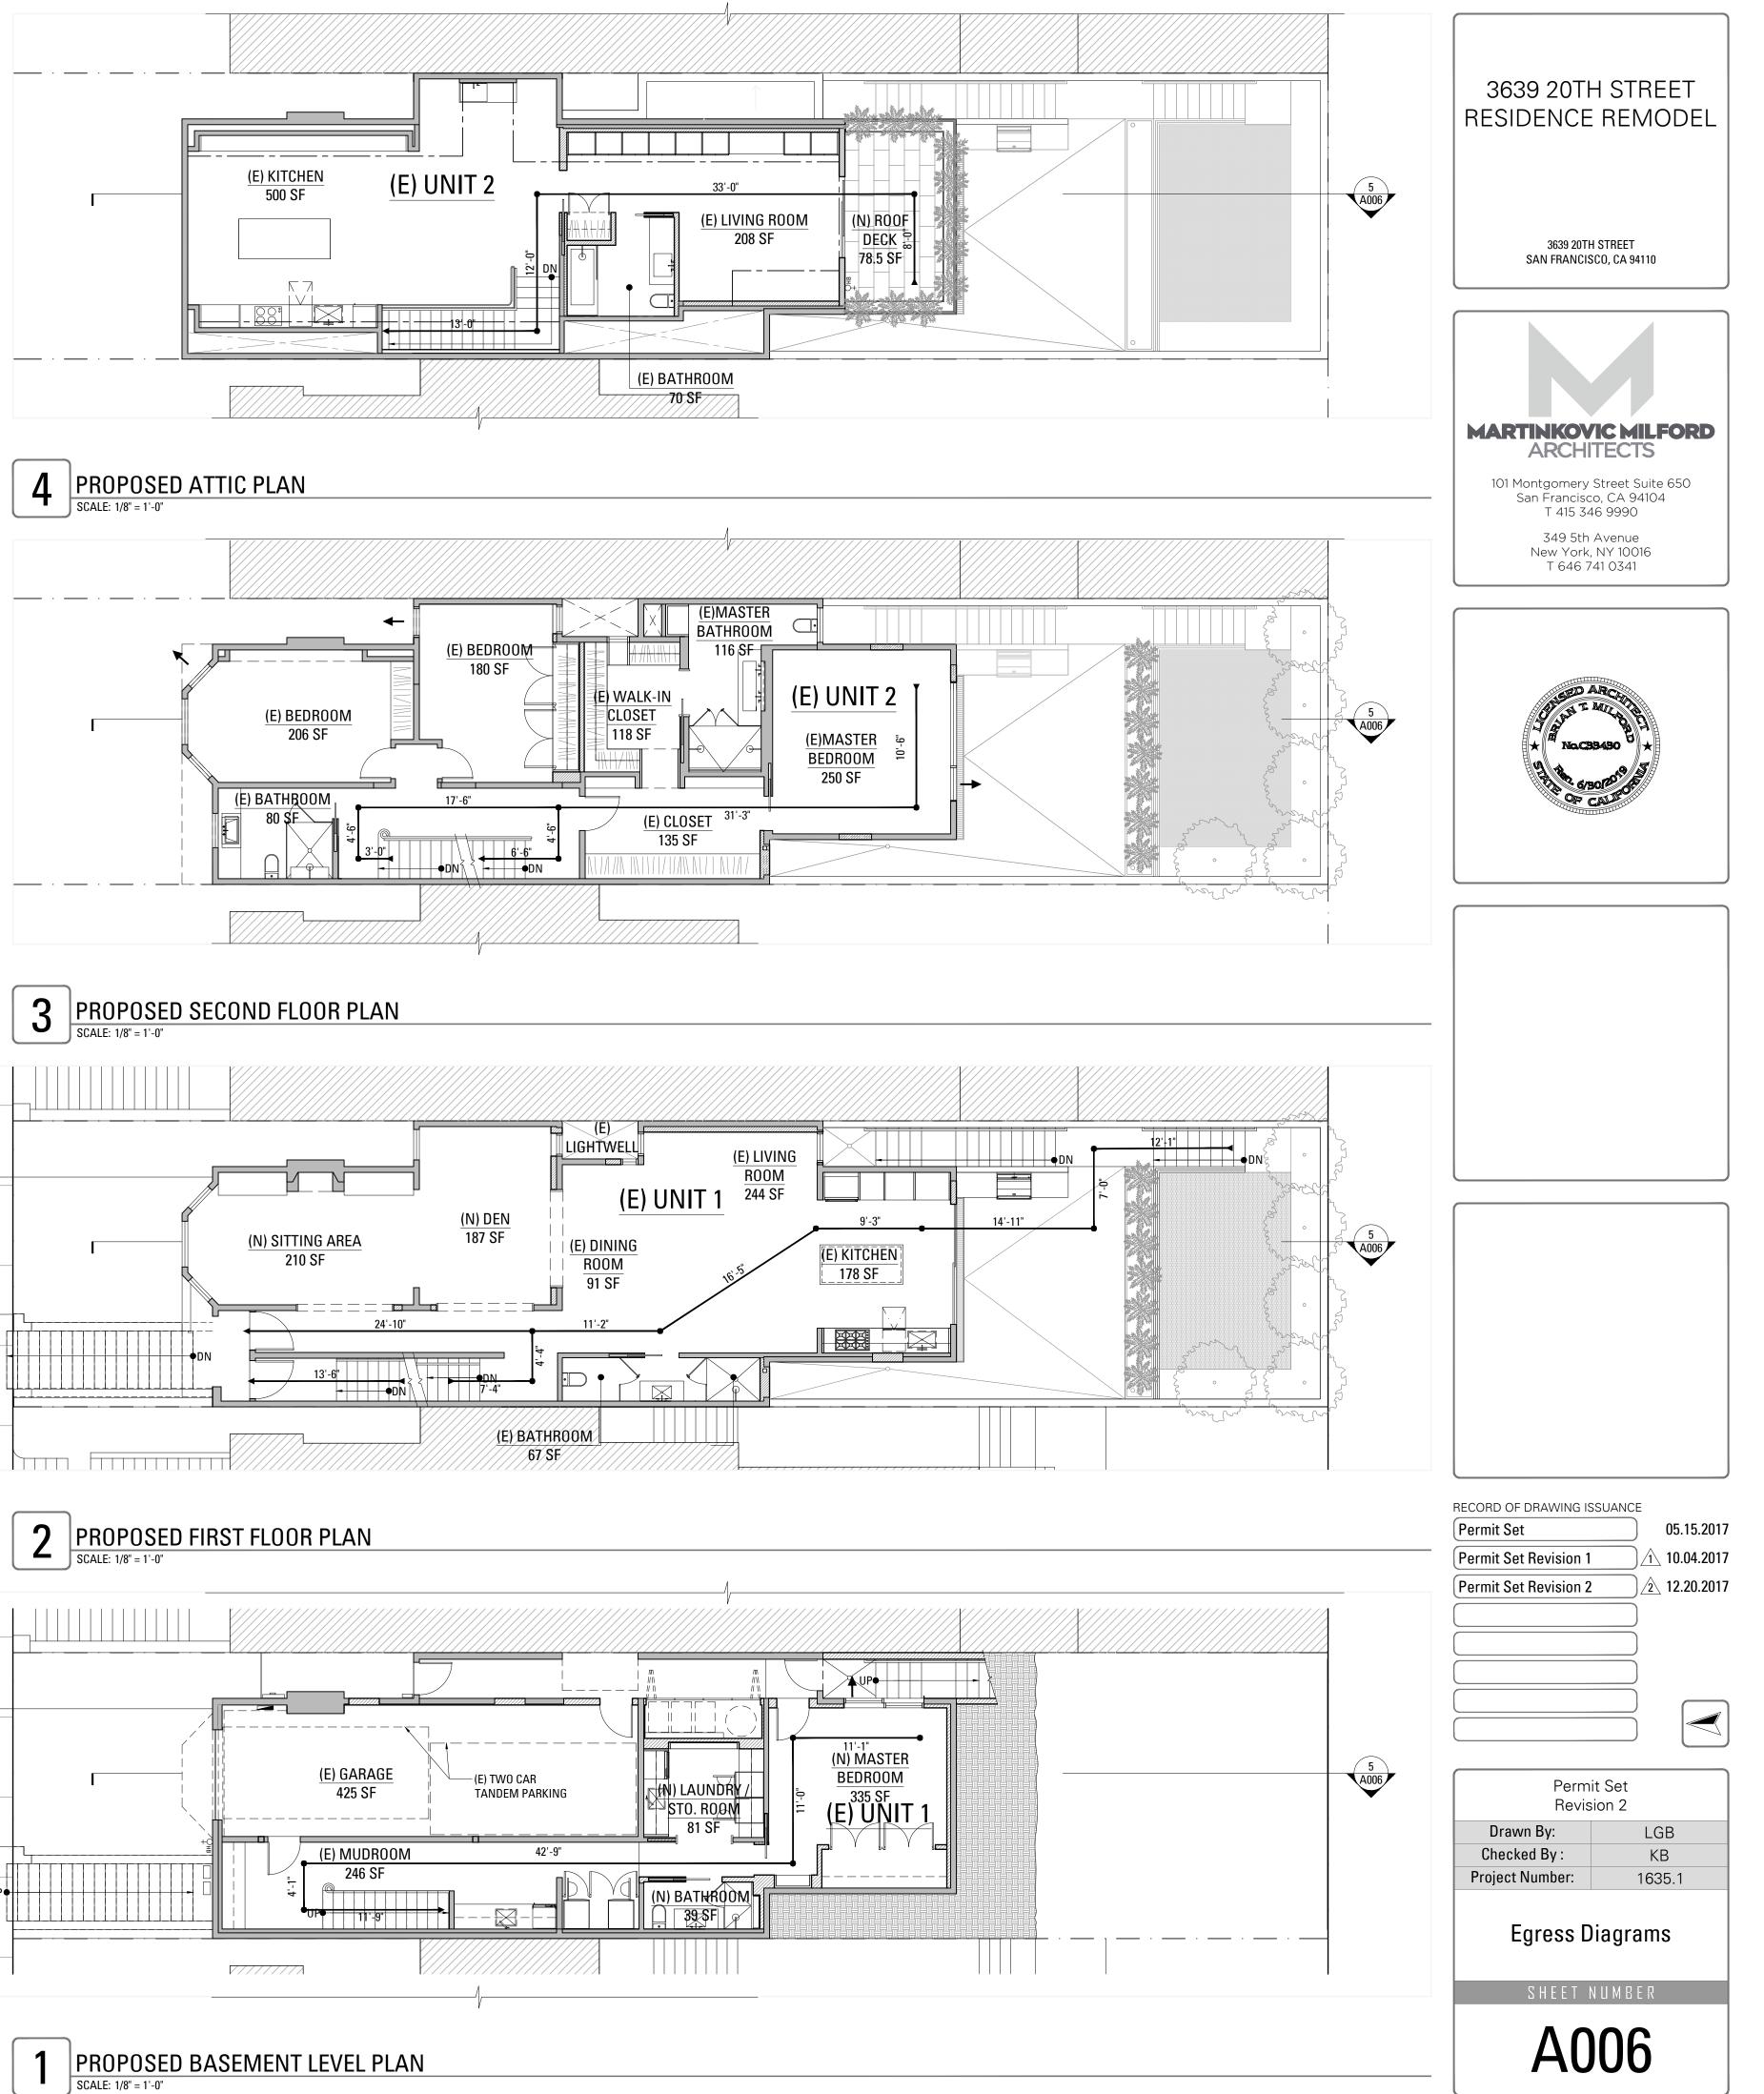

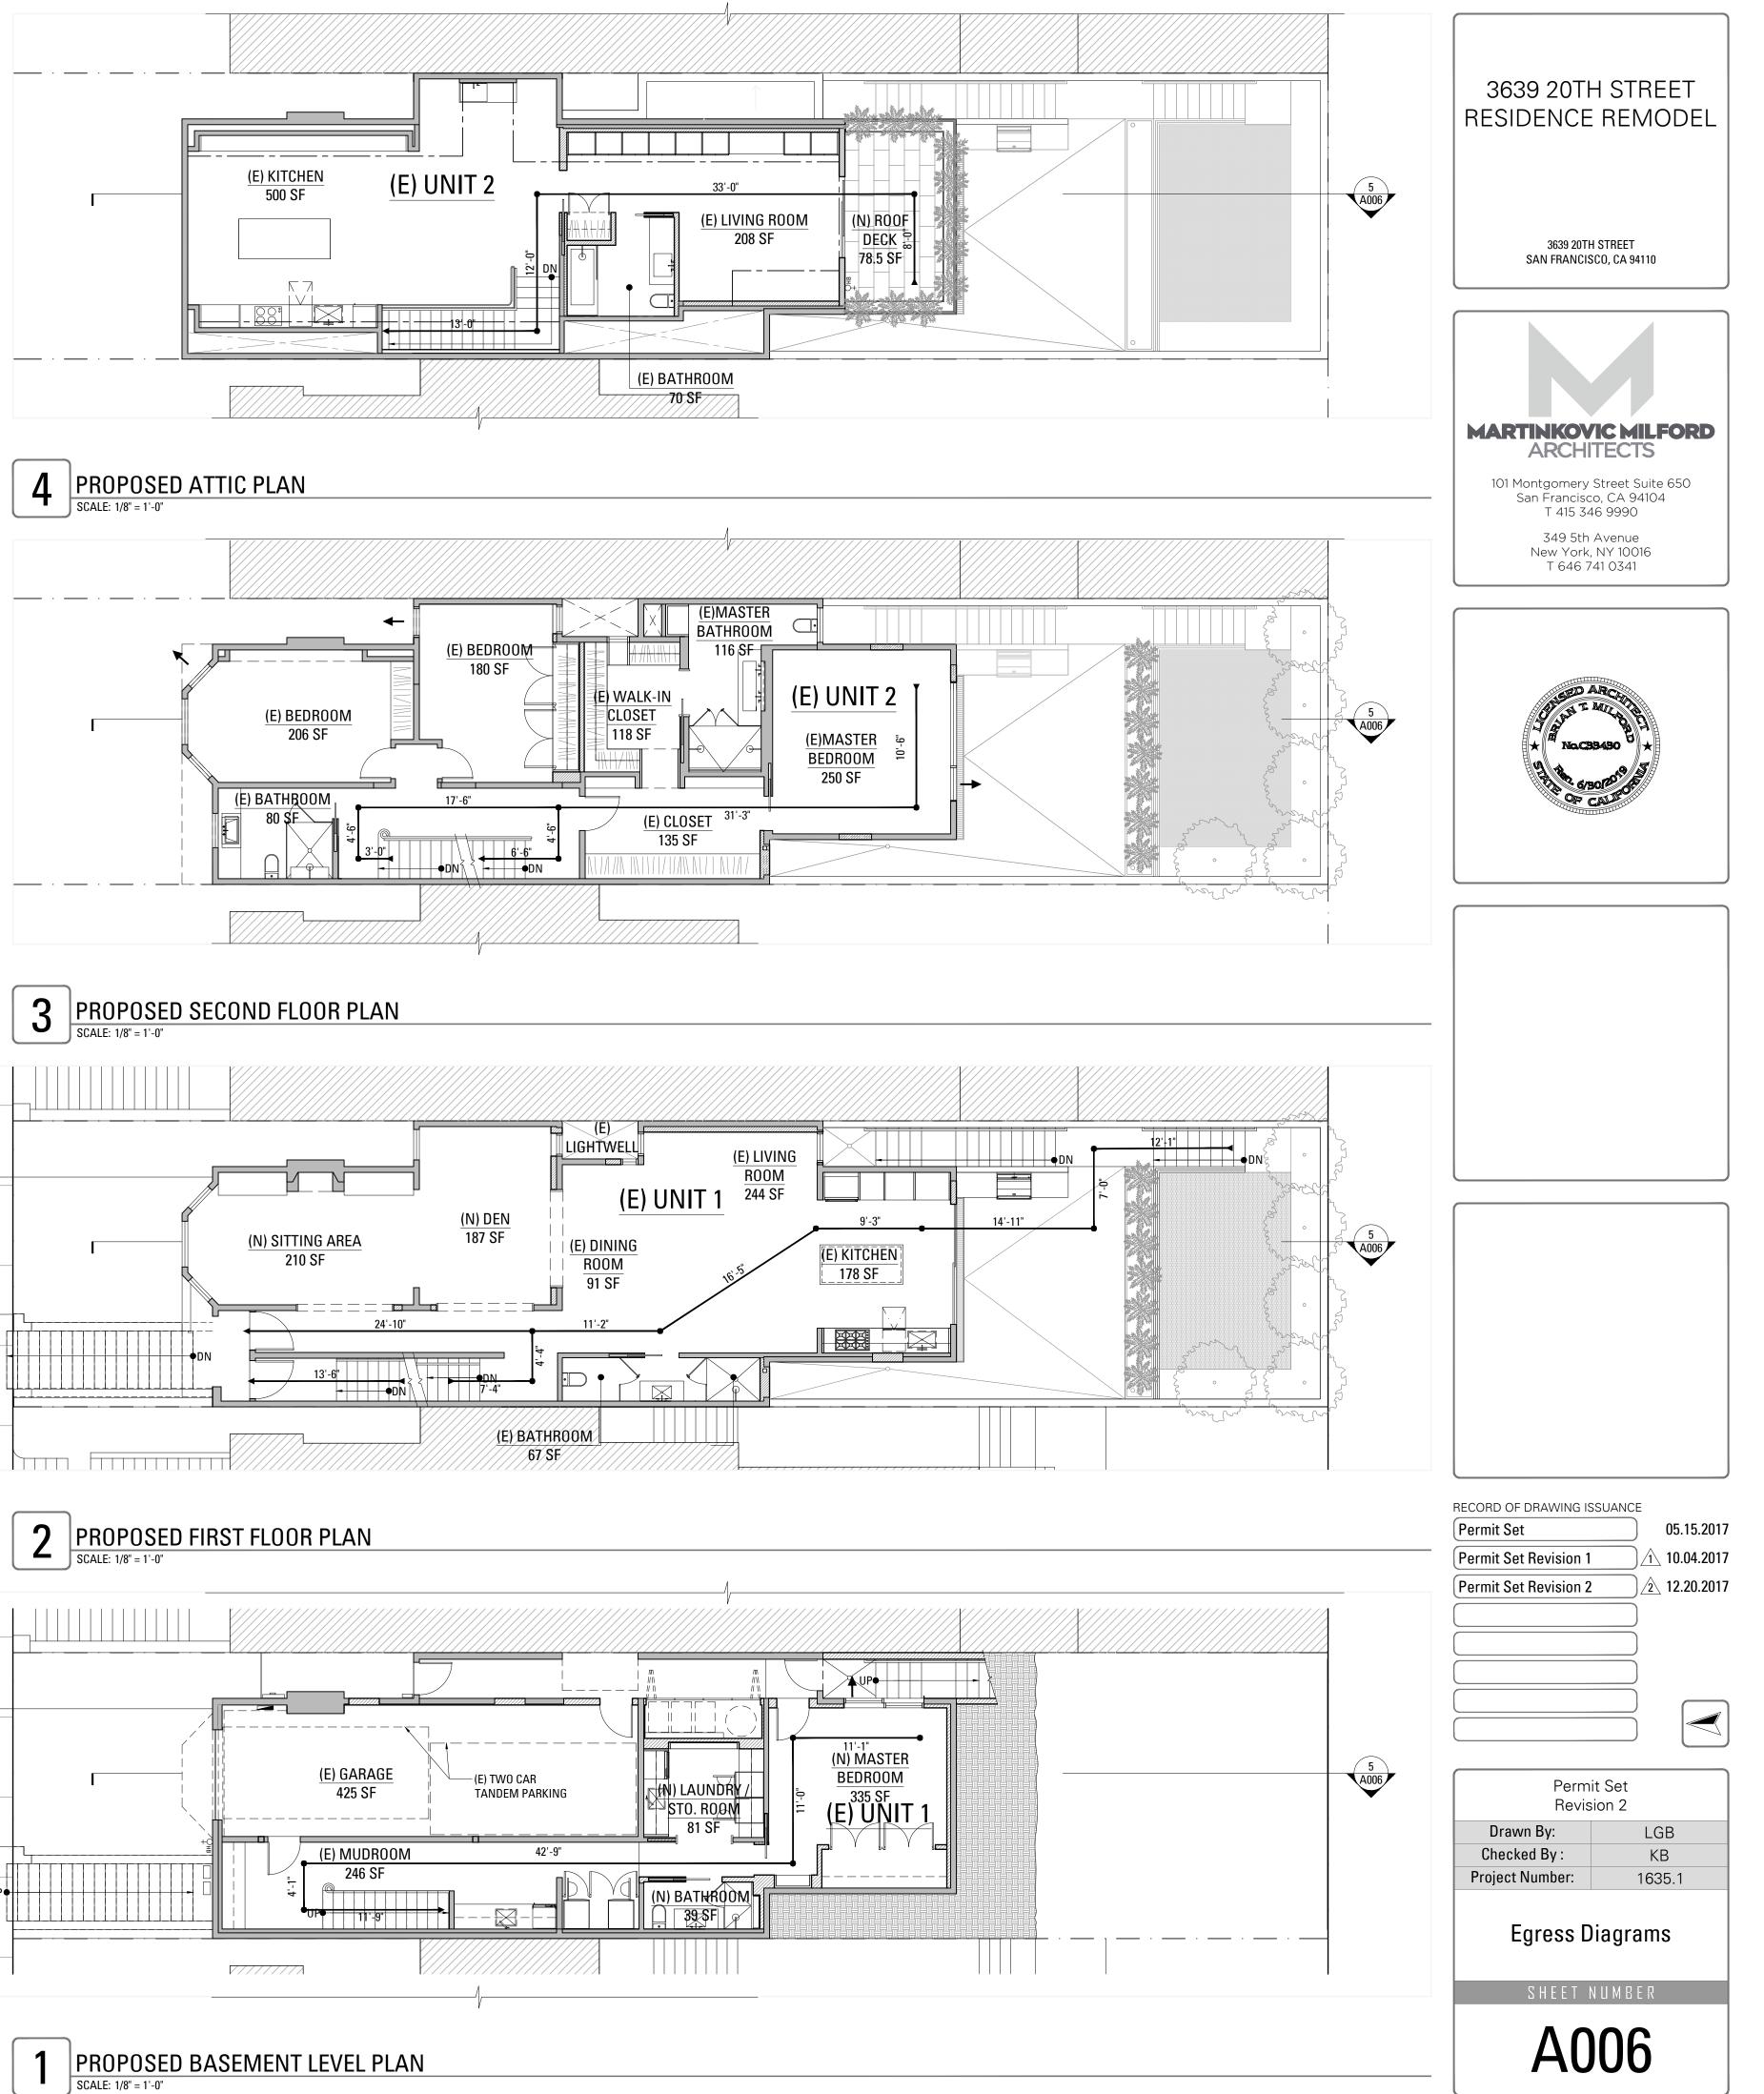

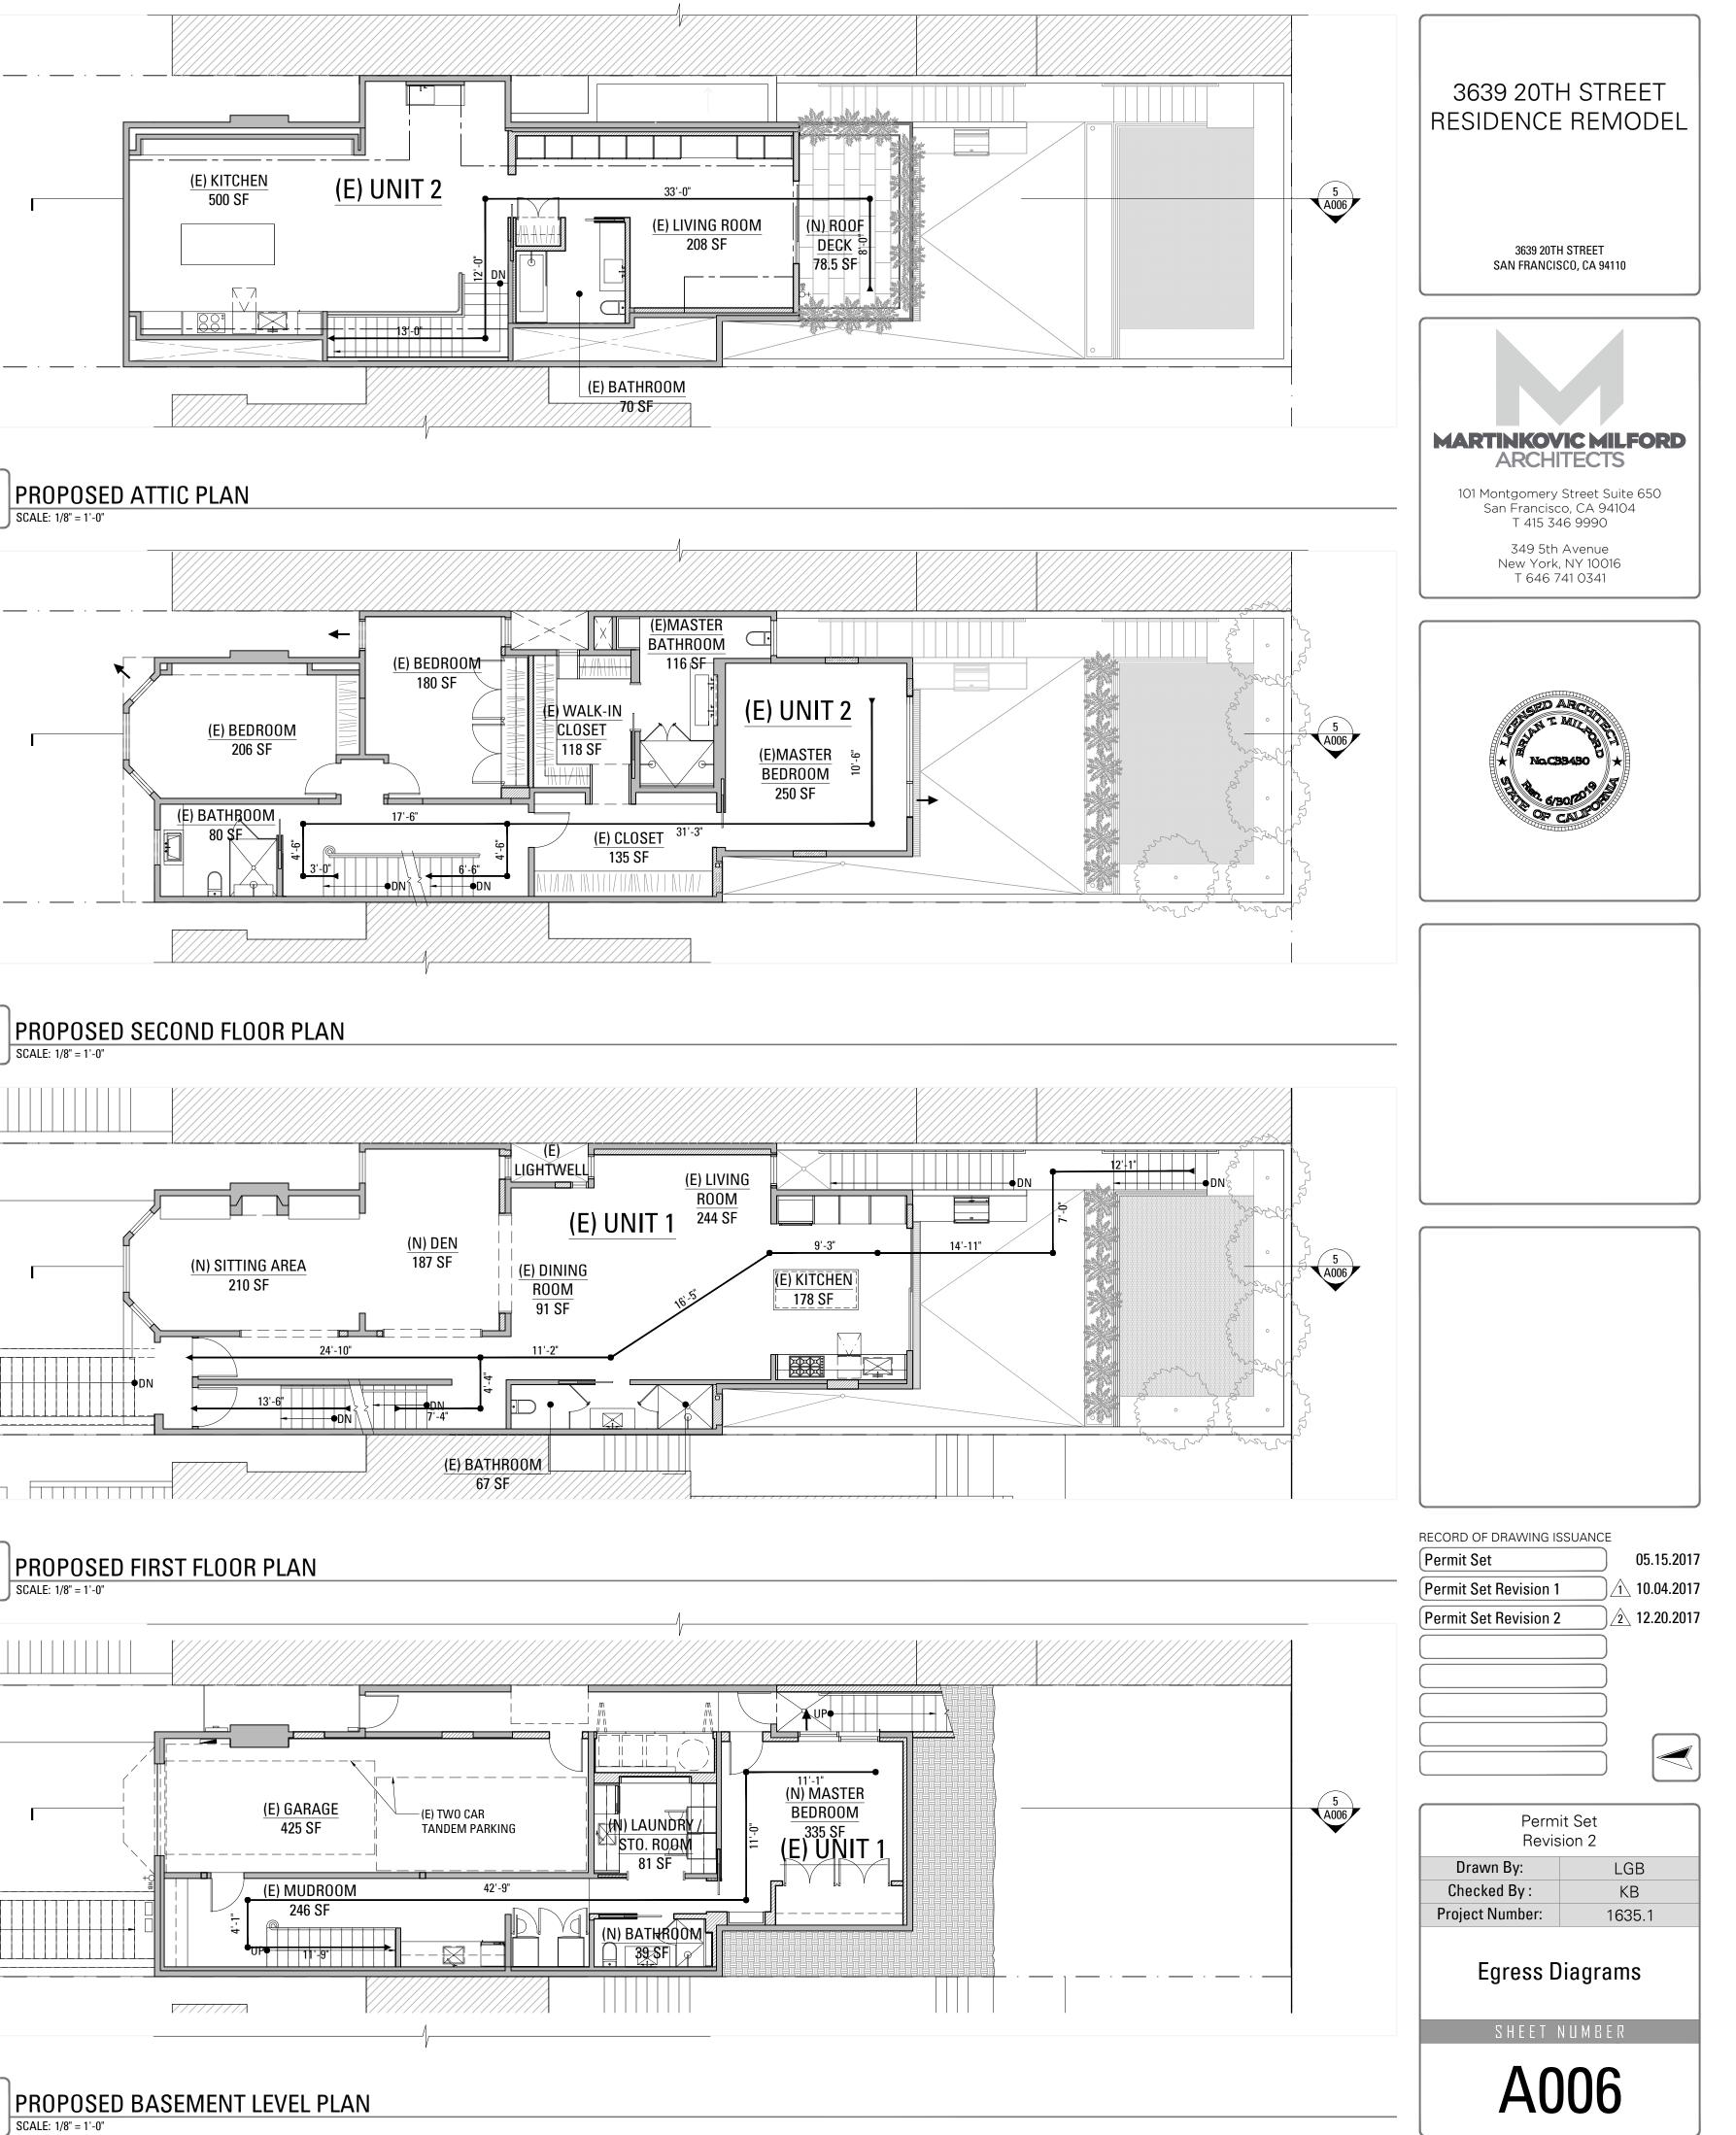

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CONSTRUCTION ENERAL NOTES

ALL (N) WALLS TYPE "A" U.O.N. SEE SCHEDULE, A901. ALL DIMENSIONS ARE TO FACE OF FINISH, CENTERLINE OF OPENING OR EDGE OF JAMB FRAME, U.O.N. DOORS NOT LOCATED BY DIMENSION SHALL BE

PLACED 3" OFF JAMB, U.O.N. ALL REQUIRED HANDRAILS SHALL COMPLY WITH HANDRAIL GRASPABILITY PER CBC 1014.3.

PROVIDE & INSTALL FLASHING, COUNTERFLASHING, CAP FLASHING, METAL TRIM, OTHER FABRICATED ITEMS AND MISCELLANEOUS SHEET METALWORK AT JUNCTIONS OF A ROOF AND WALL, AT CHIMNEYS, OVER EXPOSED DOORS AND WINDOWS, AT CHANGES OF SIDING MATERIAL IN ROOF VALLEYS OR WHERE REQUIRED TO PROVIDE COMPLETE WATERTIGHT AND WATERPROOF CONSTRUCTION.

PROVIDE & INSTALL ONE PIECE GSM PAN FLASHING AT ALL NEW AND REPLACEMENT EXTERIOR DOORS. COMPLY WITH ASTM E2112-07, STANDARD PRACTICE FOR INSTALLATION OF EXTERIOR WINDOWS, DOORS, AND SKYLIGHTS.

WATERPROOFING SHALL OVERLAP FLASHINGS FOR POSITIVE DRAINAGE AT ALL CONDITIONS.

FLASHING & SHEET METALWORK SHALL BE FABRICATED AND INSTALLED IN ACCORDANCE WITH SHEET METAL & AIR CONDITIONING CONTRACTORS NATIONAL ASSOCIATION (SMACNA) ARCHITECTURAL SHEET METAL MANUAL. COMPLY WITH MINIMUM THICKNESS OR GAGE REQUIREMENTS AS SPECIFIED IN SMACNA ARCHITECTURAL SHEET METAL MANUAL. ISOLATE AND PROTECT DISSIMILAR METALS FROM CONTACT WITH EACH OTHER BY APPLYING SPECIFIED ISOLATION MATERIAL TO CONTACT SURFACES. PROTECT SURFACES OF SHEET METAL IN CONTACT WITH CONCRETE, TREATED WOOD, OR ALUMINUM WITH A HEAVY COATING OF BITUMINOUS PAINT AS RECOMMENDED BY MANUFACTURER/FABRICATOR. FLASHING & SHEET METALWORK WILL NOT BE MEASURED SEPARATELY FOR PAYMENT BUT WILL BE PAID FOR AS PART OF THE CONTRACT LUMP SUM PRICE FOR ARCHITECTURAL WORK.

PROVIDE MINIMUM OF R-13 BATT INSULATION IN EXTERIOR WALLS ADJACENT TO (N) AND (E) LIVING SPACE, IN AREAS NOT ALREADY INSULATED PROVIDE CEMENT BOARD BACKING IN AREAS TO RECEIVE TILE FINISH

WOOD LOCATED NEARER THAN 6" TO EARTH SHALL BE TREATED WOOD ALL DOORS AND WINDOWS NOT TAGGED ARE

EXISTING TO REMAIN U.O.N. ALL TOILETS TO HAVE A MINIMUM CLEARANCE OF 24"

IN FRONT AND 15" FROM CENTERLINE OF THE TOILET TO EACH SIDE. STAIRWAYS SHALL HAVE A MINIMUM HEADROOM

CLEARANCE OF 80 INCHES ABOVE THE FRONT EDGE OF THE NOSING. ALL APPLIANCES WITH QUICK-ACTING VALVES, INCLUDING BUT NOT LIMITED TO DISHWASHERS &

CLOTHES WASHERS, SHALL HAVE WATER HAMMER ARRESTORS (CPC 609.10) ALL EXISTING NON-COMPLIANT AND NEW PLUMBING

FIXTURES SHALL COMPLY WITH CALIFORNIA SB-407 2009)

WATER HEATERS SHALL HAVE SEISMIC STRAPPING AT A POINT WITHIN THE UPPER 1/3 AND THE LOWER 1/3 OF THE WATER HEATER'S VERTICAL DIMENSIONS. AT THE LOWER POINT, A MINIMUM DISTANCE OF FOUR (4) INCHES SHALL BE MAINTAINED ABOVE THE CONTROLS TO THE STRAP. (CPC 507.2)

HOUSEHOLD COOKING APPLIANCES SHALL HAVE A VERTICAL CLEARANCE ABOVE THE COOKING TOP OF NOT LESS THAN 30 INCHES TO COMBUSTIBLE MATERIAL OR METAL CABINETS. (CMC 921.3.2) EACH KITCHEN IS REQUIRED TO HAVE AN EXHAUST FAN DUCTED TO THE OUTSIDE WITH A MINIMUM

VENTILATION RATE OF 100 CFM. ALL EXHAUST FAN DUCTING, INCLUDING BUT NOT LIMITED TO TO KITCHEN AND BATHROOM EXHAUST FANS, SHALL BE SIZED ACCORDING TO ASHRAE STANDARD 62.2 TABLE 7.1.

APPLIANCES IN ATTIC AND UNDER-FLOOR SPACES SHALL BE ACCESSIBLE THROUGH AN OPENING AND PASSAGEWAY AT LEAST AS LARGE AS THE LARGEST COMPONENT OF THE APPLIANCE, AND NOT LESS THAN 22 INCHES BY 30 INCHES. (CPC 508.4)

APPLIANCES IN ATTIC AND UNDER-FLOOR SPACES SHALL HAVE A SOLID FLOOR PASSAGEWAY OF NOT LESS THAN 24 INCHES AND A WORK PLATFORM OF NOT LESS THAN 30 INCHES BY 30 INCHES IN FRONT OF THE SERVICE SIDE OF THE APPLIANCE. (CPC 508.4.2 & 508.4.3)

APPLIANCES IN ATTIC AND UNDER-FLOOR SPACES SHALL HAVE A PERMANENT 120-VOLT RECEPTACLE OUTLET AND A LIGHTING FIXTURE NEAR THE APPLIANCE. (CPC 508.4.4)

CHANICAL NERAL NOTES

NVIRONMENTAL AIR DUCTS TERMINATE 3' FROM PROPERTY LINE & OPENINGS INTO BUILDING, AND NOT ESS THAN 10 FEET FROM A FORCED AIR INLET. (CMC 02.2)


PROVIDE GAS VENT TERMINATIONS PER CMC 802.6 & 02.6.2 PROVIDE COMBUSTION AIR PER CMC CHAPTER 7.


PROVIDE SPACE HEATING TO ALL INTERIOR SPACES NTENDED FOR HUMAN OCCUPANCY.


EXISTING & DEMOLITION NOTES


CONTRACTOR SHALL COORDINATE THE EXTENT OF THE DEMOLITION WITH CONSTRUCTION PLANS AND PROTECT ALL PORTIONS OF (E) STRUCTURE TO REMAIN

- REMOVE ALL (E) FINISHES, HARDWARE, EQUIPMENT, CONDUIT, PLUMBING, AND FRAMING NECESSARY TO ACCOMMODATE ALL NEW WORK
- CAP OFF ALL PLUMBING, GAS, & ELECTRICAL LINES AS REQUIRED.
- CONTRACTOR SHALL ENSURE THE STABILITY OF ALL (E) STRUCTURE, FRAMING AND FOUNDATIONS TO REMAIN DURING DEMOLITION AND CONSTRUCTION OF NEW WORK
- CONTRACTOR SHALL REPLACE ALL DAMAGED OR DECAYED EXISTING WOOD FRAMING , FLOOR, OR SHEATHING IN AREAS OF REMODEL AND REPAIR. NOTIFY ARCHITECT IF DAMAGED OR DECAYED CONDITIONS ARE ENCOUNTERED PRIOR TO COMMENCING REPAIR WORK.
- CONTRACTOR SHALL BE SOLEY RESPONSIBLE FOR SAFE REMOVAL AND DISPOSAL OF ALL MATERIALS NOT FOR RE-USE ON THIS PROJECT. RECYCLE AND HAUL ALL DEBRIS IN ACCORDANCE WITH LOCAL JURISDICTION REQUIREMENTS & APPLICABLE LAWS.
- DOCUMENTATION HEREIN DOES NOT AUTHORIZE, DESCRIBE, REQUIRE OR INCLUDE THE REMOVAL OF ANY HAZARDOUS MATERIALS OR ELEMENTS, INCLUDING, BUT NOT LIMITED TO LEAD PAINT, ASBESTOS AND PCB'S. GENERAL CONTRACTOR SHALL COMPLY WITH ALL APPLICABLE LAWS, REGULATIONS, ORDINANCES AND RULES RELATING TO ANY HAZARDOUS OR TOXIC MATERIALS. IF GENERAL CONTRACTOR DISCOVERS ANY SUCH MATERIALS ON THE PROPERTY, GENERAL CONTRACTOR SHALL PROMPTLY NOTIFY THE OWNER. ANY REMOVAL OF HAZARDOUS MATERIALS SHALL BE DOCUMENTED SEPARATELY, AND SHALL OCCUR AS REQUIRED BY CODE AND REGULATORY REQUIREMENTS.

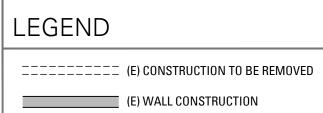

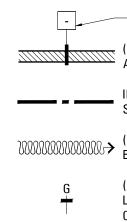

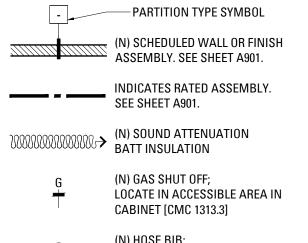

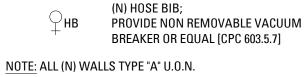










RECORD OF DRAWING ISSUANCE

| Permit Set |) | 05.15.20 | 17 |
|-----------------------|-----|----------|----|
| Permit Set Revision 1 |)/1 | 10.04.20 | 17 |
| Permit Set Revision 2 |) 🖄 | 12.20.20 | 17 |
| |) | | |
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| Permit Set | | | |
| Devision 0 | | | |

| Revision 2 | | |
|--|--------|--|
| Drawn By: | LGB | |
| Checked By : | KB | |
| Project Number: | 1635.1 | |
| Demolitions & Construction Notes and Schedules | | |
| SHEET NUMBER | | |
| A100 | | |

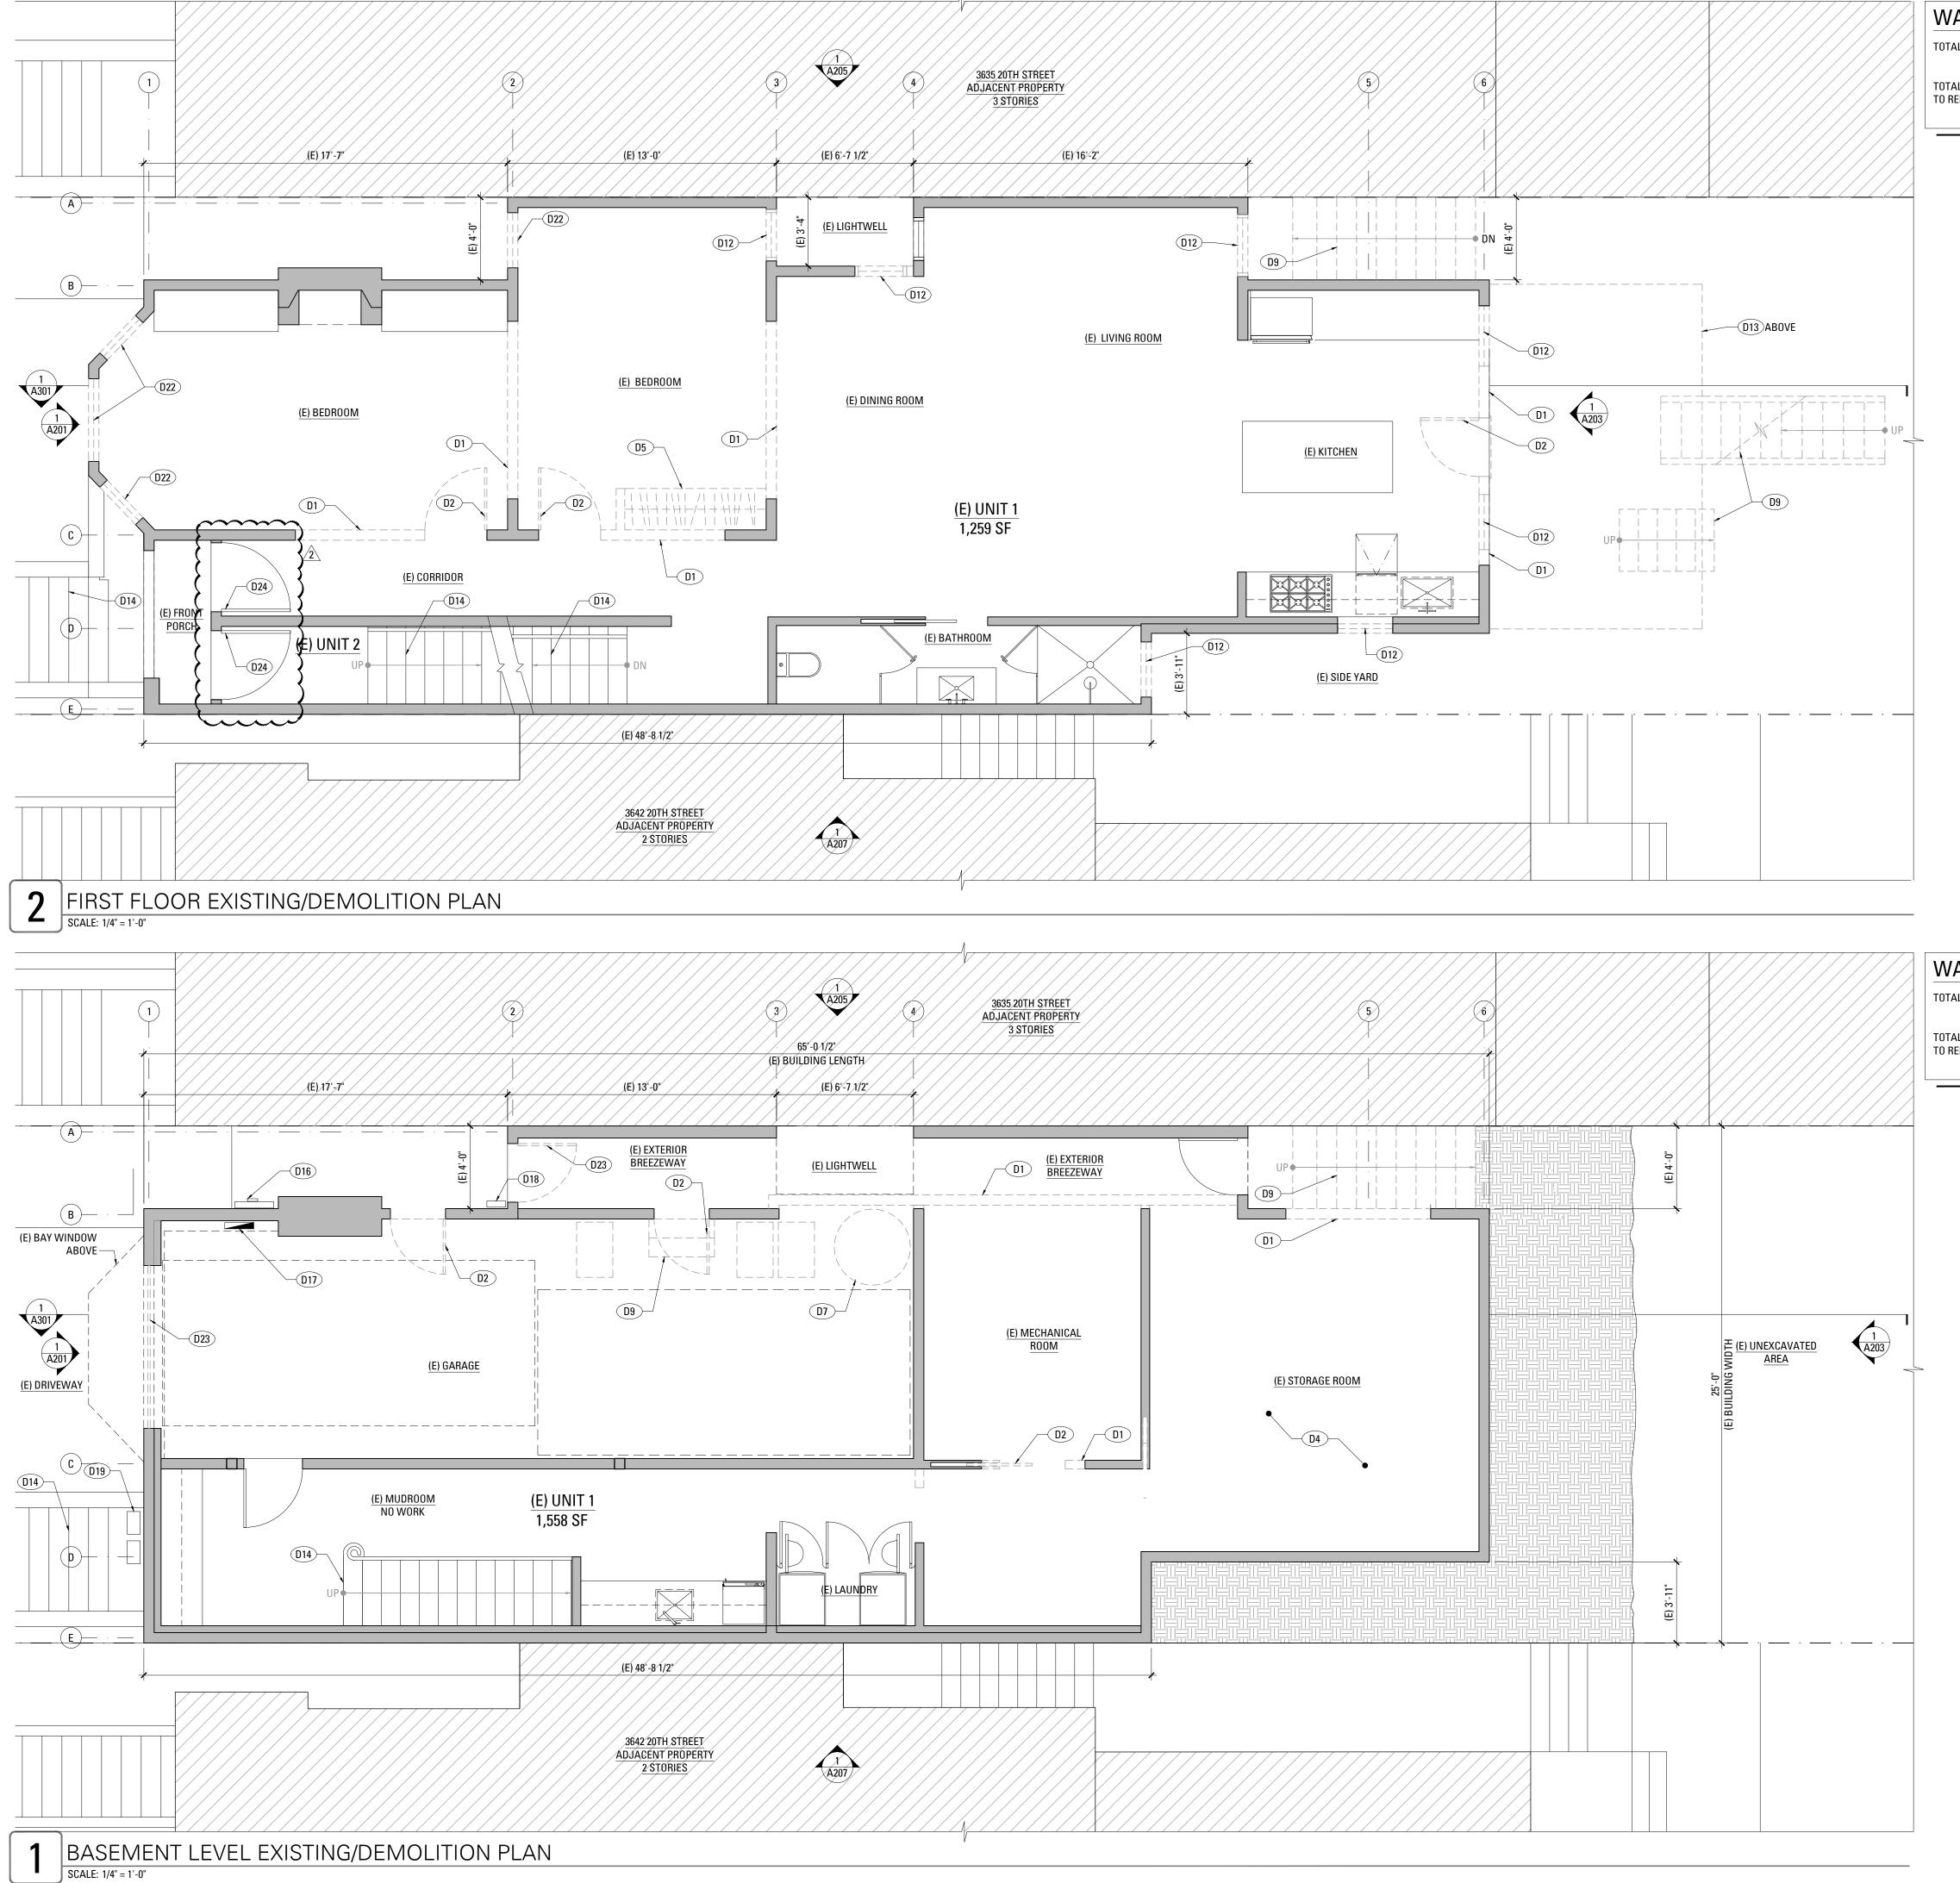


WALL CALCULATIONS

TOTAL LENGTH OF (E) INTERIOR WALLS 102'-5" 102'-5" * 25% = 25'-7 1/2"

TOTAL LENGTH OF (E) INTERIOR WALLS TO REMAIN: 58'-0"


| | GEND | 3639 20TH S | STREET |
|------------|--|---|--|
| | (E) WALL CONSTRUCTION | RESIDENCE R | EMODEL |
| | - PARTITION TYPE SYMBOL | | |
| | (N) SCHEDULED WALL OR FINISH ASSEMBLY. SEE SHEET A901. | | |
| | INDICATES RATED ASSEMBLY. SEE SHEET A901. | 3639 20TH STR SAN FRANCISCO, C | |
| WWW | MANNANCE (N) SOUND ATTENUATION BATT INSULATION | SAN FRANCISCO, C | A 94110 |
| | G (N) GAS SHUT OFF; LOCATE IN ACCESSIBLE AREA IN CABINET [CMC 1313.3] | | |
| | (N) HOSE BIB;HBPROVIDE NON REMOVABLE VACUUMBREAKER OR EQUAL [CPC 603.5.7] | | |
| NOTE | :: ALL (N) WALLS TYPE "A" U.O.N. | ARCHITE | |
| EXI | STING & | 101 Montgomery Stre San Francisco, C. | |
| DE | MOLITION KEYNOTES | T 415 346 99 349 5th Ave | |
| D1 | (E) WALL TO BE REMOVED TO ACCOMMODATE (N) WORK (S.S.D.). | New York, NY T 646 741 0 | 10016 |
| D2 | (E) DOOR TO BE REMOVED. | | |
| D 3 | (E) SKYLIGHT TO REMAIN | | |
| <u>D4</u> | (E) FOUNDATION REPLACEMENT APPROVED UNDER APPROVED PERMIT #2016.0921.8342 | | |
| D 5 | (E) CASEWORK/CABINETRY TO BE REMOVED. | | |
| D6 | (E) WALL INFILL TO BE REMOVED TO ACCOMMODATE (N) WORK | | |
| D7 | (E) APPLIANCE/EQUIPMENT TO BE REMOVED; CAP OFF /PREPARE FOR RE-ROUTING UTILITY LINES, AS REQUIRED. | | |
| D8 | (E) FINISHES IN THIS AREA TO BE REMOVED TO ACCOMMODATE (N) WORK | | |
| D9 | (E) STAIR TO BE REMOVED. | | |
| D10 | (E) SKYLIGHT TO BE REMOVED | | |
| D11 | (E) ROOF AREA TO BE REMOVED, SEE CONSTRUCTION PLANS. | | |
| D12 | (E) WINDOW TO BE REMOVED. | | |
| D13 | (E) DECK TO BE REMOVED | | |
| D14 | (E) STAIRS TO REMAIN. | | |
| D15 | (E) ATTIC AREA TO BE REMOVED TO ACCOMMODATE (N) WORK, SEE CONSTRUCTION PLANS. | | |
| D16 | (E) ELECTRICAL METER, TO REMAIN. | | |
| D17 | (E) ELECTRICAL PANEL TO REMAIN. | | |
| D18 | (E) TELEPHONE BOX, TO REMAIN. | | |
| D19 | (E) GAS METER, TO REMAIN. | | |
| D20 | (E) EXHAUST FLUE TO REMAIN | | |
| (D21) | LINE ILLUSTRATING CEILING HEIGHT OF 6'-3" OF (E) HABITABLE AREA | | |
| D22 | (E) WINDOW SASHES TO BE REMOVED AND REPLACED IN KIND, (E) FRAMES AND TRIM TO REMAIN. | RECORD OF DRAWING ISSUA | 05.15.201 |
| (D23) | (E) DOOR TO BE REMOVED AND REPLACED IN KIND | Permit Set Revision 1 Permit Set Revision 2 | <u>1</u> 10.04.201 <u>2</u> 12.20.201 |
| (D24) | (E) HISTORIC DOOR TO REMAIN, (E) GLAZING PANEL AND HARDWARE TO BE REPLACED IN KIND WITHIN | | |

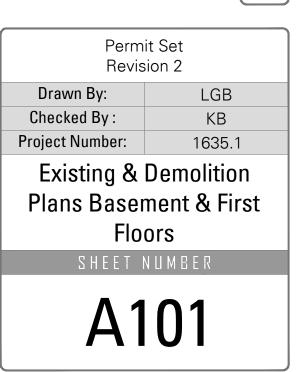

WALL CALCULATIONS

TOTAL LENGTH OF (E) INTERIOR WALLS 87'-8 1/2" 87'-8 1/2" * 25% = 21'-11"

TOTAL LENGTH OF (E) INTERIOR WALLS TO REMAIN: 78'-6"

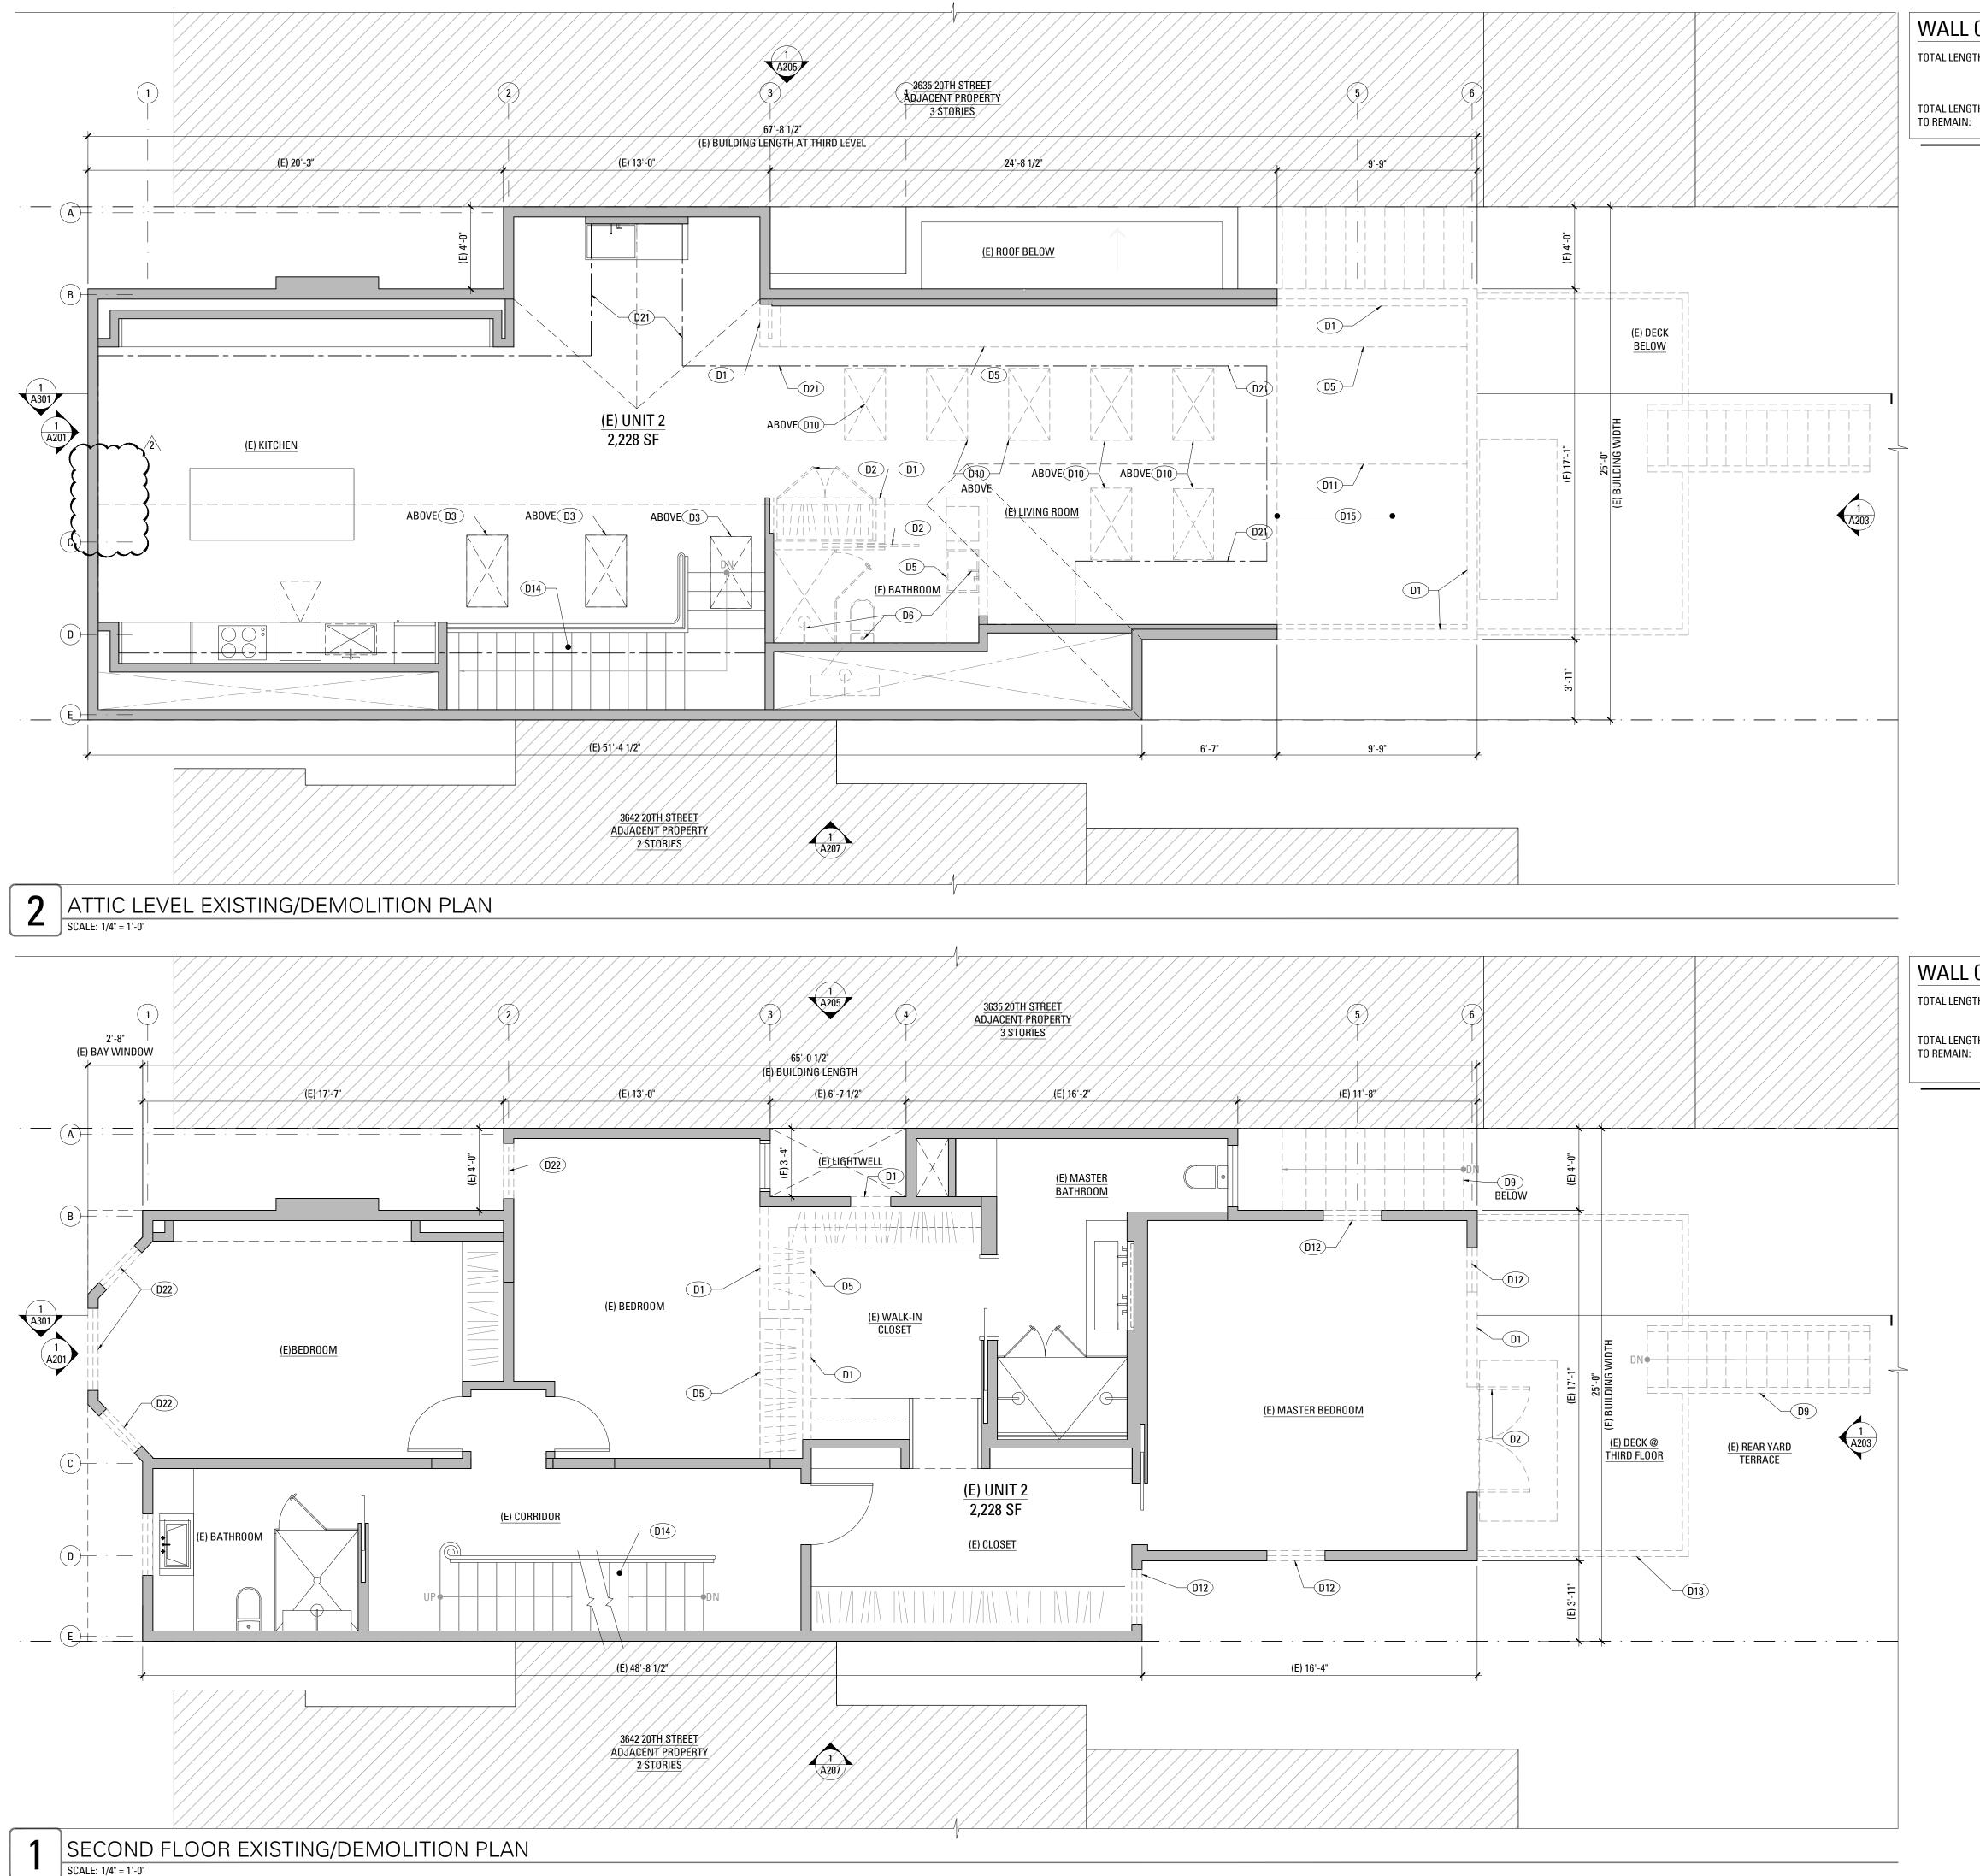


TOTAL LEI

TOTAL LE

WALL CALCULATIONS

TOTAL LENGTH OF (E) INTERIOR WALLS 104'-3 1/2" 104'-3 1/2" *.25 = 26'-1"

TOTAL LENGTH OF (E) INTERIOR WALLS 55'-2 1/2"

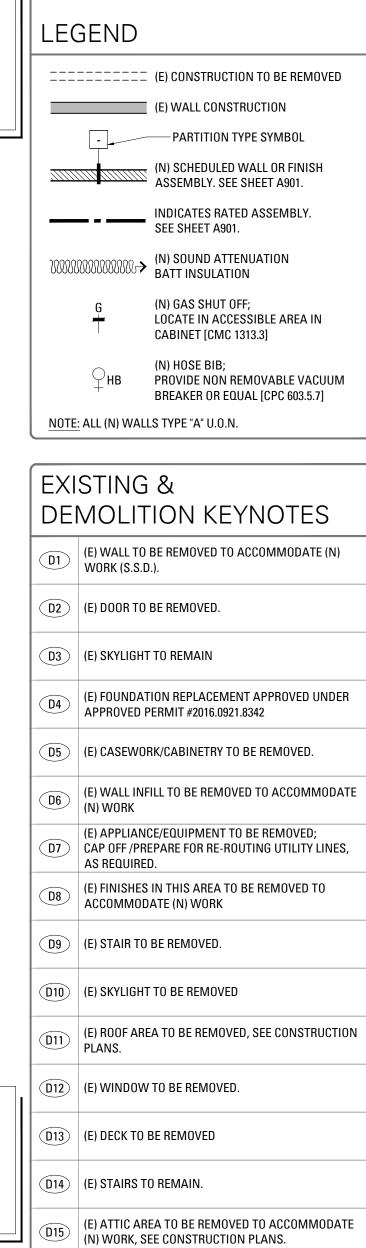

(D16) (E) ELECTRICAL METER, TO REMAIN.

(D17) (E) ELECTRICAL PANEL TO REMAIN.


D18 (E) TELEPHONE BOX, TO REMAIN.

(D19) (E) GAS METER, TO REMAIN.

(D20) (E) EXHAUST FLUE TO REMAIN

REMAIN.


(E) DOOR.

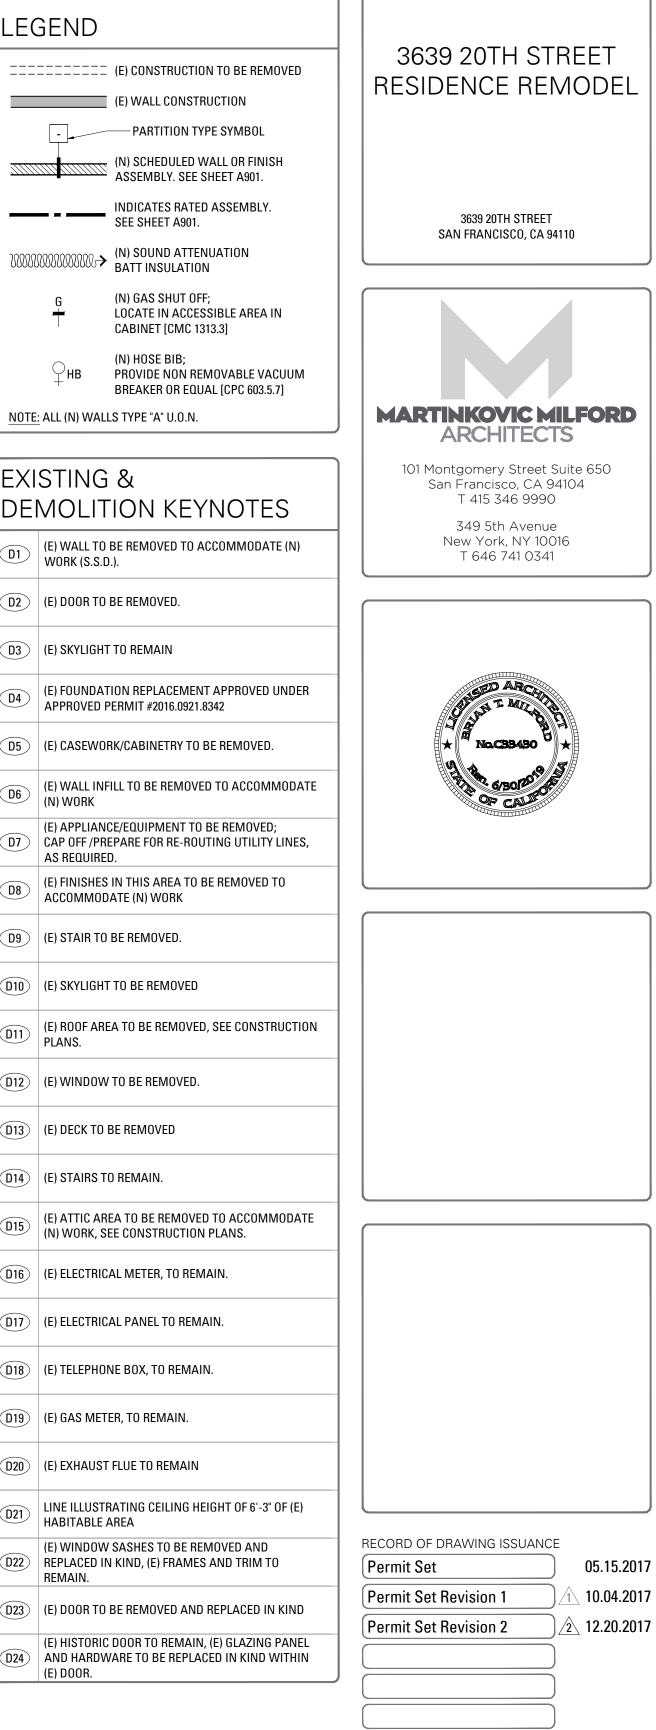


Permit Set Revision 2 Drawn By: LGB Checked By : KB 1635.1 Project Number: Existing & Demolition Plans Second & Third Floors SHEET NUMBER A102

WALL CALCULATIONS

| ENGTH OF (E) INTERIOR WALLS | 131'-0 1/2" 131'-0 1/2" * 25% = 32'-9" |
|-------------------------------------|---|
| ENGTH OF (E) INTERIOR WALLS AIN: | 117'-7 1/2" |

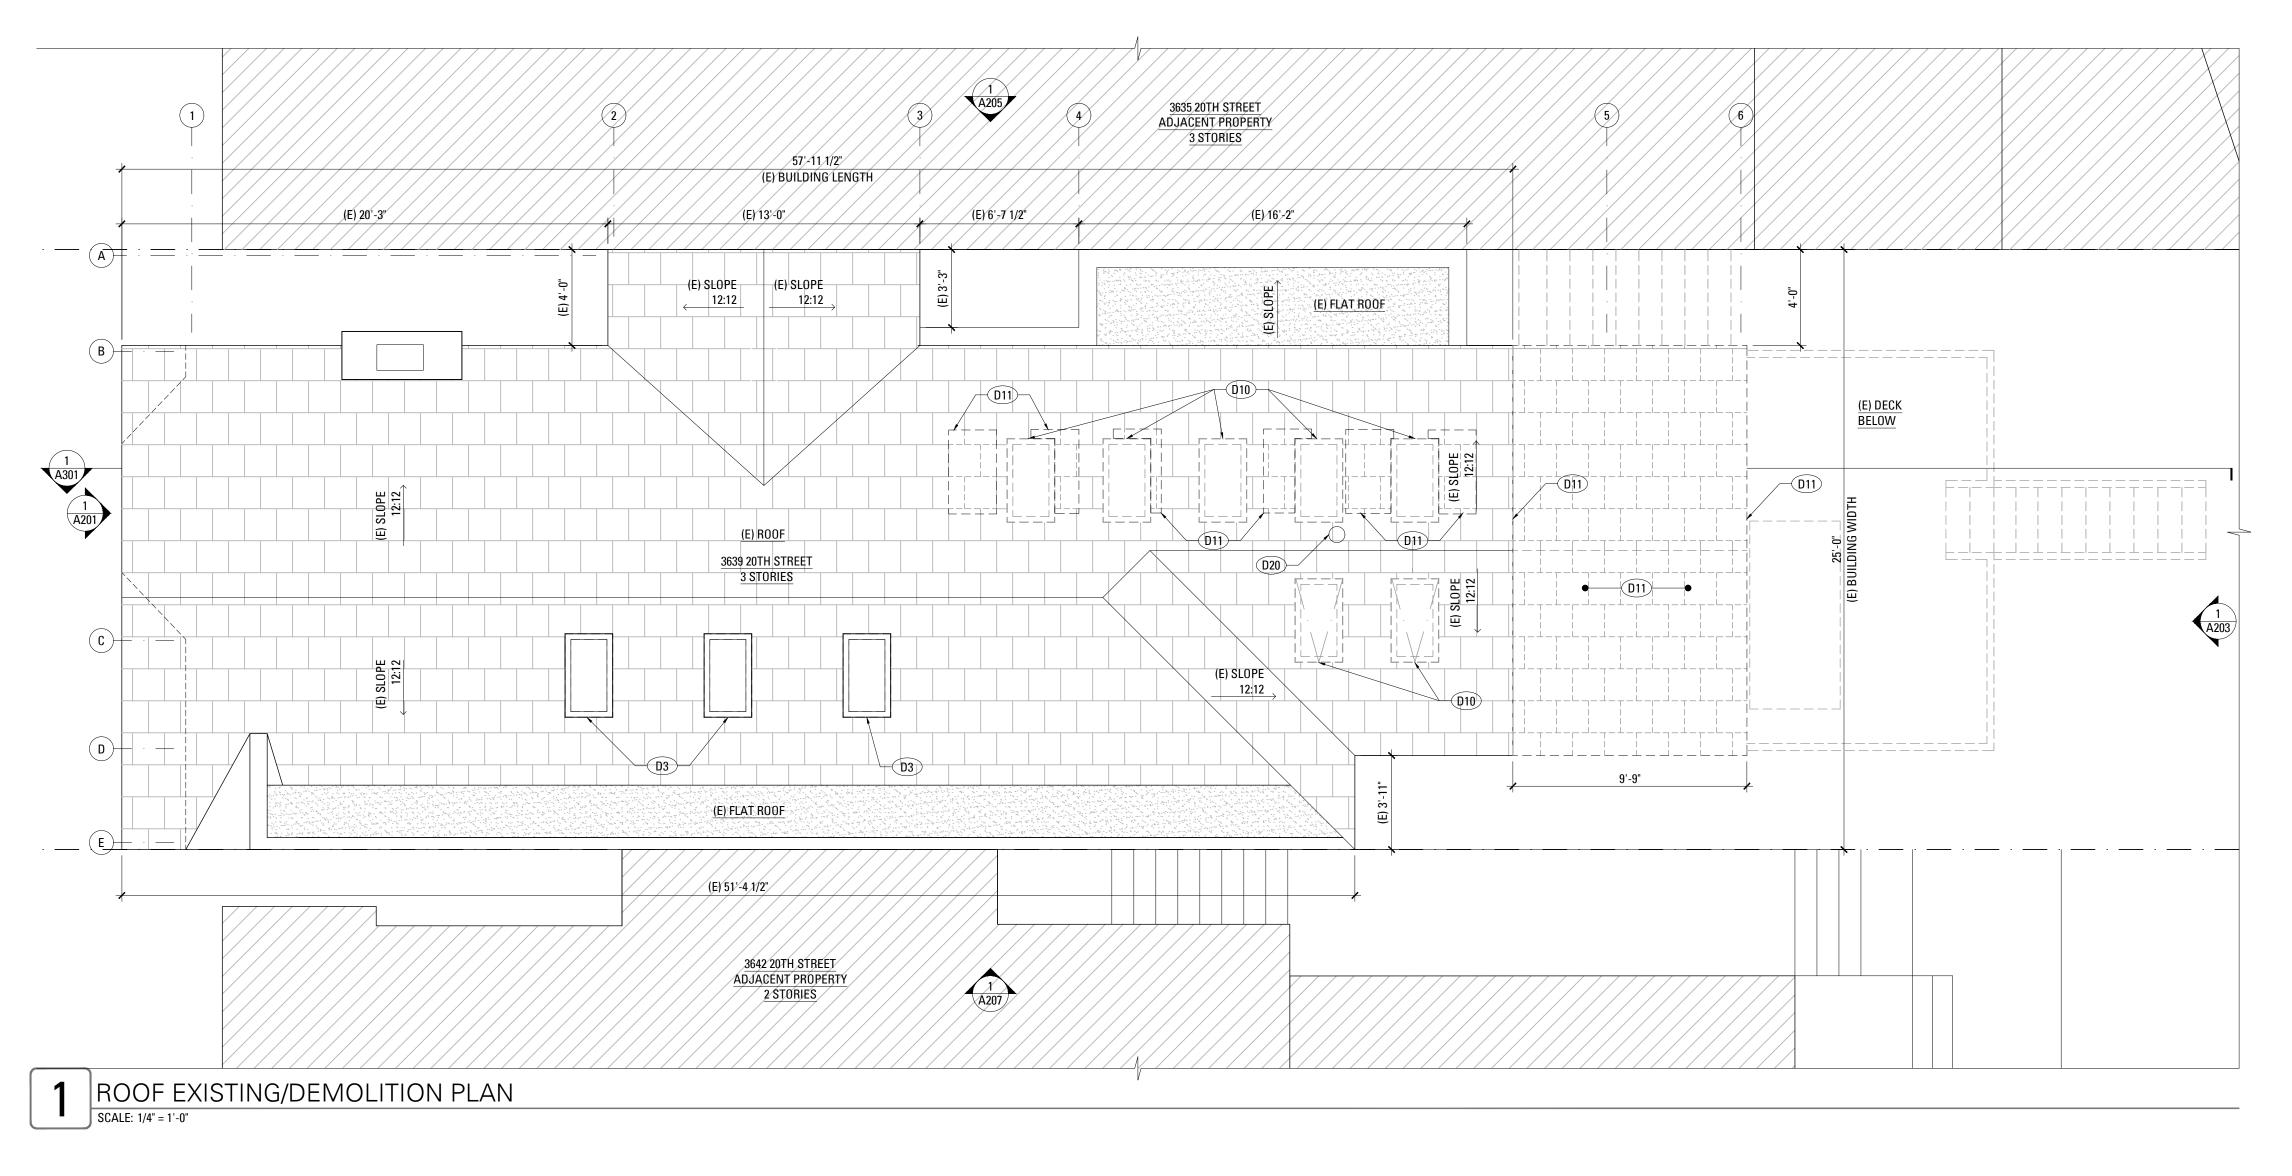


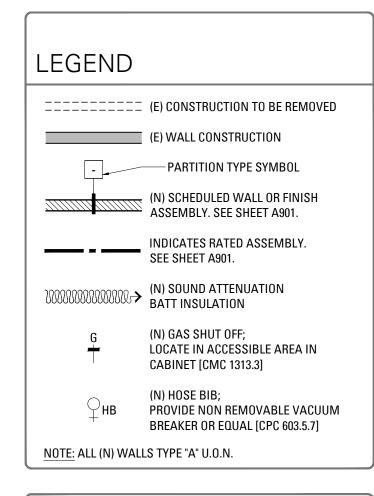


| | STING & MOLITION KEYNOTES |
|------------|---|
| D 1 | (E) WALL TO BE REMOVED TO ACCOMMODATE (N) WORK (S.S.D.). |
| D2 | (E) DOOR TO BE REMOVED. |
| D3 | (E) SKYLIGHT TO REMAIN |
| <u>D4</u> | (E) FOUNDATION REPLACEMENT APPROVED UNDER APPROVED PERMIT #2016.0921.8342 |
| D 5 | (E) CASEWORK/CABINETRY TO BE REMOVED. |
| D6 | (E) WALL INFILL TO BE REMOVED TO ACCOMMODATE (N) WORK |
| D7 | (E) APPLIANCE/EQUIPMENT TO BE REMOVED; CAP OFF /PREPARE FOR RE-ROUTING UTILITY LINES, AS REQUIRED. |
| D8 | (E) FINISHES IN THIS AREA TO BE REMOVED TO ACCOMMODATE (N) WORK |
| D9 | (E) STAIR TO BE REMOVED. |
| D10 | (E) SKYLIGHT TO BE REMOVED |
| (D11) | (E) ROOF AREA TO BE REMOVED, SEE CONSTRUCTION PLANS. |
| D12 | (E) WINDOW TO BE REMOVED. |
| D13 | (E) DECK TO BE REMOVED |
| D14) | (E) STAIRS TO REMAIN. |
| D15 | (E) ATTIC AREA TO BE REMOVED TO ACCOMMODATE (N) WORK, SEE CONSTRUCTION PLANS. |
| D16 | (E) ELECTRICAL METER, TO REMAIN. |
| (D17) | (E) ELECTRICAL PANEL TO REMAIN. |
| D18 | (E) TELEPHONE BOX, TO REMAIN. |
| D19 | (E) GAS METER, TO REMAIN. |
| D20 | (E) EXHAUST FLUE TO REMAIN |
| (D21) | LINE ILLUSTRATING CEILING HEIGHT OF 6'-3" OF (E) HABITABLE AREA |
| (D22) | (E) WINDOW SASHES TO BE REMOVED AND REPLACED IN KIND, (E) FRAMES AND TRIM TO REMAIN. |
| D23 | (E) DOOR TO BE REMOVED AND REPLACED IN KIND |
| D24 | (E) HISTORIC DOOR TO REMAIN, (E) GLAZING PANEL AND HARDWARE TO BE REPLACED IN KIND WITHIN (E) DOOR. |
| | |




| Permit Set Revision 2 | | |
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| Drawn By: | LGB | |
| Checked By : | KB | |
| Project Number: | 1635.1 | |
| Existing & Demolition Roof Plan | | |
| SHEET NUMBER | | |
| A103 | | |

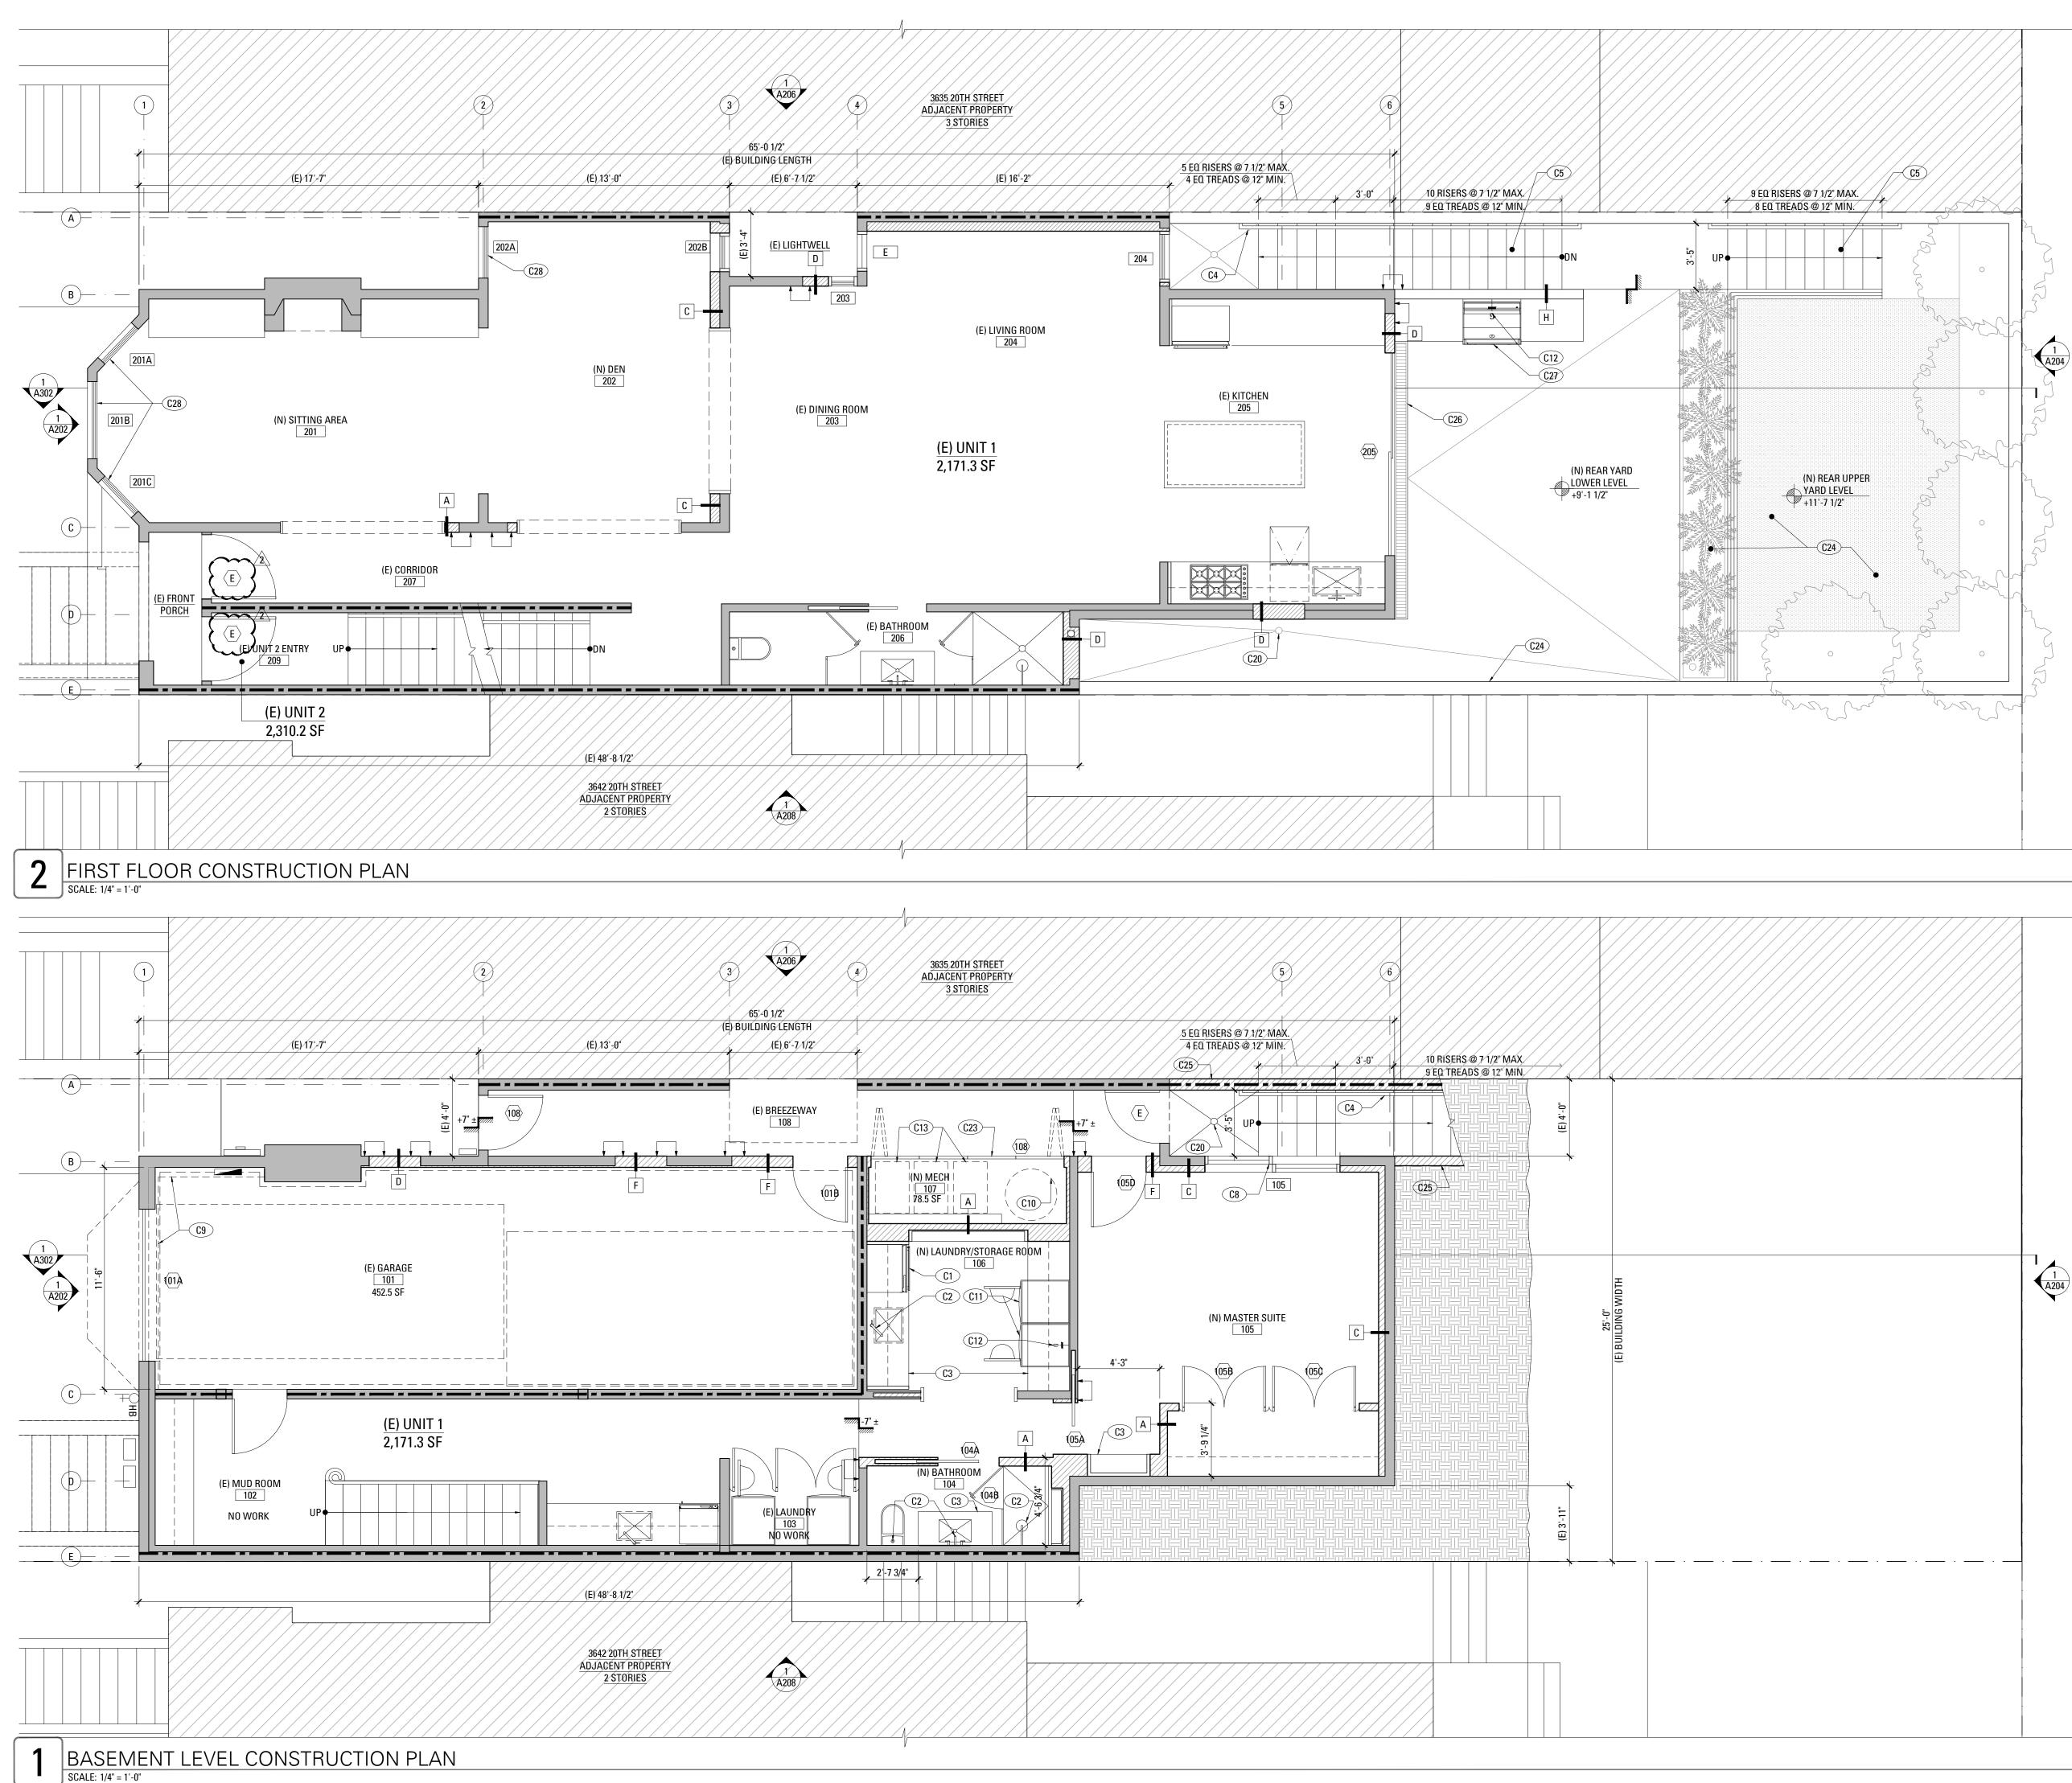

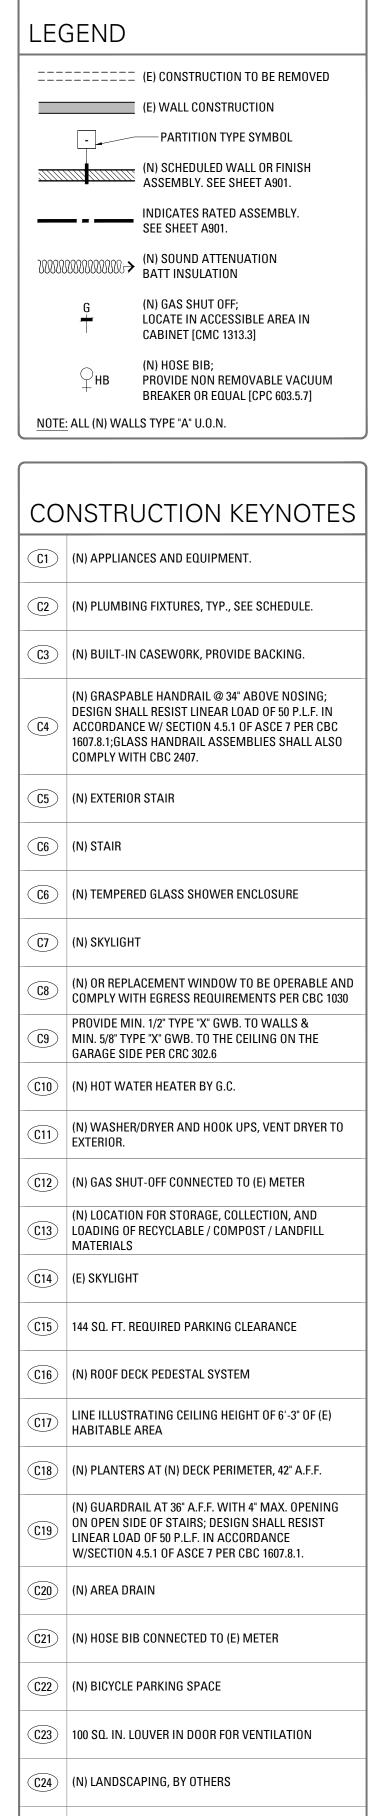


- (C25) (N) CONCRETE RETAINING WALL, S.S.D.
- C26 (N) LINEAR DRAIN
- (C27) (N) UL-LISTED, GAS GRILL
- (N) SINGLE HUNG WINDOW TO MATCH (E) WINDOW (C28) IN KIND WITH UPPER SASH TO BE OPERABLE, SEE WINDOW SCHEDULE

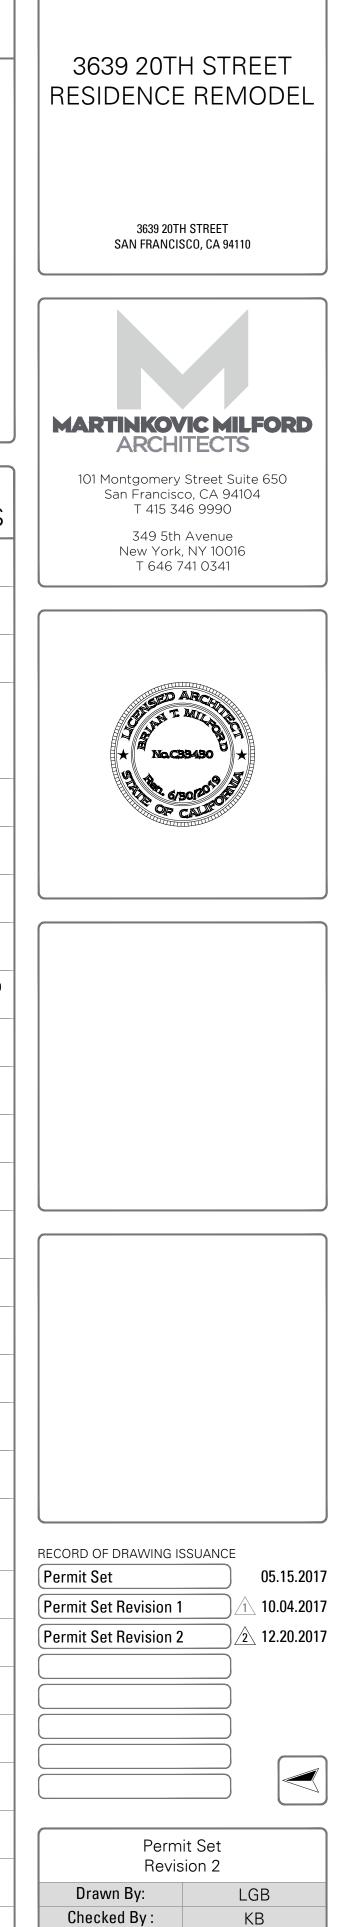


Project Number: 1635.1 **Construction Plans Basement & First Floors** SHEET NUMBER

A111

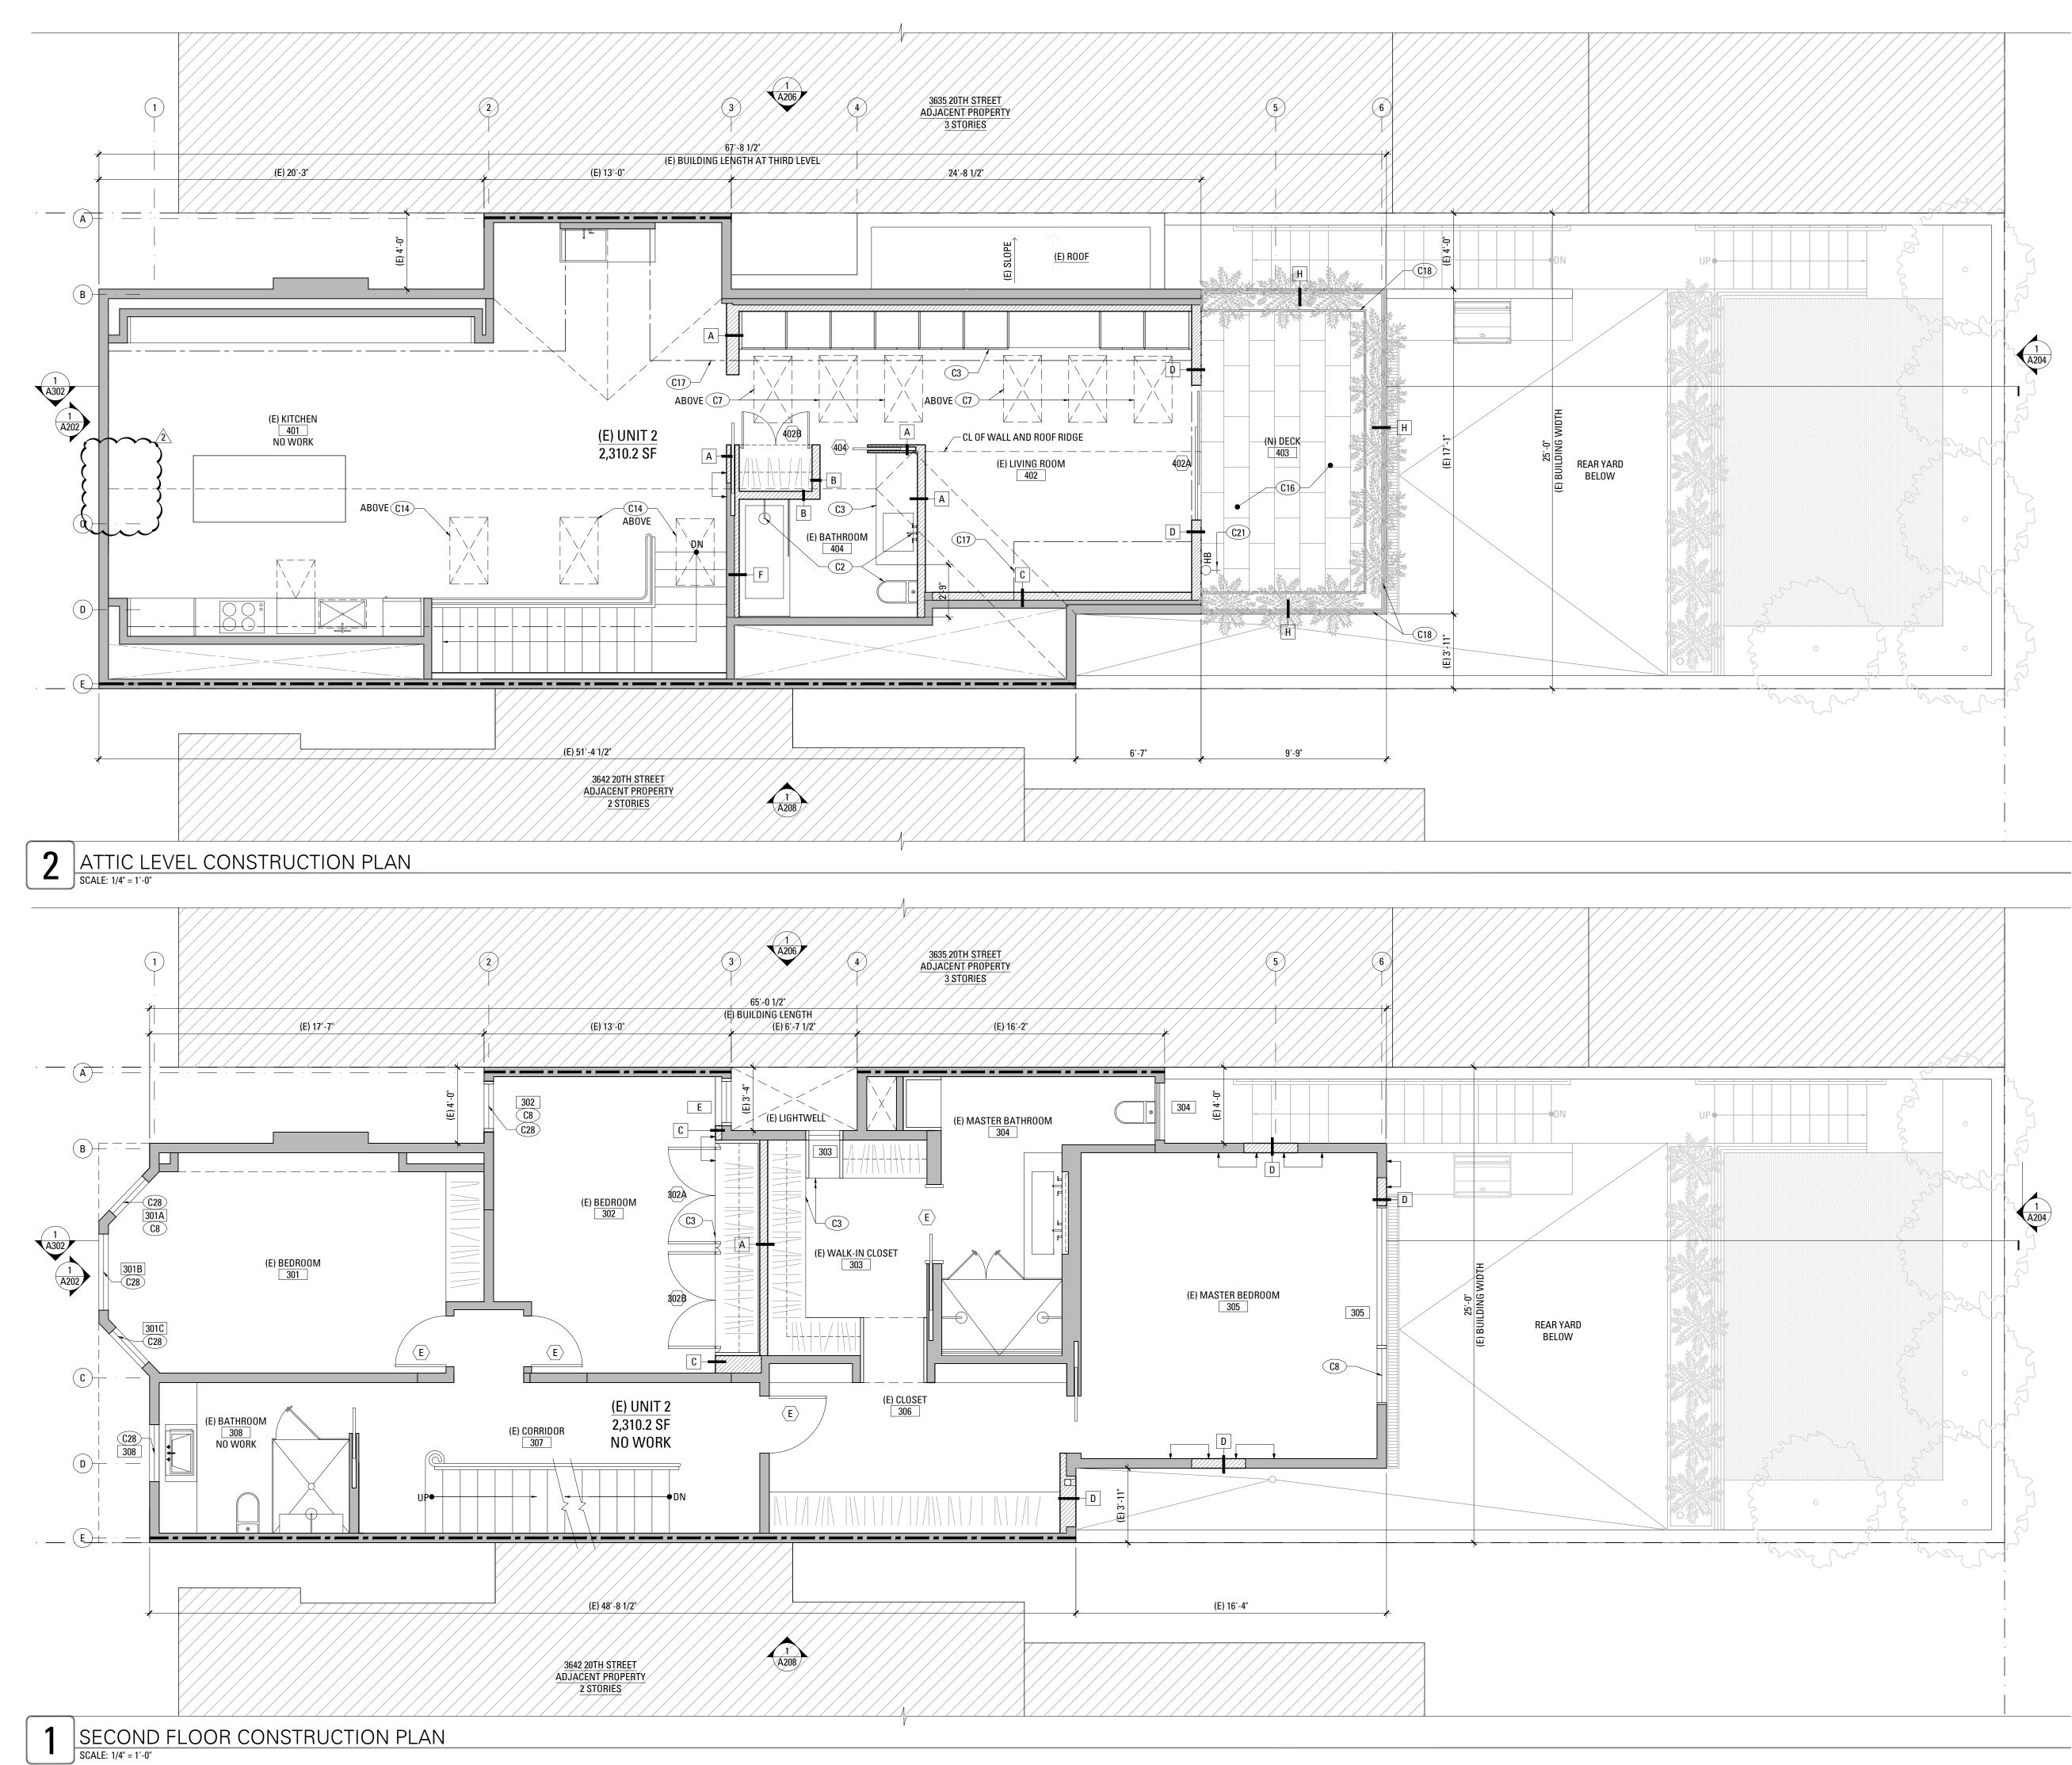


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CONSTRUCTION KEYNOTES

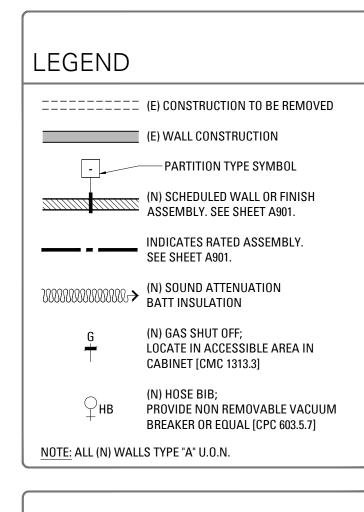- (N) APPLIANCES AND EQUIPMENT.
- (R) PLUMBING FIXTURES, TYP., SEE SCHEDULE.
- (N) BUILT-IN CASEWORK, PROVIDE BACKING.
- C4 (N) GRASPABLE HANDRAIL @ 34" ABOVE NOSING; DESIGN SHALL RESIST LINEAR LOAD OF 50 P.L.F. IN ACCORDANCE W/ SECTION 4.5.1 OF ASCE 7 PER CBC 1607.8.1;GLASS HANDRAIL ASSEMBLIES SHALL ALSO COMPLY WITH CBC 2407.
- C5 (N) EXTERIOR STAIR
- C6 (N) STAIR
- (N) TEMPERED GLASS SHOWER ENCLOSURE
- (N) SKYLIGHT
- C8 (N) OR REPLACEMENT WINDOW TO BE OPERABLE AND COMPLY WITH EGRESS REQUIREMENTS PER CBC 1030
- C9 PROVIDE MIN. 1/2" TYPE "X" GWB. TO WALLS & MIN. 5/8" TYPE "X" GWB. TO THE CEILING ON THE GARAGE SIDE PER CRC 302.6
- (N) HOT WATER HEATER BY G.C.
- (N) WASHER/DRYER AND HOOK UPS, VENT DRYER TO EXTERIOR.
- (12) (N) GAS SHUT-OFF CONNECTED TO (E) METER
- C13(N) LOCATION FOR STORAGE, COLLECTION, AND
LOADING OF RECYCLABLE / COMPOST / LANDFILL
MATERIALS
- C14 (E) SKYLIGHT
- (C15) 144 SQ. FT. REQUIRED PARKING CLEARANCE
- (N) ROOF DECK PEDESTAL SYSTEM
- C17 LINE ILLUSTRATING CEILING HEIGHT OF 6'-3" OF (E) HABITABLE AREA
- (N) PLANTERS AT (N) DECK PERIMETER, 42" A.F.F.
- (N) GUARDRAIL AT 36" A.F.F. WITH 4" MAX. OPENING ON OPEN SIDE OF STAIRS; DESIGN SHALL RESIST LINEAR LOAD OF 50 P.L.F. IN ACCORDANCE W/SECTION 4.5.1 OF ASCE 7 PER CBC 1607.8.1.
- C20 (N) AREA DRAIN
- (N) HOSE BIB CONNECTED TO (E) METER
- (N) BICYCLE PARKING SPACE
- C23 100 SQ. IN. LOUVER IN DOOR FOR VENTILATION
- (N) LANDSCAPING, BY OTHERS
- (C25) (N) CONCRETE RETAINING WALL, S.S.D.
- (C26) (N) LINEAR DRAIN
- (N) UL-LISTED, GAS GRILL
- (N) SINGLE HUNG WINDOW TO MATCH (E) WINDOW IN KIND WITH UPPER SASH TO BE OPERABLE, SEE WINDOW SCHEDULE




3639 20TH STREET

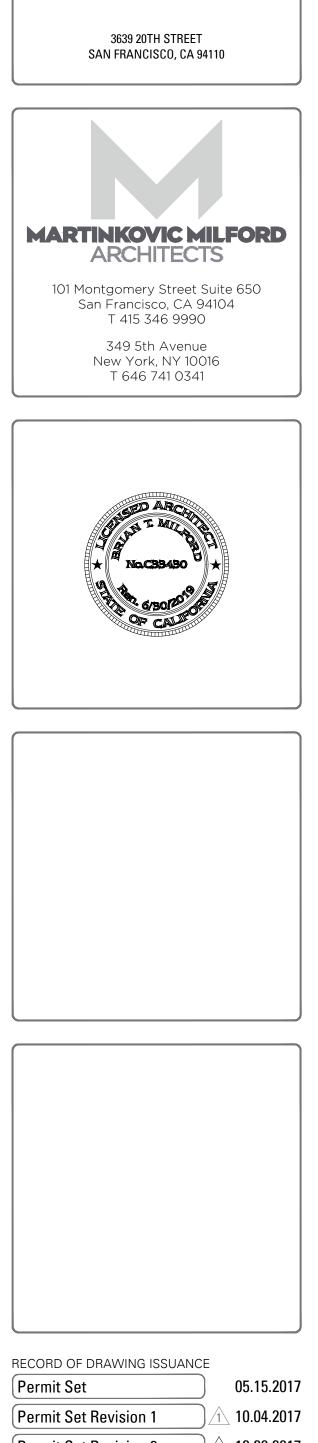
RESIDENCE REMODEL

| Permit Set Revision 2 | 12.20.2017 |
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| Drawn By: | LGB |
| Checked By : | KB |
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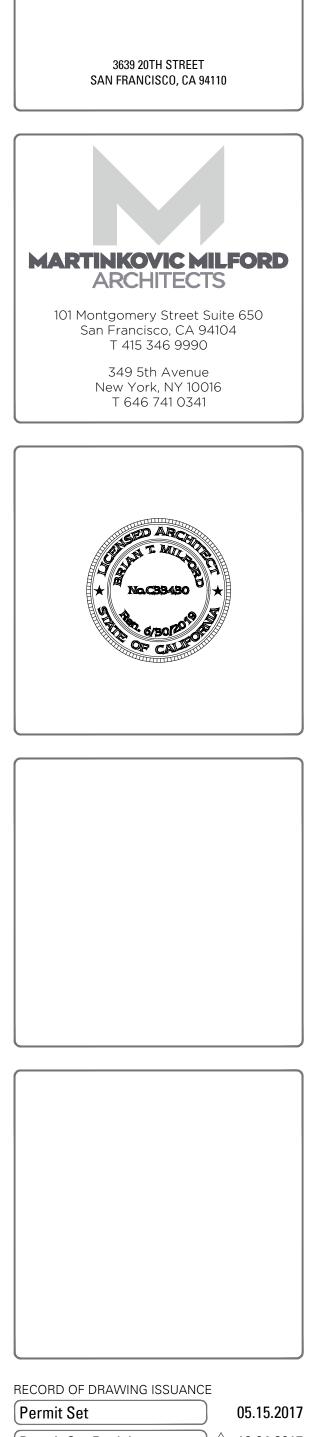




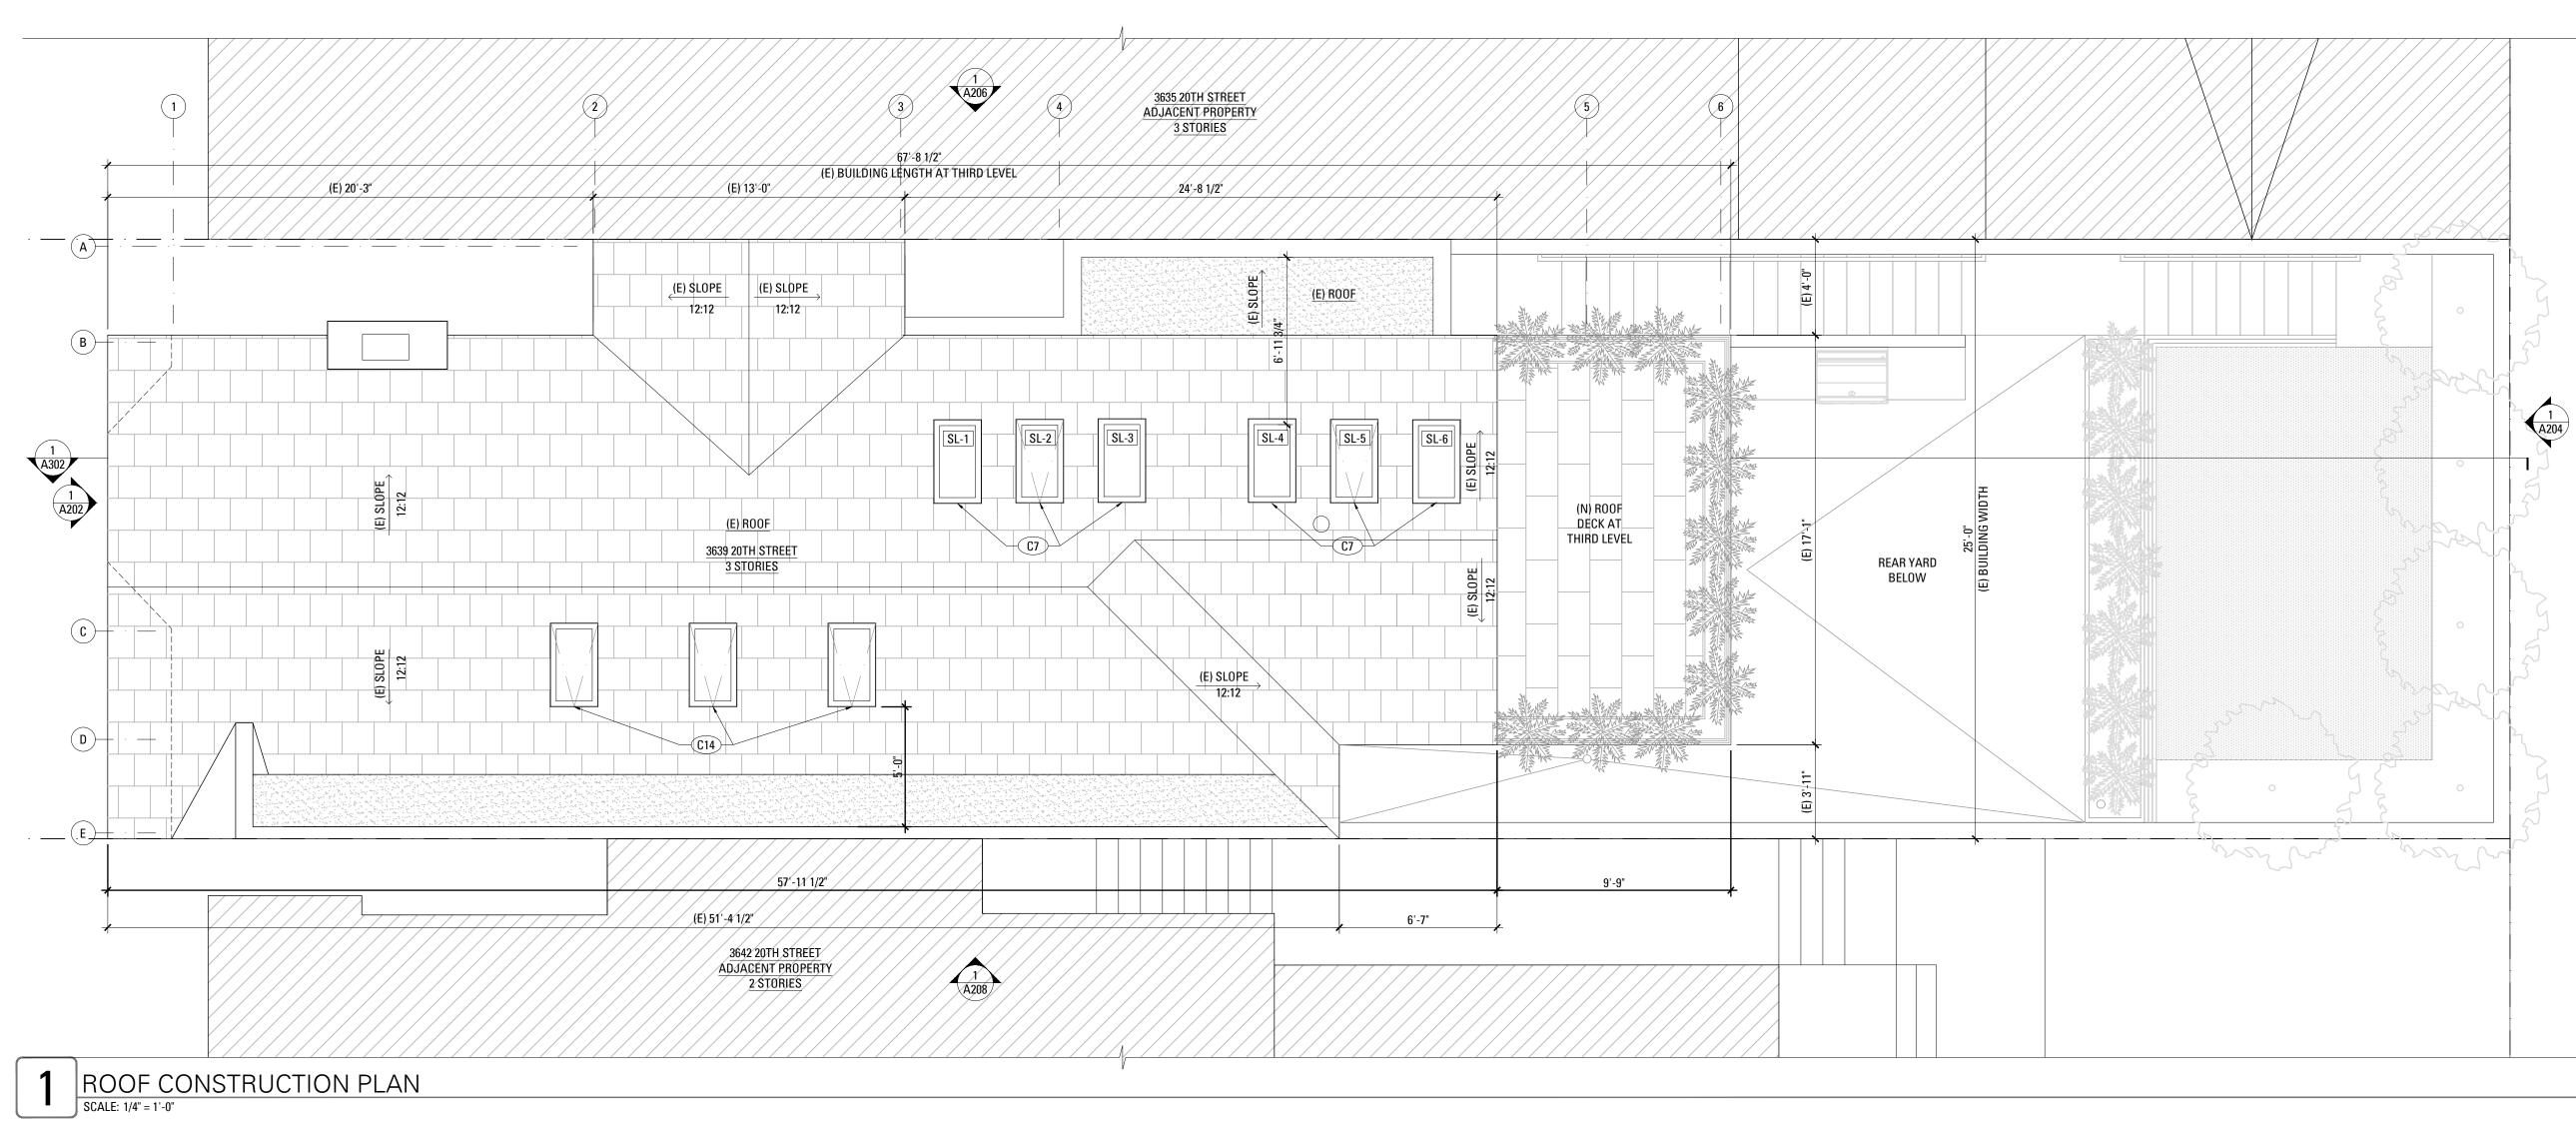

CONSTRUCTION KEYNOTES
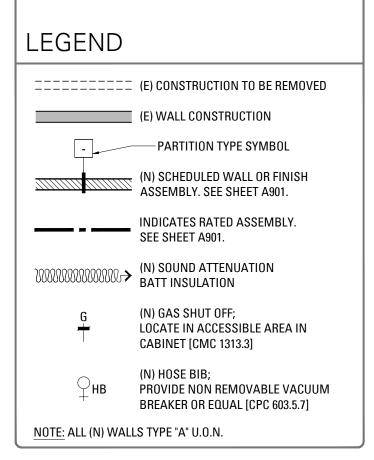
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- (N) PLUMBING FIXTURES, TYP., SEE SCHEDULE.
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- (N) WASHER/DRYER AND HOOK UPS, VENT DRYER TO EXTERIOR.
- (N) GAS SHUT-OFF CONNECTED TO (E) METER
- (N) LOCATION FOR STORAGE, COLLECTION, AND LOADING OF RECYCLABLE / COMPOST / LANDFILL MATERIALS
- (E) SKYLIGHT
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- C17 LINE ILLUSTRATING CEILING HEIGHT OF 6'-3" OF (E) HABITABLE AREA
- (N) PLANTERS AT (N) DECK PERIMETER, 42" A.F.F.
- (N) GUARDRAIL AT 36" A.F.F. WITH 4" MAX. OPENING ON OPEN SIDE OF STAIRS; DESIGN SHALL RESIST LINEAR LOAD OF 50 P.L.F. IN ACCORDANCE W/SECTION 4.5.1 OF ASCE 7 PER CBC 1607.8.1.
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3639 20TH STREET

RESIDENCE REMODEL

| Permit Set | 05.15.2017 |
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| Permit Set Revision 1 | 10.04.2017 |
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GREEN MECHANICAL AND PLUMBING GENERAL NOTES

- HOT WATER SYSTEM PIPING CONDITIONS LISTED BELOW, BURIED AND UNBURIED, MUST BE INSULATED. INSULATION THICKNESS TO BE BASED ON THE CONDUCTIVITY RANGE IN CGC TABLE 120.3-A. THE INSULATION LEVEL IS SELECTED FROM THE FLUID TEMPERATURE RANGE BASED ON THE THICKNESS REQUIREMENTS IN CGC TABLE 120.3-A.
 THE FIRST FIVE (5) FEET (1.2 METERS) OF HOT
- WATER AND COLD WATER PIPED FROM THE STORAGE TANK. 1.2. ALL PIPING WITH A NOMINAL DIAMETER OF 3/4
- 1.2. ALL FIFING WITH A NOMINAL DIAMETER OF 3/4 INCH (19 MILLIMETER) OR LARGER.
 1.3. ALL PIPING ASSOCIATED WITH A DOMESTIC HOT WATER RECIPCULATION OVATEM RECARDING OF A UNATER RECIPCULATION OVATEM RECARDING OF A INCH (19 MILLIMETER) OF
- WATER RECIRCULATION SYSTEM REGARDLESS OF THE PIPE DIAMETER.
 1.4. PIPING FROM THE HEARING SOURCE TO STORAGE
- 1.4. PIPING FROM THE HEARING SOURCE TO ST TANK OR BETWEEN TANKS. 1.5. PIPING BURIED BELOW GRADE.
- PIPING BURIED BELOW GRADE.
 ALL HOT WATER PIPES FROM THE HEATING SOURCE
- TO THE KITCHEN FIXTURES. 2. DUCTS ARE TO BE PROVIDED WITH R-6 MIN INSULATION. 3. DUCT LEAKAGE TESTING - 6% W/O AIR HANDLER AND 4%
- WITH AIR HANDLER.
 4. RETURN DUCT DESIGN/FAN POWER, AIRFLOW TESTING, AND GRILL SIZING TO COMPLY WITH REQUIREMENTS OF
- CGC SECTION 150.0-M-13.
 WATER HEATING: 120 VOLT RECEPTACLE <3FT., CAT III OR IV VENT, AND GAS SUPPLY LINE CAPACITY OF AT LEAST
- 2000,000 BTU.
 VENTILATION PERFORMANCE: THE WHOLE-BUILDING VENTILATION AIRFLOW REQUIRED BY SECTION 4 OF ASHRAE STANDARD 62.2 SHALL BE CONFIRMED THROUGH FIELD VERIFICATION AND DIAGNOSTIC TESTING IN ACCORDANCE WITH THE APPLICABLE PROCEDURES SPECIFIED IN REFERENCE RESIDENTIAL APPENDIX RA3.7.
- REFER TO 2016 CGC TABLE 150.1-A FOR REFRIGERANT CHARGE DISPLAY REQUIREMENTS. COMPLIANCE WITH 2016 CGC SECTION 150.1-C-7 FOR ADDITIONAL REQUIREMENTS REGARDING MEASUREMENT ACCESS HOLES, CHARGE INDICATOR DISPLAYS AND HERS RATER VERIFICATION PROCEDURES.
- A RADIANT BARRIER SHALL HAVE AN EMMITTANCE OF 0.05 OR LESS, TESTED IN ACCORDANCE WITH ASTM C1371 OR ASTM E403 TO BE PROVIDED.
- 9. HEAT LOSS/HEAT GAIN VALUES IN ACCORDANCE WITH ANSI/ACCA 2 MANUAL J-2004 OR EQUAL; DUCT SYSTEMS ARE SIZED ACCORDING TO ANSI/ACCA 1, MANUAL D-2009 OR EQUIVALENT; SELECT HEATING AND COOLING EQUIPMENT IN ACCORDANCE WITH ANSI/ACCA 3, MANUAL S-2004, OR EQUIVALENT.
- AT THE TIME OF ROUGH INSTALLATION, DURING STORAGE ON THE CONSTRUCTION SITE, AND UNTILFINAL STARTUP OF THE HEATING, COOLING AND VENTILATING EQUIPMENT, ALL DUCT AND OTHER RELATED AIR DISTRIBUTION COMPONENTS OPENINGS WILL BE COVERED WITH TAPE, PLASTIC, SHEET METALS, OR OTHER METHOD ACCEPTABLE TO THE ENFORCING AGENCY TO REDUCE THE AMOUNT OF WATER, DUST, OR DEBRIS THAT MAY ENTER THE SYSTEM.
 NEW THIRD-PARTY HERS VERIFICATION FOR
- VENTILATION AND INDOOR AIR QUALITY AS REQUIRED BY TITLE 21 ENERGY COMPLIANCE CALCULATIONS AND CHAPTER 150.0-0 OF THE 2016 CGC.
- 12. REFRIGERANT CHARGE VERIFICATION FOR DUCTED PACKAGE UNITS, MINI SPLITS, AND OTHER UNITS.

LIGHTING EFFICIENT GENERAL NOTES

- . LUMINAIRE EFFICACY: INSTALLED LUMINAIRES SHALL BE CLASSIFIED AS HIGH-EFFICACY OR LOW- EFFICACY.
- 2. HYBRID LUMINAIRES: WHEN A HIGH-EFFICACY AND LOW-EFFICACY LIGHTING SYSTEMS ARE COMBINED TOGETHER IN SINGLE LUMINAIRE, THE HIGH-EFFICACY AND LOW-EFFICACY LIGHTING SYSTEMS COMPLY SEPARATELY WITH WATTAGE REQUIREMENTS.
- LUMINAIRE WATTAGE AND CLASSIFICATION: ALL LIGHTING IS TO BE UL LISTED.
- THE WATTAGE OF PERMANENTLY INSTALLED HIGH DISCHARGE LIGHTING IN KITCHEN TO HAVE ELECTRONIC BALLAST WITH A 150 WATT RE-LAMPING MAX. LOW-VOLTAGE LIGHTING WILL HAVE A 50 WATT MAX RE-LAMP RATING.
- KITCHEN LIGHTING REQUIREMENTS: A MINIMUM OF 50%
 OF THE TOTAL RATED WATTAGE OF PERMANENTLY INSTALLED LIGHTING IN KITCHENS SHALL BE HIGH-EFFICACY.
- KITCHEN UNDER-CABINET AND IN-CABINET LIGHTING ARE CALCULATED TOWARD RATED WATTAGE PERCENTAGE.
 DECORATIVE LIGHTING AT DINING AREA TO BE
- SEPARATELY SWITCHED AND CIRCUITED FROM KITCHEN LIGHTING.
 THE WATTAGE OF ELECTRICAL BOXED FINISHED WITH A
- BLANK COVER OR WHERE NO ELECTRICAL EQUIPMENT BOX CAN BE USED FOR A LUMINAIRE OR A SURFACE MOUNTED CEILING FAN, SHALL BE CALCULATED AS 190 WATTS OF LOW-EFFICACY LIGHTING PER ELECTRICAL BOX.
- 9. ELECTRONIC BALLASTS: AT FLUORESCENT LAMPS RATED 13 WATTS OR GREATER, ELECTRONIC BALLASTS WITH AN OUTPUT FREQUENCY NO LESS THAN 20KHZ SHALL BE PROVIDED.
- 10. NIGHT LIGHTS: PERMANENTLY INSTALLED NIGHT LIGHTS TO CONSUME NO MORE THAN FIVE WATTS OF POWER PER LUMINAIRE.
- LIGHTING INTEGRAL TO EXHAUST FANS: LIGHTING INTEGRAL TO EXHAUST FANS SHALL MATCH THE LIGHTING EFFICACY REQUIREMENTS.
- 12. LIGHTING INSTALLED BY THE MANUFACTURER IN KITCHEN EXHAUST HOODS ARE EXEMPT FROM REQUIREMENTS.
- REFER TO 2016 CGC, TABLE 150,0-B FOR LIGHTING EFFICACY LEVEL REQUIREMENTS.
- 18.3.

REFLECTED CEILING PLAN & LIGHTING NOTES

ALL NEW ELECTRICAL WORK SHALL COMPLY WITH THE 2016 CALIFORNIA ELECTRICAL CODE. (2016 CEC) ALL NEW LIGHTING SHALL BE INSTALLED IN ACCORDANCE WITH THE 2016 CALIFORNIA TITLE 24 BUILDING ENERGY EFFICIENCY STANDARDS.

ALL INSTALLED LIGHTING SHALL BE HIGH EFFICACY IN ACCORDANCE WITH TABLE 150.0-A OF THE 2016 CALIFORNIA TITLE 24 BUILDING ENERGY EFFICIENCY STANDARDS.

ALL PERMANENTLY INSTALLED LUMINAIRES WITH INTERCHANGEABLE LAMPS MUST CONTAIN LAMPS THAT COMPLY WITH THE REQUIREMENTS OF JOINT APPENDIX 8 (JA8) AND BE APPROPRIATELY MARKED TO BE CONSIDERED "HIGH EFFICACY LUMINAIRES."

RECESSED DOWNLIGHT LUMINAIRES AND ENCLOSED LUMINAIRES ARE REQUIRED TO CONTAIN A JA8 COMPLIANT LAMP THAT MEETS THE ELEVATED TEMPERATURE REQUIREMENT.

ALL PERMANENTLY INSTALLED LUMINAIRES SHALL HAVE READILY ACCESSIBLE CONTROLS THAT PERMIT THE LUMINAIRES TO BE MANUALLY SWITCH ON AND OFF. HIGH EFFICIENCY LED LUMINAIRES SHALL HAVE MINIMUM COLOR RENDITION INDEX (CRI) ≥ 90 AND CORRELATED COLOR TEMPERATURE (CCT) OF 2700-4000K (INTERIOR) AND UP TO 5000K (OUTDOOR)

ALL FORWARD PHASE CUT DIMMERS USED WITH LED LIGHT SOURCES SHALL COMPLY WITH NEMA SSL 7A. ALL FLUORESCENT FIXTURES 13W OR GREATER SHALL HAVE ELECTRONIC BALLASTS AND SHALL HAVE AN OUTPUT FREQUENCY NO LESS THAN 20KHZ OR APPROVED GU-24 LINE VOLTAGE SOCKETS. (BUILDING ENERGY EFFICIENCY STANDARDS150.0(k)(1)(D))

ALL RECESSED LIGHTING IN SURFACES WITH THERMAL INSULATION SHALL HAVE AIR TIGHT/IC HOUSINGS. LIGHTING INSTALLED IN BATHROOMS SHALL: (A) HAVE MINIMUM ONE HIGH EFFICACY LIGHT FIXTURE; AND (B) ALL OTHER LIGHTING SHALL BE HIGH EFFICACY OR CONTROLLED BY VACANCY SENSORS.

ALL LIGHTING IN ATTACHED AND DETACHED GARAGES, LAUNDRY, UTILITY ROOMS AND BATHROOMS SHALL BE HIGH EFFICACY AND CONTROLLED BY VACANCY SENSORS. ALL INTERIOR LIGHTING IN ROOMS OR AREAS OTHER THAN KITCHENS, BATHROOMS, GARAGES, LAUNDRY AND UTILITY ROOMS SHALL BE HIGH EFFICACY, OR SHALL BE CONTROLLED BY EITHER DIMMERS OR VACANCY SENSORS. ALL LUMINAIRES THAT ARE INSTALLED WITH

JA8-CERTIFIED LIGHT SOURCES AND BLANK ELECTRICAL BOXES MORE THAN FIVE FEET ABOVE THE FINISHED FLOOR ARE REQUIRED TO BE CONTROLLED BY EITHER A DIMMER, VACANCY SENSOR, OR FAN SPEED CONTROL. ALL LIGHTING CONTROLS, BALLASTS FOR RECESSED

LUMINAIRES, AND HIGH EFFICACY LED LIGHT SOURCES SHALL BE CERTIFIED BY THE ENERGY COMMISSION FOR COMPLIANCE WITH THE 2016 CALIFORNIA TITLE 24 BUILDING ENERGY EFFICIENCY STANDARDS. PERMANENTLY INSTALLED LIGHTING THAT IS INTERNAL

TO CABINETS SHALL USE NO MORE THAN 20 WATTS OF POWER PER LINEAR FOOT OF ILLUMINATED CABINET. ANY EXHAUST FAN WITH INTEGRAL LIGHTING SHALL HAVE ABILITY TO MANUALLY SWITCH OFF LIGHT SYSTEM WHILE FAN CONTINUES TO OPERATE

ALL OUTDOOR LIGHTING MOUNTED TO THE BUILDING OR TO OTHER BUILDINGS ON THE SAME LOT MUST BE HIGH EFFICACY, AND MUCH BE CONTROLLED BY A MANUAL ON AND OFF SWITCH AND ONE OF THE FOLLOWING AUTOMATIC CONTROL TYPES:

18.1. PHOTOCONTROL AND MOTION SENSOR;
18.2. PHOTOCONTROL AND AUTOMATIC TIME SWITCH CONTROL;

ASTRONOMICAL TIME CLOCK CONTROL THAT AUTOMATICALLY TURNS THE OUTDOOR LIGHTING OFF DURING DAYLIGHT HOURS; OR

18.4. EMCS THAT PROVIDES THE FUNCTIONALITY OF AN ASTRONOMICAL TIME CLOCK.

 ALL ELECTRICAL DEVICES (SWITCHES, OUTLETS) SHALL BE THE SAME COLOR AS THE COVERPLATE, U.O.N. SEE A131
 INSTALL AS MANY ADJACENT SWITCHES AND OUTLETS IN ONE PLATE AS POSSIBLE.
 ALL SWITCHES TO BE MOUNTED 40" A F.E. LLON

 ALL SWITCHES TO BE MOUNTED 48" A.F.F., U.O.N.
 GENERAL CONTRACTOR TO COORDINATE ALL SWITCHING NOT SHOWN ON PLANS WITH OWNER.
 (E) CEILING FINISHES TO REMAIN U.O.N.

 23. (c) CEILING FINISHES TO REMAIN 0.0.N.
 24. LIGHTS NOT LOCATED BY DIMENSION SHALL BE CENTERED ON SECTION OF CEILING LOCATED. ALIGN W/ CENTER OF ADJACENT FIXTURES, DOORS, OR WINDOWS.

 ALL CONDUITS AND WIRES TO BE CONCEALED.
 ALL SMOKE ALARMS INCLUDING COMBINATION SMOKE ALARMS, THAT ARE SOLELY BATTERY POWERED SHALL CONTAIN A NONREPLACEABLE, NONREMOVABLE BATTERY THAT IS CAPABLE OF POWERING THE SMOKE ALARM FOR AT LEAST 10 YEARS.

COMMENCING JANUARY 1, 2015, ALL NEW LISTINGS OF SMOKE ALARMS OR COMBINATION SMOKE ALARMS SHALL DISPLAY THE DATE OF MANUFACTURE, PROVIDE A PLACE ON THE DEVICE WHERE THE DATE OF INSTALLATION CAN BE WRITTEN, AND INCORPORATE A HUSH FEATURE. EXCEPTIONS TO 23 AND 24 ABOVE INCLUDE: A) SMOKE DETECTORS INTENDED TO BE USED WITH A FIRE ALARM

OR HOUSEHOLD FIRE ALARM CONTROL UNIT; B) SMOKE ALARMS THAT SEND A SUPERVISION AND BATTERY DEPLETION SIGNAL TO A FIRE ALARM OR HOUSEHOLD FIRE ALARM CONTROL UNIT VIA A LOW-POWER RADIO

FREQUENCY WIRELESS COMMUNICATION SIGNAL; C)
 SMOKE ALARMS THAT USE LOW-POWER RADIO
 FREQUENCY WIRELESS COMMUNICATION SIGNAL FOR
 INTERCONNECTION.
 29. CARBON MONOXIDE ALARMS/DETECTORS MUST BE


LISTED IN ACCORDANCE WITH EITHER UL2034 OR UL2075 AND APPROVED BY THE OFFICE OF THE STATE FIRE MARSHAL (SB-183)


30. ALL EXISTING LIGHTING TO REMAIN UNLESS OTHERWISE NOTED

POWER & SIGNAL GENERAL NOTES


NEW CONVENIENCE OUTLETS ONLY SHOWN. G.C. TO VERIFY AND PROVIDE ALL NECESSARY POWER FOR ALL FOUIPMENT.

- G.C. TO COORDINATE REQUIRED DATA WITH OWNER
 G.C. TO COORDINATE WITH OWNER FOR NEW AV
- SYSTEM. ALL OUTLETS ORIENTED HORIZONTALLY, 8" A.F.F. U.O.N. ALL DIMENSIONS ARE TO CENTER UNE OF OUTLET OR
- ALL DIMENSIONS ARE TO CENTERLINE OF OUTLET OR GROUP OF OUTLETS.
 ALL OUTLETS TO BE CENTERED ON SECTION OF WALL IT
- IS LOCATED ON OF CENTERED ON SECTION OF WALL IT IS LOCATED ON OR CENTERED BELOW WINDOW OR CABINET ABOVE, U.O.N. ALL OUTLETS ORIENTED HORIZONTALLY, ON
- ALL OUTLETS ORIENTED HORIZONTALLY, ON BASEBOARD U.O.N.
 DATUBOON OUTLETS TO BE MOUNTED AD LACK
- BATHROOM OUTLETS TO BE MOUNTED ADJACENT TO OR IN ALIGNMENT WITH SWITCH HEIGHT.
 DO NOT SURFACE MOUNT CONDUIT OR JUNCTION BOXES ON WALLS. ALL CONDUIT AND JUNCTION BOXES SHOULD BE RECESSED. NOTIFY ARCHITECT OF ANY DISCREPANCIES.
- SEE SHEET A901 FOR EQUIPMENT AND APPLIANCE SCHEDULE.
- 1. INSTALL OUTLETS ON OPPOSITE SIDES OF PARTITIONS IN SEPARATE STUD CAVITIES. OFFSET OUTLETS MINIMUM DISTANCE AS REQUIRED TO AVOID BACK-TO-BACK INSTALLATION.
- 12. ALL RECEPTACLES MOUNTED ON PAINTED GYPSUM BOARD TO BE WHITE WITH WHITE COVERPLATES
- 13. ALL RECEPTACLES MOUNTED IN WOOD OR STONE FINISHES TO BE BLACK WITH S.S. COVERPLATES
- CONFIRM FINAL LOCATIONS OF DEVICES WITH
 CONFIRM FINAL LOCATIONS OF DEVICES WITH
- ARCHITECT AND MEP ENGINEER BEFORE INSTALLATION.
 15. IN ALL AREAS SPECIFIED IN CEC 210.52, ALL 125-VOLT, 15- AND 20- AMPERE RECEPTACLES SHALL BE LISTED TAMPER-RESISTANT RECEPTACLES. (CEC 406.12)
- AMPER-RESISTANT RECEPTACLES. (CEC 406.12)
 ANY OF THE MEANS DESCRIBED IN CEC 210.12 (A)(1) THROUGH (6) SHALL PROTECT ALL RECEPTACLES IN ALL DWELLING UNIT KITCHENS, FAMILY ROOMS, DINING ROOMS, LIVING ROOMS, PARLORS, LIBRARIES, DENS, BEDROOMS, SUNROOMS, RECREATION ROOMS, CLOSETS, HALLWAYS, LAUNDRY AREAS OR SIMILAR ROOMS OR AREAS WITH BRANCH CIRCUITS THAT SUPPLY 120-VOLT, SINGLE PHASE, 15- AND 20- AMPERE RECEPTACLE OUTLETS. (CEC 210.12)
- ALL BATHROOM RECEPTACLE OUTLETS SHALL BE SUPPLIED BY AT LEAST ONE 20-AMPERE BRANCH CIRCUIT. SUCH CIRCUITS SHALL HAVE NO OTHER OUTLETS. RECEPTACLES TO BE INSTALLED ON THE WALL WITHIN (3) FEET OF OUTSIDE EDGE OF SINK BASIN, WITHIN (1) FOOT BELOW THE TOP OF THE BASIN, & GFCI PROTECTED [CEC 210.52(D), 210.11(C)(3), 210.8(A)(1)].
- 18. TWO OR MORE 20-AMPERE GFCI PROTECTED CIRCUITS SHALL BE PROVIDED IN THE KITCHEN COUNTER AND ISLAND OUTLETS [CEC 210.52(B)(1), 210.52(B)(3), 210.52(C)]
- 19. ALL MULTIWIRE BRANCH CIRCUITS, INCLUDING BUT NOT LIMITED TO DISHWASHER & GARBAGE DISPOSAL CIRCUITS, SHALL DISCONNECT SIMULTANEOUSLY ALL UNGROUNDED CONDUCTORS AT THE POINT WHERE THE BRANCH CIRCUIT ORIGINATES (CEC 210.4)
- 20. DISHWASHER, GARBAGE DISPOSAL, MICROWAVE, AND SPA MOTOR OR HEATER SHALL HAVE DEDICATED CIRCUITS. [CEC 210.23 A(1), 210.23 A(2)] REFER TO MANUFACTURERS FOR SEPARATE CIRCUIT REQUIREMENTS.
- 1. RECEPTACLES, UNLESS LISTED AS RECEPTACLE ASSEMBLIES FOR COUNTERTOP APPLICATIONS, SHALL NOT BE INSTALLED IN A FACE-UP POSITION IN COUNTERTOPS OR SIMILAR WORK SURFACES. ASSEMBLIES SHALL BE PERMITTED TO BE LISTED AS GFCI RECEPTACLE ASSEMBLIES FOR COUNTERTOP APPLICATIONS WHEN REQUIRED TO PROVIDE GROUND-FAULT CIRCUIT-INTERRUPTER PROTECTION FOR PERSONNEL IN ACCORDANCE WITH 210.8. [CEC 406.5(E)]
- PROVIDE A 120V RECEPTACLE WITHIN (3) FEET OF WATER HEATER. [(CAL ENERGY CODE 150.0 (N)]
 ALL EXISTING OUTLET FACEPLATES TO BE REMOVED AND REPLACED WITH WHITE SCREWLESS PLATES

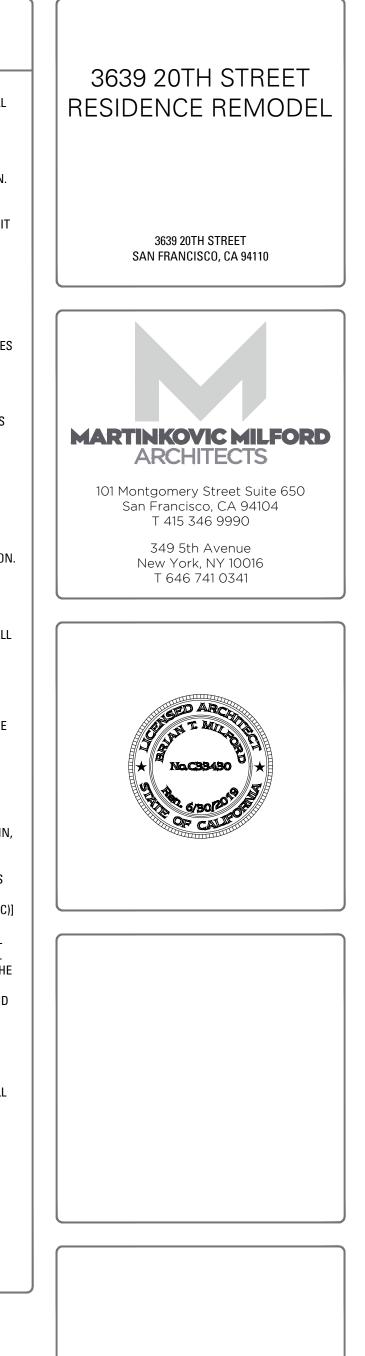

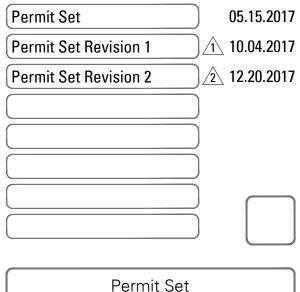

| Revision 2 | |
|------------------------------|--------|
| Drawn By: | LGB |
| Checked By : | КВ |
| Project Number: | 1635.1 |
| RCP & Pow No ⁻ | • |
| SHEET I | NUMBER |
| A1 | 20 |

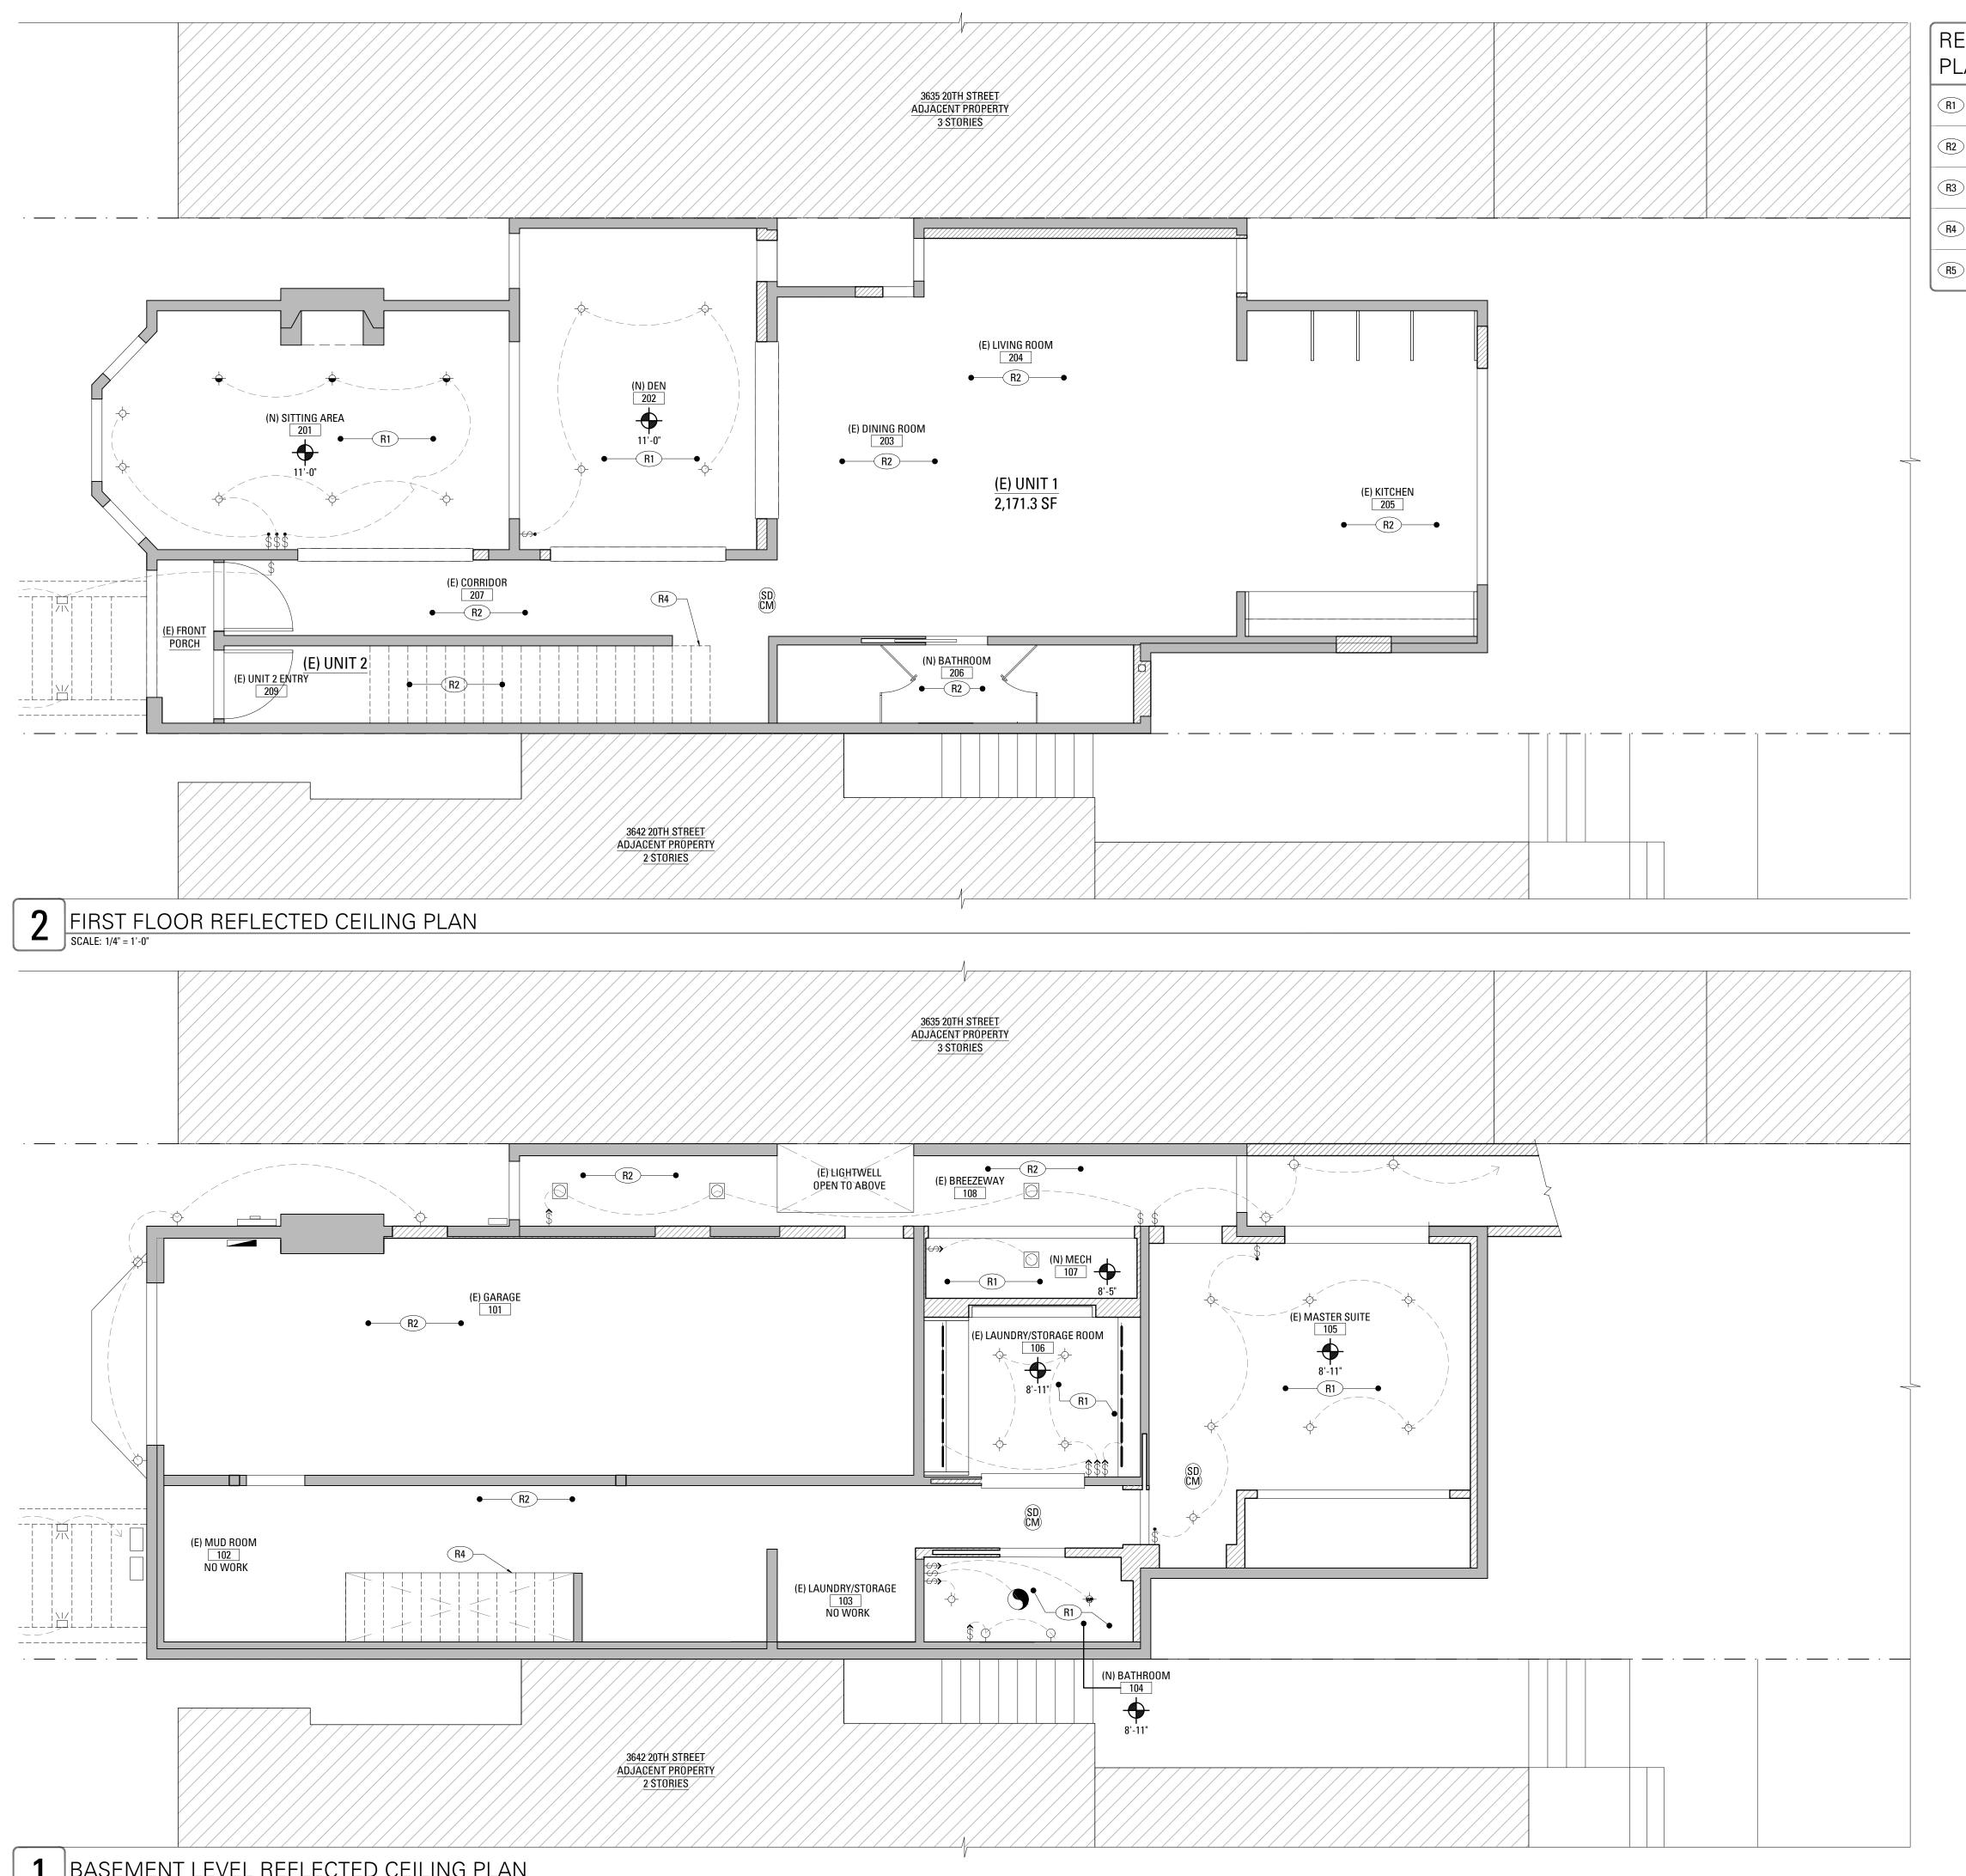

BASEMENT LEVEL REFLECTED CEILING PLAN

REFLECTED CEILING PLAN KEYNOTES


(R1) (N) PAINTED GYPSUM BOARD CEILING

(R2) (E) CEILING TO REMAIN, TYP. U.O.N.

(E) SKYLIGHTS

(R4) (E) STAIR SOFFIT ABOVE

(N) SKYLIGHTS

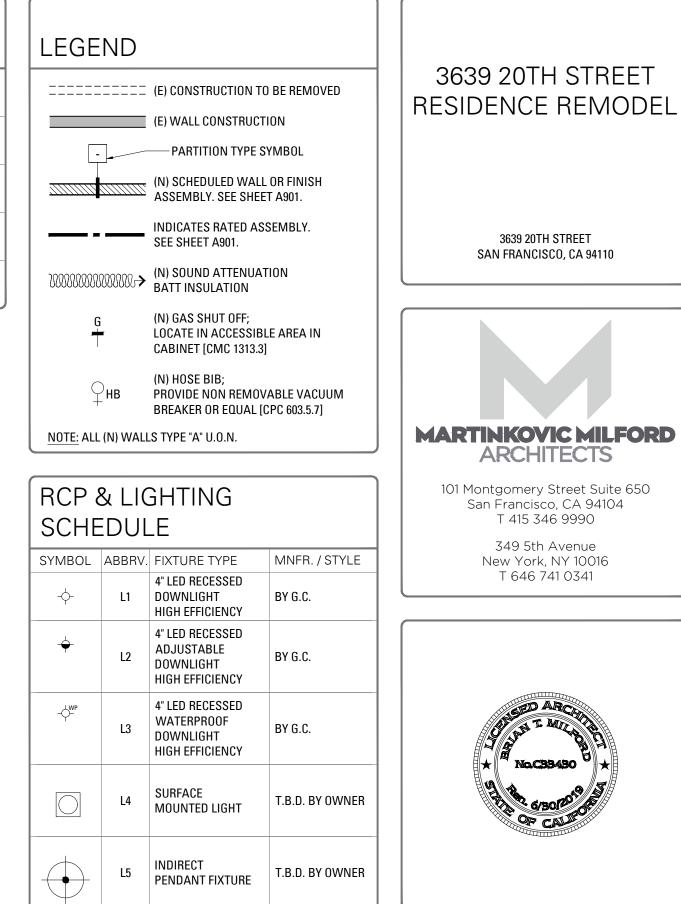

DECORATIVE CHANDELIER

EXHAUST FAN.

COMBINED PHOTOELECTRIC

SMOKE ALARM

AND CARBON MONOXIDE ALARM

L9 EXTERIOR WALL SCONCE

L10 INTERIOR WALL SCONCE

UNDER CABINET LIGHT

WALL MOUNTED STEP LIGHT

L14 MANUAL ON, AUTO OFF VACANCY SENSOR BY G.C.

L15 DIMMER SWITCH. ALL L15 LIGHTS ON SWITCH BY G.C. TO BE DIMMABLE

1. ALL SWITCHES SHALL BE DECORA ROCKER TYPE, OR EQUAL.

2. SWITCHES & COVER PLATES LOCATED ON PAINTED GYPSUM

3. SWITCHES LOCATED ON STONE OR WOOD TO BE BLACK

L7 MIN. 50 CFM + HUMIDISTAT

L6

L8

L11

L13

L12 IN-CABINET LIGHT, DOOR ACTIVATED

L16 SWITCH

WITH STAINLESS STEEL COVER PLATES.

LI7 LED STRIP

BOARD TO BE WHITE.

T.B.D. BY OWNER

BY G.C.

BY G.C.

T.B.D. BY OWNER

BY G.C.

BY G.C.

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NOTES:

| 3639 20TH STREET |
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| SAN FRANCISCO, CA 94110 |
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| MARTINKOVIC MILFORD |
| ARCHITECTS |
| 101 Montgomery Street Suite 650 San Francisco, CA 94104 |
| T 415 346 9990 |
| 349 5th Avenue New York, NY 10016 T 646 741 0341 |
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3639 20TH STREET

| Permit Set |) 05.15.2017 |
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| Permit Set Revision 1 |) <u>1</u> 10.04.2017 |
| Permit Set Revision 2 |) 🖄 12.20.2017 |
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| Permit Set Revision 2 | |
|--|--------|
| Drawn By: | LGB |
| Checked By : | KB |
| Project Number: | 1635.1 |
| Reflected Ceiling Plans Basement & First Floors | |
| SHEET N | NUMBER |
| SHEET NUMBER | |



REFLECTED CEILING PLAN KEYNOTES


(R1) (N) PAINTED GYPSUM BOARD CEILING

(R2) (E) CEILING TO REMAIN, TYP. U.O.N.

(R3) (E) SKYLIGHTS

(R4) (E) STAIR SOFFIT ABOVE

(N) SKYLIGHTS

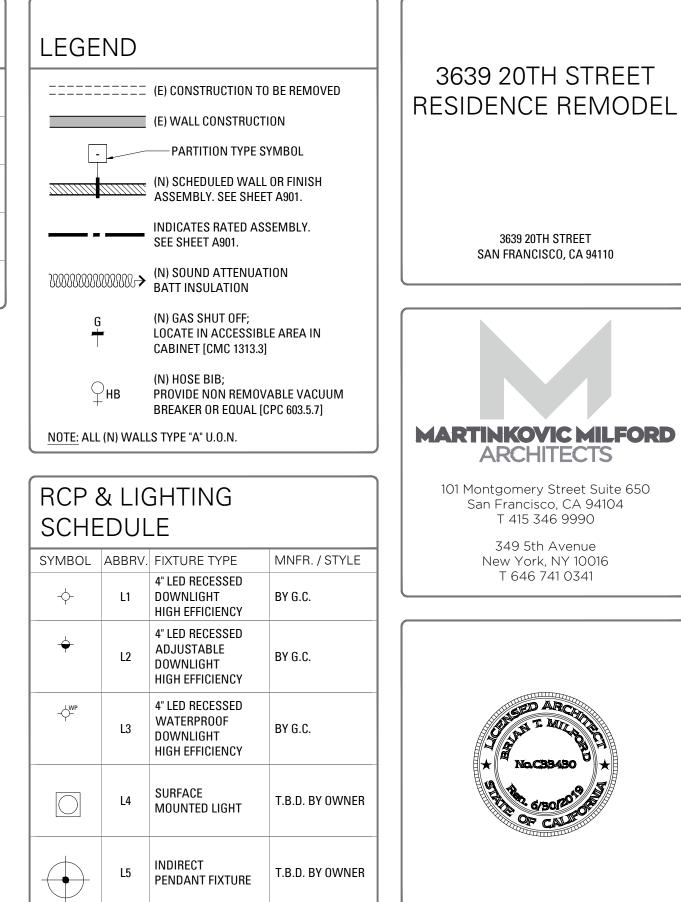

DECORATIVE CHANDELIER

EXHAUST FAN.

L7 MIN. 50 CFM + HUMIDISTAT

> COMBINED PHOTOELECTRIC

SMOKE ALARM

AND CARBON MONOXIDE ALARM

L9 EXTERIOR WALL SCONCE

L10 INTERIOR WALL SCONCE

L11 UNDER CABINET LIGHT

L13 WALL MOUNTED STEP LIGHT

L14 MANUAL ON, AUTO OFF VACANCY SENSOR BY G.C.

L15 DIMMER SWITCH. ALL L15 LIGHTS ON SWITCH BY G.C. TO BE DIMMABLE

1. ALL SWITCHES SHALL BE DECORA ROCKER TYPE, OR EQUAL.

2. SWITCHES & COVER PLATES LOCATED ON PAINTED GYPSUM

3. SWITCHES LOCATED ON STONE OR WOOD TO BE BLACK WITH STAINLESS STEEL COVER PLATES.

L12 IN-CABINET LIGHT, DOOR ACTIVATED

L16 SWITCH

LI7 LED STRIP

BOARD TO BE WHITE.

L6

L8

T.B.D. BY OWNER

BY G.C.

BY G.C.

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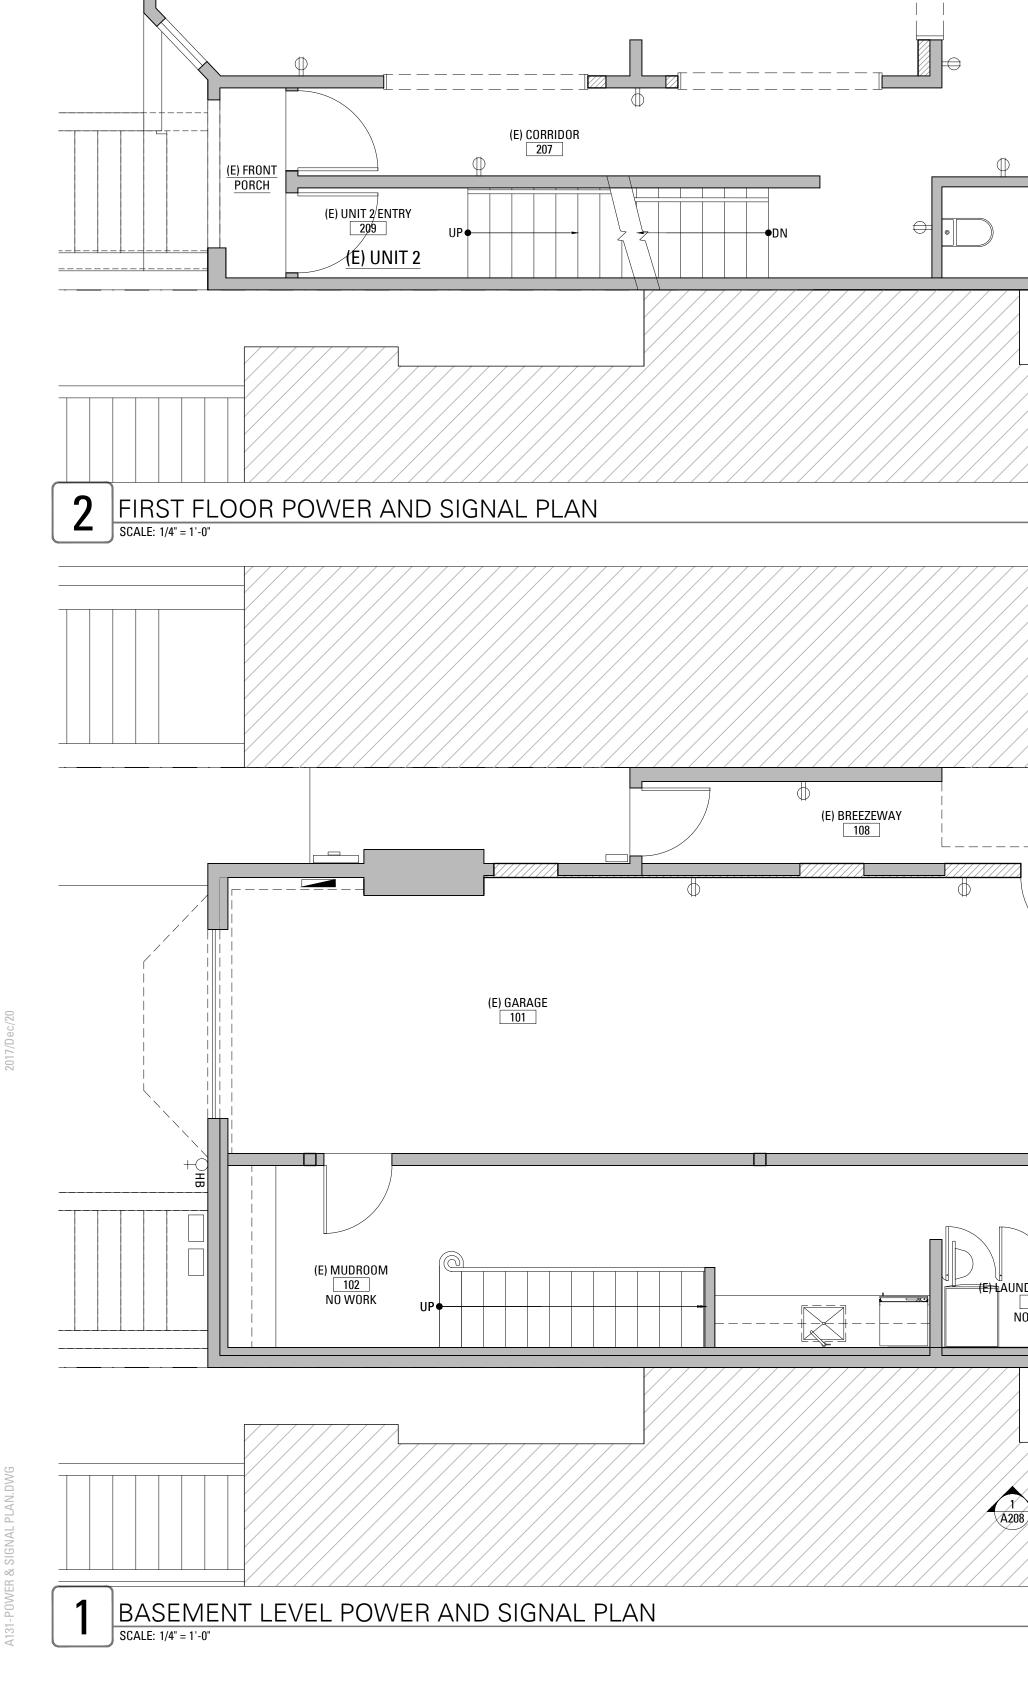
| 3639 20TH STREET SAN FRANCISCO, CA 94110 |
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| |
| MARTINKOVIC MILFORD |
| ARCHITECTS |
| 101 Montgomery Street Suite 650 San Francisco, CA 94104 T 415 346 9990 |
| 349 5th Avenue New York, NY 10016 |
| T 646 741 0341 |
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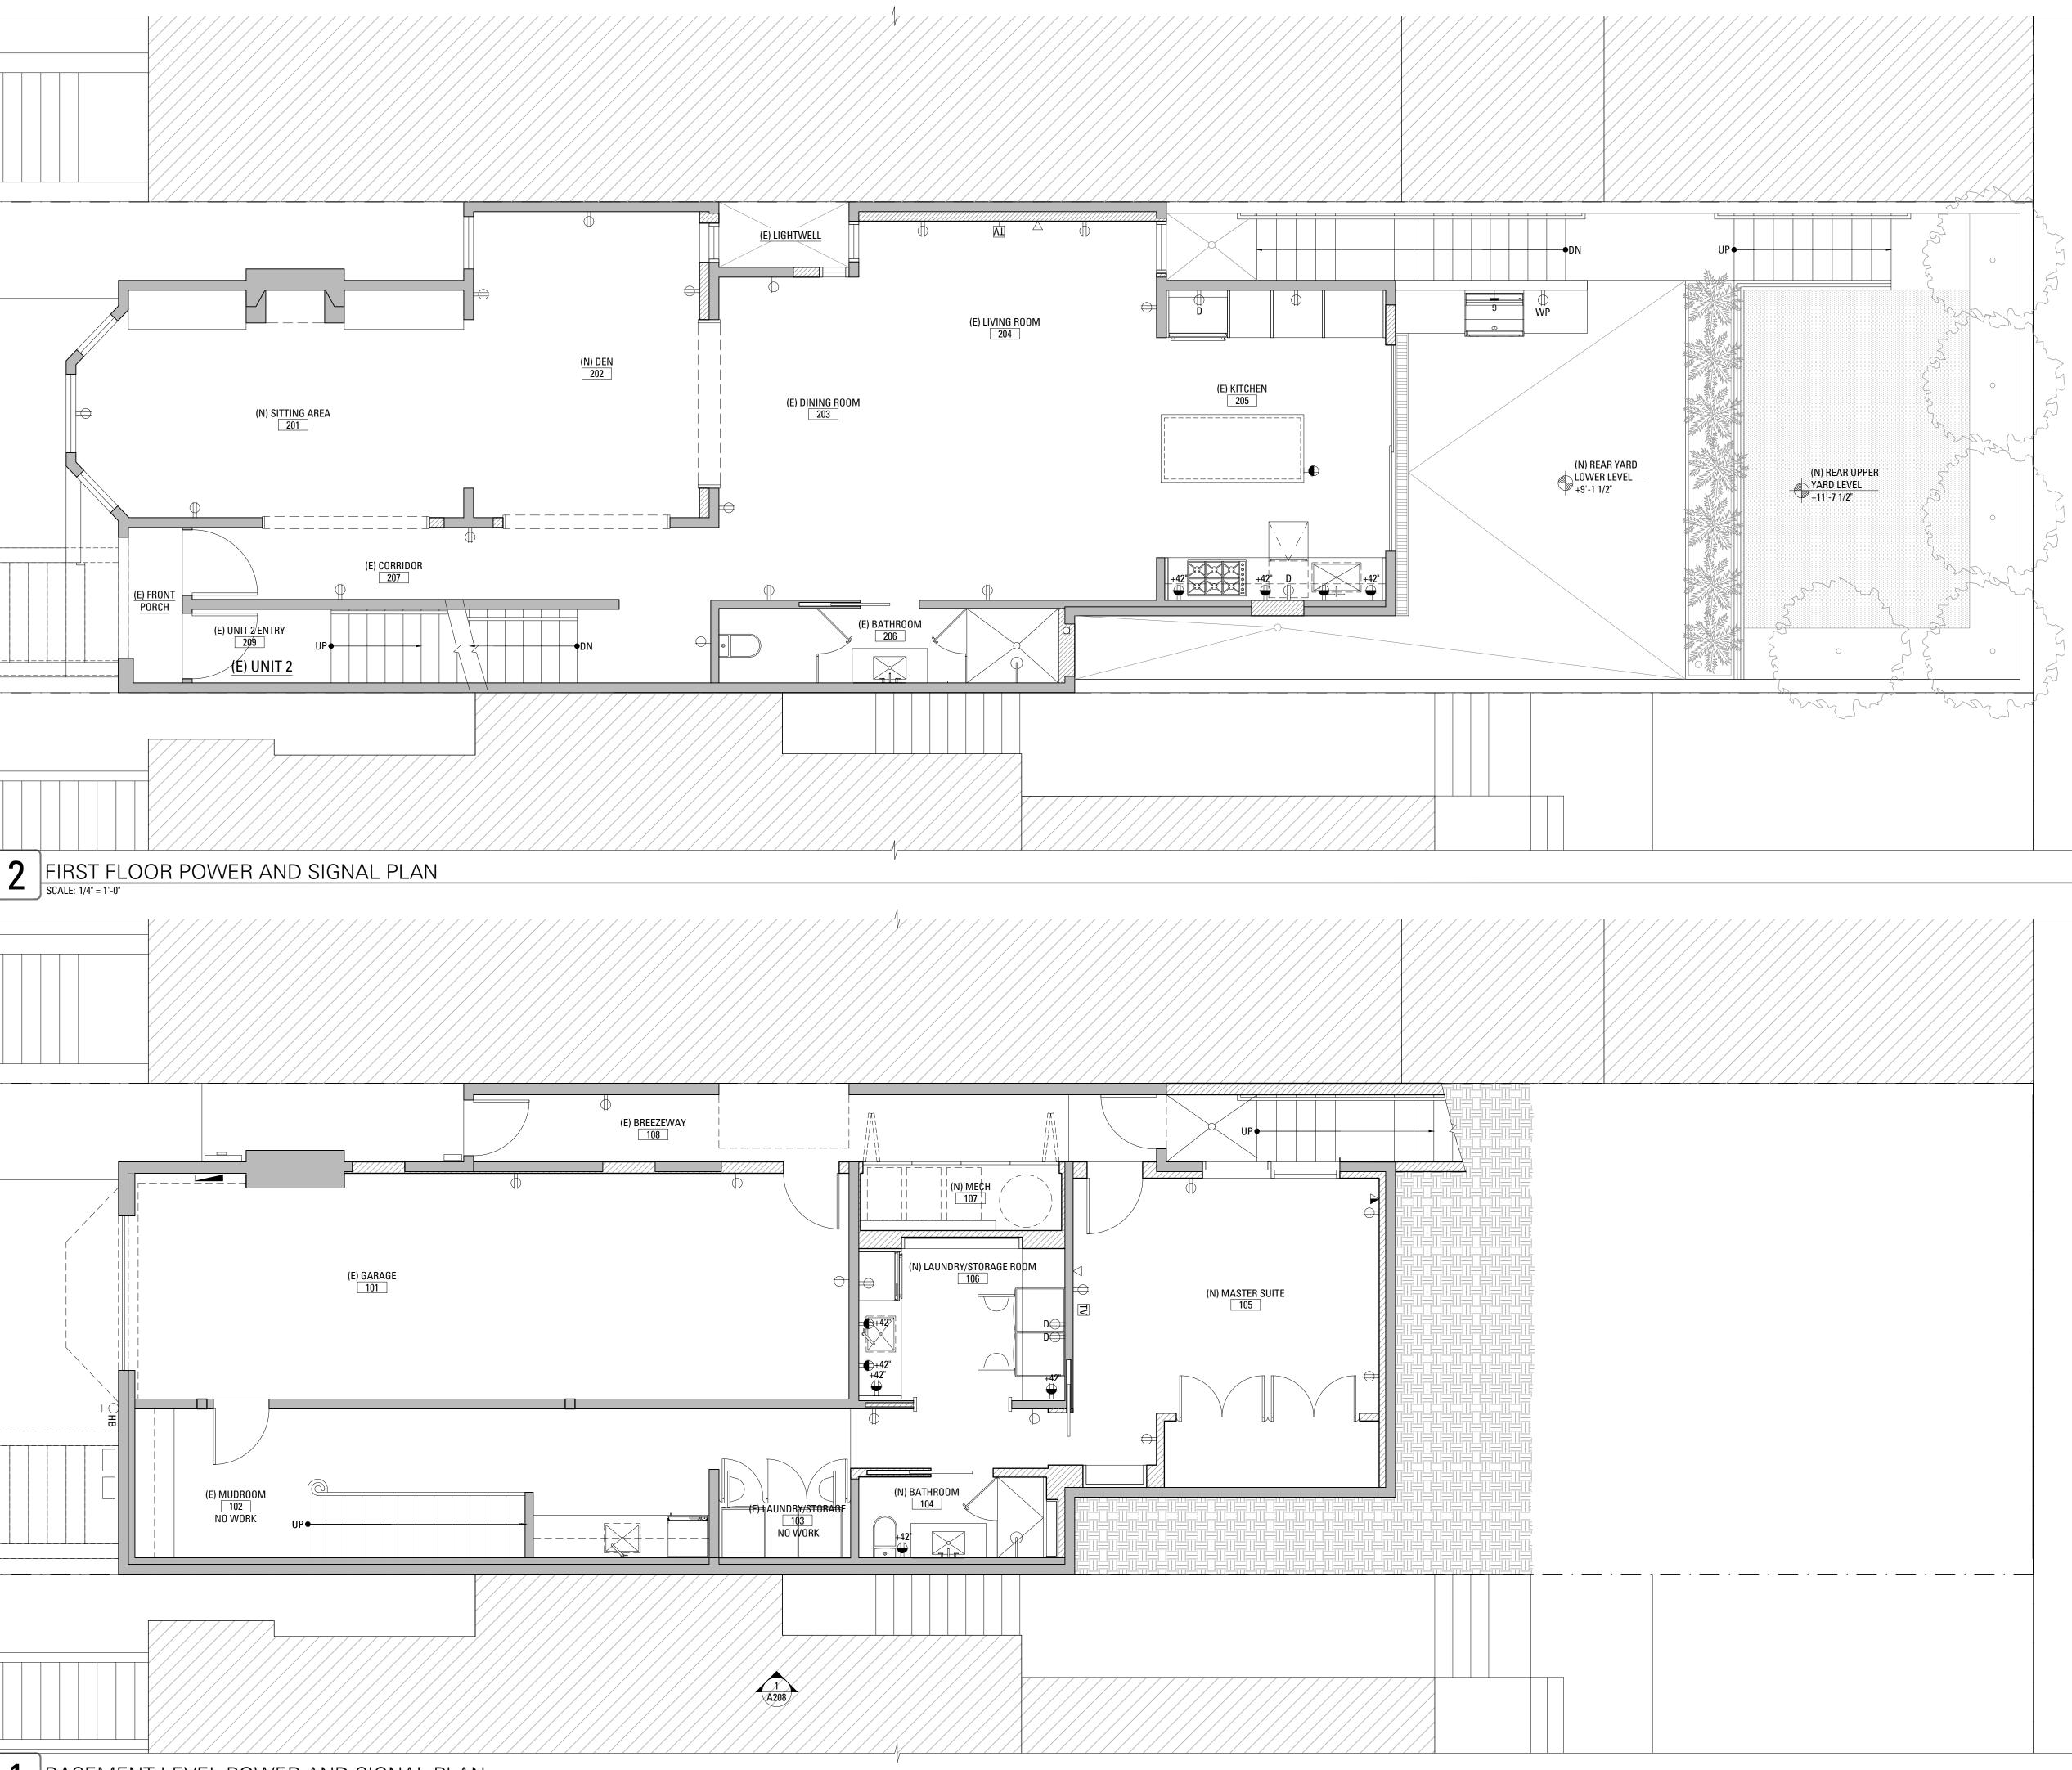
3639 20TH STREET


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| Permit Set Revision 2 | |
|---------------------------|-------------|
| Drawn By: | LGB |
| Checked By : | KB |
| Project Number: | 1635.1 |
| Reflected C Second & A | • |
| SHEET N | N U M B E R |
| Α1 | າງ |







(N) GROUNDED DUPLEX ELECTRICAL OUTLET \bigcirc

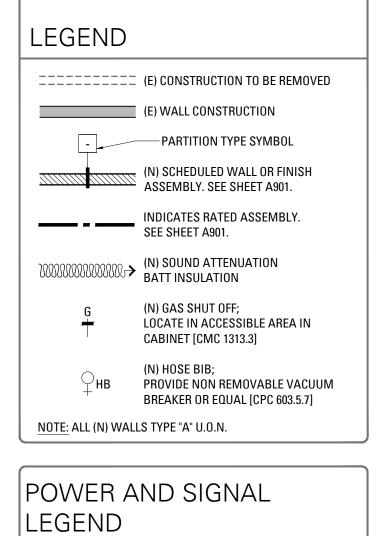SYMBOL RECEPTACLE TYPE

- (N) GROUNDED DUPLEX ELECTRICAL OUTLET, DEDICATED Φ
- WP ∯ (N) GROUNDED DUPLEX ELECTRICAL OUTLET W. ALL WEATHER USE COVER
- (N) GFCI ELECTRICAL OUTLET AT 42"A.F.F., U.O.N.; ORIENT HORIZONTALLY \bigoplus
- (N) CABLE/SATELITE TV JACK.
- \bigtriangledown (N) TELE PORT @ 18" AFF, U.O.N.
- (N) DATA PORT @ 18" AFF, U.O.N.

NOTES: 1. ALL OUTLETS SHALL BE DECORA ROCKER TYPE, OR EQUAL.

POWER & SIGNAL KEYNOTES P1 COORDINATE AND VERIFY POWER REQUIREMENT TO ACCOMMODATE INSTALLATION (P2) LOCATED ON INSIDE FACE OF CABINET


P3 OUTLET TO BE LOCATED PER TOWEL WARMER



| Permit Set | 05.15.2017 |
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| Permit Set Revision 2 | |
|--------------------------|--------------|
| Drawn By: | LGB |
| Checked By : | KB |
| Project Number: | 1635.1 |
| - | |
| Basement 8 | |
| | First Floors |



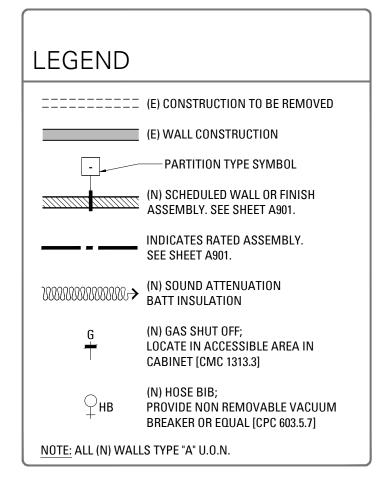

POWER AND SIGNAL


| LEGEND | | | |
|--------|-----------------|--|--|
| SYMBOL | RECEPTACLE TYPE | | |

- \bigoplus (N) GROUNDED DUPLEX ELECTRICAL OUTLET
- D (N) GROUNDED DUPLEX ELECTRICAL OUTLET, DEDICATED
- WP
(N) GROUNDED DUPLEX ELECTRICAL OUTLET W. ALL
WEATHER USE COVER
- (N) GFCI ELECTRICAL OUTLET AT 42"A.F.F., U.O.N.; ORIENT HORIZONTALLY
- (N) CABLE/SATELITE TV JACK.
- √ (N) TELE PORT @ 18" AFF, U.O.N.
- ▼ (N) DATA PORT @ 18" AFF, U.O.N.

NOTES: 1. ALL OUTLETS SHALL BE DECORA ROCKER TYPE, OR EQUAL.

| | WER & SIGNAL (NOTES |
|-----------|---|
| (P1) | COORDINATE AND VERIFY POWER REQUIREMENT TO ACCOMMODATE INSTALLATION |
| (P2) | LOCATED ON INSIDE FACE OF CABINET |
| P3 | OUTLET TO BE LOCATED PER TOWEL WARMER |



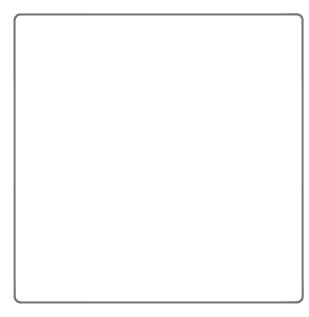

RECORD OF DRAWING ISSUANCE

| Permit Set | 05.15.2017 | | | |
|-----------------------|--------------|--|--|--|
| Permit Set Revision 1 | 10.04.2017 | | | |
| Permit Set Revision 2 | 2 12.20.2017 | | | |
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| Perm | it Set | | | |
| Revis | ion 2 | | | |
| Drawn By: | LGB | | | |
| Checked By : | KB | | | |
| Project Number: | 1635.1 | | | |
| Power & Signal Plans | | | | |
| Second & / | Attic Floors | | | |

SHEET NUMBER



1 EXISTING NORTH ELEVATION - NO PROPOSED WORK AT MAIN FACADE



| | | EVATION KEYNOTES | 3639 20TH STREET |
|-------------------|------|---|--|
| | E | (E) DOOR, WINDOW OR SKYLIGHT TO REMAIN. | RESIDENCE REMODEL |
| | | (E) DOOR OR WINDOW TO BE REMOVED. | |
| | R | (E) DOOR OR WINDOW TO BE REPLACED IN KIND. | |
| | N | (N) DOOR OR WINDOW FOR REPLACING (E) IN KIND. | 3639 20TH STREET SAN FRANCISCO, CA 94110 |
| | | (E) INTEGRAL COLOR PLASTER FINISH TO REMAIN. | |
| | 2 | (E) EXTERIOR STAIRS TO REMAIN | |
| | 3 | (E) SKYLIGHT TO BE REMOVED. | |
| | 4 | PORTION OF (E) WALL TO BE REMOVED TO ACCOMMODATE (N) WORK, SEE DEMOLITION AND CONSTRUCTION PLANS. | MARTINKOVIC MILFORD |
| | 5 | (E) DECK TO BE REMOVED. | ARCHITECTS |
| | 6 | (E) ASPHALT SHINGLES ROOF TO REMAIN. | 101 Montgomery Street Suite 650 San Francisco, CA 94104 T 415 346 9990 |
| | 1 | (E) WOOD SIDING TO REMAIN. | 349 5th Avenue New York, NY 10016 T 646 741 0341 |
| | 8 | (E) PAINTED WOOD TRIM TO REMAIN. | |
| | 9 | (E) PAINTED WOOD SIDING TO REMAIN UNLESS IT IS TOO DAMAGED TO BE REPAIRED, AND THAT ANY REMOVAL OF WOOD SIDING WILL BE REVIEWED AND APPROVED BY THE PLANNING DEPARTMENT. | |
| | 10 | (E) EXTERIOR STAIRS TO BE REMOVED. | SUPPORT T. MILLION |
| | 11 | NOT USED | * No.CBB490 5 * |
| | 12 | (N) EXTERIOR STAIRS | OF CALIFOR |
| | 13 | (N) PERIMETER FENCE | |
| | 14 | (N) LOW WALL, PAINTED STUCCO FINISH | |
| 2 | 15 | PORTION OF (E) ROOF TO BE REMOVED TO ACCOMMODATE (N) WORK; SEE DEMOLITION AND | |
| { | 16 | CONSTRUCTION PLANS | \mathbf{S} |
| | 17 | (N) SKYLIGHT | |
| <u>م</u> | (18) | (N) GUARDRAIL, 42" A.F.F. | |
| | 19 | (E) SINGLE HUNG WINDOW GLAZING AND SASHES TO BE REPLACED IN KIND, (E) WINDOW FRAME AND TRIM TO REMAIN WITH TOP SASH TO BE OPERABLE, SEE WINDOW SCHEDULE | |
| | 20 | (N) DRYER VENT, 4 SQ. INCHES MINIMUM | |
| 2 | 21 | (N) PAINTED WOOD SIDING TO MATCH ADJACENT | |
| $\left\{ \right.$ | 22 | (E) FRONT DOOR TO REMAIN, (E) GLAZING TO BE REPLACED WITH TRANSPARENT GLAZING AND (E) HARDWARE TO BE REPLACED. | |
| - N | | (N) EXTERIOR WALL SCONCE, SEE RCP | |


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| Permit Set | 05.15.2017 | | | |
| Permit Set Revision 1 | 10.04.2017 | | | |
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| Revis | | | | |
| Drawn By: | LGB | | | |
| Checked By : | КВ | | | |
| Project Number: | 1635.1 | | | |
| Existing Exterior Elevation North | | | | |
| SHEET NUMBER | | | | |
| A201 | | | | |



| | ELE | EVATION KEYNOTES | | |
|----------------------|-----|---|----|--|
| | E | (E) DOOR, WINDOW OR SKYLIGHT TO REMAIN. | | 3639 20TH STREET RESIDENCE REMODEL |
| | D | (E) DOOR OR WINDOW TO BE REMOVED. | | |
| | R | (E) DOOR OR WINDOW TO BE REPLACED IN KIND. | | |
| | N | (N) DOOR OR WINDOW FOR REPLACING (E) IN KIND. | | 3639 20TH STREET |
| | 1 | (E) INTEGRAL COLOR PLASTER FINISH TO REMAIN. | | SAN FRANCISCO, CA 94110 |
| | 2 | (E) EXTERIOR STAIRS TO REMAIN | | |
| | 3 | (E) SKYLIGHT TO BE REMOVED. | - | |
| | 4 | PORTION OF (E) WALL TO BE REMOVED TO ACCOMMODATE (N) WORK, SEE DEMOLITION AND CONSTRUCTION PLANS. | | MARTINKOVIC MILFORD |
| | 5 | (E) DECK TO BE REMOVED. | | ARCHITECTS 101 Montgomery Street Suite 650 |
| | 6 | (E) ASPHALT SHINGLES ROOF TO REMAIN. | | San Francisco, CA 94104 T 415 346 9990 |
| | 7 | (E) WOOD SIDING TO REMAIN. | | 349 5th Avenue New York, NY 10016 T 646 741 0341 |
| $\hat{2}$ | 8 | (E) PAINTED WOOD TRIM TO REMAIN. | | |
| | 9 | (E) PAINTED WOOD SIDING TO REMAIN UNLESS IT IS TOO DAMAGED TO BE REPAIRED, AND THAT ANY REMOVAL OF WOOD SIDING WILL BE REVIEWED AND APPROVED BY THE PLANNING DEPARTMENT. | | SED ARCIN |
| | | (E) EXTERIOR STAIRS TO BE REMOVED. | | THE THE PARTY OF |
| | 11 | NOT USED | | * No.C33430 * |
| | 12 | (N) EXTERIOR STAIRS | | CALIFOR CAL |
| | 13 | (N) PERIMETER FENCE | | |
| | 14 | (N) LOW WALL, PAINTED STUCCO FINISH | | |
| 2 | 15 | PORTION OF (E) ROOF TO BE REMOVED TO ACCOMMODATE (N) WORK; SEE DEMOLITION AND CONSTRUCTION READS | | |
| { | 16 | (E) WOOD PANEL INFILL AND DECORATIVE TRIMS TO REMAIN | 3 | |
| | 17 | (N) SKYLIGHT | | |
| <u>^</u> 2 | 18 | (N) GUARDRAIL, 42" A.F.F. | | |
| { | 19 | (E) SINGLE HUNG WINDOW GLAZING AND SASHES TO BE REPLACED IN KIND, (E) WINDOW FRAME AND TRIM TO REMAIN WITH TOP SASH TO BE OPERABLE, SEE WINDOW SCHEDULE | | |
| Ś | 20 | (N) DRYER VENT, 4 SQ. INCHES MINIMUM | 3 | |
| | 21 | (N) PAINTED WOOD SIDING TO MATCH ADJACENT SIDING MATERIAL | | |
| $\overline{\langle}$ | 22 | (E) FRONT DOOR TO REMAIN, (E) GLAZING TO BE REPLACED WITH TRANSPARENT GLAZING AND (E) HARDWARE TO BE REPLACED. | 3 | |
| | 23 | (N) EXTERIOR WALL SCONCE, SEE RCP | | |
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| | | | | RECORD OF DRAWING ISSUANCE |
| | | | | Permit Set 05.15.2017 |
| | | | | Permit Set Revision 1 10.04.2017 |
| | | | | Permit Set Revision 2 2 12.20.2017 |


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| Drawn By: | LGB | | | |
| Checked By : | KB | | | |
| Project Number: | 1635.1 | | | |
| Proposed Exterior Elevation North | | | | |
| SHEET N | NUMBER | | | |
| A202 | | | | |

(E) STREET LEVEL 0'-0"

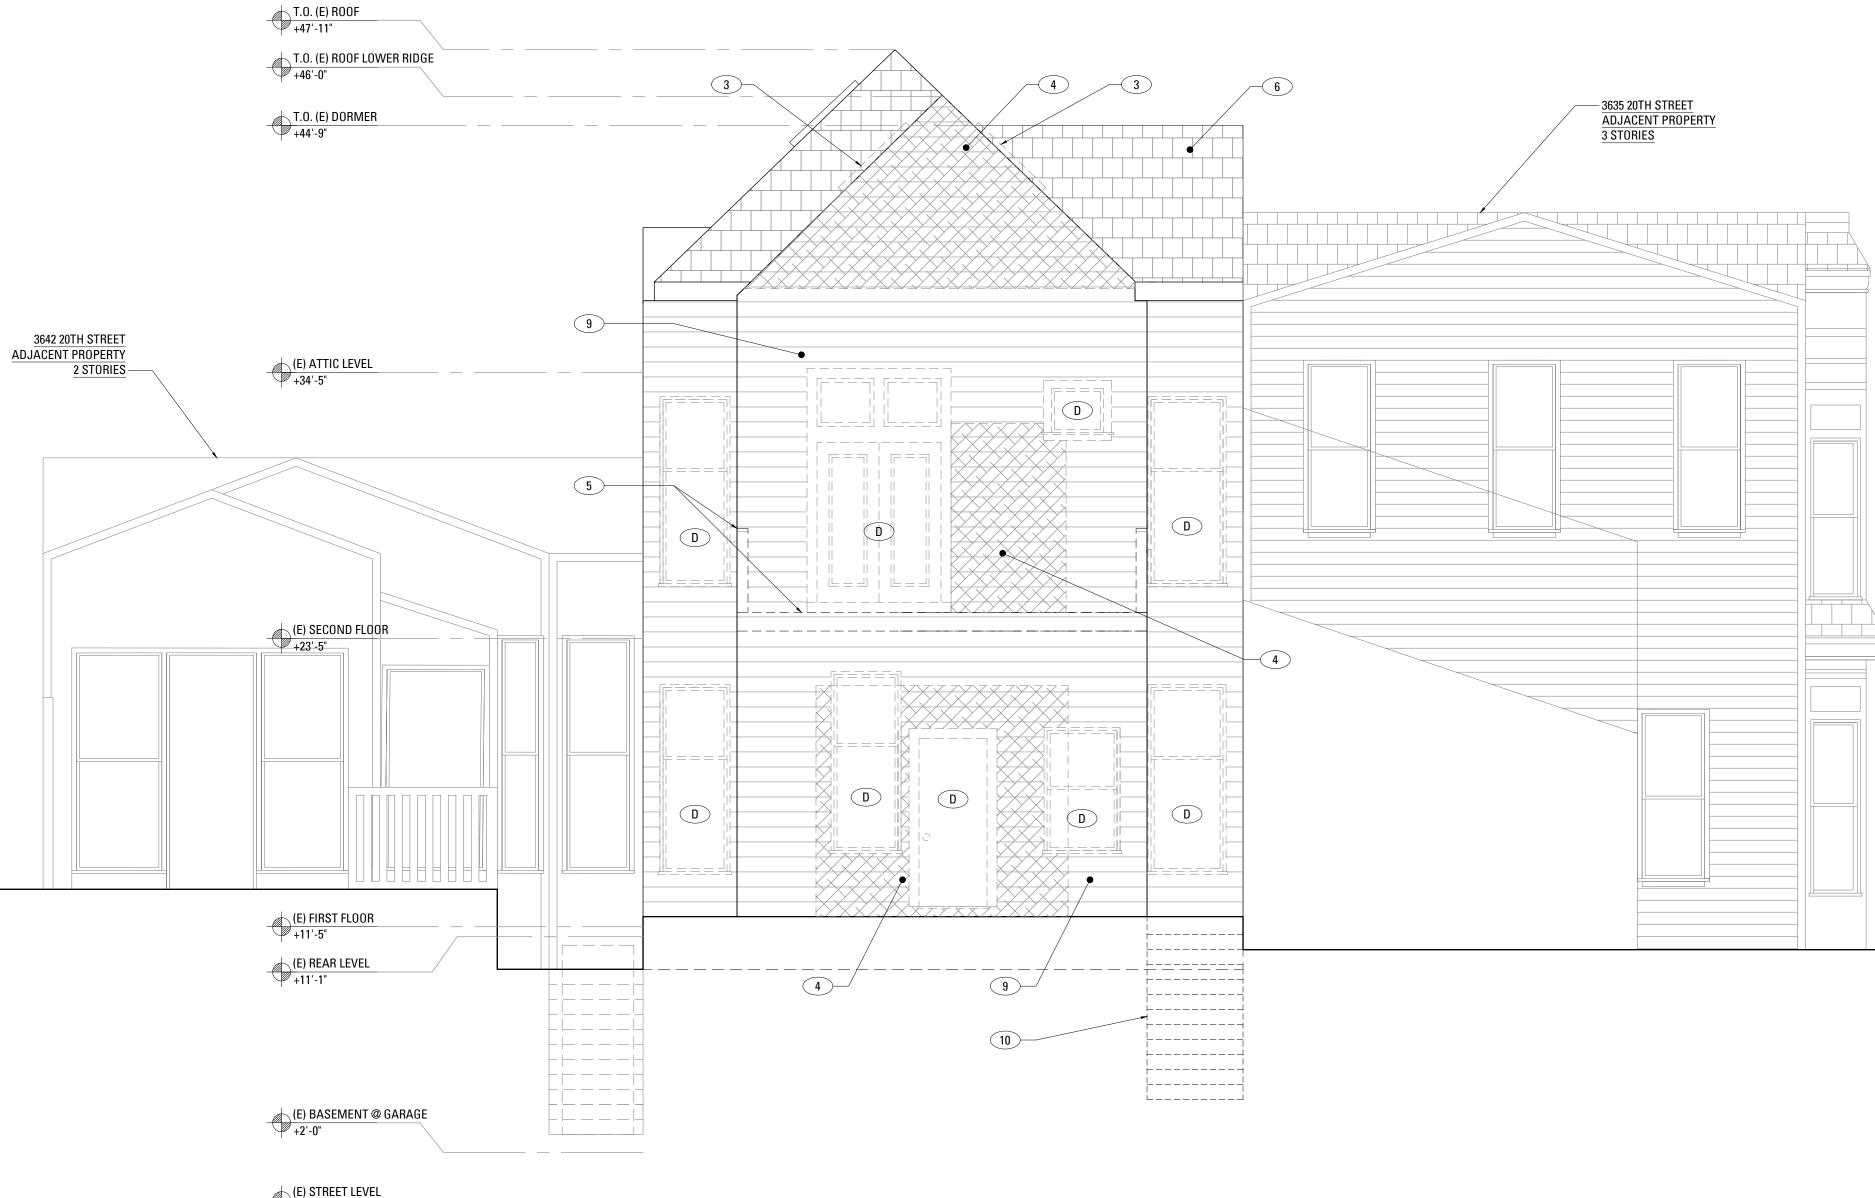

| E | (E) DOOR, WINDOW OR SKYLIGHT TO REMAIN. |
|------|---|
| D | (E) DOOR OR WINDOW TO BE REMOVED. |
| R | (E) DOOR OR WINDOW TO BE REPLACED IN KIND. |
| N | (N) DOOR OR WINDOW FOR REPLACING (E) IN KIND. |
| | (E) INTEGRAL COLOR PLASTER FINISH TO REMAIN. |
| 2 | (E) EXTERIOR STAIRS TO REMAIN |
| 3 | (E) SKYLIGHT TO BE REMOVED. |
| 4 | PORTION OF (E) WALL TO BE REMOVED TO ACCOMMODATE (N) WORK, SEE DEMOLITION AND CONSTRUCTION PLANS. |
| 5 | (E) DECK TO BE REMOVED. |
| 6 | (E) ASPHALT SHINGLES ROOF TO REMAIN. |
| 7 | (E) WOOD SIDING TO REMAIN. |
| 8 | (E) PAINTED WOOD TRIM TO REMAIN. |
| 9 | (E) PAINTED WOOD SIDING TO REMAIN UNLESS IT IS TOO DAMAGED TO BE REPAIRED, AND THAT ANY REMOVAL OF WOOD SIDING WILL BE REVIEWED AND APPROVED BY THE PLANNING DEPARTMENT. |
| 10 | (E) EXTERIOR STAIRS TO BE REMOVED. |
| 11 | NOT USED |
| 12 | (N) EXTERIOR STAIRS |
| 13 | (N) PERIMETER FENCE |
| 14 | (N) LOW WALL, PAINTED STUCCO FINISH |
| 15 | PORTION OF (E) ROOF TO BE REMOVED TO ACCOMMODATE (N) WORK; SEE DEMOLITION AND CONSTRUCTION PLANS |
| 16 | (E) WOOD PANEL INFILL AND DECORATIVE TRIMS TO REMAIN |
| 17 | (N) SKYLIGHT |
| 18 | (N) GUARDRAIL, 42" A.F.F. |
| 19 | (E) SINGLE HUNG WINDOW GLAZING AND SASHES TO BE REPLACED IN KIND, (E) WINDOW FRAME AND TRIM TO REMAIN WITH TOP SASH TO BE OPERABLE, SEE WINDOW SCHEDULE |
| 20 | (N) DRYER VENT, 4 SQ. INCHES MINIMUM |
| 21 | (N) PAINTED WOOD SIDING TO MATCH ADJACENT SIDING MATERIAL |
| 22 | (E) FRONT DOOR TO REMAIN, (E) GLAZING TO BE REPLACED WITH TRANSPARENT GLAZING AND (E) HARDWARE TO BE REPLACED. |
| (23) | (N) EXTERIOR WALL SCONCE, SEE RCP |

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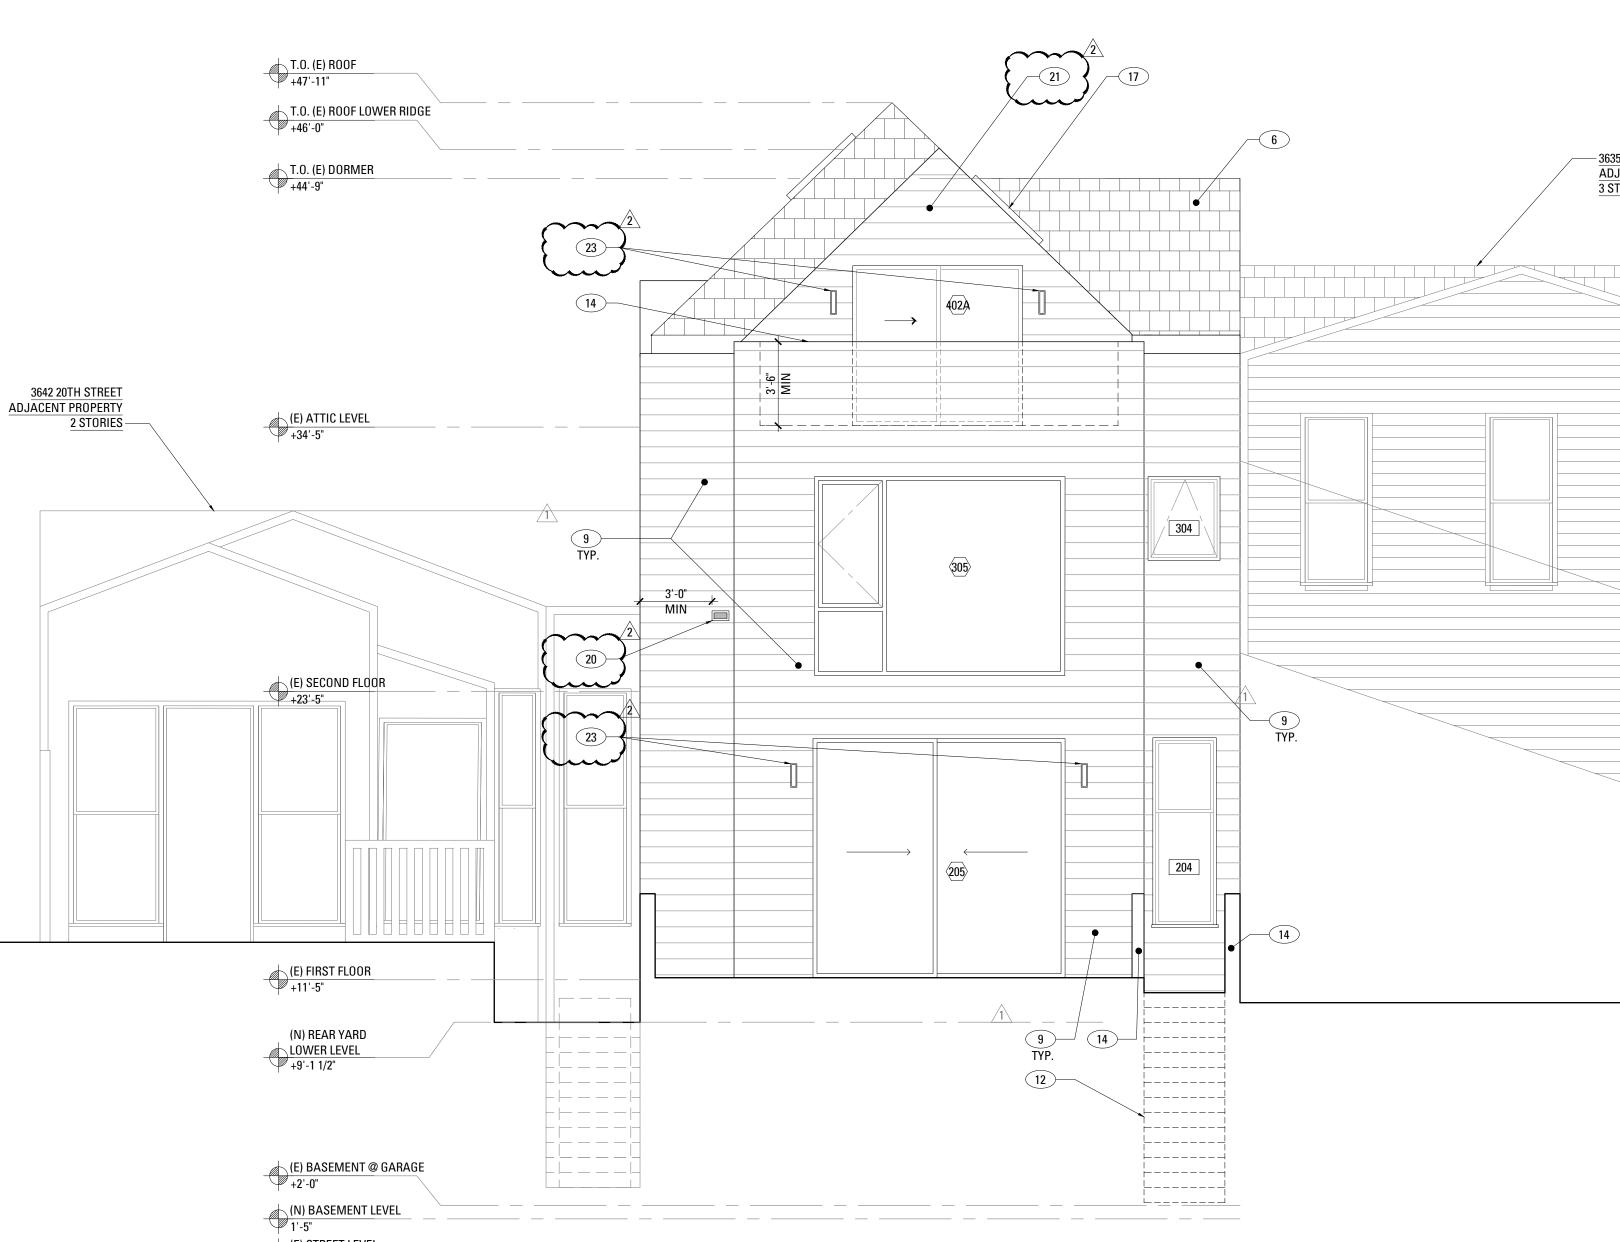


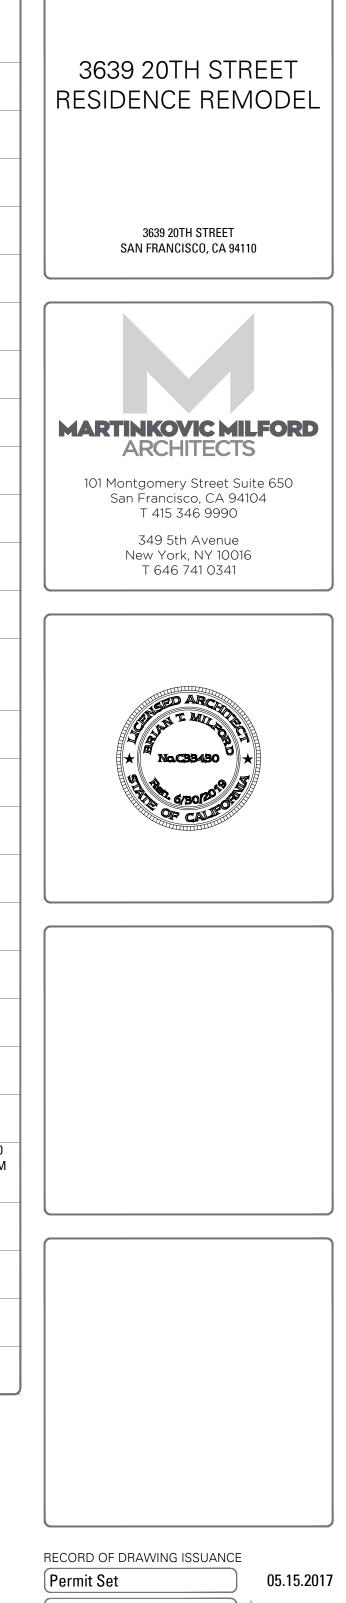
| Permit Set | 05.15.2017 |
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| Permit Set Revision 1 | 10.04.2017 |
| Permit Set Revision 2 | |
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| Perm | it Set |
| Revis | ion 2 |
| Drawn By: | LGB |
| Checked By : | KB |
| Project Number: | 1635.1 |
| Existing Exter | rior Elevation |

South SHEET NUMBER



(N) BASEMENT LEVEL 1'-5" (E) STREET LEVEL 0'-0"




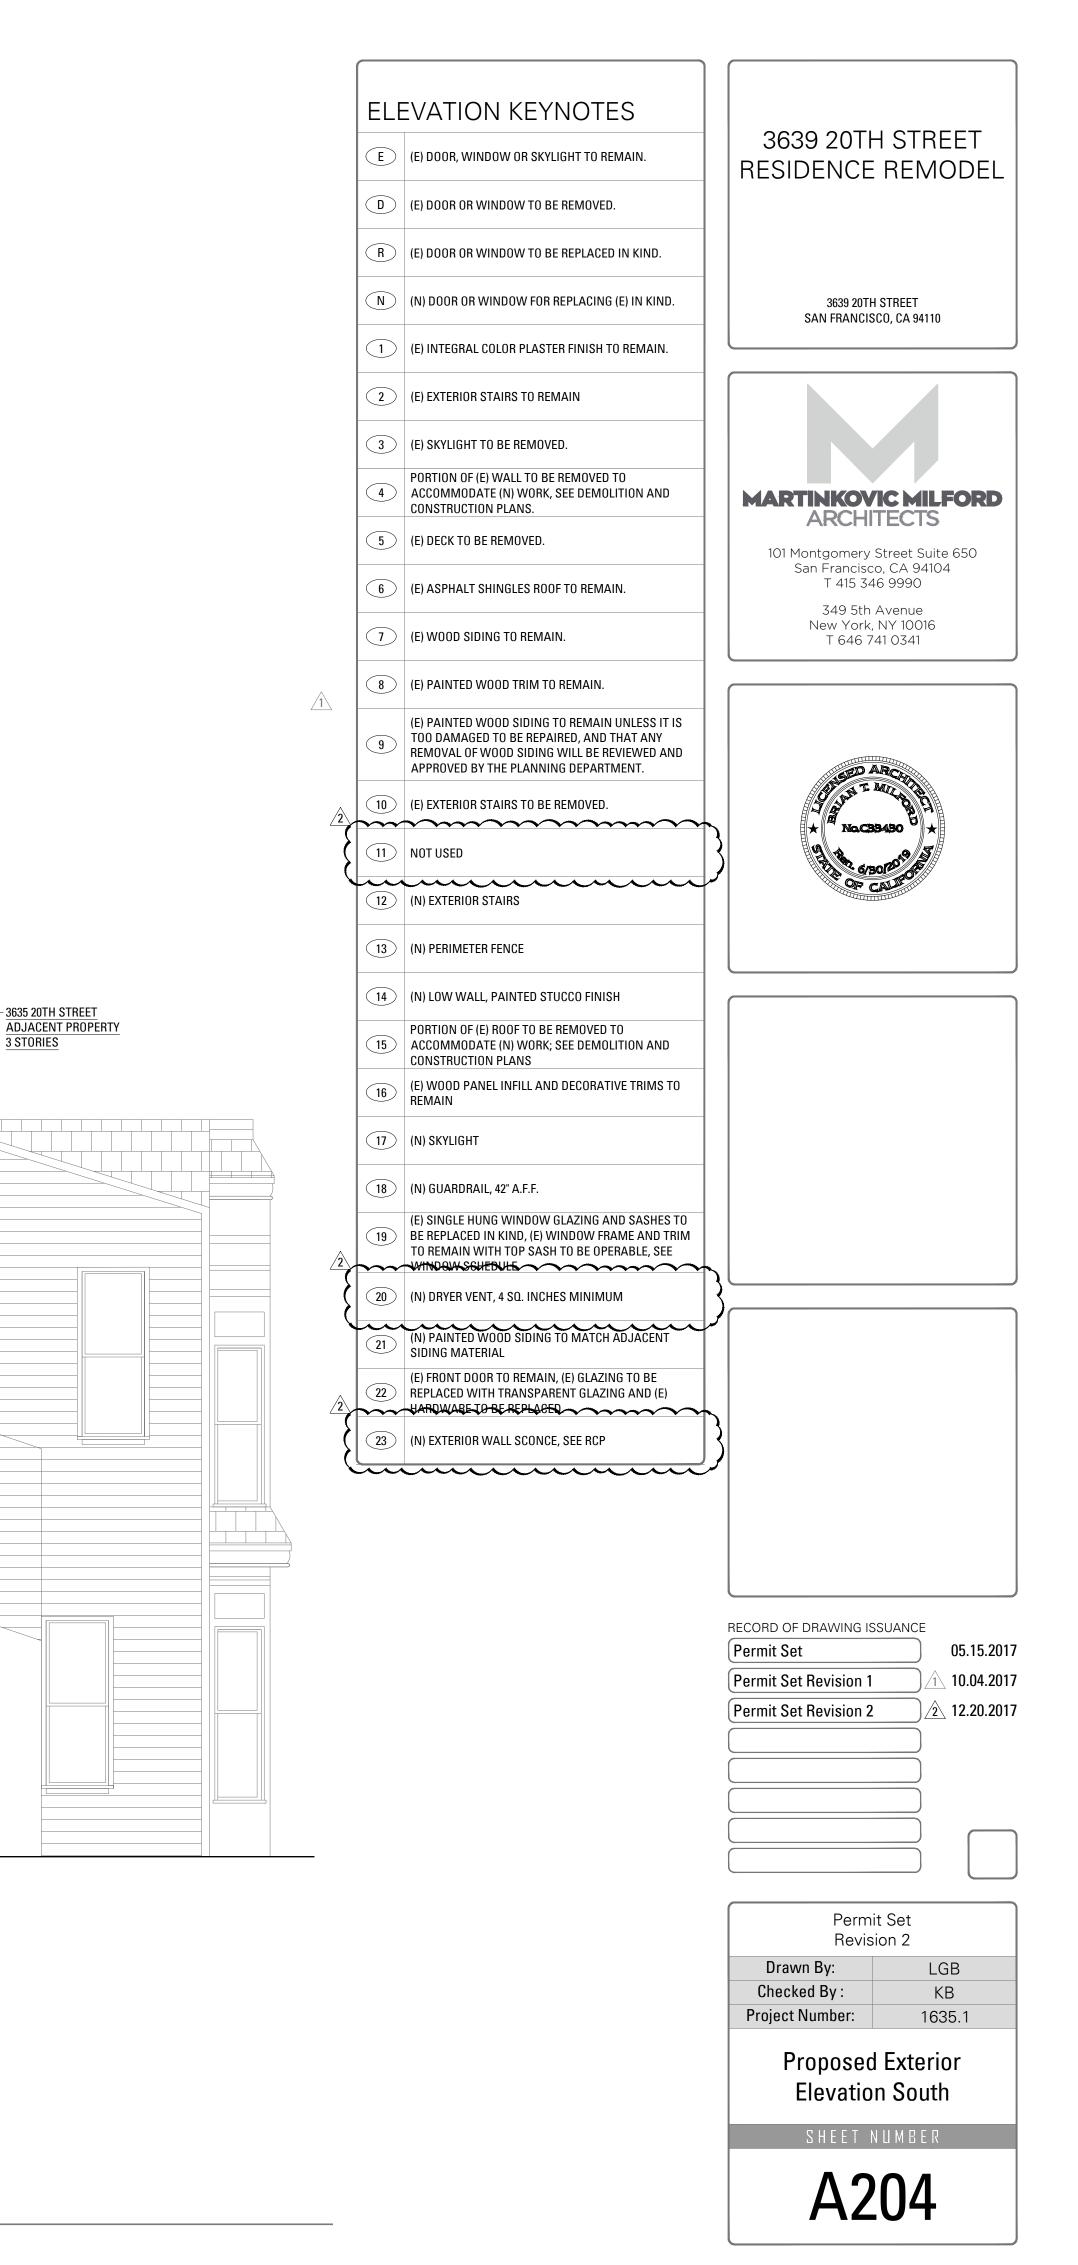



3635 20TH STREET ADJACENT PROPERTY


<u>3 STORIES</u> IN FOREGROUND –

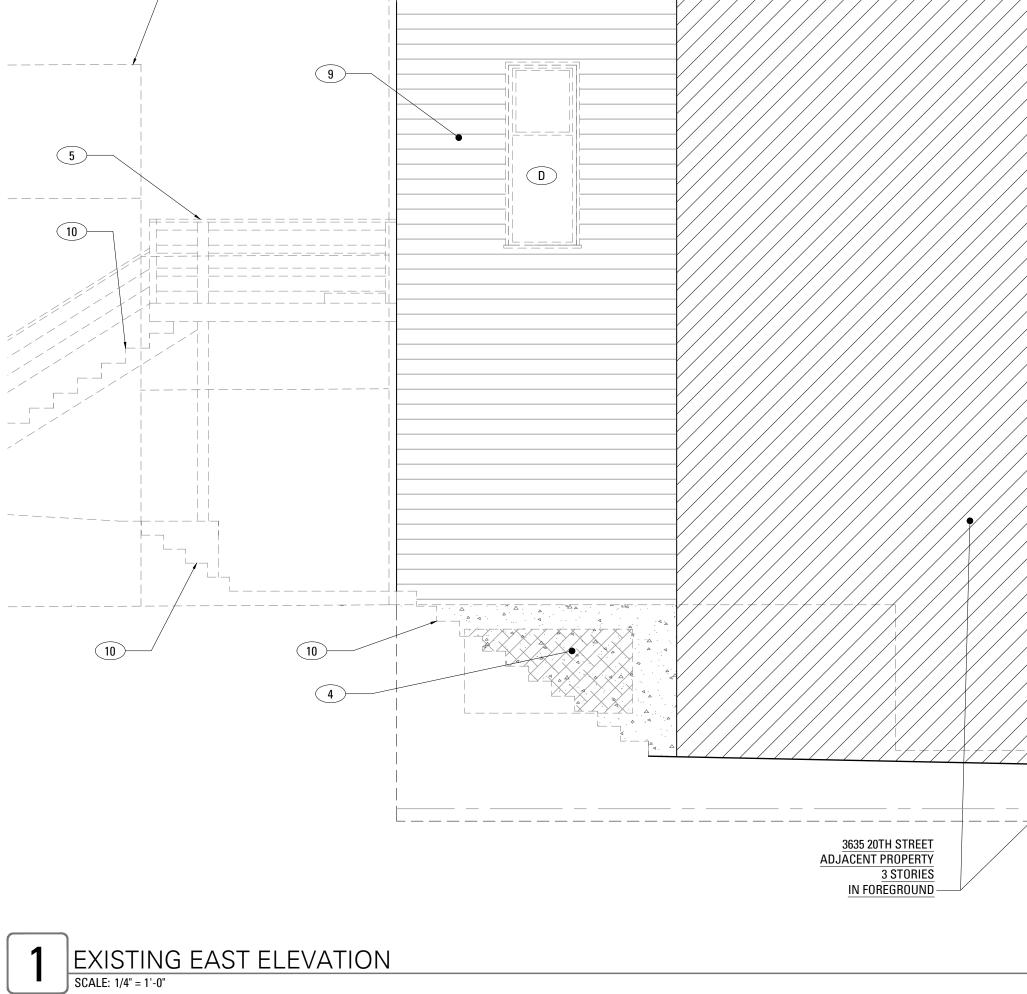

(D)

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(E) REAR LEVEL +11'-1"


(E) STREET LEVEL 0'-0"

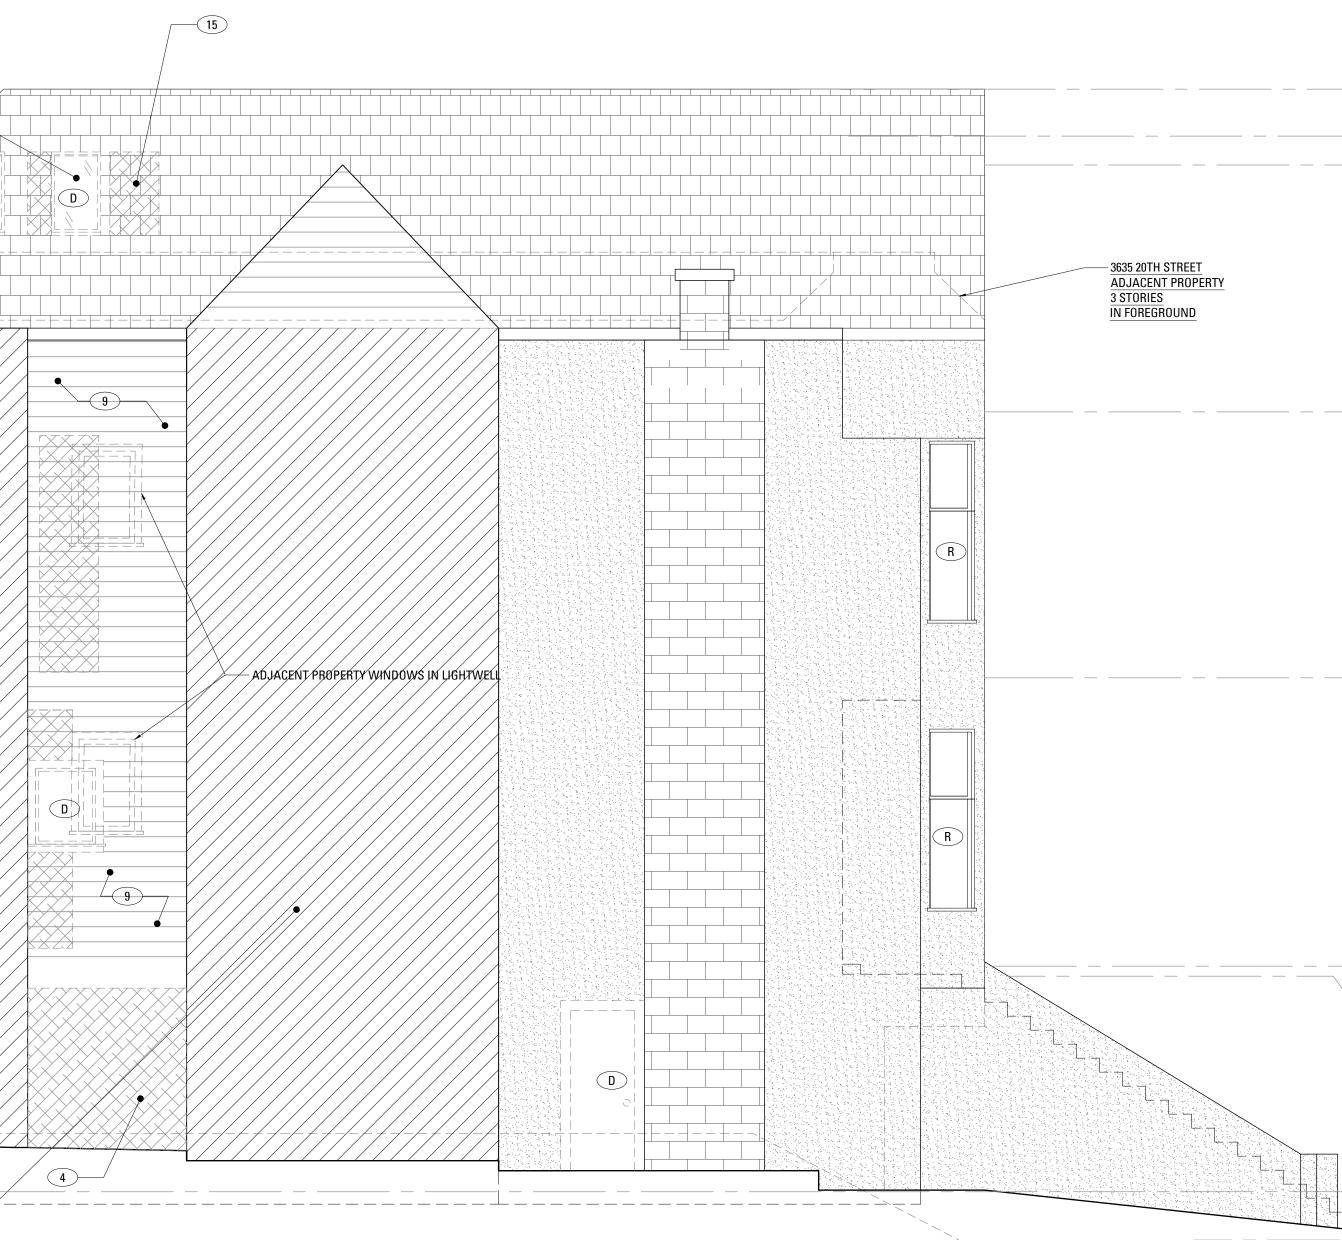(E) BASEMENT @ GARAGE +2'-0"

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| | ELE | EVATION KEYNOTES | |
|--------------------------------------|-----|---|---|
| | E | (E) DOOR, WINDOW OR SKYLIGHT TO REMAIN. | 3639 20TH STREET |
| | D | (E) DOOR OR WINDOW TO BE REMOVED. | |
| | R | (E) DOOR OR WINDOW TO BE REPLACED IN KIND. | |
| | N | (N) DOOR OR WINDOW FOR REPLACING (E) IN KIND. | 3639 20TH STREET |
| | | (E) INTEGRAL COLOR PLASTER FINISH TO REMAIN. | SAN FRANCISCO, CA 94110 |
| | 2 | (E) EXTERIOR STAIRS TO REMAIN | |
| | 3 | (E) SKYLIGHT TO BE REMOVED. | |
| | 4 | PORTION OF (E) WALL TO BE REMOVED TO ACCOMMODATE (N) WORK, SEE DEMOLITION AND CONSTRUCTION PLANS. | MARTINKOVIC MILFORD |
| | 5 | (E) DECK TO BE REMOVED. | ARCHITECTS 101 Montgomery Street Suite 650 |
| | 6 | (E) ASPHALT SHINGLES ROOF TO REMAIN. | San Francisco, CA 94104 T 415 346 9990 349 5th Avenue |
| | 7 | (E) WOOD SIDING TO REMAIN. | New York, NY 10016 T 646 741 0341 |
| | 8 | (E) PAINTED WOOD TRIM TO REMAIN. | |
| | 9 | (E) PAINTED WOOD SIDING TO REMAIN UNLESS IT IS TOO DAMAGED TO BE REPAIRED, AND THAT ANY REMOVAL OF WOOD SIDING WILL BE REVIEWED AND APPROVED BY THE PLANNING DEPARTMENT. | ED ARCH |
| | 10 | (E) EXTERIOR STAIRS TO BE REMOVED. | CONTRACT TO AND THE AND |
| | 11 | NOT USED | * Nac38430 * |
| | 12 | (N) EXTERIOR STAIRS | OF CALIFORNIA |
| T.O. (E) ROOF +47'-11" | 13 | (N) PERIMETER FENCE | |
| T.O. (E) ROOF LOWER RIDGE +46'-0" | 14 | (N) LOW WALL, PAINTED STUCCO FINISH | |
| T.O. (E) DORMER +44'-9" | 15 | PORTION OF (E) ROOF TO BE REMOVED TO ACCOMMODATE (N) WORK; SEE DEMOLITION AND | |
| | 16 | CONSTRUCTION PLANS (E) WOOD PANEL INFILL AND DECORATIVE TRIMS TO REMAIN | |
| | 17 | (N) SKYLIGHT | |
| | 18 | (N) GUARDRAIL, 42" A.F.F. | |
| (E) ATTIC LEVEL | 19 | (E) SINGLE HUNG WINDOW GLAZING AND SASHES TO BE REPLACED IN KIND, (E) WINDOW FRAME AND TRIM TO REMAIN WITH TOP SASH TO BE OPERABLE, SEE WINDOW SCHEDULE | |
| +34'-5" | 20 | (N) DRYER VENT, 4 SQ. INCHES MINIMUM | |
| | 21 | (N) PAINTED WOOD SIDING TO MATCH ADJACENT SIDING MATERIAL | |
| | 22 | (E) FRONT DOOR TO REMAIN, (E) GLAZING TO BE REPLACED WITH TRANSPARENT GLAZING AND (E) HARDWARE TO BE REPLACED. | |
| | 23 | (N) EXTERIOR WALL SCONCE, SEE RCP | |
| | | | |
| (E) SECOND FLOOR +23'-5" | | | |
| | | | |
| | | | RECORD OF DRAWING ISSUANCE |
| | | | Permit Set Revision 1 10.04.2017 |
| | | | Permit Set Revision 2 2 12.20.2017 |
| | | | |
| | | | |
| (E) FIRST FLOOR +11'-5" | | | |
| +II-J 🌱 | | | |

| Permit Set Revision 2 | | | |
|-------------------------------------|--------|--|--|
| Drawn By: | LGB | | |
| Checked By : | КВ | | |
| Project Number: | 1635.1 | | |
| Existing Exterior Elevation East | | | |
| | 31 | | |
| SHEET | | | |

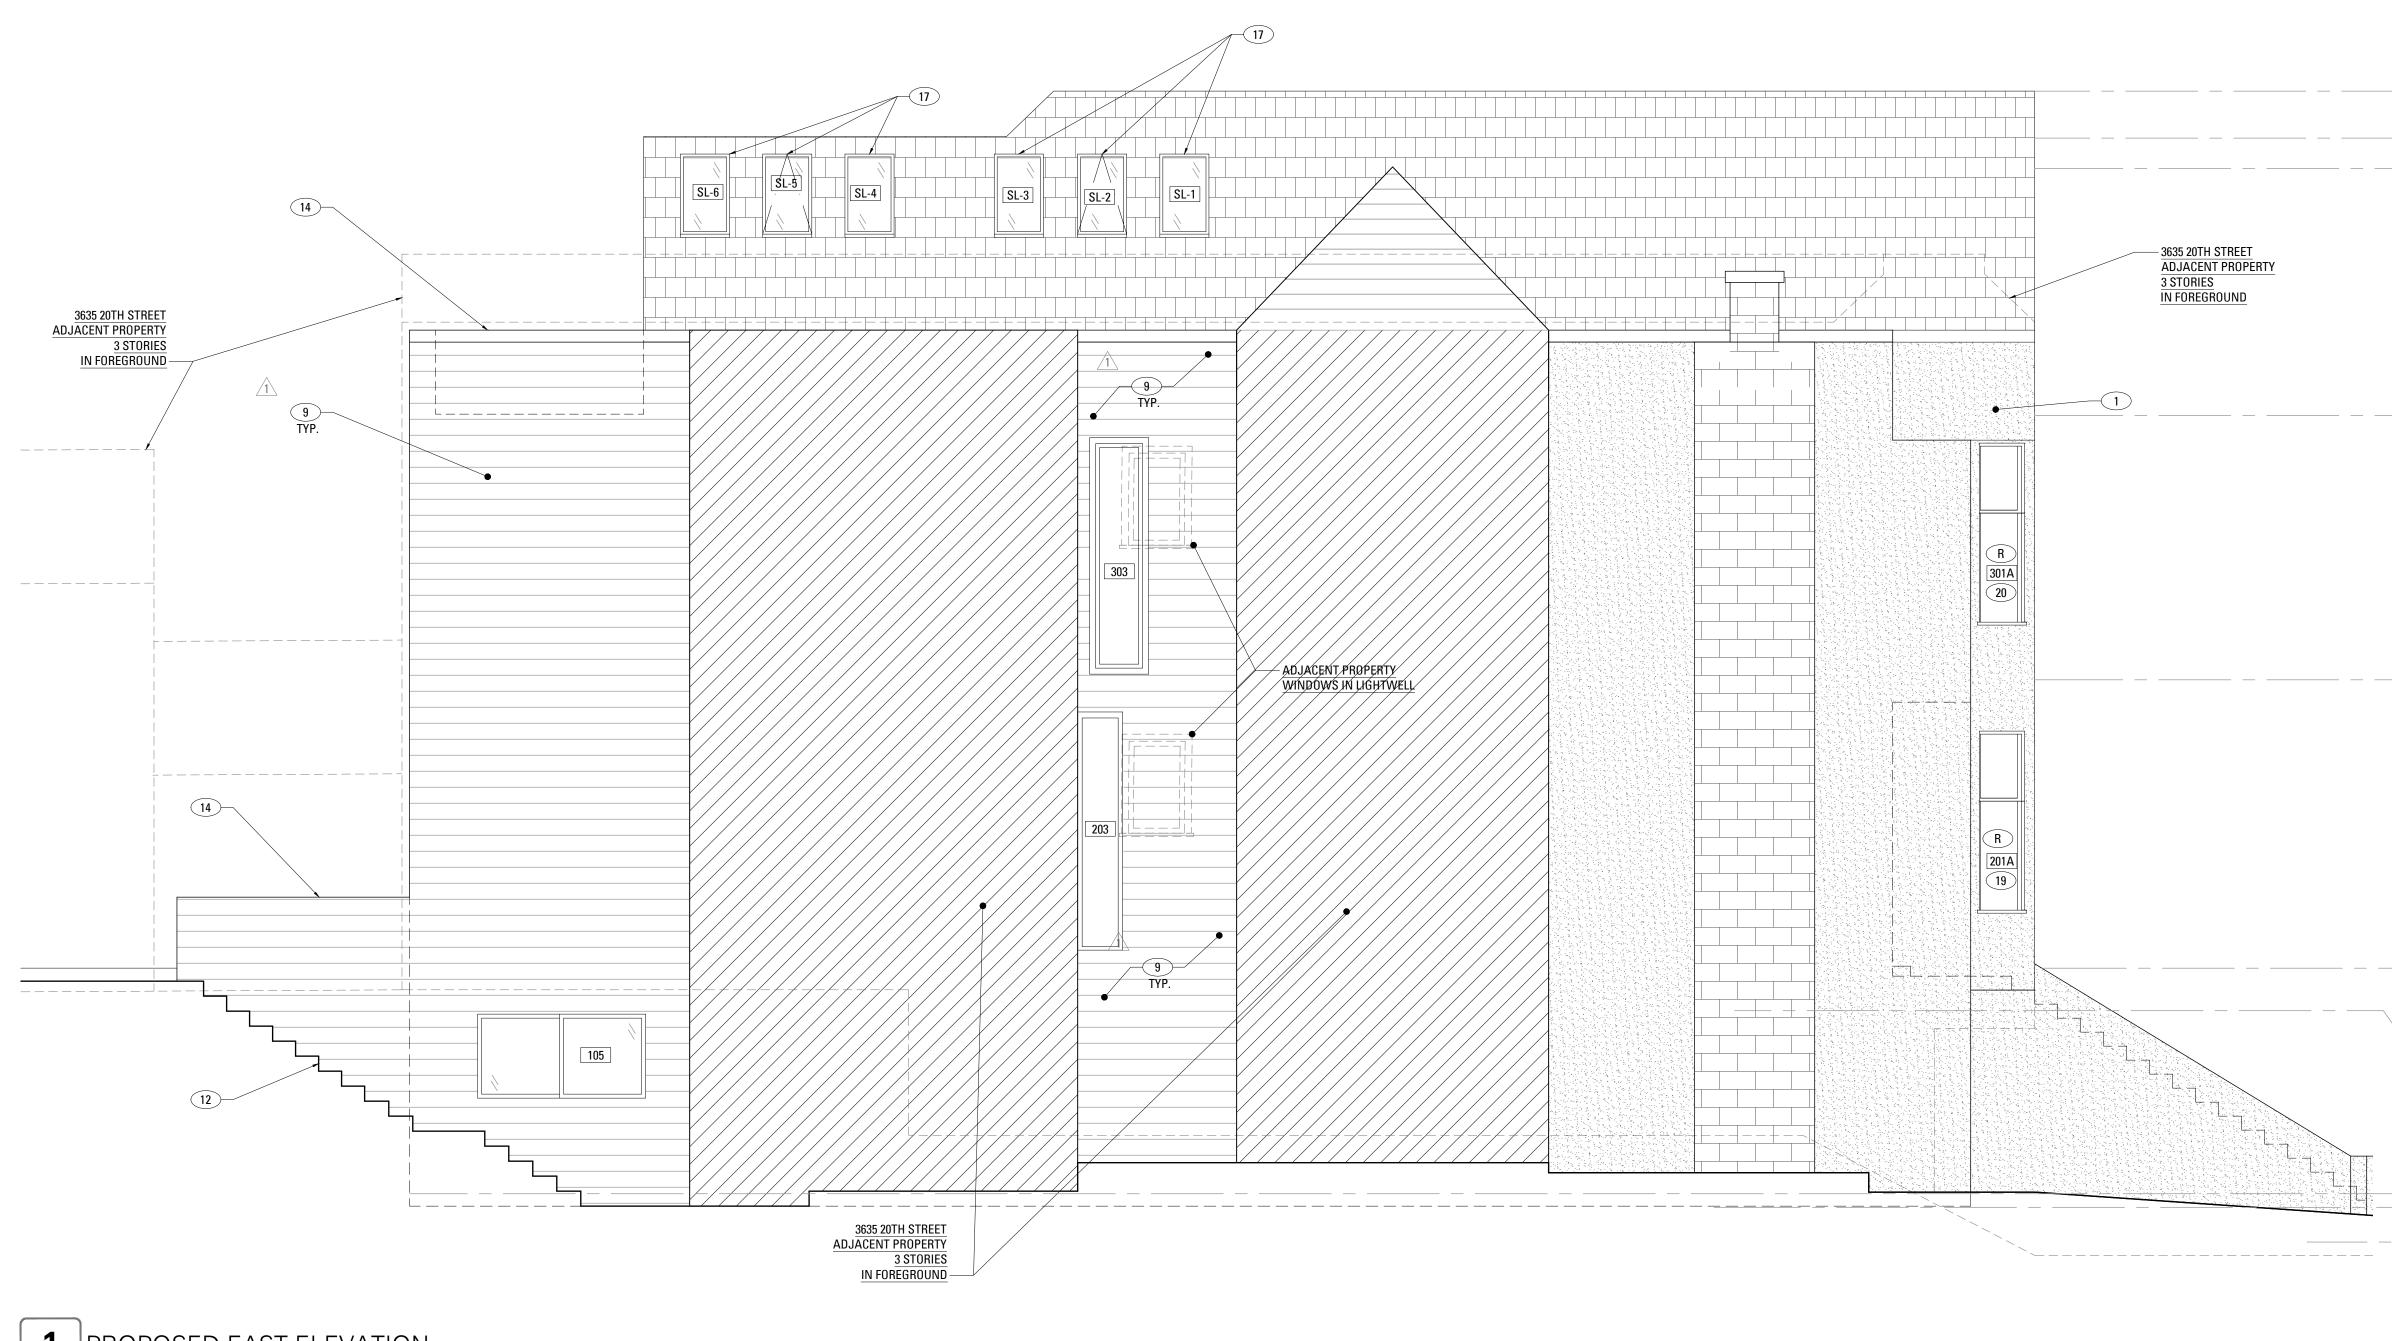

| | ELE | EVATION KEYNOTES | |
|----------------------------|-----|---|---|
| | E | (E) DOOR, WINDOW OR SKYLIGHT TO REMAIN. | 3639 20TH STREET RESIDENCE REMODEL |
| | D | (E) DOOR OR WINDOW TO BE REMOVED. | |
| | R | (E) DOOR OR WINDOW TO BE REPLACED IN KIND. | |
| | N | (N) DOOR OR WINDOW FOR REPLACING (E) IN KIND. | 3639 20TH STREET SAN FRANCISCO, CA 94110 |
| | | (E) INTEGRAL COLOR PLASTER FINISH TO REMAIN. | |
| | 2 | (E) EXTERIOR STAIRS TO REMAIN | |
| | 3 | (E) SKYLIGHT TO BE REMOVED. | |
| | 4 | PORTION OF (E) WALL TO BE REMOVED TO ACCOMMODATE (N) WORK, SEE DEMOLITION AND CONSTRUCTION PLANS. | MARTINKOVIC MILFORD ARCHITECTS |
| | 5 | (E) DECK TO BE REMOVED. | 101 Montgomery Street Suite 650 |
| | 6 | (E) ASPHALT SHINGLES ROOF TO REMAIN. | San Francisco, CA 94104 T 415 346 9990 349 5th Avenue |
| | 7 | (E) WOOD SIDING TO REMAIN. | New York, NY 10016 T 646 741 0341 |
| 1 | 8 | (E) PAINTED WOOD TRIM TO REMAIN. | |
| | 9 | (E) PAINTED WOOD SIDING TO REMAIN UNLESS IT IS TOO DAMAGED TO BE REPAIRED, AND THAT ANY REMOVAL OF WOOD SIDING WILL BE REVIEWED AND APPROVED BY THE PLANNING DEPARTMENT. | SED ARCON |
| | 10 | (E) EXTERIOR STAIRS TO BE REMOVED. | T THE T MILL BOARD |
| | 11 | NOT USED | * No.CBB430 * |
| T.O. (E) ROOF | 12 | (N) EXTERIOR STAIRS | OF CALIFORNIA |
| +47'-11" | 13 | (N) PERIMETER FENCE | |
| +46'-0" | 14 | (N) LOW WALL, PAINTED STUCCO FINISH | |
| T.O. (E) DORMER +44'-9" | 15 | PORTION OF (E) ROOF TO BE REMOVED TO ACCOMMODATE (N) WORK; SEE DEMOLITION AND CONSTRUCTION PLANS | |
| | 16 | (E) WOOD PANEL INFILL AND DECORATIVE TRIMS TO REMAIN | |
| | 17 | (N) SKYLIGHT | |
| | 18 | (N) GUARDRAIL, 42" A.F.F. | |
| (E) ATTIC LEVEL | 19 | (E) SINGLE HUNG WINDOW GLAZING AND SASHES TO BE REPLACED IN KIND, (E) WINDOW FRAME AND TRIM TO REMAIN WITH TOP SASH TO BE OPERABLE, SEE WINDOW SCHEDULE | |
| +34'-5" | 20 | (N) DRYER VENT, 4 SQ. INCHES MINIMUM | |
| | 21 | (N) PAINTED WOOD SIDING TO MATCH ADJACENT SIDING MATERIAL | |
| | 22 | (E) FRONT DOOR TO REMAIN, (E) GLAZING TO BE REPLACED WITH TRANSPARENT GLAZING AND (E) HARDWARE TO BE REPLACED. | |
| | 23 | (N) EXTERIOR WALL SCONCE, SEE RCP | |
| | | | |
| (E) SECOND FLOOR | | | |
| +23'-5" | | | |
| | | | RECORD OF DRAWING ISSUANCE |
| | | | Permit Set 05.15.2017 Description 04.0017 |
| | | | Permit Set Revision 1 1 10.04.2017 Permit Set Revision 2 2 12.20.2017 |
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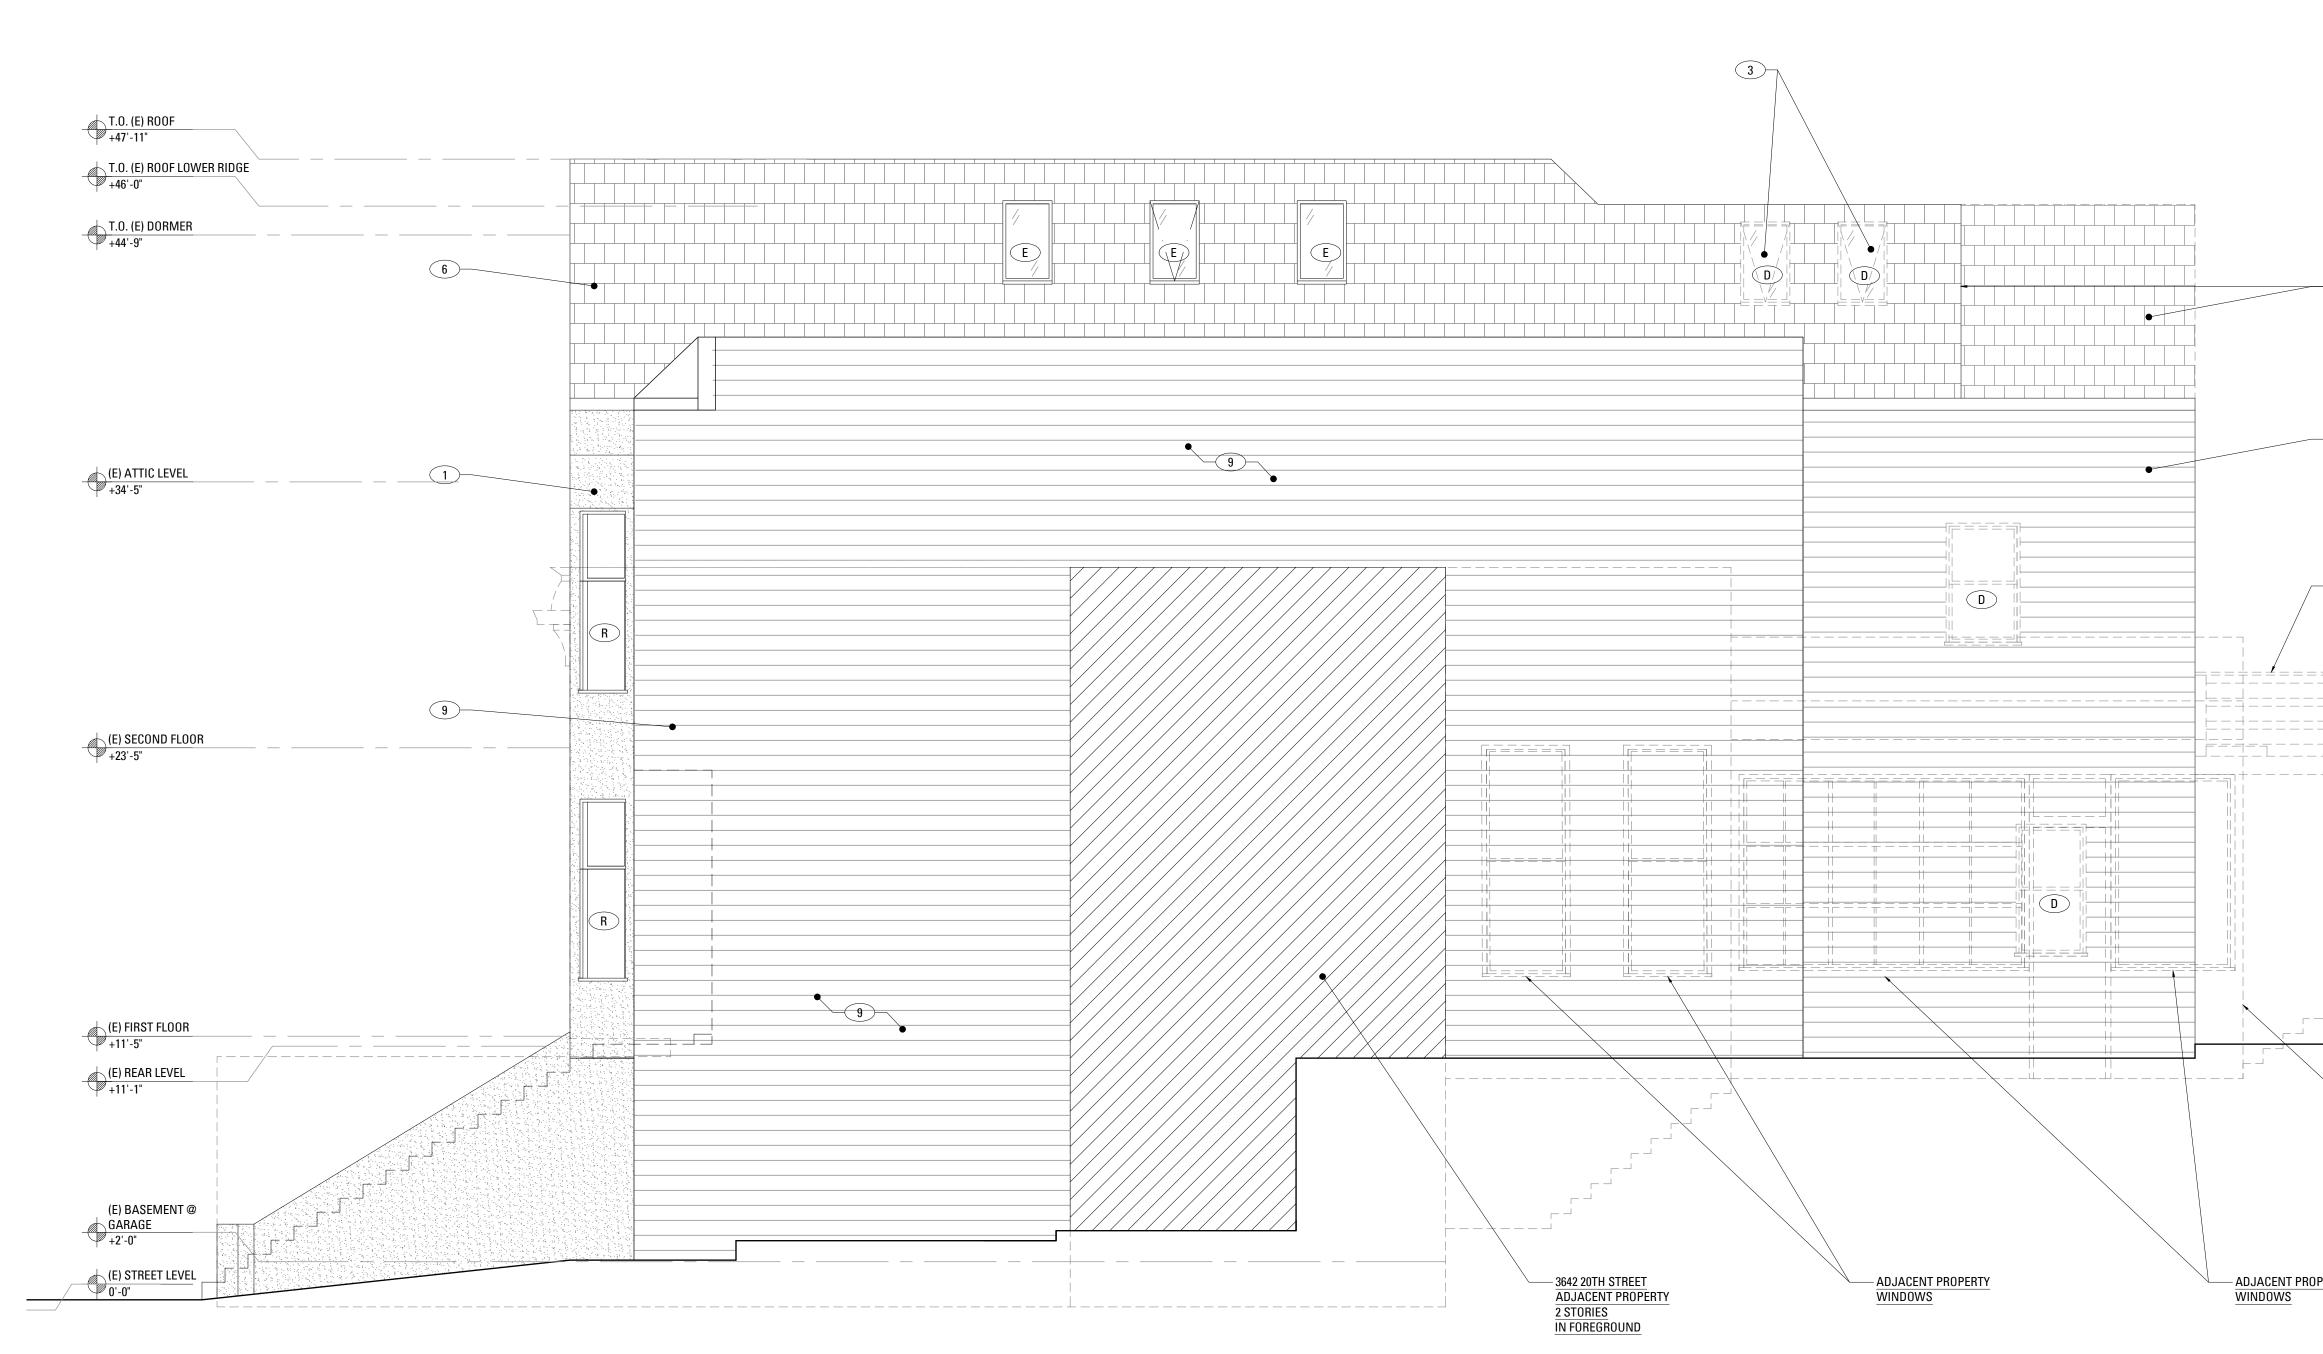
| Permit Set Revision 2 | | | | | |
|-------------------------------------|--------------------|--|--|--|--|
| | · • · · · <u>-</u> | | | | |
| Drawn By: | LGB | | | | |
| Checked By : | KB | | | | |
| Project Number: | 1635.1 | | | | |
| Proposed Exterior Elevation East | | | | | |
| SHEET I | NUMBER | | | | |
| A206 | | | | | |

(E) FIRST FLOOR +11'-5"


(N) REAR YARD LOWER LEVEL +9'-1 1/2"

(E) BASEMENT @ GARAGE +2'-0" (N) BASEMENT LEVEL +1'-5 (E) STREET LEVEL 0'-0"

1 EXISTING WEST ELEVATION SCALE: 1/4" = 1'-0"



| | ELEVATION KEYNOTES | |
|---|---|---|
| | (E) (E) DOOR, WINDOW OR SKYLIGHT TO REMAIN. | 3639 20TH STREET |
| | | RESIDENCE REMODEL |
| | | |
| | (E) DOOR OR WINDOW TO BE REPLACED IN KIND. | |
| | (N) DOOR OR WINDOW FOR REPLACING (E) IN KIND. | 3639 20TH STREET SAN FRANCISCO, CA 94110 |
| | (E) INTEGRAL COLOR PLASTER FINISH TO REMAIN. | |
| | 2 (E) EXTERIOR STAIRS TO REMAIN | |
| | 3 (E) SKYLIGHT TO BE REMOVED. | |
| | 4 PORTION OF (E) WALL TO BE REMOVED TO ACCOMMODATE (N) WORK, SEE DEMOLITION AND CONSTRUCTION PLANS. | MARTINKOVIC MILFORD ARCHITECTS |
| | 5 (E) DECK TO BE REMOVED. | 101 Montgomery Street Suite 650 |
| | 6 (E) ASPHALT SHINGLES ROOF TO REMAIN. | San Francisco, CA 94104 T 415 346 9990 349 5th Avenue |
| | (E) WOOD SIDING TO REMAIN. | New York, NY 10016 T 646 741 0341 |
| | 8 (E) PAINTED WOOD TRIM TO REMAIN. | |
| | (E) PAINTED WOOD SIDING TO REMAIN UNLESS IT IS TOO DAMAGED TO BE REPAIRED, AND THAT ANY REMOVAL OF WOOD SIDING WILL BE REVIEWED AND APPROVED BY THE PLANNING DEPARTMENT. | |
| | 10 (E) EXTERIOR STAIRS TO BE REMOVED. | THE REAL PROPERTY OF THE PARTY |
| | 11 NOT USED | |
| | 12 (N) EXTERIOR STAIRS | FILE OF CALIFOR |
| | (N) PERIMETER FENCE | |
| | (N) LOW WALL, PAINTED STUCCO FINISH | |
| | PORTION OF (E) ROOF TO BE REMOVED TO 15 ACCOMMODATE (N) WORK; SEE DEMOLITION AND | |
| -(15) | 13 Accommodate (N) work, see demotition and construction plans 16 (E) WOOD PANEL INFILL AND DECORATIVE TRIMS TO REMAIN | |
| | 17 (N) SKYLIGHT | |
| | 18 (N) GUARDRAIL, 42" A.F.F. | |
| 9 | (E) SINGLE HUNG WINDOW GLAZING AND SASHES TO BE REPLACED IN KIND, (E) WINDOW FRAME AND TRIM TO REMAIN WITH TOP SASH TO BE OPERABLE, SEE WINDOW SCHEDULE | |
| | 20 (N) DRYER VENT, 4 SQ. INCHES MINIMUM | |
| | (N) PAINTED WOOD SIDING TO MATCH ADJACENT SIDING MATERIAL | |
| -5 | (E) FRONT DOOR TO REMAIN, (E) GLAZING TO BE REPLACED WITH TRANSPARENT GLAZING AND (E) HARDWARE TO BE REPLACED. | |
| | (N) EXTERIOR WALL SCONCE, SEE RCP | |
| | | RECORD OF DRAWING ISSUANCE Permit Set 05.15.2017 |
| | | Permit Set 03.13.2017 Permit Set Revision 1 1 10.04.2017 Permit Set Revision 2 2 12.20.2017 |
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| | | |
| | | |
| | | |
| 3642 20TH STREET | | Permit Set Revision 2 |
| ADJACENT PROPERTY 2 STORIES IN FOREGROUND | | Drawn By:LGBChecked By :KBProject Number:1635.1 |
|)PERTY | | Existing Exterior Elevation West |
| | | SHEET NUMBER |
| | | ∧ 2 07 |
| | | A207 |

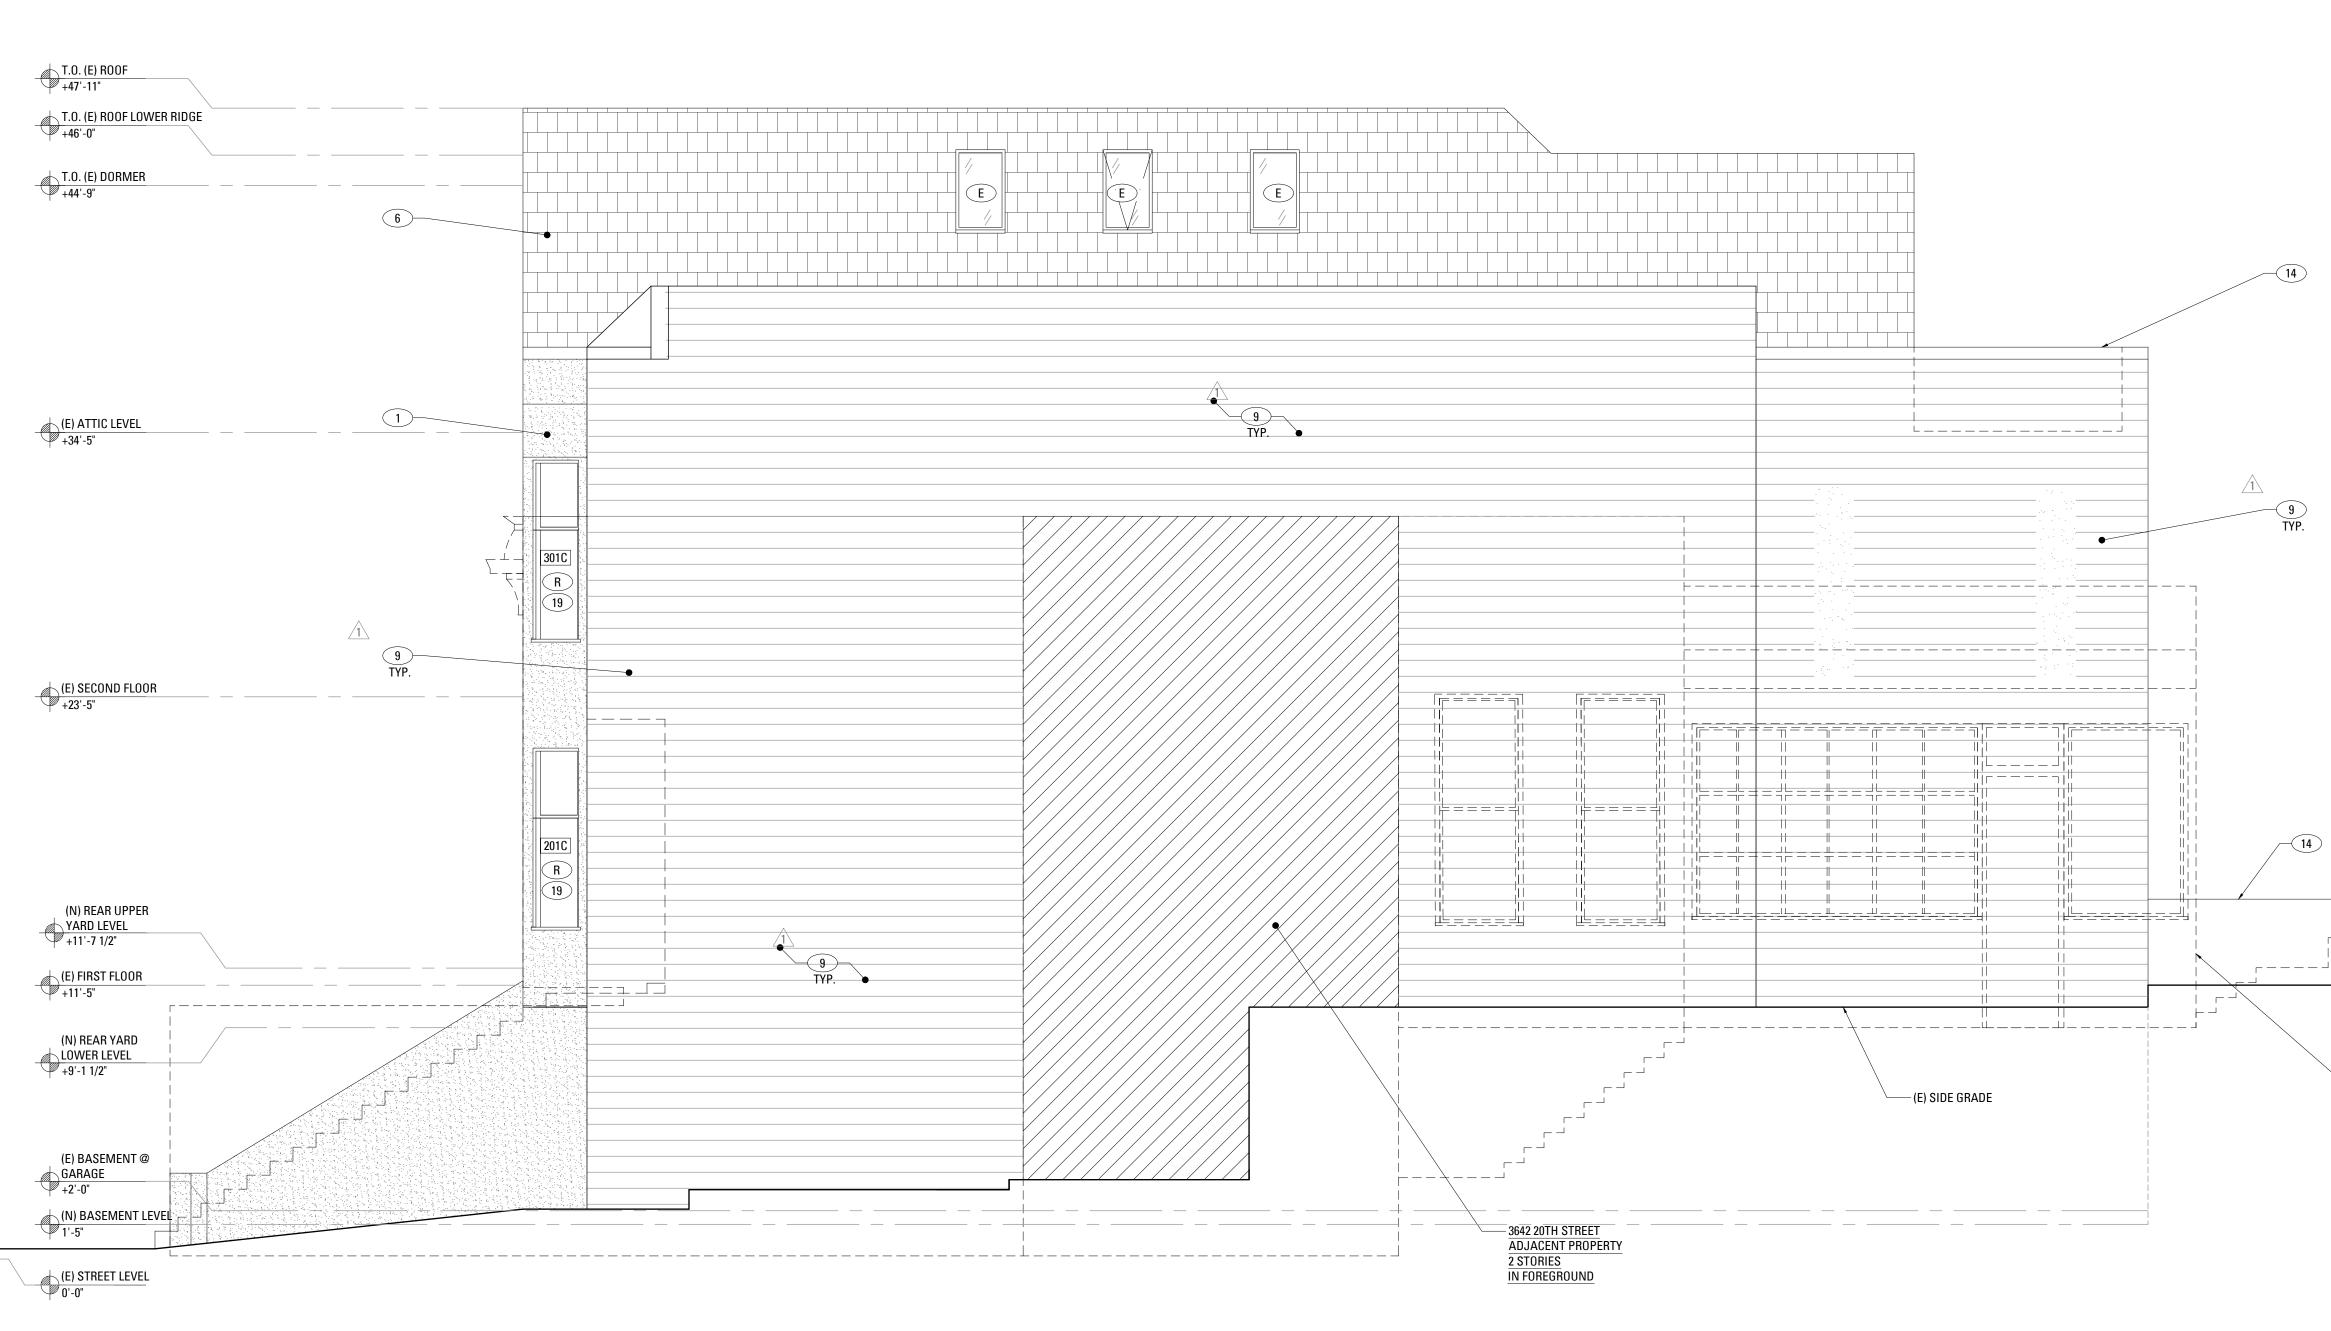

| | ELE | EVATION KEYNOTES | |
|---|-----|---|--|
| | E | (E) DOOR, WINDOW OR SKYLIGHT TO REMAIN. | 3639 20TH STREET RESIDENCE REMODEL |
| | D | (E) DOOR OR WINDOW TO BE REMOVED. | |
| | R | (E) DOOR OR WINDOW TO BE REPLACED IN KIND. | |
| | N | (N) DOOR OR WINDOW FOR REPLACING (E) IN KIND. | 3639 20TH STREET |
| | | (E) INTEGRAL COLOR PLASTER FINISH TO REMAIN. | SAN FRANCISCO, CA 94110 |
| | 2 | (E) EXTERIOR STAIRS TO REMAIN | |
| | 3 | (E) SKYLIGHT TO BE REMOVED. | |
| | 4 | PORTION OF (E) WALL TO BE REMOVED TO ACCOMMODATE (N) WORK, SEE DEMOLITION AND | MARTINKOVIC MILFORD |
| | 5 | CONSTRUCTION PLANS. (E) DECK TO BE REMOVED. | ARCHITECTS 101 Montgomery Street Suite 650 |
| | 6 | (E) ASPHALT SHINGLES ROOF TO REMAIN. | San Francisco, CA 94104 T 415 346 9990 |
| | 7 | (E) WOOD SIDING TO REMAIN. | 349 5th Avenue New York, NY 10016 T 646 741 0341 |
| Λ | 8 | (E) PAINTED WOOD TRIM TO REMAIN. | |
| | 9 | (E) PAINTED WOOD SIDING TO REMAIN UNLESS IT IS TOO DAMAGED TO BE REPAIRED, AND THAT ANY REMOVAL OF WOOD SIDING WILL BE REVIEWED AND APPROVED BY THE PLANNING DEPARTMENT. | THE ARA |
| | 10 | (E) EXTERIOR STAIRS TO BE REMOVED. | CONSTRUCT TO AND |
| | 11 | NOT USED | x No.C33490 x 𝔄 𝔄 𝔄 𝔄 |
| | 12 | (N) EXTERIOR STAIRS | FILE OF CALIFOR |
| | 13 | (N) PERIMETER FENCE | |
| | 14 | (N) LOW WALL, PAINTED STUCCO FINISH | |
| | 15 | PORTION OF (E) ROOF TO BE REMOVED TO ACCOMMODATE (N) WORK; SEE DEMOLITION AND CONSTRUCTION PLANS | |
| | 16 | (E) WOOD PANEL INFILL AND DECORATIVE TRIMS TO REMAIN | |
| | 17 | (N) SKYLIGHT | |
| | 18 | (N) GUARDRAIL, 42" A.F.F. | |
| | 19 | (E) SINGLE HUNG WINDOW GLAZING AND SASHES TO BE REPLACED IN KIND, (E) WINDOW FRAME AND TRIM TO REMAIN WITH TOP SASH TO BE OPERABLE, SEE WINDOW SCHEDULE | |
| | 20 | (N) DRYER VENT, 4 SQ. INCHES MINIMUM | |
| | 21 | (N) PAINTED WOOD SIDING TO MATCH ADJACENT SIDING MATERIAL | |
| | 22 | (E) FRONT DOOR TO REMAIN, (E) GLAZING TO BE REPLACED WITH TRANSPARENT GLAZING AND (E) HARDWARE TO BE REPLACED. | |
| | 23 | (N) EXTERIOR WALL SCONCE, SEE RCP | |
| | | | |
| | | | |
| | | | |
| Π | | | RECORD OF DRAWING ISSUANCE |
| 14 | | | Permit Set Revision 1 10.04.2017 |
| | | | Permit Set Revision 2 |
| | _ | | |
| | | (E) REAR GRADE | |
| | | | |
| (E) REAR GRADE | | 12 BEYOND | Permit Set Revision 2 |
| ADJACENT PROPERTY 2 STORIES IN FOREGROUND | | | Drawn By: LGB |
| | | | Checked By :KBProject Number:1635.1 |
| | | | Proposed Exterior Elevation West |
| | | | SHEET NUMBER |


A208


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-9 TYP.


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EXISTING/DEMOLITION LONGITUDINAL SECTION



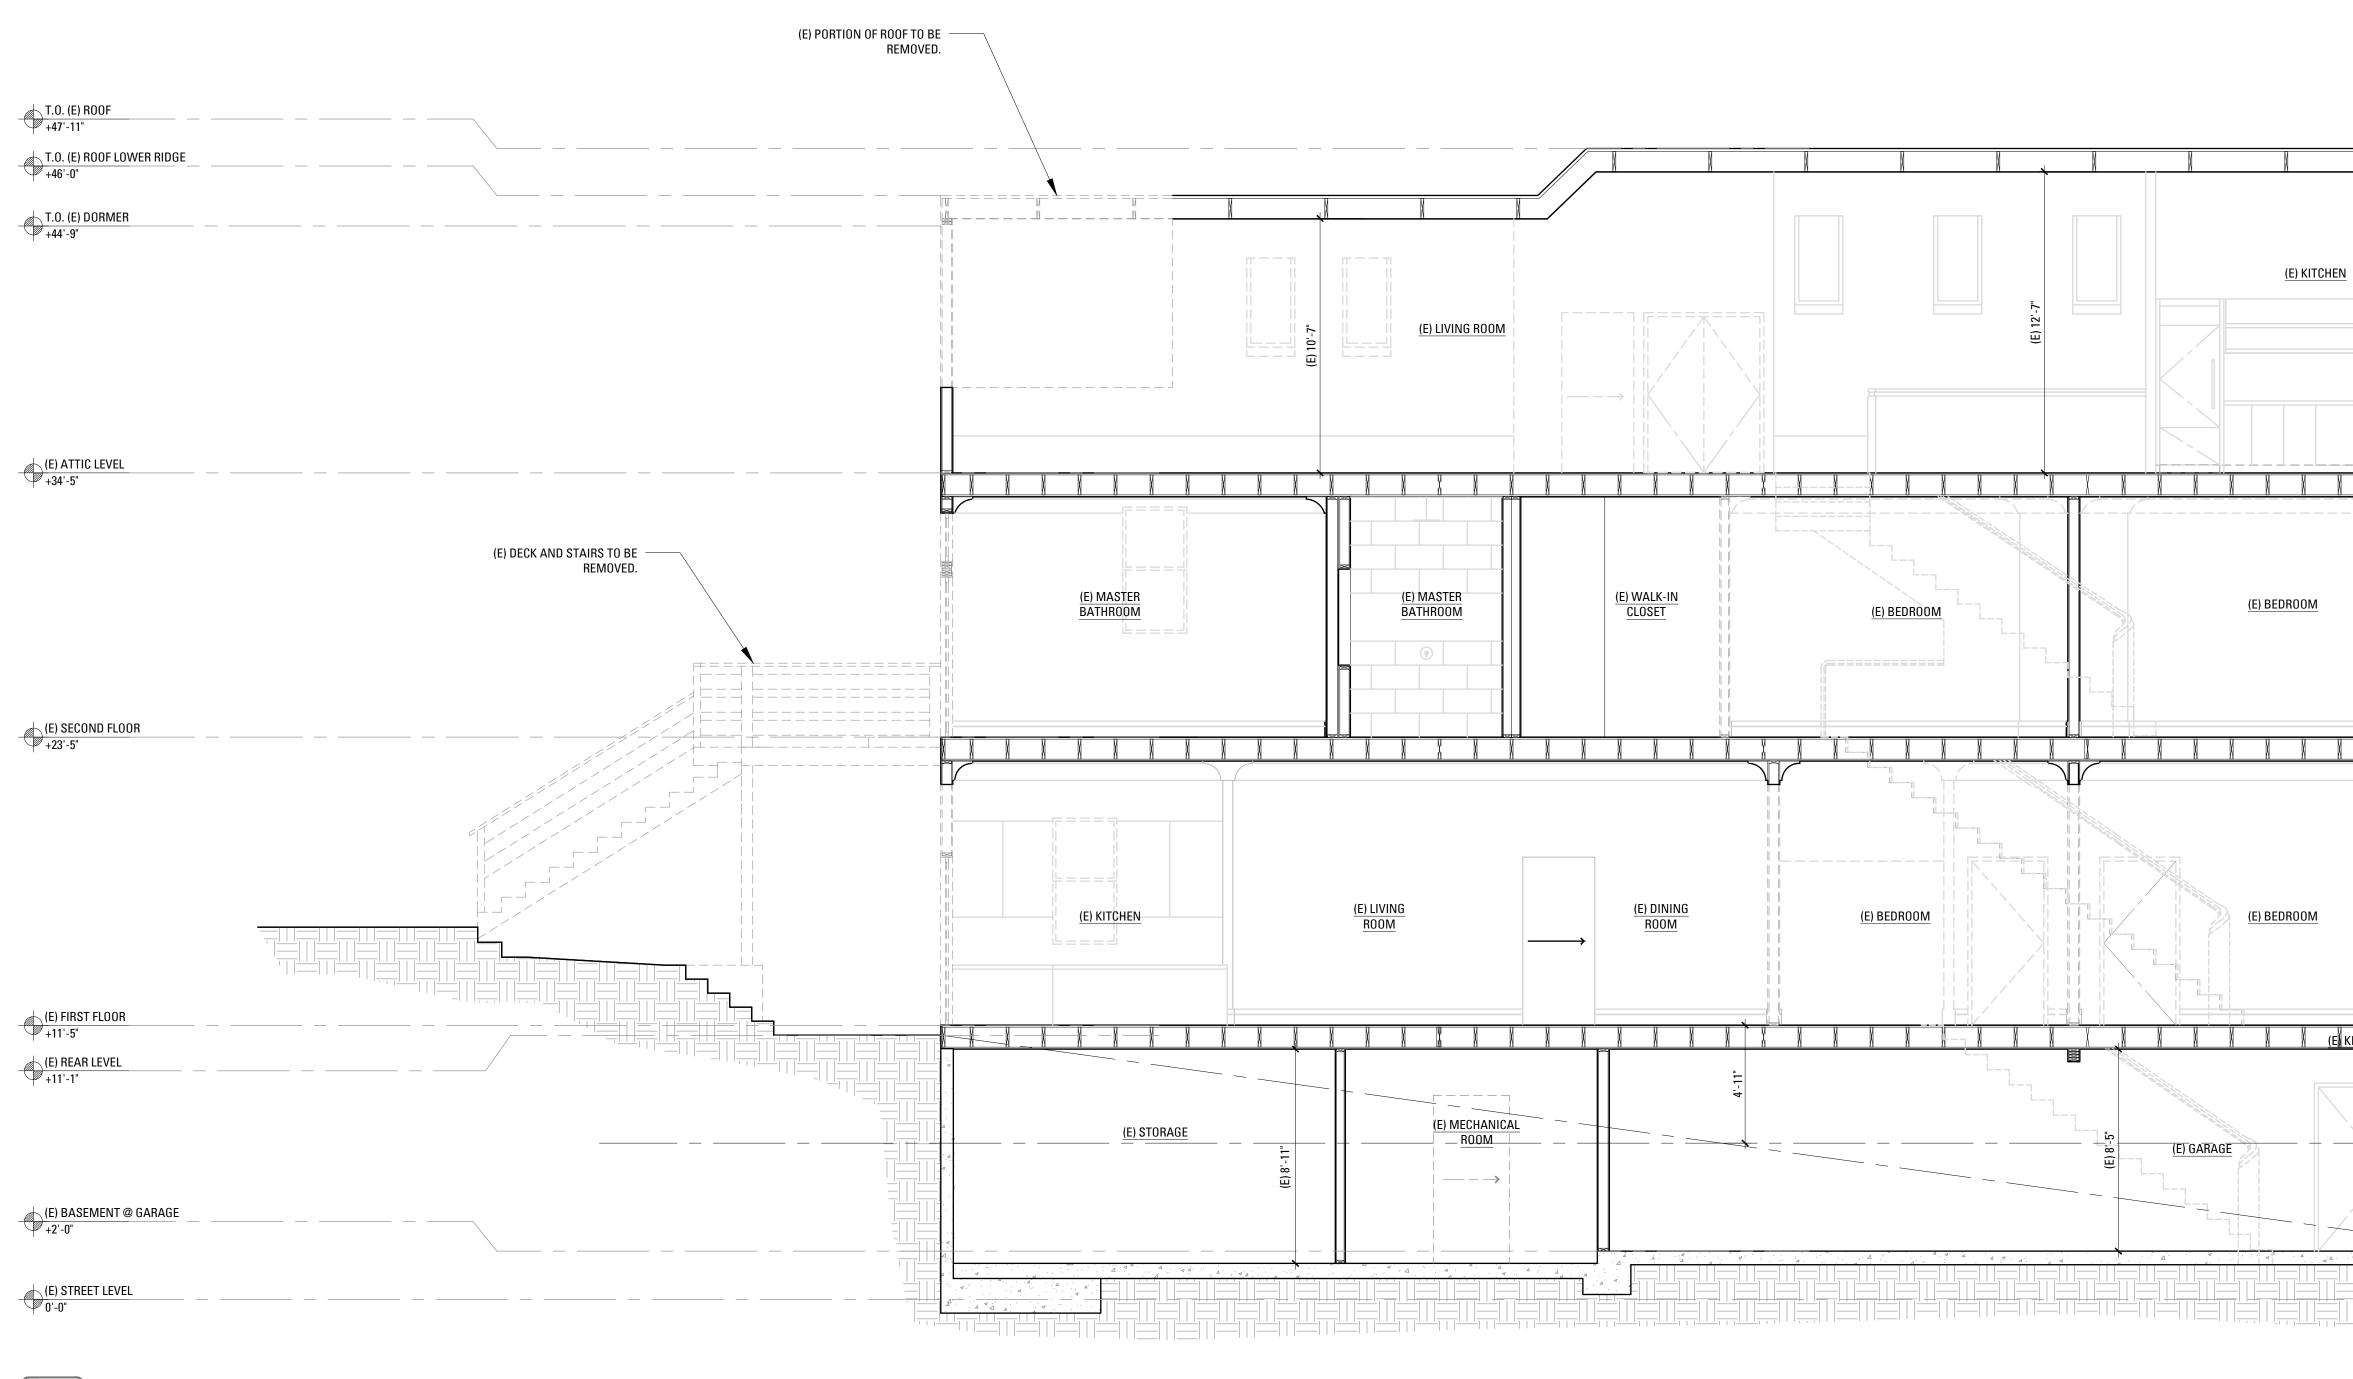



A301

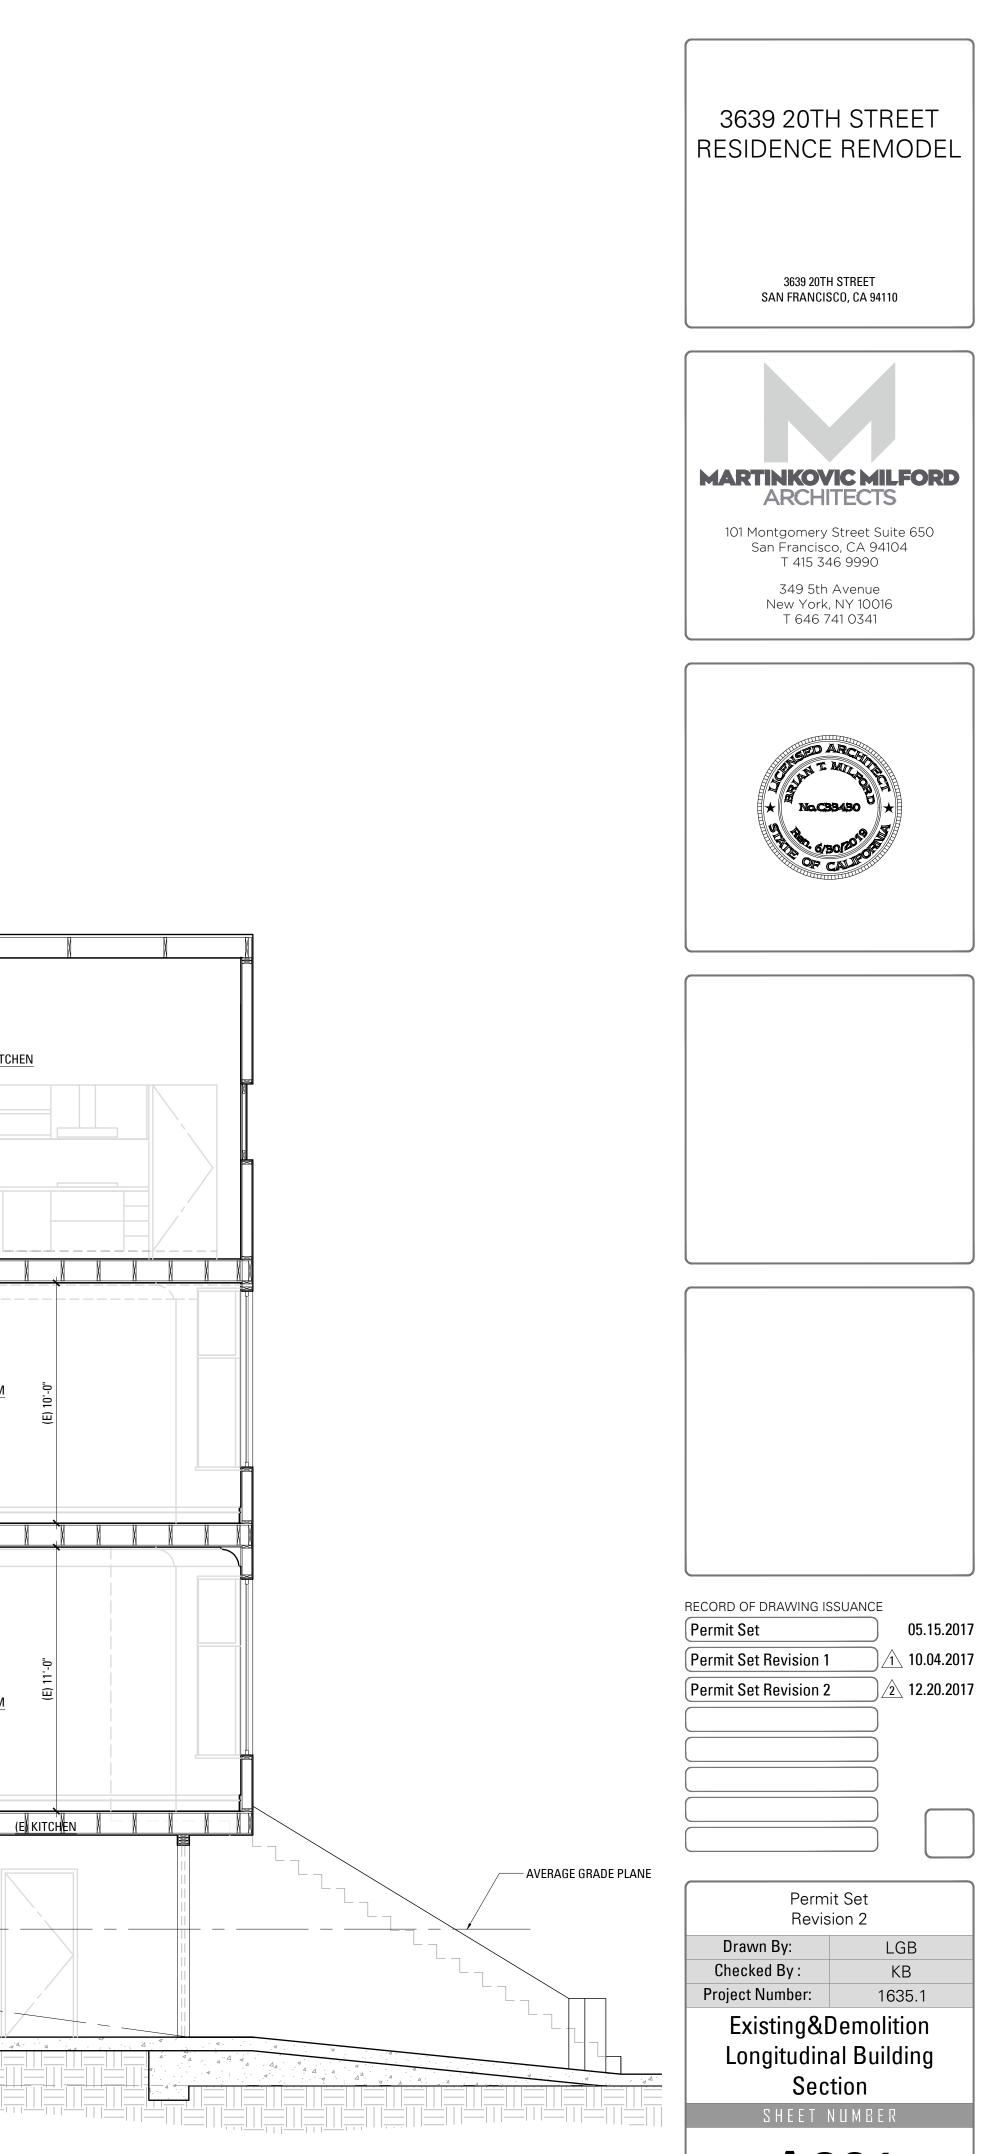

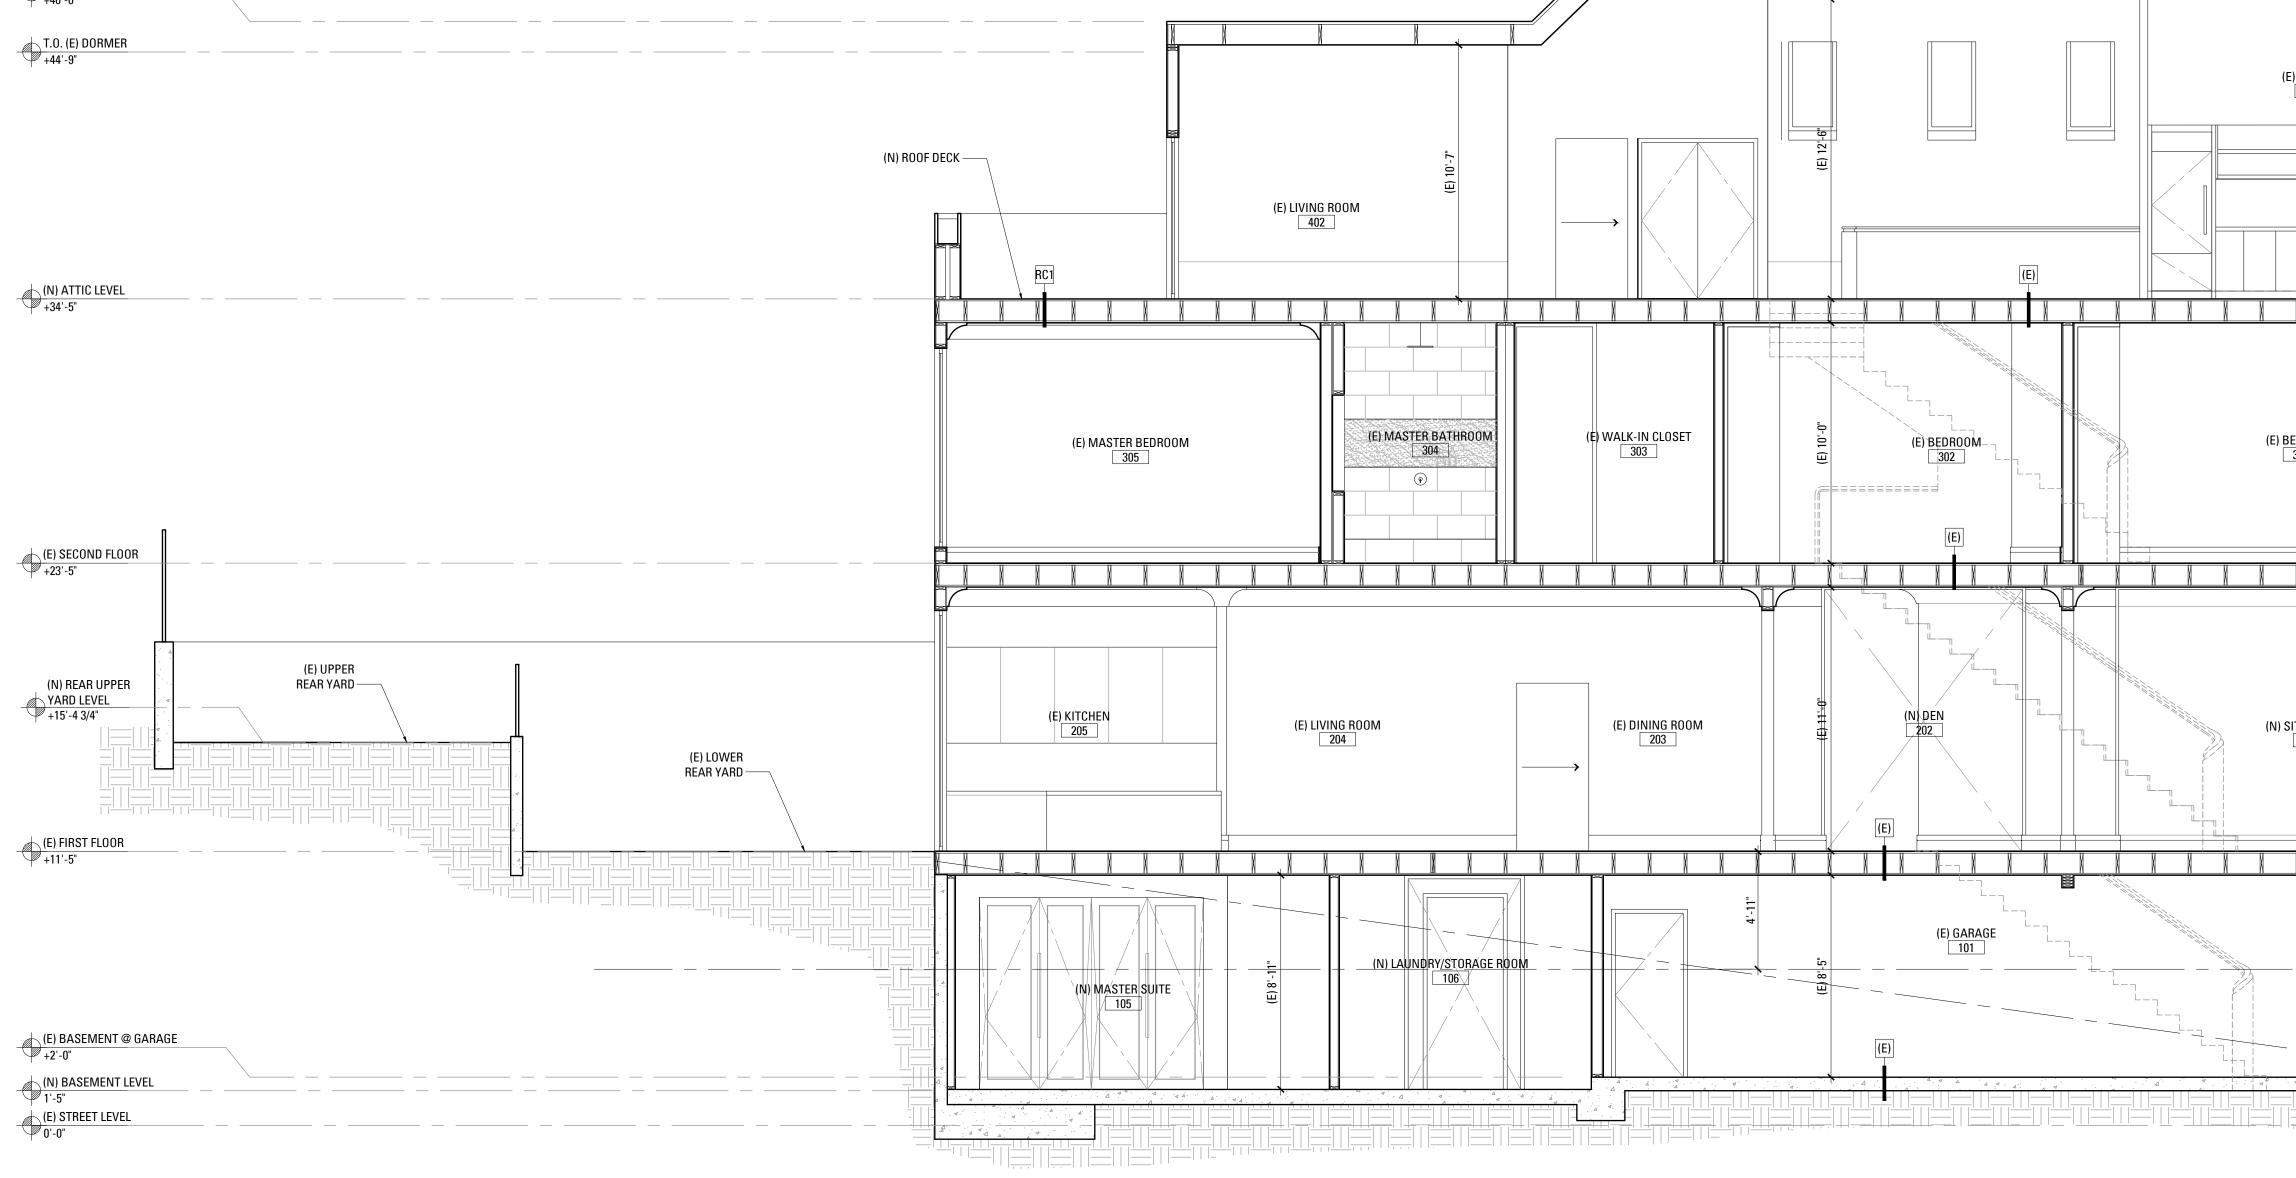T.O. (E) ROOF +47'-11"

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OPERABLE SKYLIGHT
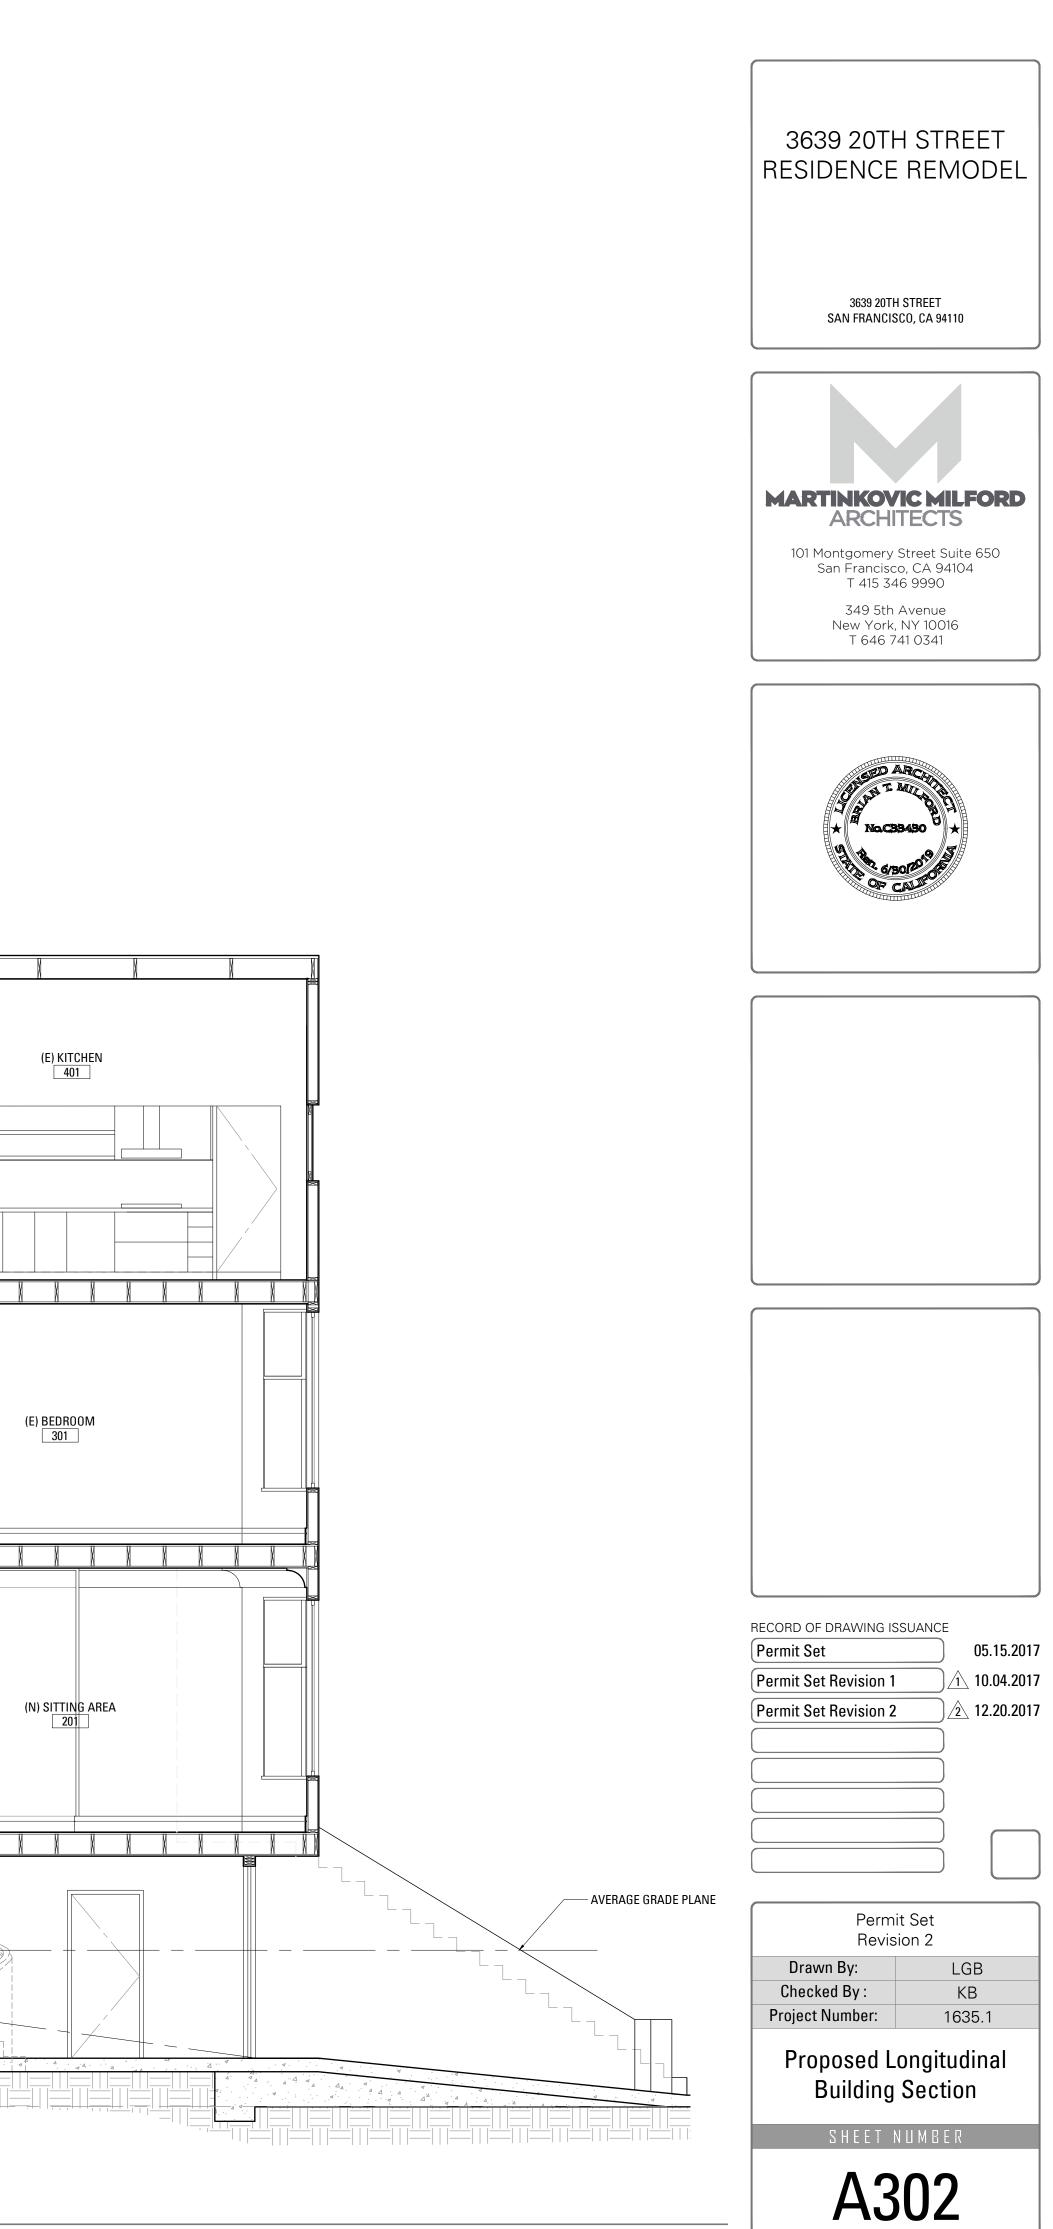
| | LOCATIO | N | WINDO | | | | | | | |
|------|------------|--------------------|-------|----------------------------|-----------------------|----------|--------------------|--------------------|--------------|--|
| NO. | FLOOR | ROOM | ТҮРЕ | W x H FRAME DIM. U.O.N. | HEAD HEIGHT A.F.F. | MATERIAL | INTERIOR FINISH | EXTERIOR FINISH | MFR. | COMMENTS |
| Ε | 02, 03, 04 | | | EXISTING | EXISTING | | EXISTING | EXISTING | | ALL (E) WINDOWS TO REMAIN, COMPLY WITH 2016 CBC SECTION |
| 105 | 01 | MASTER BEDROOM | 1 | 7'-0" X 3'-6" | 8'-0" | | WOOD | WOOD | | WINDOW TO COMPLY WITH EN EGRESS REQUIREMENTS PER C VENTILATION REQUIREMENTS |
| 201A | 02 | SITTING AREA | 7 | +/- 2'-6" X 7'-4" | 9'-10 1/2" | | WOOD | WOOD | · <u>⁄</u> 2 | TO REPLACE (E) WINDOW GLAZ HUNG W/ TOP SASH TO BE OPE VERIFY SIZE IN FIELD, (E) FRAM |
| 201B | 02 | SITTING AREA | 7 | +/- 4'-0" X 7'-4" | 9'-10 1/2" | | WOOD | WOOD | | TO REPLACE (E) WINDOW GLAZ HUNG W/ TOP SASH TO BE OPE VERIFY SIZE IN FIELD, (E) FRAM |
| 201C | 02 | SITTING AREA | 7 | +/- 2'-6" X 7'-4" | 9'-10 1/2" | | WOOD | WOOD | | TO REPLACE (E) WINDOW GLAZ HUNG W/ TOP SASH TO BE OPE VERIFY SIZE IN FIELD, (E) FRAM |
| 202A | 02 | DEN | 7 | +/- 2'-8" X 7'-4" | 9'-10 1/2" | | WOOD | WOOD | | TO REPLACE (E) WINDOW GLAZ HUNG W/ TOP SASH TO BE OPE VERIFY SIZE IN FIELD, (E) FRAM |
| 202B | 02 | DEN | 3 | 2'-0" X 3'-10" | 8'-0" | | WOOD | WOOD | | |
| 203 | 02 | DINING ROOM | 3 | 2'-0" X 3'-10" | 8'-0" | | WOOD | WOOD | | |
| 204 | 02 | LIVING ROOM | 7 | 2'-5" X 7'-8" | 9'-10 1/2" | | WOOD | WOOD | | |
| 301A | 02 | SITTING AREA | 7 | +/- 2'-6" X 7'-4" | 9'-10 1/2" | | WOOD | WOOD | · <u>⁄2</u> | TO REPLACE (E) WINDOW GLAZ HUNG W/ TOP SASH TO BE OPE VERIFY SIZE IN FIELD, (E) FRAM |
| 301B | 02 | SITTING AREA | 7 | +/- 4'-0" X 7'-4" | 9'-10 1/2" | | WOOD | WOOD | (| TO REPLACE (E) WINDOW GLAZ HUNG W/ TOP SASH TO BE OPE VERIFY SIZE IN FIELD, (E) FRAM |
| 301C | 02 | SITTING AREA | 7 | +/- 2'-6" X 7'-4" | 9'-10 1/2" | | WOOD | WOOD | | TO REPLACE (E) WINDOW GLAZ HUNG W/ TOP SASH TO BE OPE VERIFY SIZE IN FIELD, (E) FRAM |
| 302 | 03 | BEDROOM | 7 | 2'-8" X 7'-4" | 9'-10 1/2" | | WOOD | WOOD | | |
| 303 | 03 | WALK-IN CLOSET | 3 | 1'-11 1/2" X 9'-4 1/2" | 9'-9 1/2" | | WOOD | WOOD | | |
| 304 | 03 | MASTER BATHROOM | 2 | 2'-9" X 3'-3" | 8'-9" | | WOOD | WOOD | | |
| 305 | 03 | MASTER BEDROOM | 4 | 10'-0" X 8'-0" | 8'-9" | | WOOD | WOOD | | |
| 308 | 03 | BATHROOM | 7 | 3'-0" X 7'-4" | 9'-9 1/2" | | WOOD | WOOD | 2 | TO REPLACE (E) WINDOW GLAZ HUNG W/ TOP SASH TO BE OPE VERIFY SIZE IN FIELD, (E) FRAM |
| 401 | 04 | KITCHEN | 8 | +/- 4'-8" X 2'-10" | 7'-0" | | WOOD | WOOD | | (N) WINDOW INSTALL WITHIN SIZE IN FIELD |
| SL-1 | | ROOF | 5 | 2'-0" X 4'-1" | | | WOOD | WOOD | | |
| SL-2 | | ROOF | 6 | 2'-0" X 4'-1" | | | WOOD | WOOD | | |
| SL-3 | | ROOF | 5 | 2'-0" X 4'-1" | | | WOOD | WOOD | | |
| SL-4 | | ROOF | 5 | 2'-0" X 4'-1" | | | WOOD | WOOD | | |
| SL-5 | | ROOF | 6 | 2'-0" X 4'-1" | | | WOOD | WOOD | | |
| SL-6 | | ROOF | 5 | 2'-0" X 4'-1" | | | WOOD | WOOD | | |

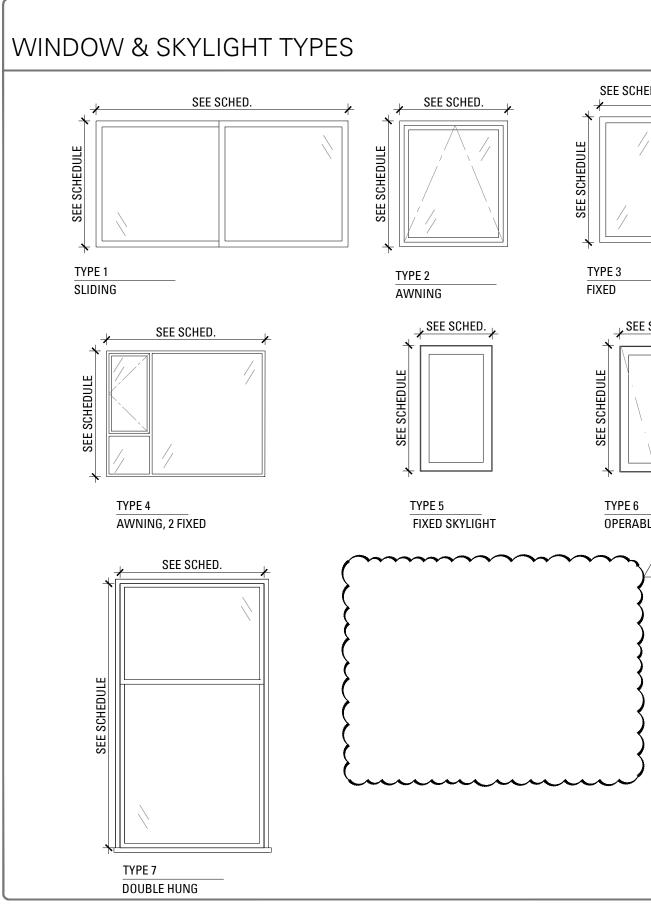WINDOW & SKYLIGHT NOTES

1. ALL DIMENSIONS ARE UNIT SIZES TO OUTSIDE FRAME DIMENSIONS, U.O.N.

2. SILL OR HEAD HEIGHTS GIVEN ARE TO INSIDE OF UNIT OR INSIDE OF FRAME, U.O.N. 3. GENERAL CONTRACTOR TO PROVIDE CODE COMPLIANT SAFETY GLAZING WHERE REQUIRED

4. EGRESS WINDOWS TO COMPLY WITH 2016 CBC SECTION 1030 AND SHALL HAVE A MINIMUM NET CLEAR OPENING OF 5.7 SQUARE FEET, A MINIMUM NET CLEAR OPENING HEIGHT OF 24" AND I RESULT OF NORMAL OPERATION OF THE OPENING. THE BOTTOM OF THE OPENING SHALL NOT BE GREATER THAN 44" ABOVE FINISHED FLOOR.

5. WINDOW TO BE GLAZED WITH DOUBLE PANE, LOW-E CLEAR GLASS, 0.32 U-FACTOR OR BETTER, WITH U.V. PROTECTION, U.O.N.

 PER 2013 CBC SECTION 1013.8, AT OPERABLE EXTERIOR WINDOWS LOCATED MORE THAN 72" ABOVE FINISHED GRADE OR OTHER SURFACE BELOW, THE LOWEST PART OF THE CLEAR OPENING (NOT LESS THAN 36" ABOVE THE FINISHED FLOOR SURFACE OF THE ROOM IN WHICH THE WINDOW IS LOCATED. GLAZING BETWEEN THE FLOOR AND A HEIGHT OF 36" SHALL BE FIXED OR HAVE (SPHERE CANNOT PASS. EXCEPTION: OPENINGS THAT ARE PROVIDED WITH WINDOW GUARDS THAT COMPLY WITH WINDOW GUARDS THAT COMPLY WITH ASTM F 2006, F 2090 OR 1013.8.1 7. ALL GLAZED EXTERIOR DOORS AND WINDOWS TO HAVE THERMAL SEAL GASKETING, U.O.N.

8. ALL EXTERIOR DOORS AND WINDOWS TO HAVE GALVANIZED SHEET METAL PAN FLASHING AND GALVANIZED METAL HEAD FLASHING, U.O.N.

9. ALL EXTERIOR DOOR AND WINDOW OPENINGS SHALL HAVE SELF-ADHERED FLASHING 10. ALL GAPS BETWEEN FRAMING AND EXTERIOR DOOR & WINDOW FRAMES TO BE FILLED WITH EXPANDING FOAM INSULATION

PARTITION NOTES

- 1. SEE STRUCTURAL DRAWINGS FOR NAILING & SCREWING SCHEDULE,
- REFER TO GYPSUM ASSOCIATION F CBC TABLE 720.1 (2) [CRC R302] FOR FIREBLOCKING, DRAFTSTOPPING.
- ATTACHMENT OF WALL SHEATHIN REQUIREMENTS OF THE REFERENCI
- STRUCTURAL DRAWINGS THERMAL INSULATION TO FILL WA
- IN 2X4 WOOD-FRAME WALLS & MII WOOD-FRAME WALLS OR EQUIVAL REFER TO ASTM C1063 FOR CEMEN
- WHERE INFORMATION DIFFERS FRO STRINGENT CRITERIA & CONTACT

| | $\left[\right]$ | | | |
|--|------------------|---|--------------------------------------|---|
| | V | VALL PARTITION TYPES: | | 3639 20TH STREET |
| | WALL TYPE | | REFERENCE RATED WALL ASSEMBLY | RESIDENCE REMODEL |
| 1AIN, G.C. TO VERIFY EGRESS WINDOW TO ECTION 1030. | MA | WALL ASSEMBLY DESCRIPTION ASSEMBLY (N) INTERIOR PARTITION | REFI RAT ASS | |
| TH EMERGENCY ESCAPE AND PER CBC 1030, AND WITH LIGHT AND ENTS PER | | (N) 5/8" GYPSUM BOARD (N) 2 X WOOD STUD FRAMING | | |
| GLAZING AND SASHES IN KIND, SINGLE E OPERABLE AND WOOD CORBELS, G.C. TO RAME AND TRIMS TO REMAIN | | (N) FINISHES VARY; SEE INTERIOR ELEVATIONS | | 3639 20TH STREET SAN FRANCISCO, CA 94110 |
| GLAZING AND SASHES IN KIND, SINGLE | | NOTE: 1. AT THICKENED WALL CONDITIONS | | |
| GLAZING AND SASHES IN KIND, SINGLE | | PROVIDE FURRING OR ADDITIONAL STUDS TO ACCOMODATE THICKNESS 2. PROVIDE 5/8" CEMENT BOARD ON WALL | | |
| E OPERABLE AND WOOD CORBELS, G.C. TO RAME AND TRIMS TO REMAIN | | SURFACE TO RECEIVE TILE FINISH 3. PROVIDE LATICRETE HYDROBAN OR ARCHITECT APPROVED EQUAL LIQUID | | |
| GLAZING AND SASHES IN KIND, SINGLE E OPERABLE AND WOOD CORBELS, G.C. TO RAME AND TRIMS TO REMAIN | | MEMBRANE OVER CEMENT BOARD AT ALL WALLS AROUND SHOWER LOCATIONS | | MARTINKOVIC MILFORD |
| ······· | | (N) 1-HOUR RATED, INTERIOR PARTITION (N) 5/8" TYPE 'X' GYPSUM BOARD | | ARCHITECTS 101 Montgomery Street Suite 650 |
| | | (N) 2 X WOOD STUD FRAMING | | San Francisco, CA 94104 T 415 346 9990 |
| GLAZING AND SASHES IN KIND, SINGLE | | (N) FINISHES VARY; SEE INTERIOR ELEVATIONS | 3614 | 349 5th Avenue New York, NY 10016 T 646 741 0341 |
| E OPERABLE AND WOOD CORBELS, G.C. TO RAME AND TRIMS TO REMAIN | В | NOTE: 1. AT THICKENED WALL CONDITIONS PROVIDE FURRING OR ADDITIONAL | FILE NO. WP 3 [1 HOUR] | |
| GLAZING AND SASHES IN KIND, SINGLE E OPERABLE AND WOOD CORBELS, G.C. TO RAME AND TRIMS TO REMAIN | | STUDS TO ACCOMODATE THICKNESS 2. PROVIDE 5/8" CEMENT BOARD ON WALL SURFACE TO RECEIVE TILE FINISH | GA FILE | |
| GLAZING AND SASHES IN KIND, SINGLE E OPERABLE AND WOOD CORBELS, G.C. TO | | 3. PROVIDE LATICRETE HYDROBAN OR ARCHITECT APPROVED EQUAL LIQUID MEMBRANE OVER CEMENT BOARD AT | | T MARCHON |
| RAME AND TRIMS TO REMAIN | | ALL WALLS AROUND SHOWER LOCATIONS | | × No.CBB450 ★ |
| | | (N) INTERIOR FURRING WALL (N) 5/8" TYPE 'X' GYPSUM BOARD (N) 2 X WOOD STUD FRAMING | | 4 18 6/BO/2019 5 |
| | | (N) FINISHES VARY; SEE INTERIOR ELEVATIONS | | OF CALLED |
| | | (E) WALL | | |
| GLAZING AND SASHES IN KIND, SINGLE E OPERABLE AND WOOD CORBELS, G.C. TO |) C | 1. AT THICKENED WALL CONDITIONS PROVIDE FURRING OR ADDITIONAL STUDS TO ACCOMODATE THICKNESS | | |
| RAME AND TRIMS TO REMAIN | 5 | PROVIDE 5/8" CEMENT BOARD ON WALL SURFACE TO RECEIVE TILE FINISH PROVIDE LATICRETE HYDROBAN OR | | |
| | | ARCHITECT APPROVED EQUAL LIQUID MEMBRANE OVER CEMENT BOARD AT ALL WALLS AROUND SHOWER | | |
| | - | LOCATIONS (N) EXTERIOR WALL INFILL - STUCCO | | |
| | | (N) INTERIOR FINISH (N) 5/8" TYPE 'X' GYPSUM BOARD (N) SHEAR PLYWOOD WHERE OCCURS, S.S.D. | | |
| | D | (N) 2 X WOOD STUD FRAMING, S.S.D. | | |
| | | (N) PLYWOOD SHEATHING, S.S.D. (N) MOISTURE & AIR INFILTRATION BARRIER (N) 7/8" MIN. CEMENT PLASTER ON LATH | | |
| | | (N) 1-HOUR EXTERIOR WALL INFILL - STUCCO (N) INTERIOR FINISH | M 15-1.1 | |
| | F | (N) 5/8" TYPE 'X' GYPSUM BOARD (N) SHEAR PLYWOOD WHERE OCCURS, S.S.D. (N) 2 X WOOD STUD FRAMING, S.S.D. | CBC TABLE 720.1 (2) ITEM [1 HOUR] | |
| MINIMUM NET OPENING WIDTH OF 20" AS A | | (N) THERMAL INSULATION (N) PLYWOOD SHEATHING, S.S.D. | ABLE 720 [1 H | |
| G OF THE WINDOW SHALL BE AT A HEIGHT E OPENINGS THROUGH WHICH A 4" DIAMETER | | (N) MOISTURE & AIR INFILTRATION BARRIER (N) 7/8" MIN. CEMENT PLASTER ON LATH | CBC T | |
| | | (N) INTERIOR FINISH (N) 5/8" TYPE 'X' GYPSUM BOARD | J314 | |
| | G | (N) SHEAR PLYWOOD WHERE OCCURS, S.S.D. (N) 2 X WOOD STUD FRAMING, S.S.D. (N) R-13 MIN. BATT INSULATION | UL DESIGN U309 & U314 [1 HOUR] | |
| | | (N)1/2" PLYWOOD SHEATHING, S.S.D. | L DESIGN | |
| | | (N) MOISTURE & AIR INFILTRATION BARRIER (N) 1/2" P.T. PROPERTY LINE PLYWOOD | | RECORD OF DRAWING ISSUANCE Permit Set 05.15.2017 |
| | | (N) NON-RATED EXTERIOR PARTIAL HEIGHT WALL | | Permit Set Revision 1 10.04.2017 Permit Set Revision 2 2 12.20.2017 |
| | н | (N) SHEATHING, S.S.D. (N) 2 X WOOD STUD FRAMING, S.S.D. | | Permit Set Revision 2 2 12.20.2017 |
| | | (N) MOISTURE & AIR INFILTRATION BARRIER | | |
| | | (N) 7/8" MIN. CEMENT PLASTER ON LATH | | |
| | | (N) 1-HOUR RATED EXTERIOR PARTIAL HEIGHT WALL | | |
| | | (N) 5/8" TYPE 'X' GYPSUM SHEATHING | GA FILE NO. WP 8105 [1 HOUR] | Permit Set Revision 2 |
| S: wood stud spacing, stud doubling, | J | (N) MOISTURE & AIR INFILTRATION BARRIER | A FILE NO | Drawn By: LGB |
| AND ADDITIONAL INFORMATION. FIRE RESISTANCE DESIGN MANUAL AND R REFERENCE RATED WALL ASSEMBLIES, | | (N) EXTERIOR FINISH; 7/8" MIN. CEMENT PLASTER ON LATH OR 3/4" DROP SIDING | 6, | Checked By :KBProject Number:1635.1 |
| NG AND FINISHES TO COMPLY WITH THE CED WALL RATED WALL ASSEMBLY AND | | (E) EXTERIOR WALL INFILL - WOOD SIDING (N) INTERIOR FINISH, MATCH ADJACENT | | Schedules |
| ALL CAVITY. MINIMUM R-13 INSULATION INIMUM R-19 INSULATION IN 2X6 | к | (N) 5/8" TYPE 'X' GYPSUM BOARD (N) SHEAR PLYWOOD WHERE OCCURS, S.S.D. (N) 2 X WOOD STUD FRAMING, S.S.D. | | |
| LENT U-FACTOR. IT PLASTER ASSEMBLIES. ROM CONSULTANT DRAWNGS, USE MORE | | (N) THERMAL INSULATION (N) SHEATHING, MATCH ADJACENT (N) MOISTURE & AIR INFILTRATION BARRIER | | SHEET NUMBER |
| ARCHITECT TO CONFIRM. | | (N) 3/4" DROP SIDING, MATCH ADJACENT | | A901 |
| | | | | - |

| | DOOR | | | | FRAME | | | |
|------------|-------------------------|-----------|--------|-----------------|--------|----------------------|--------|--|
| YPE | W x H LEAF | тург | тшек | | FINICI | | FINICI | COMMENTS |
| E | DIM. U.O.N. EXISTING | TYPE E | THICK | MATERIAL | FINISH | MATERIAL EXISTING | FINISH | COMMENTS ALL (E) EXTERIOR DOORS TO REMAIN, U.O.N. |
| (01A | 7'-10 1/2" X 8'-0" | D9 | 1 3/4" | SOLID CORE WOOD | T.B.D. | SOLID CORE WOOD | T.B.D. | TO REPLACE (E) IN KIND. MIN. 200 SQ. IN LOUVER VENTILATION. |
| 101B | 2'-10" X 6'-8" | D7 | 1 3/4" | SOLID CORE WOOD | T.B.D. | SOLID CORE WOOD | T.B.D. | |
| (04A | 3'-2" X 6'-8" | D3 | 1 3/4" | SOLID CORE WOOD | T.B.D. | SOLID CORE WOOD | T.B.D. | |
| 104B | 2'-2" X 6'-0" | D4 | 1/2" | TEMPERED GLASS | T.B.D. | | T.B.D. | FRAMELESS TEMPERED GLASS SHOWER DOOR |
| 105A | 2'-8" X 6'-8" | D3 | 1 3/4" | SOLID CORE WOOD | T.B.D. | SOLID CORE WOOD | T.B.D. | |
| 105B | 4'-8" X 6'-8" | D6 | 1 3/4" | SOLID CORE WOOD | T.B.D. | SOLID CORE WOOD | T.B.D. | |
| 1050 | 4'-8" X 6'-8" | D6 | 1 3/4" | SOLID CORE WOOD | T.B.D. | SOLID CORE WOOD | T.B.D. | |
| 105D | 2'-10" X 6'-8" | D7 | 1 3/4" | SOLID CORE WOOD | T.B.D. | SOLID CORE WOOD | T.B.D. | |
| (108) | +/- 10'-0" X 6'-8" | D8 | 1 3/4" | SOLID CORE WOOD | T.B.D. | SOLID CORE WOOD | T.B.D. | MIN. 200 SQ. IN. LOUVER FOR VENTILATION 20 MIN. FIRE-RATED AND FRAME W/SMOKE GASKI REPLACE IN KIND, G.C. TO VERIFY SIZE IN FIELD |
| 205 | 10'-6" X 9'-11 1/2" | D2 | 1 3/4" | GLASS | T.B.D. | SOLID CORE WOOD | T.B.D. | |
| 207A | NOT USED | | | | | | | |
| 209 | NOT USED | | | | | | | |
| 402A | 7'-1" X 6'-8" | D2 | 1 3/4" | SOLID CORE WOOD | T.B.D. | SOLID CORE WOOD | T.B.D. | |
| 402B | 3'-10" X 6'-8" | D11 | 1 3/4" | SOLID CORE WOOD | T.B.D. | SOLID CORE WOOD | T.B.D. | |
| 404 | 2'-6" X 6'-8" | D3 | 1 3/4" | SOLID CORE WOOD | T.B.D. | SOLID CORE WOOD | T.B.D. | |

