Certificate of Appropriateness Case Report

HEARING DATE: JUNE 6, 2018

1650 Mission St. Suite 400 San Francisco, CA 94103-2479

Reception:

415.558.6378

Fax: 415.558.6409

Planning Information: **415.558.6377**

 Case No.:
 2015-007715COA-02

 Project Address:
 2342-2344 3RD STREET

Historic Landmark: Dogpatch Landmark District Zoning: UMU (Urban Mixed Use)

45-X Height and Bulk District

Block/Lot: 4108/003A Applicant: John Kevlin

> Reuben, Junius & Rose, LLP 1 Bush Street, Suite 600 San Francisco, CA 94104

Staff Contact: Natalia Kwiatkowska - (415) 575-9185

natalia.kwiatkowska@sfgov.org

Reviewed By: Tim Frye – (415) 575-6822

tim.frye@sfgov.org

PROPERTY DESCRIPTION

2342-2344 3RD STREET is a three-story, group housing building located on a rectangular midblock lot on the west side of 3rd Street between 20th and 22rd Streets. The subject property was originally constructed between 1905 and 1914 in a flat-front Italianate style. The front façade of the building was stripped and clad in stucco at an unknown date. The building is a contributor to the Article 10 Dogpatch Landmark District.

PROJECT DESCRIPTION

The proposed project entails the rehabilitation of the existing building including restoration of the exterior, addition of a storefront, removal of a non-historic rear addition, and an interior remodel. The restoration is based on physical evidence upon the removal of the non-historic stucco and shingles and historic photographs in accordance with the *Secretary of the Interior's Standards for Rehabilitation*. Please reference the plans and photographs for details. The exterior work is described in more detail below:

- Remove existing non-historic stucco at front façade and non-historic roofing shingles at side
 and restore historic wood cladding including repair and replacement where existing conditions
 are deteriorated beyond repair.
- Replace existing non-historic aluminum windows with wood-sash, double-hung windows with
 ogee lugs, divisions, and wood trim based on historic evidence. The project includes minor
 changes to the fenestration at side and rear facades including installation of new windows and
 doors, relocation of windows, and elimination of windows.

- Replace existing non-historic garage and entries at ground level with a wood-sash storefront and a wood residential entry based on historic evidence.
- Restore existing wood cornice and parapet.
- Replacement of existing metal gate and fence at front.
- Remove existing non-historic shed-roofed addition at rear and replace existing wood stair with
 a steel stair, which is a required second means of egress per the Building Code. The existing
 rear wall will be partially demolished and the remaining portion will be fire-rated.

COMPLIANCE WITH THE PLANNING CODE PROVISIONS

The proposed project is in compliance with all other provisions of the Planning Code.

APPLICABLE PRESERVATION STANDARDS

ARTICLE 10

Pursuant to Section 1006.2 of the Planning Code, unless exempt from the Certificate of Appropriateness requirements or delegated to Planning Department Preservation staff through the Administrative Certificate Appropriateness process, the Historic Preservation Commission is required to review any applications for the construction, alteration, removal, or demolition of any designated Landmark for which a City permit is required. Section 1006.6 states that in evaluating a request for a Certificate of Appropriateness for an individual landmark or a contributing building within a historic district, the Historic Preservation Commission must find that the proposed work is in compliance with the Secretary of the Interior's Standards for the Treatment of Historic Properties, as well as the designating Ordinance and any applicable guidelines, local interpretations, bulletins, related appendices, or other policies.

ARTICLE 10 – Appendix L – Dogpatch Landmark District

In reviewing an application for a Certificate of Appropriateness, the Historic Preservation Commission must consider whether the proposed work would be compatible with the character of the Dogpatch Landmark District as described in Appendix L of Article 10 of the Planning Code and the character-defining features specifically outlined in the designating ordinance.

THE SECRETARY OF THE INTERIOR'S STANDARDS

Rehabilitation is the act or process of making possible a compatible use for a property through repair, alterations, and additions while preserving those portions or features that convey its historical, cultural, or architectural values. The Rehabilitation Standards provide, in relevant part(s):

Standard 1: A property shall be used for its historic purpose or be placed in a new use that requires minimal change to the defining characteristics of the building and its site and environment.

The proposed project would maintain the subject property's current and historic residential use while restoring exterior features. Therefore, the proposed project complies with Rehabilitation Standard 1.

Standard 2: The historic character of a property shall be retained and preserved. The removal of historic materials or alteration of features and spaces that characterize a property shall be avoided.

The proposed project would not remove or alter any features or spaces, which characterize the building or surrounding landmark district. The decorative ornament and window trim was stripped and the front façade was clad in stucco at an unknown date. The project will reconstruct and restore the historic character of the subject property, as defined by its character-defining features including, but not limited to, its overall mass and form, storefront, double-hung woodsash windows, wood cladding, wood cornice and decorative elements based on physical evidence upon removal of the existing non-historic cladding and on historic evidence. Therefore, the proposed project complies with Rehabilitation Standard 2.

Standard 3: Each property will be recognized as a physical record of its time, place and use. Changes that create a false sense of historical development, such as adding conjectural features or architectural elements from other buildings, shall not be undertaken.

The proposed project does not include the addition of conjectural elements or architectural features from other buildings. The proposed façade elements will be designed in accordance with physical building evidence upon the removal of the non-historic cladding and on historic photographs. The project will install a storefront based on historic photographs. The new work will not create a false sense of historical development. The new work will be compatible with and will improve the integrity of the building and surrounding district. Therefore, the proposed project complies with Rehabilitation Standard 3.

Standard 5: Distinctive features, finishes, and construction techniques or examples of fine craftsmanship that characterize a property will be preserved.

The proposed project does not impact or destroy any distinctive features, finishes or construction techniques, which characterize the surrounding district. Nearly all character-defining elements at the primary façade have previously been removed. All restorative work will match the lost historic features in design, material, and finish. All other features in repairable condition will be preserved. Therefore, the proposed project complies with Rehabilitation Standard 5.

Standard 6: Deteriorated historic features will be repaired rather than replaced. Where the severity of deterioration requires replacements of a distinctive feature, the new feature will

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match the old in design, color, texture, and other visual qualities and, where possible, materials. Replacement of missing features shall be substantiated by documentary, physical, or pictorial evidence.

The subject property was substantially altered in the past and nearly all of the character-defining features have been removed including decorative ornament, windows and trim, cornice, and storefront; however, the property is still contributing in its current form. Some character-defining features such as historic wood cladding were exposed through the exploratory removal of non-historic stucco and shingles. The project proposes to restore the historic wood cladding including repair and replacement where the severity of deteriorated requires it. All replacement of missing features is based on physical evidence upon the removal of non-historic cladding and on historic photographs. All replacement features will match the old in design, color, texture, and materials. Therefore, the proposed project complies with Rehabilitation Standard 6.

Standard 9:

New additions, exterior alterations, or related new construction will not destroy historic materials, features, and spatial relationships that characterize the property. The new work will be differentiated from the old and will be compatible with the historic materials, features, size, scale and proportion, and massing to protect the integrity of the property and its environment.

The proposed project would not destroy or damage any contributing elements to the Dogpatch Landmark District. The project will remove a non-historic, shed-roofed, addition at rear that was not constructed during the period of significance and does not possess character-defining features associated with the building or district. The wood stair at rear will be reconstructed of steel materials to meet current Building Code requirements. The replacement stair will be minimally visible from the public right-of-way. Therefore, the proposed project complies with Rehabilitation Standard #9.

Standard 10:

New additions and adjacent or related new construction shall be undertaken in such a manner that if removed in the future, the essential form and integrity of the historic property and its environment would be unimpaired.

The proposed project is not additive in nature, but would restore the historic character of the building including a ground floor storefront. The proposed scope of work does not entail any additions or related new construction. Therefore, the proposed project complies with Rehabilitation Standard 10.

Summary:

The Department finds that the overall project is consistent with the Secretary of the Interior Standards for Rehabilitation.

PUBLIC/NEIGHBORHOOD INPUT

To date, the Department has not received any public comment in regards to the project.

STAFF ANALYSIS

Included as an exhibit are architectural drawings of the existing building and the proposed project. Based on the requirements of Article 10, Appendix L of Article 10 of the Planning Code, and the Secretary of Interior's Standards, Department staff has determined that the proposed work is compatible with the character-defining features of the subject building and with the Dogpatch Landmark District. Due to the extensive removal of historic materials at the primary façade, the proposed scope of reconstructive work would restore the historic character of the existing building, including distinctive materials, architectural elements, and spaces that characterize the property. The new features specified for the façade will be in alignment with the property's and district's character-defining features. The proposal includes new openings at the ground level on the side elevation which are compatible in terms of size, proportion, and materials and will not be visible form the public right-of-way.

Staff recommends four Conditions of Approval that will ensure that the proposed work is undertaken in conformance with this Certificate of Appropriateness.

Department staff finds that the proposed work will be in conformance with the *Standards* and requirements of Article 10, and that the work is compatible with the Dogpatch Landmark District. Staff recommends approval with conditions.

ENVIRONMENTAL REVIEW STATUS

The Department has determined that the proposed project is exempt/excluded from environmental review, pursuant to CEQA Guideline Section 15301 (Class One - Minor Alteration of Existing Facility, (e) Additions to existing structures provided that the addition will not result in an increase of more than 10,000 square feet).

PLANNING DEPARTMENT RECOMMENDATION

Planning Department staff recommends APPROVAL WITH CONDITIONS of the proposed project as it appears to meet the *Secretary of the Interior Standards for Rehabilitation* and requirements of Article 10.

- 1. As part of the Building Permit, the Project Sponsor shall contact Planning Department preservation staff once full demolition of the existing non-historic cladding is complete to coordinate on site review prior to work commencing on the exterior restoration.
- If necessary, based on new information the Project Sponsor shall revise the proposed façade restoration details in conformance with physical evidence and staff site visit recommendations subject to Department review and approval.
- 3. As part of the Building Permit, the Project Sponsor shall provide material samples to ensure compatibility with the surrounding landmark district. These material samples shall demonstrate the range of color and finishes for the identified materials.
- 4. As part of the Building Permit, the Project Sponsor shall include a notation on the plan set stating a mock-up for the new storefront, window systems, and cornice will be provided prior to commencement of work. The proposed storefront shall be based on physical and historic

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evidence. The Project Sponsor shall continue working with staff on details to ensure compatibility with the landmark district. The required mock-up is subject to review and approval by Planning Department Preservation staff prior to work commencement.

ATTACHMENTS

Draft Motion

Exhibits:

- Parcel Map
- Sanborn Map
- Zoning Map
- Aerial Photograph
- Site Photo

Environmental Analysis

Project Sponsor submittal, including:

• Reduced Plans

Historic Preservation Commission Draft Motion

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ADOPTING FINDINGS FOR A CERTIFICATE OF APPROPRIATENESS FOR PROPOSED WORK DETERMINED TO BE APPROPRIATE FOR AND CONSISTENT WITH THE PURPOSES OF ARTICLE 10, TO MEET THE STANDARDS OF ARTICLE 10 AND TO MEET THE SECRETARY OF INTERIOR'S STANDARDS FOR REHABILITATION, FOR THE PROPERTY LOCATED ON LOT 003A IN ASSESSOR'S BLOCK 4108, WITHIN UMU (URBAN MIXED USE) ZONING DISTRICT, A 45-X HEIGHT AND BULK DISTRICT, AND THE DOGPATCH LANDMARK DISTRICT.

PREAMBLE

WHEREAS, on June 21, 2017, Reuben, Junius & Rose ("Project Sponsor") filed an application with the San Francisco Planning Department (hereinafter "Department") for a Certificate of Appropriateness for exterior and interior alterations of the subject property including: restoration of the exterior, addition of a storefront, removal of a non-historic rear addition, and an interior remodel.

WHEREAS, the Project was determined by the Department to be categorically exempt from environmental review. The Historic Preservation Commission ("Commission") has reviewed and concurs with said determination.

WHEREAS, on June 6, 2018, the Commission conducted a duly noticed public hearing on the current project, Case No. 2015-007715COA-02 (Project) for its appropriateness.

WHEREAS, in reviewing the Application, the Commission has had available for its review and consideration case reports, plans, and other materials pertaining to the Project contained in the

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Draft Motion Hearing Date: June 6, 2018

Department's case files, has reviewed and heard testimony and received materials from interested parties during the public hearing on the Project.

MOVED, that the Commission hereby grants the Certificate of Appropriateness, in conformance with the architectural plans labeled Exhibit A on file in the docket for Case 2015-007715COA-02 based on the following findings:

CONDITIONS OF APPROVAL

- 1. As part of the Building Permit, the Project Sponsor shall contact Planning Department preservation staff once full demolition of the existing non-historic cladding is complete to coordinate on site review prior to work commencing on the exterior restoration.
- 2. If necessary, based on new information the Project Sponsor shall revise the proposed façade restoration details in conformance with physical evidence and staff site visit recommendations subject to Department review and approval.
- 3. As part of the Building Permit, the Project Sponsor shall provide material samples to ensure compatibility with the surrounding landmark district. These material samples shall demonstrate the range of color and finishes for the identified materials.
- 4. As part of the Building Permit, the Project Sponsor shall include a notation on the plan set stating a mock-up for the new storefront, window systems, and cornice will be provided prior to commencement of work. The proposed storefront shall be based on physical and historic evidence. The Project Sponsor shall continue working with staff on details to ensure compatibility with the landmark district. The required mock-up is subject to review and approval by Planning Department Preservation staff prior to work commencement.

FINDINGS

Having reviewed all the materials identified in the recitals above and having heard oral testimony and arguments, this Commission finds, concludes, and determines as follows:

- 1. The above recitals are accurate and also constitute findings of the Commission.
- 2. Findings pursuant to Article 10:

The Historic Preservation Commission has determined that the proposed work is compatible with the character of the landmark as described in the designation report.

- The project will retain the existing residential use and historic character of the building and landmark district.
- The proposed project will not add any conjectural historical features or features that add a false sense of historical development. The façade restoration will be based on documentary evidence including historic photographs and physical evidence upon removal of the nonhistoric cladding.

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- The project will restore distinctive materials and finishes from the period of significance, including wood cladding, double-hung wood sash windows, wood cornice and decorative elements, and replacing the existing roll-up garage door and ground floor entries with a wood storefront and entry to gain further compatibility with the landmark district.
- The proposed project meets the requirements of Article 10, Appendix L of the Planning Code.
- The proposed project meets the following Secretary of Interior's Standards for Rehabilitation:

Standard 1.

A property shall be used for its historic purpose or be placed in a new use that requires minimal change to the defining characteristics of the building and its site and environment.

Standard 2.

The historic character of a property shall be retained and preserved. The removal of historic materials or alteration of features and spaces that characterize a property shall be avoided.

Standard 3.

Each property will be recognized as a physical record of its time, place, and use. Changes that create a false sense of historical development, such as adding conjectural features or elements from other historic properties, will not be undertaken.

Standard 5.

Distinctive features, finishes, and construction techniques or examples of craftsmanship that characterize a property shall be preserved.

Standard 6.

Deteriorated historic features will be repaired rather than replaced. Where the severity of deterioration requires replacement of a distinctive feature, the new feature will match the old in design, color, texture, and, where possible, materials. Replacement of missing features will be substantiated by documentary and physical evidence.

Standard 9.

New additions, exterior alterations, or related new construction will not destroy historic materials, features, and spatial relationships that characterize the property. The new work will be differentiated from the old and will be compatible with the historic materials, features, size, scale and proportion, and massing to protect the integrity of the property and its environment.

Standard 10.

New additions and adjacent or related new construction shall be undertaken in such a manner that if removed in the future, the essential form and integrity of the historic property and its environment would be unimpaired.

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3. **General Plan Compliance.** The proposed Certificate of Appropriateness is, on balance, consistent with the following Objectives and Policies of the General Plan:

I. URBAN DESIGN ELEMENT

THE URBAN DESIGN ELEMENT CONCERNS THE PHYSICAL CHARACTER AND ORDER OF THE CITY, AND THE RELATIONSHIP BETWEEN PEOPLE AND THEIR ENVIRONMENT.

GOALS

The Urban Design Element is concerned both with development and with preservation. It is a concerted effort to recognize the positive attributes of the city, to enhance and conserve those attributes, and to improve the living environment where it is less than satisfactory. The Plan is a definition of quality, a definition based upon human needs.

OBJECTIVE 1

EMPHASIS OF THE CHARACTERISTIC PATTERN WHICH GIVES TO THE CITY AND ITS NEIGHBORHOODS AN IMAGE, A SENSE OF PURPOSE, AND A MEANS OF ORIENTATION.

POLICY 1.3

Recognize that buildings, when seen together, produce a total effect that characterizes the city and its districts.

OBJECTIVE 2

CONSERVATION OF RESOURCES WHICH PROVIDE A SENSE OF NATURE, CONTINUITY WITH THE PAST, AND FREEDOM FROM OVERCROWDING.

POLICY 2.4

Preserve notable landmarks and areas of historic, architectural or aesthetic value, and promote the preservation of other buildings and features that provide continuity with past development.

POLICY 2.5

Use care in remodeling of older buildings, in order to enhance rather than weaken the original character of such buildings.

POLICY 2.7

Recognize and protect outstanding and unique areas that contribute in an extraordinary degree to San Francisco's visual form and character.

The goal of a Certificate of Appropriateness is to provide additional oversight for buildings and districts that are architecturally or culturally significant to the City in order to protect the qualities that are associated with that significance.

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The proposed project qualifies for a Certificate of Appropriateness and therefore furthers these policies and objectives by maintaining and preserving the character-defining features of the contributory property and landmark district for the future enjoyment and education of San Francisco residents and visitors.

- 4. The proposed project is generally consistent with the eight General Plan priority policies set forth in Section 101.1 in that:
 - A) The existing neighborhood-serving retail uses will be preserved and enhanced and future opportunities for resident employment in and ownership of such businesses will be enhanced:

The proposed project includes the addition of a storefront for a future retail use.

B) The existing housing and neighborhood character will be conserved and protected in order to preserve the cultural and economic diversity of our neighborhoods:

The proposed project will strengthen neighborhood character by respecting the character-defining features of the site and landmark district in conformance with the Secretary of the Interior's Standards.

C) The City's supply of affordable housing will be preserved and enhanced:

The project will not reduce the affordable housing supply as the existing units will be retained.

D) The commuter traffic will not impede MUNI transit service or overburden our streets or neighborhood parking:

The proposed project will not result in commuter traffic impeding MUNI transit service or overburdening the streets or neighborhood parking.

E) A diverse economic base will be maintained by protecting our industrial and service sectors from displacement due to commercial office development. And future opportunities for resident employment and ownership in these sectors will be enhanced:

The proposed project will not have any impact on industrial and service sector jobs.

F) The City will achieve the greatest possible preparedness to protect against injury and loss of life in an earthquake.

Preparedness against injury and loss of life in an earthquake will be improved by the proposed work. The work will be executed in compliance with all applicable construction and safety measures.

G) That landmark and historic buildings will be preserved:

The proposed project is in conformance with Article 10 of the Planning Code and the Secretary of the

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Interior's Standards.

H) Parks and open space and their access to sunlight and vistas will be protected from development:

The proposed project will not impact the access to sunlight or vistas for the parks and open space.

5. For these reasons, the proposal overall, is appropriate for and consistent with the purposes of Article 10, meets the standards of Article 10, and the Secretary of Interior's Standards for Rehabilitation, General Plan and Prop M findings of the Planning Code.

Draft Motion CASE NO 2015-007715COA-02 Hearing Date: June 6, 2018 2342-2344 3rd Street

DECISION

That based upon the Record, the submissions by the Applicant, the staff of the Department and other interested parties, the oral testimony presented to this Commission at the public hearings, and all other written materials submitted by all parties, the Commission hereby **GRANTS a Certificate of Appropriateness** for the property located at Lot 003A in Assessor's Block 4108 for proposed work in conformance with the renderings labeled Exhibit A on file in the docket for Case No. 2015-007715COA-02.

APPEAL AND EFFECTIVE DATE OF MOTION: The Commission's decision on a Certificate of Appropriateness shall be final unless appealed within thirty (30) days. Any appeal shall be made to the Board of Appeals, unless the proposed project requires Board of Supervisors approval or is appealed to the Board of Supervisors as a conditional use, in which case any appeal shall be made to the Board of Supervisors (see Charter Section 4.135).


Duration of this Certificate of Appropriateness: This Certificate of Appropriateness is issued pursuant to Article 10 of the Planning Code and is valid for a period of three (3) years from the effective date of approval by the Historic Preservation Commission. The authorization and right vested by virtue of this action shall be deemed void and canceled if, within 3 years of the date of this Motion, a site permit or building permit for the Project has not been secured by Project Sponsor.

THIS IS NOT A PERMIT TO COMMENCE ANY WORK OR CHANGE OF OCCUPANCY UNLESS NO BUILDING PERMIT IS REQUIRED. PERMITS FROM THE DEPARTMENT OF BUILDING INSPECTION (and any other appropriate agencies) MUST BE SECURED BEFORE WORK IS STARTED OR OCCUPANCY IS CHANGED.

I hereby certify that the Historical Preservation Commission ADOPTED the foregoing Motion on June 6, 2018

Jonas P. Ionin	Ĺ
Commission S	Secretary
AYES:	
NAYS:	
ABSENT:	
ADOPTED:	June 6, 2018


Parcel Map

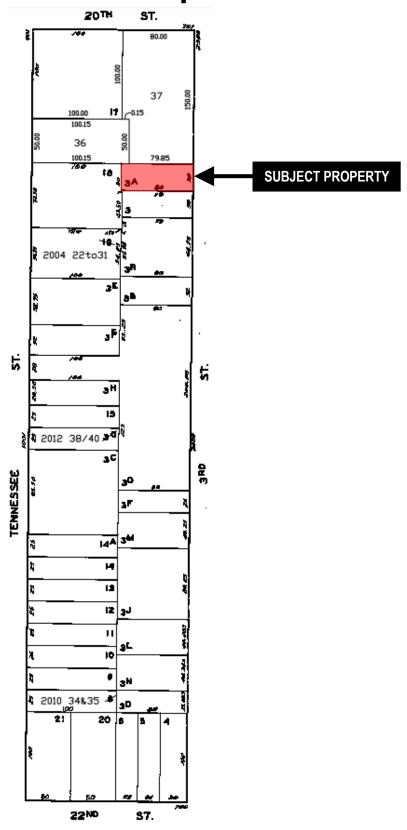



Certificate of Appropriateness Hearing Case Number 2015-007715COA-02 2342 3rd Street Block 4108 Lot 003A

Sanborn Map*

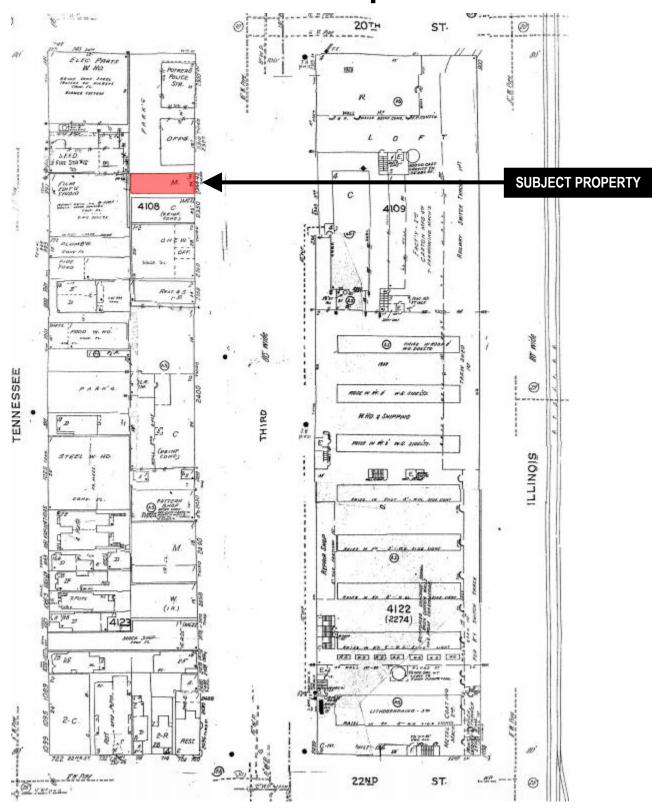

*The Sanborn Maps in San Francisco have not been updated since 1998, and this map may not accurately reflect existing conditions.



Certificate of Appropriateness Hearing **Case Number 2015-007715COA-02** 2342 3rd Street Block 4108 Lot 003A


Zoning Map





Certificate of Appropriateness Hearing **Case Number 2015-007715COA-02** 2342 3rd Street Block 4108 Lot 003A

Aerial Photo

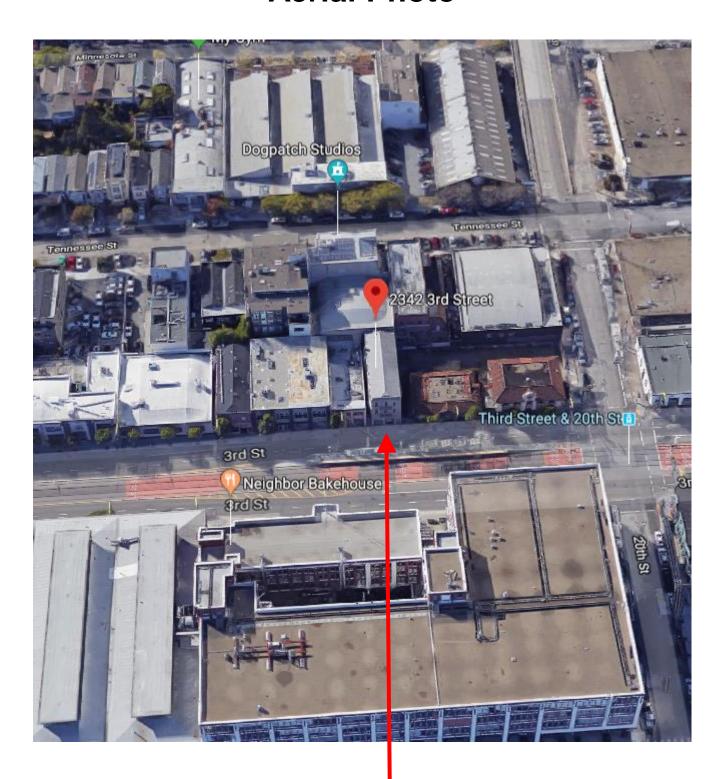

SUBJECT PROPERTY



Certificate of Appropriateness Hearing Case Number 2015-007715COA-02 2342 3rd Street Block 4108 Lot 003A

Site Photo



SUBJECT PROPERTY

Certificate of Appropriateness Hearing **Case Number 2015-007715COA-02** 2342 3rd Street Block 4108 Lot 003A

CEQA Categorical Exemption Determination

PROPERTY INFORMATION/PROJECT DESCRIPTION

Project Address			Block/Lot(s)	
2342 -2344 3rd St.			4108003A	
Case No.			Permit No.	
2015-007715PRJ			201503171039	
Addition/ Demolition (requires HRE for		Demolition (requires HRE for	New	
AI	teration	Category B Building)	Construction	
Proje	ct description for	Planning Department approval.		
the ex	The proposed project entails rehabilitation of the existing three-story, residential building including restoration of the exterior, installation of a new storefront, removal of a non-historic rear addition, and an interior remodel. The subject property, constructed between 1905 and 1914, is a contributor to the Article 10 Dogpatch Landmark District			
	P 1: EXEMPTIC e: If neither class a	ON CLASS applies, an Environmental Evaluation Application	on is required.*	
	Class 1 - Existin	g Facilities. Interior and exterior alterations; addit	ions under 10,000 sq. ft.	
		onstruction. Up to three new single-family resider rcial/office structures; utility extensions; change of a CU.		
	Class 32 - In-Fill Development. New Construction of seven or more units or additions greater than 10,000 sq. ft. and meets the conditions described below: (a) The project is consistent with the applicable general plan designation and all applicable general plan policies as well as with applicable zoning designation and regulations. (b) The proposed development occurs within city limits on a project site of no more than 5 acres substantially surrounded by urban uses. (c) The project site has no value as habitat for endangered rare or threatened species. (d) Approval of the project would not result in any significant effects relating to traffic, noise, air quality, or water quality. (e) The site can be adequately served by all required utilities and public services. FOR ENVIRONMENTAL PLANNING USE ONLY			
	Class			

STEP 2: CEQA IMPACTS

TO BE COMPLETED BY PROJECT PLANNER

If any box is checked below, an Environmental Evaluation Application is required.						
	Air Quality: Would the project add new sensitive receptors (specifically, schools, day care facilities, hospitals, residential dwellings, and senior-care facilities within an Air Pollution Exposure Zone? Does the project have the potential to emit substantial pollutant concentrations (e.g., backup diesel generators, heavy industry, diesel trucks, etc.)? (refer to EP _ArcMap > CEQA Catex Determination Layers > Air Pollution Exposure Zone)					
Hazardous Materials: If the project site is located on the Maher map or is suspected of containing hazardous materials (based on a previous use such as gas station, auto repair, dry cleaners, or heavy manufacturing, or a site with underground storage tanks): Would the project involve 50 cubic yards or more of soil disturbance - or a change of use from industrial to residential? If yes, this box must be checked and the project applicant must submit an Environmental Application with a Phase I Environmental Site Assessment. Exceptions: do not check box if the applicant presents documentation of enrollment in the San Francisco Department of Public Health (DPH) Maher program, a DPH waiver from the Maher program, or other documentation from Environmental Planning staff that hazardous material effects would be less than significant (refer to EP_ArcMap > Maher layer).						
	Transportation: Does the project create six (6) or more net new parking spaces or residential units? Does the project have the potential to adversely affect transit, pedestrian and/or bicycle safety (hazards) or the adequacy of nearby transit, pedestrian and/or bicycle facilities?					
	Archeological Resources: Would the project result in soil disturbance/modification greater than two (2) feet below grade in an archeological sensitive area or eight (8) feet in a non-archeological sensitive area? (refer to EP_ArcMap > CEQA Catex Determination Layers > Archeological Sensitive Area)					
	Subdivision/Lot Line Adjustment: Does the project site involve a subdivision or lot line adjustment on a lot with a slope average of 20% or more? (refer to EP_ArcMap > CEQA Catex Determination Layers > Topography)					
	Slope = or > 20%: Does the project involve any of the following: (1) square footage expansion greater than 1,000 sq. ft. outside of the existing building footprint, (2) excavation of 50 cubic yards or more of soil, (3) new construction? (refer to EP_ArcMap > CEQA Catex Determination Layers > Topography) If box is checked, a geotechnical report is required.					
	Seismic: Landslide Zone: Does the project involve any of the following: (1) square footage expansion greater than 1,000 sq. ft. outside of the existing building footprint, (2) excavation of 50 cubic yards or more of soil, (3) new construction? (refer to EP_ArcMap > CEQA Catex Determination Layers > Seismic Hazard Zones) If box is checked, a geotechnical report is required.					
	Seismic: Liquefaction Zone: Does the project involve any of the following: (1) square footage expansion greater than 1,000 sq. ft. outside of the existing building footprint, (2) excavation of 50 cubic yards or more of soil, (3) new construction? (refer to EP_ArcMap > CEQA Catex Determination Layers > Seismic Hazard Zones) If box is checked, a geotechnical report will likely be required.					
1	If no boxes are checked above, GO TO STEP 3. If one or more boxes are checked above, an Environmental Evaluation Application is required, unless reviewed by an Environmental Planner.					
Com	Comments and Planner Signature (optional): Natalia Kwiatkowska					

STEP 3: PROPERTY STATUS - HISTORIC RESOURCE TO BE COMPLETED BY PROJECT PLANNER PROPERTY IS ONE OF THE FOLLOWING: (refer to Parcel Information Map)

PROPERTY IS ONE OF THE FOLLOWING: (refer to Parcel Information Map)				
	Category A: Known Historical Resource. GO TO STEP 5.			
	Category B: Potential Historical Resource (over 45 years of age). GO TO STEP 4.			
	Category C: Not a Historical Resource or Not Age Eligible (under 45 years of age). GO TO STEP 6.			

STEP 4: PROPOSED WORK CHECKLIST

TO BE COMPLETED BY PROJECT PLANNER

Check	Check all that apply to the project.				
	1. Change of use and new construction. Tenant improvements not included.				
	2. Regular maintenance or repair to correct or repair deterioration, decay, or damage to building.				
	3. Window replacement that meets the Department's <i>Window Replacement Standards</i> . Does not include storefront window alterations.				
	4. Garage work. A new opening that meets the <i>Guidelines for Adding Garages and Curb Cuts</i> , and/or replacement of a garage door in an existing opening that meets the Residential Design Guidelines.				
	5. Deck, terrace construction, or fences not visible from any immediately adjacent public right-of-way.				
	6. Mechanical equipment installation that is not visible from any immediately adjacent public right-of-way.				
	7. Dormer installation that meets the requirements for exemption from public notification under <i>Zoning Administrator Bulletin No. 3: Dormer Windows</i> .				
	8. Addition(s) that are not visible from any immediately adjacent public right-of-way for 150 feet in each direction; does not extend vertically beyond the floor level of the top story of the structure or is only a single story in height; does not have a footprint that is more than 50% larger than that of the original building; and does not cause the removal of architectural significant roofing features.				
Note: I	Note: Project Planner must check box below before proceeding.				
	Project is not listed. GO TO STEP 5.				
	Project does not conform to the scopes of work. GO TO STEP 5.				
	Project involves four or more work descriptions. GO TO STEP 5.				
	Project involves less than four work descriptions. GO TO STEP 6.				

STEP 5: CEQA IMPACTS - ADVANCED HISTORICAL REVIEW

TO BE COMPLETED BY PROJECT PLANNER

Chec	Check all that apply to the project.		
	1. Project involves a known historical resource (CEQA Category A) as determined by Step 3 and conforms entirely to proposed work checklist in Step 4.		
	2. Interior alterations to publicly accessible spaces.		
	3. Window replacement of original/historic windows that are not "in-kind" but are consistent with existing historic character.		
	4. Façade/storefront alterations that do not remove, alter, or obscure character-defining features.		
	5. Raising the building in a manner that does not remove, alter, or obscure character-defining features.		
	6. Restoration based upon documented evidence of a building's historic condition, such as historic photographs, plans, physical evidence, or similar buildings.		

╽╙╽	7. Addition(s) , including mechanical equipment that are minimally visible from a public right-of-way and meet the <i>Secretary of the Interior's Standards for Rehabilitation</i> .			
	8. Other work consistent with the Secretary of the In Properties (specify or add comments):	nterior Stand	lards for the Treatment of Historic	
	9. Other work that would not materially impair a history	oric district (s	specify or add comments):	
	(Requires approval by Senior Preservation Planner/F	Preservation	Coordinator)	
	10. Reclassification of property status . (Requires a Planner/Preservation	approval by S	Senior Preservation	
	Reclassify to Category A	Reclass	sify to Category C	
	a. Per HRER dated	(attach HRE	ER)	
	b. Other (specify):			
	Note: If ANY box in STEP 5 above is checked, a	Preservatio	n Planner MUST check one box below.	
	Further environmental review required. Based on the information provided, the project requires an Environmental Evaluation Application to be submitted. GO TO STEP 6.			
	Project can proceed with categorical exemption review. The project has been reviewed by the Preservation Planner and can proceed with categorical exemption review. GO TO STEP 6.			
	Preservation Planner and can proceed with categoric	cal exemption	n review. GO TO STEP 6.	
Comm	Preservation Planner and can proceed with categorice ents (optional):	cal exemption	n review. GO TO STEP 6.	
	•		n review. GO TO STEP 6.	_
Preser	ents (optional): vation Planner Signature: Natalia Kwiatkows	ka	n review. GO TO STEP 6.	
Preser ——————————————————————————————————	ents (optional): vation Planner Signature: Natalia Kwiatkows EP 6: CATEGORICAL EXEMPTION DETERMINGS ECOMPLETED BY PROJECT PLANNER	ka NATION		
Preser ——————————————————————————————————	ents (optional): vation Planner Signature: P 6: CATEGORICAL EXEMPTION DETERMINER BE COMPLETED BY PROJECT PLANNER Further environmental review required. Proposed p	ka NATION		
Preser ——————————————————————————————————	ents (optional): vation Planner Signature: Natalia Kwiatkows EP 6: CATEGORICAL EXEMPTION DETERMINGS ECOMPLETED BY PROJECT PLANNER	ka NATION		
Preser ——————————————————————————————————	ents (optional): Position Planner Signature: Natalia Kwiatkows EP 6: CATEGORICAL EXEMPTION DETERMING BE COMPLETED BY PROJECT PLANNER Further environmental review required. Proposed procedure (check all that apply): Step 2 - CEQA Impacts Step 5 - Advanced Historical Review	NATION project does		_
Preser ——————————————————————————————————	ents (optional): vation Planner Signature: Natalia Kwiatkows P 6: CATEGORICAL EXEMPTION DETERMING E COMPLETED BY PROJECT PLANNER Further environmental review required. Proposed processed (check all that apply): Step 2 - CEQA Impacts Step 5 - Advanced Historical Review STOP! Must file an Environmental Evaluation App	NATION project does	not meet scopes of work in either	
Preser ——————————————————————————————————	ents (optional): Position Planner Signature: Natalia Kwiatkows EP 6: CATEGORICAL EXEMPTION DETERMING BE COMPLETED BY PROJECT PLANNER Further environmental review required. Proposed procedure (check all that apply): Step 2 - CEQA Impacts Step 5 - Advanced Historical Review	NATION project does lication. project is cat	not meet scopes of work in either	
Preser ——————————————————————————————————	ents (optional): vation Planner Signature: Natalia Kwiatkows P 6: CATEGORICAL EXEMPTION DETERMING E COMPLETED BY PROJECT PLANNER Further environmental review required. Proposed processed for the complete of the complet	NATION project does lication. project is cat	not meet scopes of work in either regorically exempt under CEQA. sonable possibility of a significant Signature:	
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Preser ——————————————————————————————————	ents (optional): vation Planner Signature: Natalia Kwiatkows P 6: CATEGORICAL EXEMPTION DETERMING E COMPLETED BY PROJECT PLANNER Further environmental review required. Proposed processed for the complete of the complet	NATION project does lication. project is cate a sult in a real sted, oject.	not meet scopes of work in either tegorically exempt under CEQA. sonable possibility of a significant Signature: Natalia Kwiatkowska 05/18/2018	

STEP 7: MODIFICATION OF A CEQA EXEMPT PROJECT

TO BE COMPLETED BY PROJECT PLANNER

In accordance with Chapter 31 of the San Francisco Administrative Code, when a California Environmental Quality Act (CEQA) exempt project changes after the Approval Action and requires a subsequent approval, the Environmental Review Officer (or his or her designee) must determine whether the proposed change constitutes a substantial modification of that project. This checklist shall be used to determine whether the proposed changes to the approved project would constitute a "substantial modification" and, therefore, be subject to additional environmental review pursuant to CEQA.

PROPERTY INFORMATION/PROJECT DESCRIPTION

Project Address (If different than front page)			Block/Lot(s) (If different than front page)			
2342 -2344 3rd St.			4108/003A			
Case	No.	Previous Building Permit No.	New Building Permit No.			
2015-	007715PRJ	201503171039				
Plans	Dated	Previous Approval Action	New Approval Action			
		Building Permit				
	fied Project Description:	CONSTITUTES SUBSTANTIAL MODI	TICATION!			
		CONSTITUTES SUBSTANTIAL MODII	-ICATION			
Com	pared to the approved project, w	ould the modified project:				
	Result in expansion of the building envelope, as defined in the Planning Code;					
	Result in the change of use the Sections 311 or 312;	at would require public notice under Plann	ing Code			
	Result in demolition as defined	under Planning Code Section 317 or 190	005(f)?			
	Is any information being presented that was not known and could not have been known at the time of the original determination, that shows the originally approved project may no longer qualify for the exemption?					
If at I	east one of the above boxes is	checked, further environmental review	is required.			
DET	DETERMINATION OF NO SUBSTANTIAL MODIFICATION					
	The proposed modification would not result in any of the above changes.					
approv	If this box is checked, the proposed modifications are categorically exempt under CEQA, in accordance with prior project approval and no additional environmental review is required. This determination shall be posted on the Planning Department website and office and mailed to the applicant, City approving entities, and anyone requesting written notice.					
Plani	ner Name:	Signature or Stamp:				


Para sa impormasyon sa Tagalog tumawag sa: 415.575.9121

\dashv	1 2 3	4	5 6	7	8 9	PROJECT NAME
	DRAWING INDEX	ASSESS	OR'S MAP	S	COPE OF WORK	- 2342-2344 3 rd Street
_	A-0.1 COVER SHEET A-0.2 PHOTOS A-0.3 HISTORIC PHOTOS A-1.1 SITE PLANS A-1.2 DEMO CALCULATIONS A-1.3 DEMO CALCULATIONS A-1.4 ROUGH OPENNING CALCULATIONS A-1.5 ROUGH OPENNING CALCULATIONS A-2.1 FIRST FLOOR PLANS A-2.2 SECOND FLOOR PLANS A-2.3 THIRD FLOOR PLANS	TENNESSEE ST.	7250 500 1000 1000 1000 1000 1000 1000 10	BUILDING - EXTERIOR REHABILITATION V - REPLACEMENT OF WINDOWS - REPLACEMENT/UPGRADE OF - REINFORCEMENT OF REAR Y	S W/ HISTORICALLY COMPATIBLE WINDOWS STOREFRONT ENTRY DOOR	SAN FRANCISCO, CA
	A-3.1 FRONT ELEVATIONS (EAST) A-3.2 RIGHT ELEVATIONS (NORTH) A-3.3 REAR ELEVATIONS (WEST) A-3.4 LEFT ELEVATIONS (SOUTH) A-4.1 SECTIONS A-5.0 EXIT DIAGRAM & CALCULATIONS A-5.1 TYPICAL DETAILS A-5.2 TYPICAL DETAILS A-5.3 TYPICAL DETAILS A-5.3 TYPICAL DETAILS A-5.4 GENERAL NOTES/TYPICAL DETAILS A-5.5 FACADE ANALYSIS A-5.6 STOREFRONT SECTION A-6.0 EXPLORATORY DEMO DIAGRAM A-6.1 EXPLORATORY DEMO PICS (1) A-6.2 GENERAL BUILDING CHECKLIST	W W W W W W W W W W W W W W W W W W W	SUBJECT PARCEL	AND SERVICES		SIA CONSULTING CORPORATION 1256 HOWARD STREET SAN FRANCISCO CA 94103 TEL: (415) 741.1292 FAX: (415) 849.1252 WW.SIACONSULT.COM
	C-0.1 SURVEY	ADDD	TAMATION.			SHEET TITLE
			EVIATION	1	PROJECT DATA	
_		# POUND OR NUMBER & AND @ AT ABV ABOVE ACT ACOUSTIC CEILING TILE AD AREA DRAIN ADJ ADJACENT AFF ABOVE FINISHED FLOOR ALUM ALUMINUM APPROX APPROXIMATE ANOD ANODIZED ASPH ASPHALT AVG AVERAGE BD BOARD	GYP GYPSUM H.C. HANDICAPPED HI HIGH HM HOLLOW METAL HP HIGH POINT HR HOUR HVAC HEATING, VENTILATING, AND AIR CONDITIONING IRGWB IMPACT RESISTANT GYPSUM WALLBOARD ILO IN LIEU OF INSUL INSULATED INT INTERIOR	PLANNING DATA: ADDRESS: BLOCK / LOT: LOT AREA: ZONING: (E) # OF UNITS:	2342-2344 3RD STREET 4108 / 003A 2,395 S.F. UMU 18 GROUP HOUSING SRO UNITS W/ 1 GROUND FLOOR VACANT SPACE	Cover Sheet
		BD BOARD BLDG BUILDING BLKG BLOCKING BOT BOTTOM BSMT BASEMENT BST BOTTOM OF STAIRS BYND BEYOND CIP CAST IN PLACE CHNL CHANNEL CJ CONTROL JOINT CLG CEILING CLO CLOSET	LO LOW MAX MAXIMUM MECH MECHANICAL MEMBR MEMBRANE MIN MINIMUM MO MASONRY OPENING MTL METAL (N) NEW NIC NOT IN CONTRACT NO NUMBER NOM NOMINAL N.T.S. NOT TO SCALE	(N) # OF UNITS: ALLOWABLE HEIGHT: BUILDING HEIGHT:	18 GROUP HOUSING SRO UNITS W/ 1 GROUND FLOOR RETAIL SALE AND SERVICES 45-X 38'-9" ± (NO CHANGE)	
		CLR CLEAR CNTR COUNTER CMU CONCRETE MASONRY UNIT COL COLUMN COMPR COMPRESSIBLE CONC CONCRETE CONT CONTINUOUS CORR CORRIDOR CPT CARPET CT CERAMIC TILE CTR CENTER	N.1.S. NOTTO SCALE O.C. ON CENTER OFF OFFICE OH OPPOSITE HAND OZ OUNCE PCC PRE-CAST CONCRETE P.L. PROPERTY LINE PLUMB PLUMBING PLYD PLYWOOD PT PRESSURE TREATED PNT PAINT/PAINTED PVC POLYVINYL CHLORIDE	BUILDING DATA: NUMBER OF STORIES: CONSTRUCTION TYPE: OCCUPANCY GROUP: APPLICABLE CODES:	3 TYPE "V-B" R-2 / B 2013 CALIFORNIA CODES EDITIONS W/ SAN FRANCISCO AMENDMENTS	These documents are property of SIA CONSULTIN and are not to be produced changed or copied without the expressed written consent of SIA CONSULTING ENGINEERS. ISSUES / REVISIONS NO. DATE DESCRIPTION
		CTYD COURTYARD DBL DOUBLE DEMO DEMOLISH DET DETAIL D.F. DRINKING FOUNTAIN DIA DIAMETER DIMS DIMENSIONS DN DOWN DR DOOR DWG DRAWING (E) EXISTING EA EACH	RBR RUBBER RCP REFLECTED CEILING PLAN RD ROOF DRAIN RDWD REDWOOD REQD REQUIRED RM ROOM S.F. SQUARE FOOT SIM SIMILIAR SPEC SPECIFIED OR SPECIFICATION SPK SPRINKLER SSTL STAINLES STEEL STC SOUND TRANSMISSION	(E) GROSS FLOOR AREA: FIRST FLOOR: SECOND FLOOR: THIRD FLOOR: TOTAL GROSS AREA:	1,989 ± S.F. 1,850 ± S.F. (NO CHANGE) 1,850 ± S.F. (NO CHANGE) 5,689 ± S.F.	
		EL ELEVATION ELEC ELECTRICAL ELEV ELEVATOR/ELEVATION EQ EQUAL EXCL EXCLUDE EXP JT EXPANSION JOINT EXT EXTERIOR	COEFFICIENT STD STANDARD STL STEEL STRUCT STRUCTURAL SQ. SQUARE T&G TONGUE AND GROOVE TC TOP OF CURB	(N) GROSS FLOOR AREA: FIRST FLOOR: SECOND FLOOR:	1,813 ± S.F. 1,850 ± S.F. (NO CHANGE)	DRAWN A.A. CHECKED R.K.
		F.D. FLOOR DRAIN FEC FIRE EXTINGUISHER CABINET FIXT FIXTURE FLR FLOOR FLUOR FLUORESCENT FM FILLED METAL FND FOUNDATION FO FACE OF F.O.F. FACE OF FININSH FURR FURRING	TELE	THIRD FLOOR: TOTAL GROSS AREA:	1,850 ± S.F. (NO CHANGE) 5,513 ± S.F.	DATE 11/15/2015 REVISED DATE 05/01/2018 JOB NO. 15-1684
	Subject Building (Historical Photo) Subject Building (Historical Photo)	FURR FURRING GA GAUGE GALV GALVANIZED G.B. GRAB BAR GND GROUND GRP GROUP GWB GYPSUM WALL BOARD	U.N.O. UNLESS NOTED OTHERWISE U/S UNDERSIDE V.I.F. VERIFY IN FIELD VP VISION PANEL W/ WITH WD WOOD W.H. WATER HEATER		. 9	A-0.1

Subject Building (Viewed from 3rd Street)

East Elevation



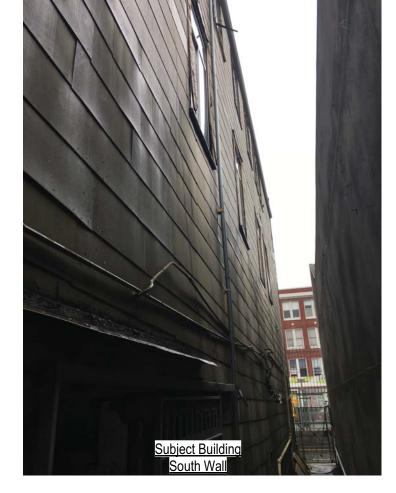

PROJECT NAME

2342-2344 3rd Street SAN FRANCISCO, CA



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SHEET TITLE

Photos





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ISSUES / REVISIONS

NO. DATE DESCRIPTION

DRAWN A.A.

CHECKED R.K.

DATE 11/15/2015

REVISED DATE 05/01/2018

15-1684 JOB NO.

SHEET NO.

A-0.2

PROJECT NAME

2342-2344 3rd Street SAN FRANCISCO, CA



Subject Building (Historical Photo)



Subject Building (Historical Photo)



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Historic Photos

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NO. DATE DESCRIPTION

DRAWN

CHECKED R.K.


DATE 11/15/2015

05/01/2018 REVISED DATE


15-1684 JOB NO.

SHEET NO.

A-0.3

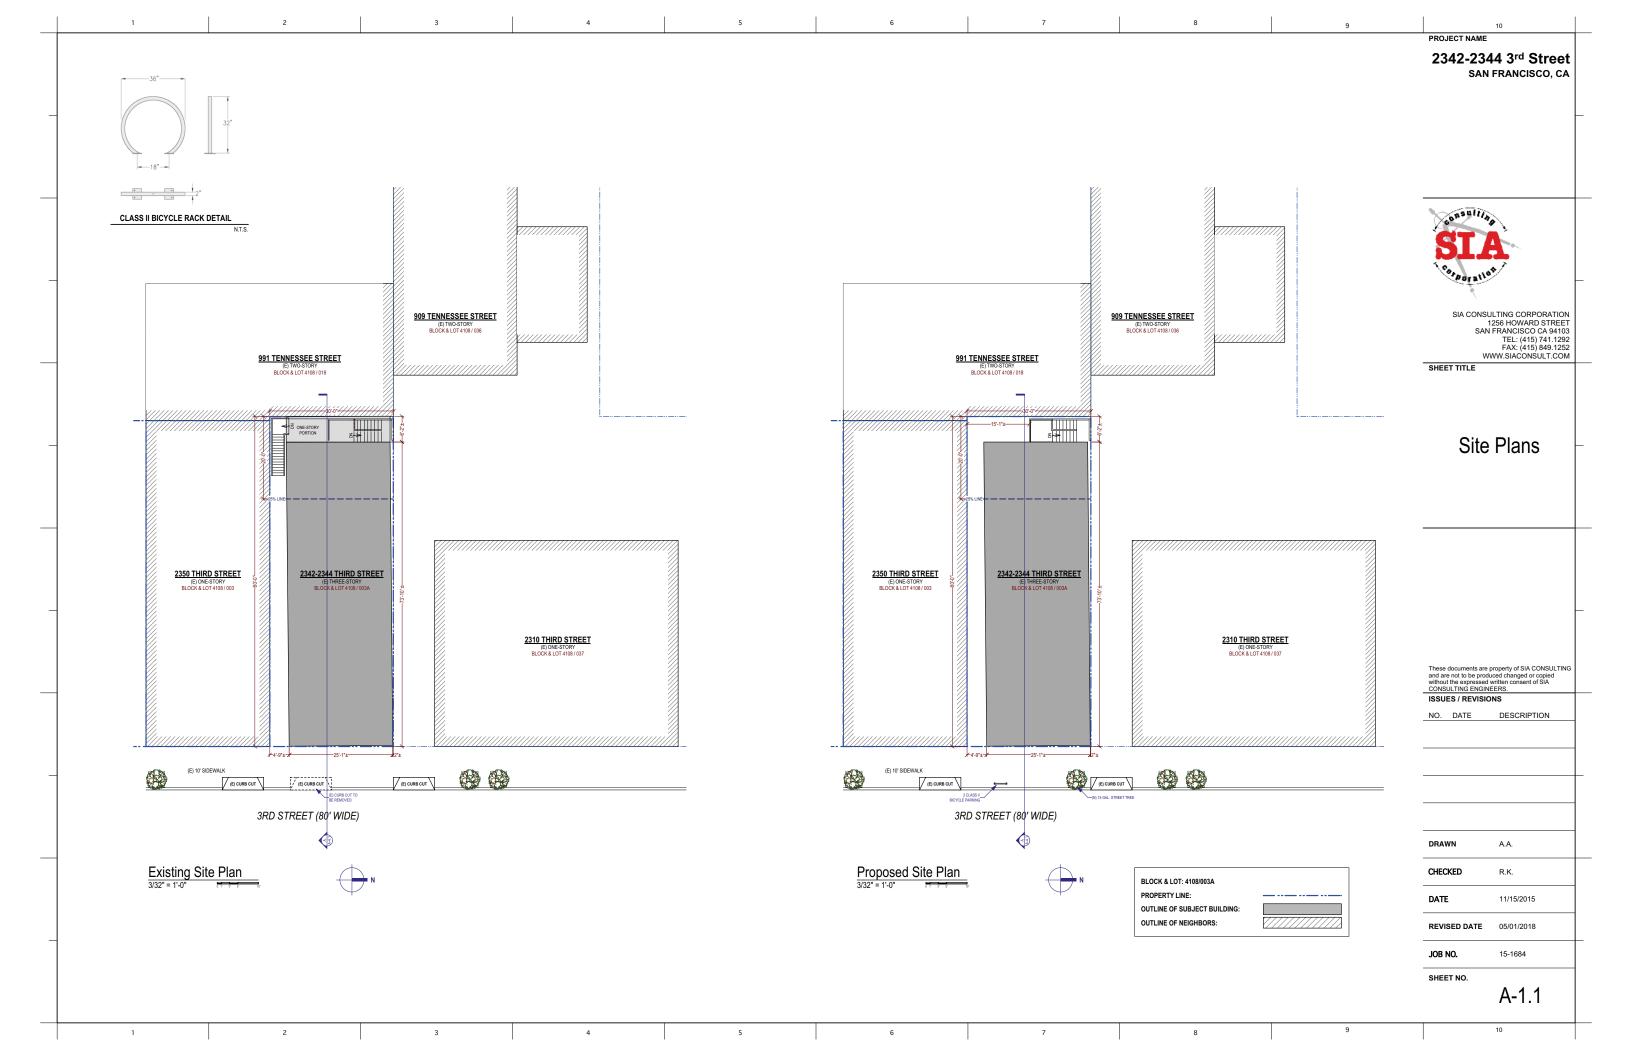



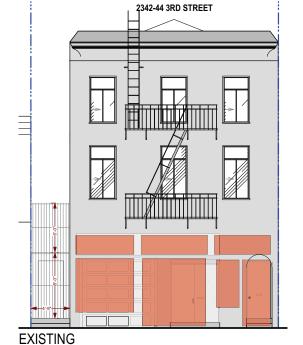

Front (East) Facade



2342-2344 3rd Street SAN FRANCISCO, CA

PROJECT NAME



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Demo Calculations

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NO.	DATE	DESCRIPTION

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CHECKED	R.K.
DATE	11/15/2015

REVISED DATE 05/01/2018

SHEET NO.

JOB NO.

A-1.2

15-1684

DEMOLITION CALCULATIONS TABL


Removal of Elements	Sec. 1005 Proposed Limits Project		Proposed Project Total	Meets Planning Code
Vertical Envelope Elements (s.f. of surface area) [by elevation: front, sides, back exterior walls]	50% or more [function as external walls] OR	10 %	10 %	YES
External walls (used for external or internal wall functions)	25% or more OR	8.9 %	8.9 %	YES
Horizontal Elements ⁵ [roof area, floor plates except at/below grade]	75% or more (combined internal	0.04 %	57.6 %	YES
Internal Structural Framework [interior partitions, etc.]	frame work or floor plates)	57.6 %		110

NOTE:
If removal & replacement of additional building elements considered beyond repair is required during construction, contact the Planning Department immediately for review & approval. This includes floor framing, sidewalls & other structural members not visible fromthe public right-of-way.

Removal of elements beyond percentages submitted above is considered a

If removal is beyond percentages outlined in Planning Code Sec. 1005, further environmental review by the Planning Department is required.


EXISTING SURFACE AREA TO BE REMOVED

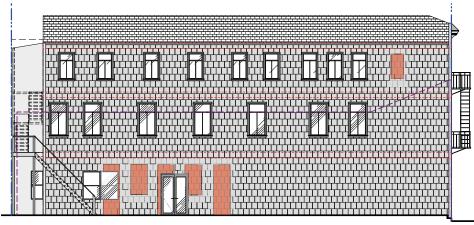

Existing Left (South) Facade



Proposed Left (South) Facade

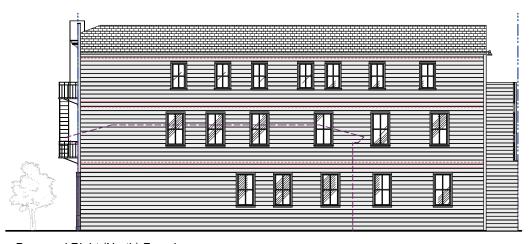

Proposed Right (North) Facade

NOTE: **DEMOLITION CALCULATIONS TABL** Sec. 1005 Proposed Proposed Project Total Planning Code Vertical Envelope Element 50% or more (s.f. of surface area) [function as 12 % YES 12 % by elevation: front ernal walls sides, back exterior walls] OR 25% or more External walls YES 9.1 % (used for external or OR 9.1 % internal wall functions) Horizontal Elements⁵ 75% or more 0.04 % [roof area, floor plates (combined internal except at/below grade] 57.6 % YES structural frame work Internal Structural work r floor plates) 57.6 % Framework [interior partitions, etc.] : EXISTING SURFACE AREA TO BE REMOVED EXISTING FLOOR AREA TO BE REPAIRED : EXISTING EXTERIOR WALL TO BE REMOVED : EXISTING INTERIOR WALL TO BE REMOVED

/ (E) CURB CUT

EXISTING

1st Floor Plan

If removal & replacement of additional building elements considered beyond repair is required during construction, contact the Planning Department immediately for review & approval. This includes floor framing, sidewalls & other structural members not visible fromthe public right-of-way. Removal of elements beyond percentages submitted above is considered a violation.

ff removal is beyond percentages outlined in Planning Code Sec. 1005, further environmental review by the Planning Department is required.

Unit 101 Net Area: 172 sq ft

> Unit 100 Net Area: 590 sq ft

> > W-12

EXISTING

2nd Floor Plan

W-09

PROPOSED

PROJECT NAME

2342-2344 3rd Street SAN FRANCISCO, CA



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SHEET TITLE

Unit 307 Net Area: 107 sq ft

Unit 308 Net Area: 121 sq ft

Demo Calculations

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ISSUES / REVISIONS

NO. DATE DESCRIPTION

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JOB NO. 15-1684

SHEET NO.

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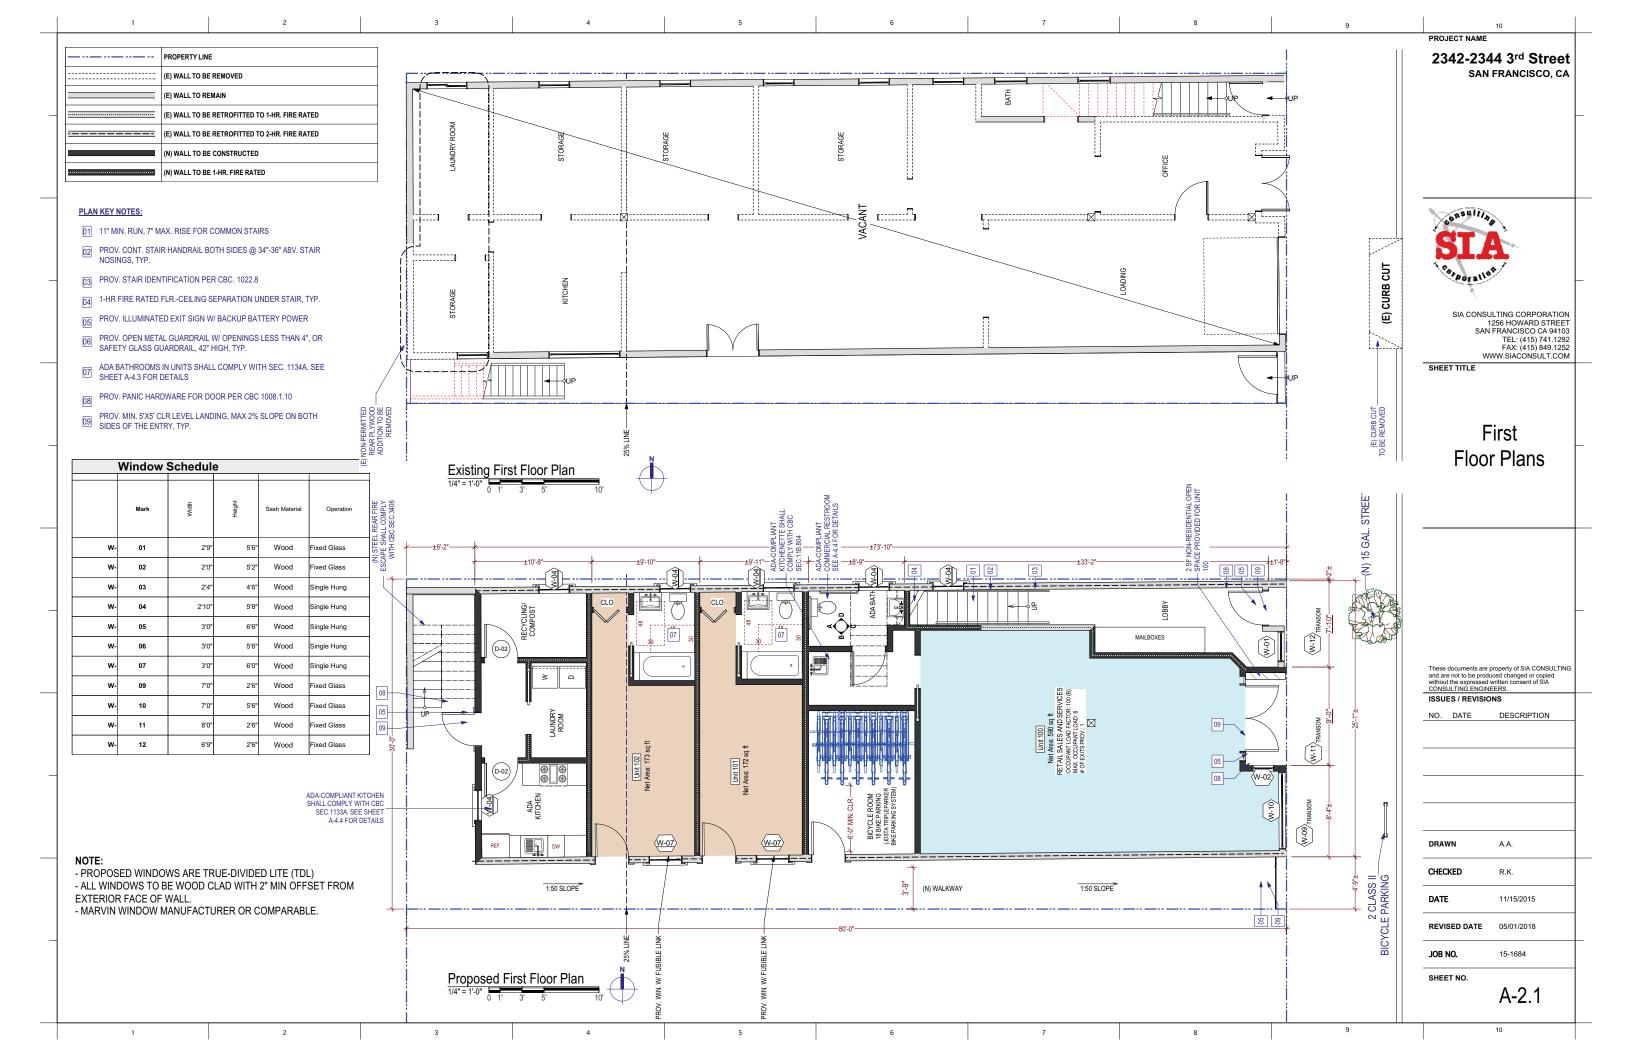
PROPOSED

EXISTING
3rd Floor Plan
18° = 1'-0'

Unit 207 Net Area: 107 sq ft
























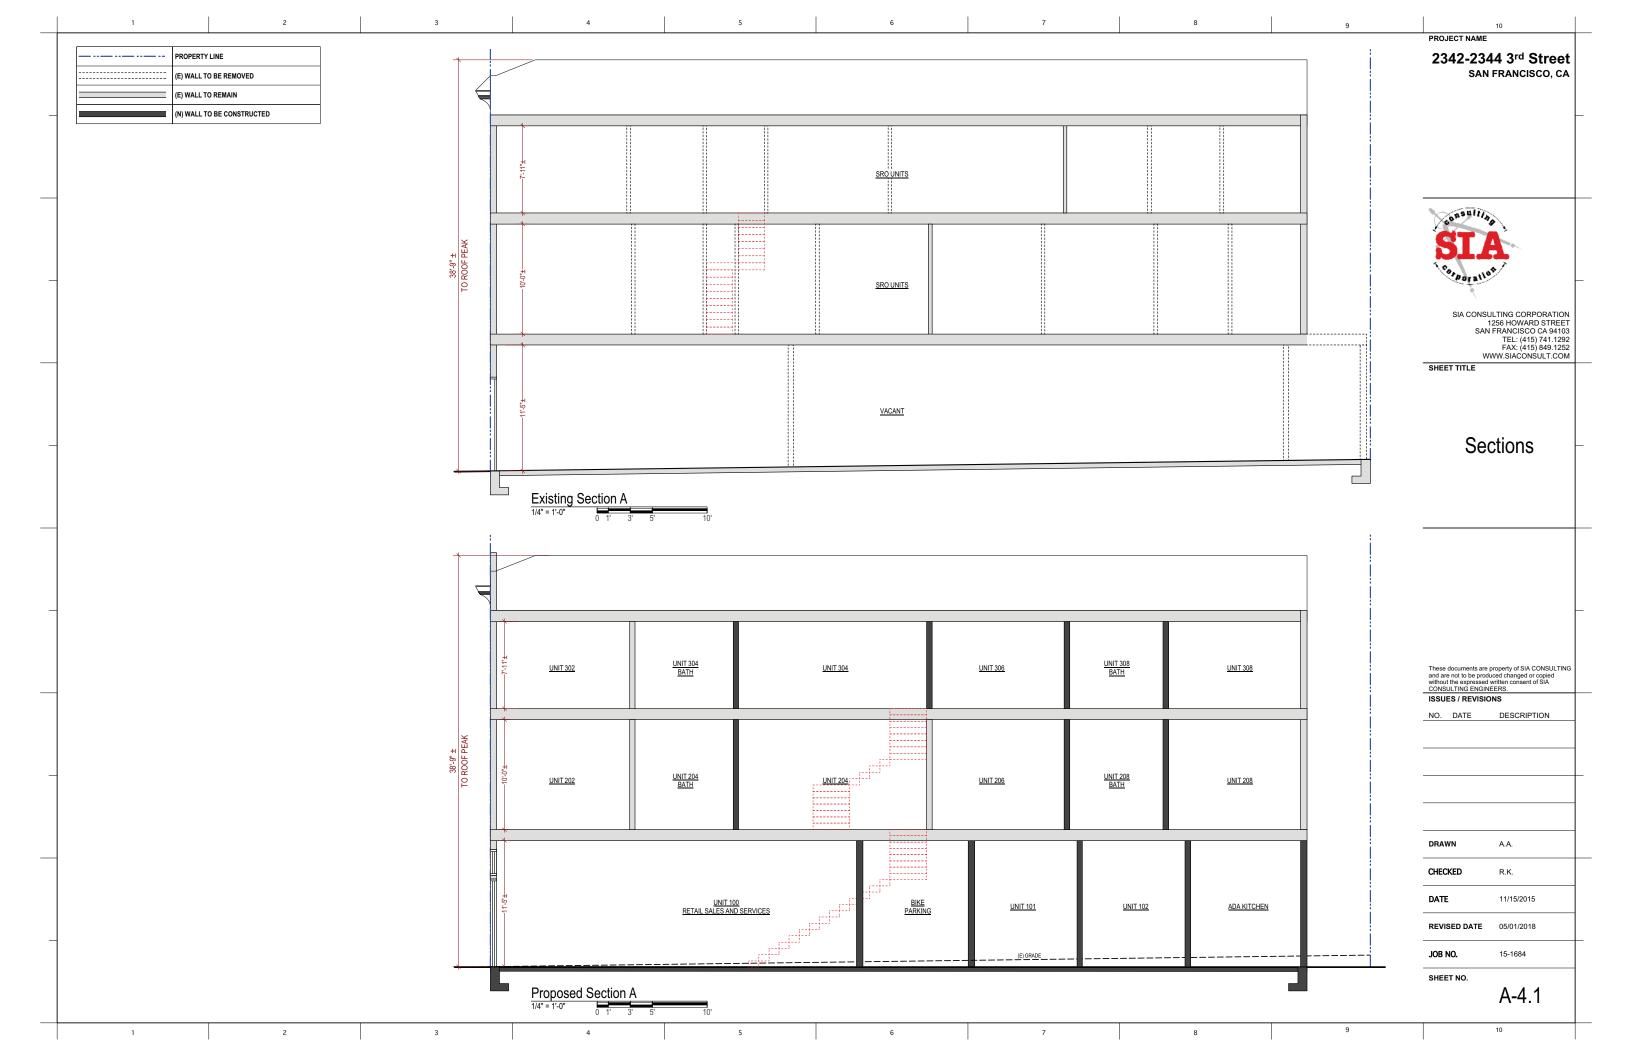

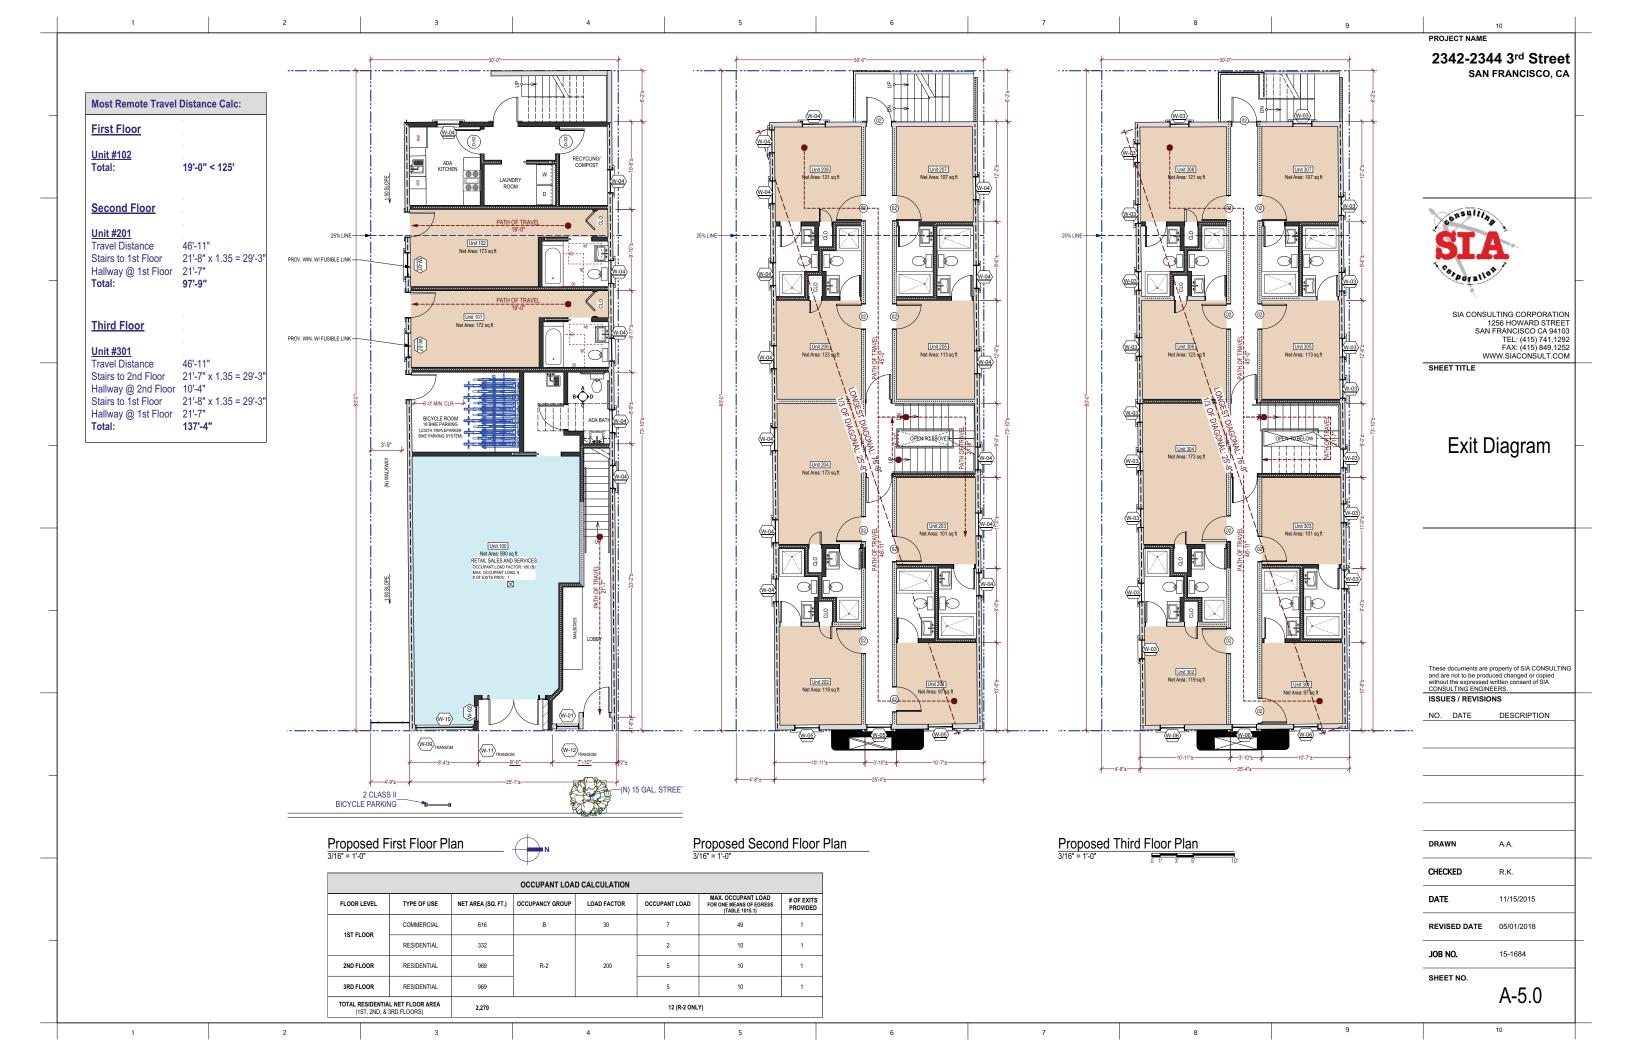

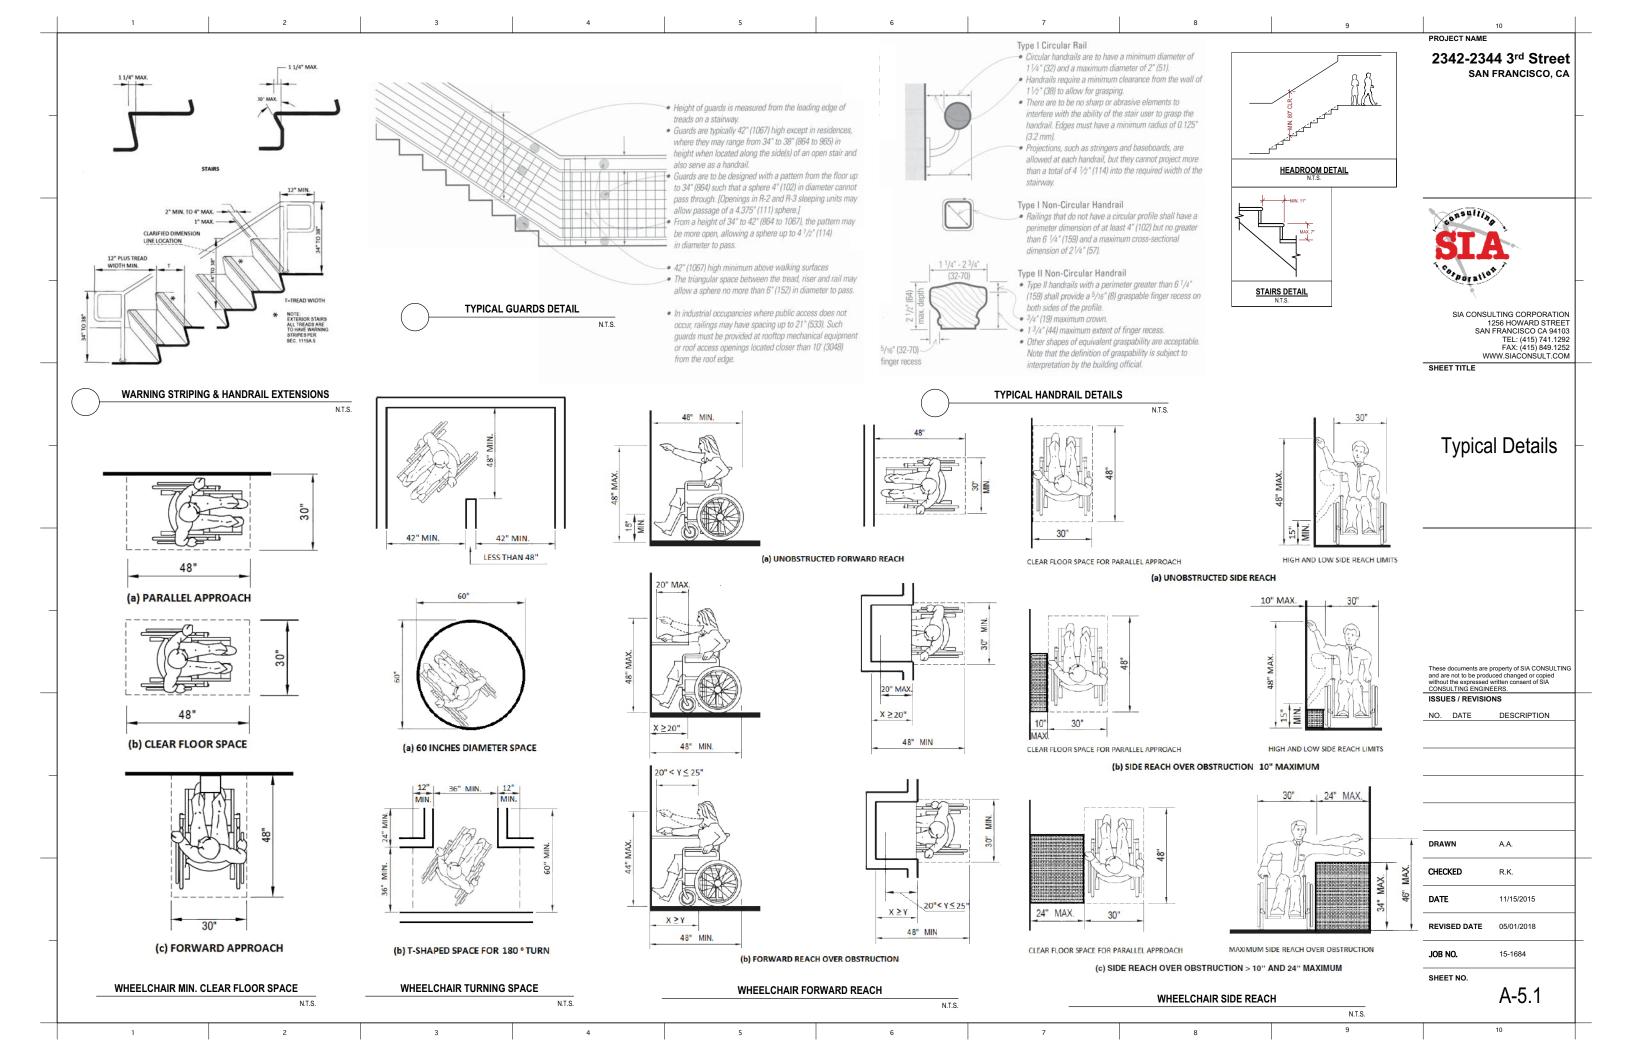

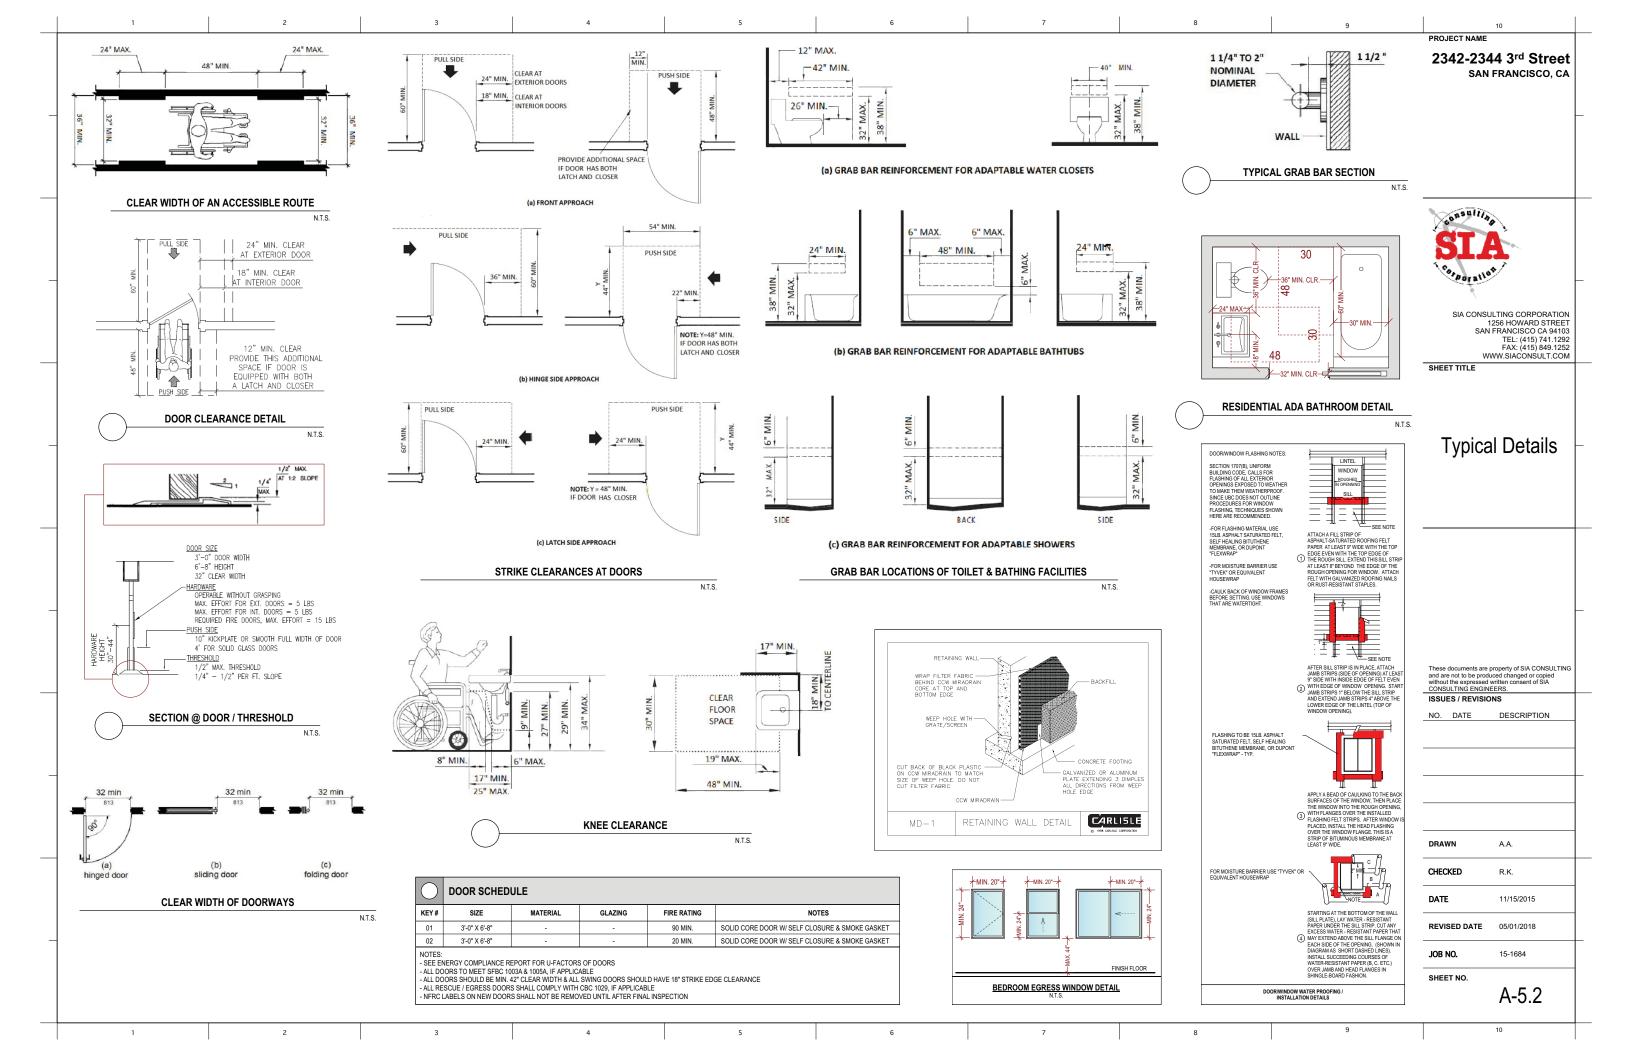

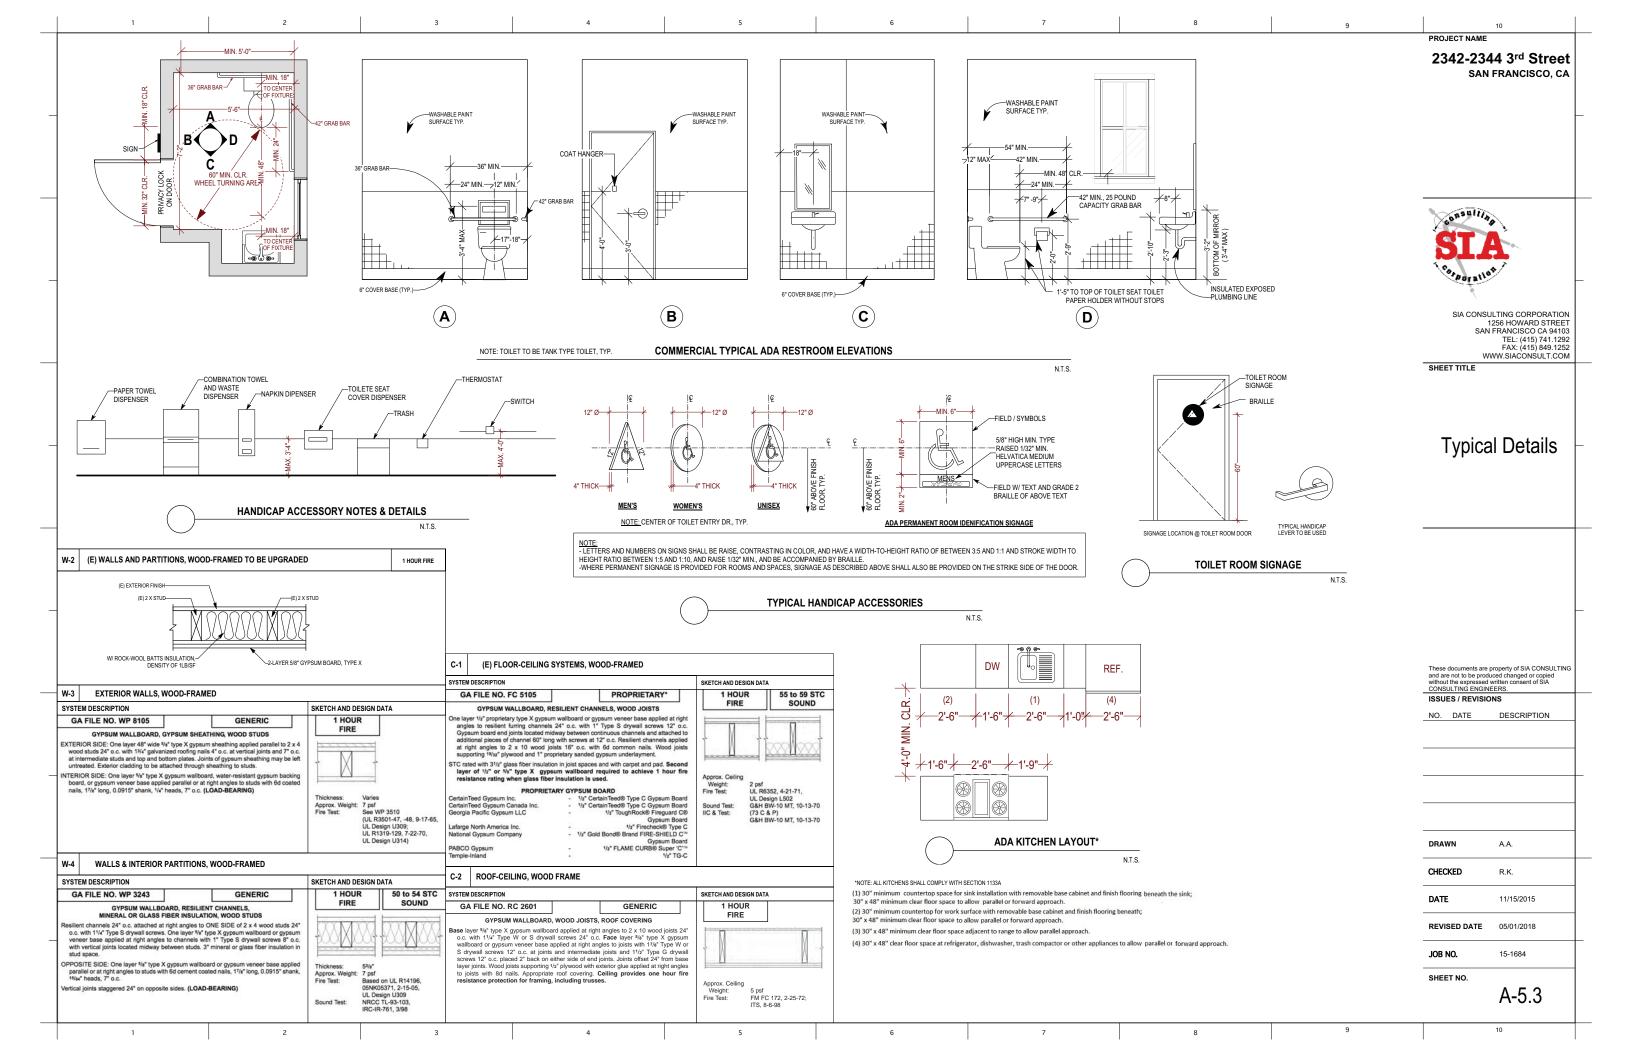

2342-2344 3rd Street SAN FRANCISCO, CA



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SHEET TITLE

Facade Renderings

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ISSUES / REVISIONS

DESCRIPTION

NO. DATE

A.A. DRAWN CHECKED R.K. DATE 11/15/2015

REVISED DATE 05/01/2018

15-1684 JOB NO.

SHEET NO.

A-5.4

Facade Perspective 2

Facade Perspective 1

Outdoor Wall Lamp Cut Sheet

DOOR / WINDOW NOTES:

- 1. ALL ESCAPE OR RESCUE DOORS & WINDOWS FROM SLEEPING ROOMS SHALL COMPLY WITH SEC. 1029
 - NET CLEAR HEIGHT: 24" MIN
 - NET CLEAR WIDTH: 20" MIN
 - NET OPENING: 5.7 SQ. FT. MIN.
- FINISHED SILL HEIGHT: 44" MAX. ABOVE THE FINISHED FLOOR
- 2. VERIFY IN FIELD FOR EXACT DOORS & WINDOWS ROUGH OPENING SIZE PRIOR TO PURCHASE & INSTALLATION
- 3. U-FACTOR OF GLAZING SHALL BE 0.55, UNLESS SPECIFIED ON PLANS OR ENERGY COMPLIANCE REPORT
- 4. NFRC LABELS ON NEW DOOR / WINDOWS SHALL NOT BE REMOVED UNTIL AFTER FINAL
- INSPECTION 5. COORDINATE INSTALLATION OF ALL FLASHINGS AND WINDOWS WITH INSTALLATION
- INSTRUCTIONS OF WINDOW MANUFACTURER. OBTAIN APPROVAL OF INSTALLATION METHODOLOGY FROM WINDOW MANUFACTURER PRIOR TO COMMENCING INSTALLATION. 6. UTILIZE PRIMERS AND / OR ADHESIVES COMPATIBLE WITH ALL MATERIALS AND AS RECOMMENDED BY MANUFACTURER OF SELF-ADHERED MEMBRANE TO ACHIEVE TENACIOUS BOND OF MEMBRANE TO ALL SUBSTRATES.
- 7. UTILIZE SEALANTS COMPATIBLE WITH ALL MATERIALS AND AS RECOMMENDED BY
- WINDOW AND SELF-ADHERED MEMBRANE MANUFACTURERS. 8. THE WIDTH OF THE LEVEL AREA ON THE SIDE TO WHICH THE DOOR SWINGS SHALL EXTEND 24 INCHES PAST THE STRIKE EDGE OF THE DOOR FOR EXTERIOR DOORS AND 18 INCHES PAST THE STRIKE EDGE FOR INTERIOR DOORS.
- 10. ALL ENTRANCES AND EXTERIOR GROUND-FLOOR EXIT DOORS TO BUILDINGS AND FACILITIES SHALL BE MADE ACCESSIBLE TO PERSONS WITH DISABILITIES. DOORWAYS SHALL HAVE A MINIMUM CLEAR OPENING OF 32 INCHES (813 MM) WITH THE DOOR OPEN 90 DEGREES, MEASURED BETWEEN THE FACE OF THE DOOR AND THE OPPOSITE STOP
- 11. THE BOTTOM 10 INCHES (254 MM) OF ALL DOORS EXCEPT AUTOMATIC AND SLIDING SHALL HAVE A SMOOTH, UNINTERRUPTED SURFACE TO ALLOW THE DOOR TO BE OPENED BY A WHEELCHAIR FOOTREST WITHOUT CREATING A TRAP OR HAZARDOUS CONDITION. WHERE NARROW FRAME DOORS ARE USED, A 10-INCH (254 MM) HEIGHT SMOOTH PANEL SHALL BE INSTALLED ON THE PUSH SIDE OF THE DOOR, WHICH WILL ALLOW THE DOOR TO BE OPENED BY A WHEELCHAIR FOOTREST WITHOUT CREATING A TRAP OR HAZARDOUS
- SHALL NOT BE MORE THAN 1/2-INCH (12.7 MM) LOWER THAN THE THRESHOLD OF THE DOORWAY. CHANGES IN LEVEL BETWEEN 1/4 AND 1/2 INCH SHALL BE LEVELED WITH A SLOPE NO GRATER THAN 1 UNIT VERTICAL IN 2 UNITS HORIZONTAL.
- 13. ALL EXIT DOORS SHALL BE OPENABLE FROM THE INSIDE WITHOUT THE USE OF A KEY OR ANY SPECIAL KNOWLEDGE OR EFFORT.
- 14. MOUNT LEVER HARDWARE AT +34" A.F.I
- 15. MAXIMUM PUSH / PULL FORCE FOR DOORS:
 - 8.5# FOR EXTERIOR DOORS 5# FOR INTERIOR DOORS

 - 15# FOR FIRE DOORS

KITCHEN NOTES:

MIN. TWO 20A SMALL APPLIANCE BRANCH CIRCUITS ARE REQUIRED FOR THE KICHEN & ARE STALL. (CEC 406.9 (C)) LIMITED TO SUPPLYING WALL & COUNTER SPACE RECEP, OUTLIETS FOR THE KITCHEN. PANTRY, BREAKFAST ROOM, DINING ROOM, & SIMILAR AREAS. THESE CIRCUITS CANNOT
SERVE OUTSIDE PLUGS, RANGE HOOD, DISPOSALS, DISHWASHERS OR MICROWAVES, ONLY
(CEC 240.24(D) & 240.25(E)) THE REQUIRED COUNTERTOP/WALL OUTLEST INCLUDING THE REFRIGERATOR

50% OR MORE OF THE KITCHEN LIGHTING WATTAGE MUST BE FLUORESCENT INCANDESCENT LIGHTING MUST BE SWITCHED SEPARATELY

PROVIDE AT LEAST ONE RECEPTACLE OUTLIET FOR EACH COUNTER SPACE 12" OR WIDER KITCHEN COUNTER OUTLETS SHALL BE SPACED SO THAT NO POINT ALONG THE WALL IS GREATER THAN 24" FROM AN OUTLET. AT LEAST ONE GFCI RECEPTACLE FOR THE PENINSULA COUNTER SPACE (CEC 210.52 (C) (3) & 210.8 (A) (6)

UPPER CABINETS SHALL BE A MIN. OF 30" ABOVE COOKING TOP PER CMC 916.1.2. PROV COOKING APPLIANCES MIN. CLEARANCES TO COMBUSTIBLE MATERIALS PER CMC 916.1.1.

ENERGY NOTES:

ALL INSTALLED HIGH EFFICACY LUMINARIES SHALL BE SWITCHED SEPARATELY FROM LOW

INSTALLED LIGHTING IN KITCHENS SHALL BE HIGH FEFICACY LUMINARIES, LIP TO 50% OF THE WATTAGE OF PERMANENTLY INSTALLED LIGHTING IN KITCHENS MAY BE IN LIGHTS THAT ARE NOT HIGH EFFICACY. (150(K)(3))

A MIN. OF ONE INSTALLED LIGHTING IN BATHROOMS SHALL BE HIGH EFFICACY LUMINARIE. ALL OTHER INSTALLED LIGHTING SHALL BE HIGH EFFICACY OR CONTROLLED BY A VACACNCY SENSOR(S). (150(K)(5))

INSTALLED LUMINARIES IN GARAGES, LAUNDRY ROOMS & UTILITY ROOMS SHALL BE HIGH EFFICACY LUMINARIES AND CONTROLLED BY A VACANCY SENSOR(S). (150(K)(6))

INSTALLED LUMINARIES IN ROOMS OTHER THAN KITCHENS, BATHROOMS, GARAGES LAUNDRY ROOMS & UTILITY ROOMS SHALL BE HIGH EFFICACY LUMINARIES OR ARE CONTROLLED BY DIMMERS OR A VACANCY SENSOR(S), (150(K)(7))

LIGHTING FIXTURES RECESSED INTO INSULATED CEILINGS MUST BE APPROVED FOR ZERO-CLEARANCE INSULATION COVER (I.C.) BY UNDERWRITERS LABORATORIES OR OTHER

FIREPLACES, DECORATIVE GAS APPLIANCES AND GAS LOGS: INSTALLATION OF FACTORY-BUILT AND MASONRY FIREPLACES SHALL INCLUDE:

- A. CLOSABLE METAL OR GLASS DOORS. B. COMBUSTION AIR INTAKE (6 SQ. IN. MINIMUM) TO DRAW AIR FROM OUTSIDE OF THE BUILDING DIRECTLY INTO FIRE BOX. THE COMBUSTION AIR INTAKE MUST BE
- EQUIPPED WITH A READILY ACCESSIBLE, OPERABLE AND LIGHT-FITTING DAMPER OR COMBUSTION AIR CONTROL DEVICE. *EXCEPTION: AN OUTSIDE COMBUSTION AIR INTAKE IS NOT REQUIRED IF THE
- FIREPLACE IS INSTALLED OVER CONCRETE SLAB FLOORING AND THE FIREPLACE IS NOT LOCATED ON AN EXTERIOR WALL.
- C. A FLUE DAMPER WITH AN READILY ACCESSIBLE CONTROL *EXCEPTION: WHEN A GAS LOG, LOG LIGHTER, OR DECORATIVE GAS APPLIANCE IS INSTALLED IN A FIREPLACE, THE FLUE DAMPER SHALL BE BLOCKED OPEN IF REQUIRED BY THE MANUFACTURER'S INSTALLATION INSTRUCTIONS OR THE STATE

ELECTRICAL NOTES:

THE INSTALLATION OF SMOKE ALARMS IN ALL OF THE FOLLOWING AREAS SHALL BE

PROVIDED: (CRC R314.3) A. ON THE CEILING OR WALL OUTSIDE OF EACH SEPARATE SLEEPING AREA IN THE IMMEDIATE VICINITY OF BEDROOMS.

B. IN EACH ROOM USED FOR SLEEPING PURPOSES.

THE INSTALLATION OF CARBON MONOXIDE ALARMS IN THE FOLLOWING AREAS SHALL BE PROVIDED: (CRC R315.1)

A. APPROVED CARBON MONOXIDE ALARMS SHALL BE INSTALLED OUTSIDE OF EACH

SEPARATE SLEEPING AREA IN THE IMMEDIATE VICINITY OF THE BEDROOMS & ON EVERY LEVEL INCLUDING BASEMENTS IN DWELLING
UNITS THAT HAVE FUEL-FIRED APPLIANCES OR ATTACHED GARAGES

A MIN. OF TWO 20 AMP SMALL APPLIANCE BRANCH CIRCUITS SHALL BE PROVIDED FOR ALL RECEPTACLE OUTLETS IN THE KITCHEN, DINING ROOM, PANTRY, OR OTHER SIMILAR AREAS.

AT LEAST ONE 20 AMP BRANCH CIRCUIT SHALL BE PROVIDED TO SUPPLY BATHROOM RECEPTACLE OUTLETS. SUCH CIRCUITS SHALL HAVE NO OTHER OUTLETS. (CEC

IN EVERY DWELLING UNIT, FIXED APPLIANCES SUCH AS FOOD WASTE GRINDERS. DISHWASHERS, WASHING MACHINES, DRYERS, LAUNDRY TRAY LOCATIONS, BUILT-IN REFRIGERATORS OR FREEZERS, FURNACES, AC UNITS, BUILT-IN HEATERS OR ANY OTHER FIXED APPLIANCE WITH A MOTOR OF 1/4 H.P. OR LARGER SHALL BE ON A SEPARATE 20 AMP

BRANCH CIRCUIT.
ALL RECEPTACLES IN BATHROOMS, GARAGES, ACCESSORY BUILDINGS, OUTDOORS, CRAWL
SPACES, UNFINISHED BASEMENTS, KITCHENS (WHERE RECEPTACLES SERVE COUNTER TOP
SURFACES), LAUNDRY, UTILITY, WET BAR SINKS (WITHIN 6 FEET OF THE EDGE OF THE SINK), SHALL HAVE GROUND-FAULT CIRCUIT INTERRUPTER (GFCI) PROTECTION. (CEC 210.8(A))

IN ALL AREAS SPECIFIED IN 210.52, ALL NON-LOCKING TYPE 125-VOLT, 15- AND 20- AMP RECEPTACLES SHALL BE LISTED TAMPER-RESISTANT RECEPTACLES. (CEC 406.12)

ALL RECEPTACLE OUTLETS IN BATHROOMS, ABOVE KITCHEN COUNTERTOP, CRAWL SPACES, GARAGE, ROOFTOPS, OUTDOOR OUTLETS, WITHIN 6' OF WETBAR SINK/LAUNDRY SINK TO BE PROTECTED BY GROUND FAULT CIRCUIT INTERRUPTER (GFCI), (CEC 210.8)

ALL RECEPTACLE OUTLETS ARE REQUIRED TO BE LISTED TAMPER RESISTANT. (CEC 406.12 &

COMBINATION TYPE AFCI CIRCUIT BREAKERS ARE REQUIRED FOR ALL 120 VOLT SINGLE 12. THERE SHALL BE A FLOOR LANDING ON EACH SIDE OF A DOOR. THE FLOOR OR LANDING PHASE 15/20 AMP BRANCH CIRCUITS. EXCEPT FOR BATHROOMS, KITCHENS, GARAGES, OUTDOORS, AND LAUNDRY ROOMS. (CEC 210.12(B))

AT A MIN, ONE DEDICATED 20 AMP CIRCUIT IS REQUIRED FOR A BATHROOM.(CEC

A GECL PROTECTED OUTLIETS AT THE FOLLOWING LOCATIONS: GARAGE LINEINISHED BASEMENT, CRAWL AND STORAGE SPACES, WITHIN 6' OF SINK OR BASIN, EXTERIOR

ARC FAULT CIRCUIT INTERRUPTER ("AFCI") PROTECTION FOR ALL RECEPTACLES, LIGHTING CIRCUITS, SWITCHES, AND HARD-WIRED SMOKE DETECTORS INSTALL IN FAMILY ROOMS, DINING ROOMS, LIVING ROOMS, PARLORS, LIBRARIES, DENS, BEDROOMS, SUNROOMS, RECREATIONS ROOMS, CLOSETS, HALLWAYS, OR SIMILAR ROOMS OR AREAS PER CEC 210.12(B). THE "AFCI" SHALL BE LISTED TO PROTECT THE ENTIRE BRANCH CIRCUI

ECEPTACLE OUTLETS ARE NOT ALLOWED WITHIN OR OVER A BATHTUB OR SHOWER

SUBPANELS ARE NOT ALLOWED TO BE LOCATED IN BATHROOMS OR CLOTHES CLOSETS. CIRCUITS SHARING A GROUNDED CONDUCTOR (NEUTRAL) WITH TWO UNGROUNDED(HOT)

CONDUCTORS MUST USE A TWO POLE CIRCUIT BREAKER OR AN IDENTIFIED HANDLE TIE.(CEC 210.4(B)) GROUP NON-CABLE CIRCUITS IN PANEL (CEC 210.4(D)) THE RECEPTACLE OUTLIETS THAT SERVE KITCHEN COUNTER TOPS. DINING ROOM BREAKFAST AREA, & PANTRY, MUST HAVE A MIN OF 2 DEDICATED 20 AMP CIRCUITS.(CEC

KITCHEN COUNTER TOPS 12 INCHES OR WIDER MUST HAVE A RECEPTACLE OUTLET. (CEC

KITCHEN COUNTER TOPS MUST HAVE RECEPTACLE OUTLETS SO NO POINT ALONG THE COUNTER WALLS IS MORE THAN 24 INCHES FROM A RECEPTACLE. (CEC 210.52 (C))

ISLAND AND PENINSULAR COUNTER TOPS MUST HAVE AT LEAST ONE RECEPTACLE. (CEC

THE SPACING FOR GENERAL RECEPTACLE OUTLETS MUST BE LOCATED SO THAT NO POINT ON ANY WALL, FIXED GLASS, OR CABINETS IS OVER 6 FEET FROM A RECEPTACLE OUTLET

HALLWAYS 10 FEET OR MORE MUST HAVE AT LEAST ONE RECEPTACLE OUTLET.

LAUNDRY ROOMS MUST HAVE AT LEAST ONE DEDICATED 20 AMP RECEPTACLE CIRCUIT (CEC 210.11(2)) PROVIDE 120V RECEPTACLE WITHIN 3 FEET OF WATER HEATER. CAL ENERGY CODE 150.0 (N)

PROVIDE GROUNDING ELECTRODE SHALL BE NONFERROUS (COPPER), NOT BE LESS THAN PROVIDE GROUNDING ELECTRODE SHALL BE INVIPERROUS (COPPER), NOT BE LESS TRIED IN THE FIRST BY IN DIAMETER. THE ELECTRODE SHALL BE INSTALLED SUCH THAT AT LEAST 8' OF LENGTH IS IN CONTRACT WITH THE SOIL. THE UPPER END OF THE ELECTRODE SHALL BE FLUSH WITH OR BELOW GROUND LEVEL UNLESS THE ABOVE-GROUND END AND THE GROUNDING ELECTRODE CONDUCTOR ATTACHMENT IS PROTECTED AGAINST PHYSICAL DAMAGE. ICEC

NOTES:

BATHROOMS AND TOILET COMPARTMENTS MAY HAVE A CEILING HEIGHT OF NOT LESS THAN 7'-0". (CBC 1208.02)

ALL INTERIOR SPACES INTENDED FOR HUMAN OCCUPANCY SHALL BE PROVIDED WITH SPACE HEATING (CBC 1204.1)

SMOKE DETECTORS SHALL BE IN ALL BEDROOMS AND AREAS LEADING TO THEM.

CARBON MONOXIDE ALARM IN EACH OCCUPIED LEVEL.

PLUMBING AND MECHANICAL NOTES:

WATER CLOSETS SHALL HAVE AN AVERAGE WATER CONSUMPTION OF NOT MORE THAN 1.28 GALLONS PER FLUSH. (CPC

SHOWER HEADS SHALL HAVE A WATER FLOW NOT TO EXCEED 2.0 GALLONS PER MINUTE @ 80 PSI. (CPC 408.2)

FAUCETS IN KITCHENS, WET BARS, LAUNDRY SINKS, ETC SHALL HAVE A WATER FLOW NOT TO EXCEED 1.8 GALLONS PER MINUTE @ 60 PSI. (CPC 403.6)

FAUCETS IN LAVATORIES SHALL HAVE A WATER FLOW NOT TO EXCEED 1.5 GALLONS PER MINUTE @ 60 PSI. (CPC 403.6)

SHOWER STALLS SHALL HAVE A CLEAR INTERIOR FINISH AREA OF 7.1 SQ. FT. AND BE ABLE TO ACCOMMODATE A MINIMUM 30 INCH CIRCLE AT THE THRESHOLD LEVEL. THESE CLEARANCES SHALL BE MAINTAINED UP TO A HEIGHT OF 70 INCHES ABOVE SHOWER DRAIN

SHOWER COMPARTMENTS AND WALLS ABOVE BATHTUBS WITH INSTALLED SHOWER HEADS SHALL BE FINISHED WITH A SMOOTH, NONABSORBENT SURFACE TO A HEIGHT NOT LESS THAN 72 INCHES (6 FT), (CRC R307.2)

THE MAXIMUM HOT WATER TEMPERATURE DISCHARGING FROM THE BATHTUR. SHOWER AND WHIRLPOOL BATHTUB FILLER SHALL BE LIMITED TO 120 DEGREES FAHRENHEIT. THE WATER HEATER THERMOSTAT SHALL NOT BE CONSIDERED A CONTROL FOR MEETING THIS PROVISION. (CPC 409.4 & 408.3)

A 30-INCH CLEAR WIDTH FOR WATER CLOSET COMPARTMENT AND 24 INCH CLEARANCE IN

ROOMS CONTAINING BATHTUBS, SHOWERS, SPAS AND SIMILAR FIXTURES SHALL BE PROVIDED WITH AN EXHAUST FAN WITH A MINIMUM CAPACITY OF 50 CFM DUCTED TO TERMINATE OUTSIDE THE BUILDING. (CRC R303.3, CG 4.506.1, CBC 1203.4.3.2.1, CMC 403.7)

THE CLOTHES DRYER VENT SHALL NOT EXCEED 14 FT IN OVERALL LENGTH WITH MAXIMUM TWO 90 DEGREE ELBOWS. (CMC 504.3.1)

CLOTHES DRYER EXHAUST SHALL BE A MIN. 4 INCHES, TERMINATE TO THE OUTSIDE OF THE BUILDING, SHALL BE EQUIPPED WITH A BACK-DRAFT DAMPER, AND MEET THE REQUIREMENTS OF CMC 504.3. PROV. 100 SQ. IN. MIN. MAKE-UP AIR OPENING FOR

ENVIRONMENTAL AIR DUCTS EXHAUST SHALL TERMINATE MIN. 3 FEET FROM PROPERTY LINE OR OPENINGS INTO BUILDING. (CMC 504.5)

MECHANICAL EQUIPMENT SHALL BE INSTALLED PER THE MANUFACTURE'S INSTALLATION

DOMESTIC RANGE VENTS TO BE SMOOTH METALLIC INTERIOR SURFACE. (CMC 504.2)

SUPPLY AND RETURN AIR DUCTS TO BE INSULATED AT A MIN OF R-6. CAL ENERGY CODE

VENTING SYSTEMS SHALL TERMINATE NOT LESS THAN 4 FEET BELOW OR 4 FEET HORIZONTALLY FROM, & NOT LESS THAN ONE FOOT ABOVE A DOOR, AN OPENABLE WINDOW OR A GRAVITY AIR INLET INTO A BUILDING. VENTING SYSTEMS SHALL TERMINATE AT LEAST 3 FEET AROVE AN OUTSIDE - OR MAKE UP - AIR INLET LOCATED WITHIN 10 FEET & AT LEAST 4

GAS VENT TERMINATIONS SHALL MEET THE REQUIREMENTS OF CMC 802 6 & SEMC 802 6 2

COMBUSTION AIR SHALL MEET THE REQUIREMENTS OF CMC CH7

SAFETY GLAZING SHALL BE PROVIDED AT THE FOLLOWING HAZARDOUS LOCATIONS: (CRC R308 4 CBC 2406 4)

A. SWINGING, BI-FOLD, AND SLIDING DOORS
B. WHEN LOCATED WITHIN 60 INCHES ABOVE THE FLOOR OF WET SURFACES SUCH AS

- TURS SHOWERS SALINAS STEAM ROOMS OR OUTDOOR SWIMMING POOL C. WITHIN A 24 INCH ARC OF EITHER VERTICAL EDGE OF DOORS AND WITHIN 60 INCHES
- OF WALKING SURFACE D. WHERE GLAZING AREA IS MORE THAN 9 SOLET. IN AREA, WITH THE BOTTOM EDGE LESS THAN 18 INCHES ABOVE THE FLOOR, TOP EDGE MORE THAN 36 INCHES ABOVE FLOOR, AND WITHIN 36 INCHES OF A WALKING SURFACE, MEASURED HORIZONTALLY

WATER HEATERS PROTECTION FROM FIRE DAMAGE: WATER HEATERS GENERATING A GLOW, SPARK OR FLAME CAPABLE OF IGNITING FLAMMABLE VAPORS MAY BE INSTALLED IN A GARAGE PROVIDED, THE PILOTS & THE BURNERS OR HEATING ELEMENTS AND SWITCHES ARE LOCATED AT LEAST 18" ABOVE THE FLOOR LEVEL IN RESIDENTIAL GARAGES

WATER HEATERS PROTECTION FROM SEISMIC DAMAGE: WATER HEATERS SHALL BE ANCHORED TO RESIST HORIZONTAL DISPLACEMENT DUE TO EARTH QUAKE MOTION, STRAP THE WATER HEATER AT THE UPPER AND LOWER THIRDS. (CPC 508.2)

PROV. COMBUSTION AIR OPENING FROM OUTSIDE FOR WATER HEATER & FURNACE, PER CMC CH7 & EXHAUST FLUE TERMINATION PER CMC 802.6.

BATHROOM NOTES:

EXHAUST FANS ARE CAPABLE OF PROVIDING FIVE AIR CHANGES PER HOUR.

ANCH CIRCUITS: A 20A CIRCUIT IS REUIRED TO SERVE THE REQUIRED BATHROOM OUTLETS, THIS CIRCUIT CANNOT SUPPLY ANY OTHER RECEP, LIGHTS, FANS, ETC.

SHOWERS AND TUB/SHOWER COMBINATIONS SHALL BE PROVIDED W/ INDIVIDUAL CONTROL HABITABLE SPACE SHALL HAVE A CEILING HEIGHT OF NOT LESS THAN 7-6". KITCHEN, HALLS, VALVES OF THE THERMOSTATIC MIXING OR PRESSURE BALANCE TYPE, (CPC 418.0)

> SHOWER COMPARTMENTS AND WALLS ABOVE BATHTUBS WITH INSTALLED SHOWER HEADS SHALL BE FINISHED WITH A SMOOTH, NONABSORBENT SURFACE TO A HEIGHT OF NOT LESS THAN 70 INCHES ABOVE THE DRAIN INLET (CBC 1210.2.3)

BATHTUB & SHOWER FLOORS & WALLS ABOVE BATHTUBS WITH INSTALLED SHOWER HEADS & IN SHOWER COMPARTMENTS SHALL BE FINISHED WITH A NONABSORBENT SURFACE. SUCH WALL SURFACES SHALL EXTEND TO A HEIGHT OF NOT LESS THAN 6 FEET ABOVE THE

WHIRLPOOL TUB: LIGHT FIXTURES INSTALLED ABV. AND WITHIN 5' FROM THE INSIDE WALLS OF THE WHIRLPOOL TUB SHALL BE AT LEAST 7'-6" ABV THE MAX. WATER LEVEL AND GFCI PROTECTED. FIXTURES MAY BE INSTALL LESS THAN 7'-6" PROVIDED THEY ARE LISTED FOR USE IN DAMPED LOCATIONS AND GFCI PROTECTED. CEC ARTICLE 680-43(B)(1a-c).

PROJECT NAME

2342-2344 3rd Street SAN FRANCISCO, CA



SIA CONSULTING CORPORATION 1256 HOWARD STREET SAN FRANCISCO CA 9410 TEL: (415) 741,1292 FAX: (415) 849 1252 WWW.SIACONSULT.COM

SHEET TITLE

General Notes / Typical Details

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ISSUES / REVISIONS

NO. DATE DESCRIPTION

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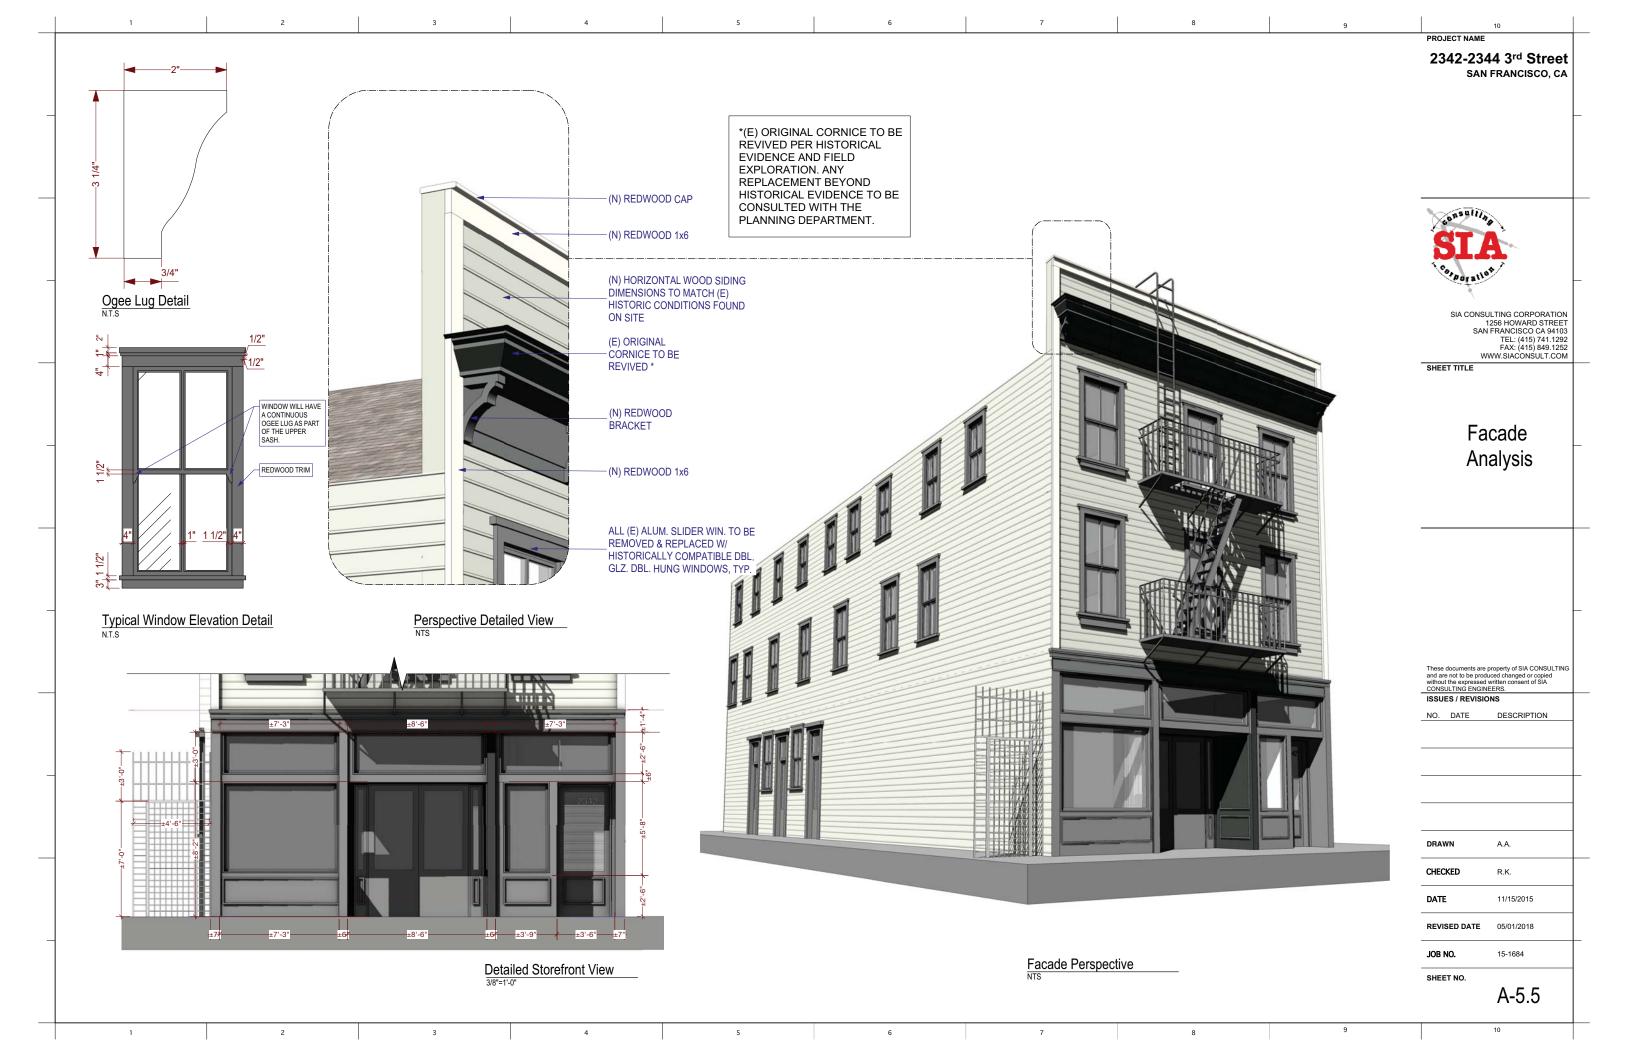
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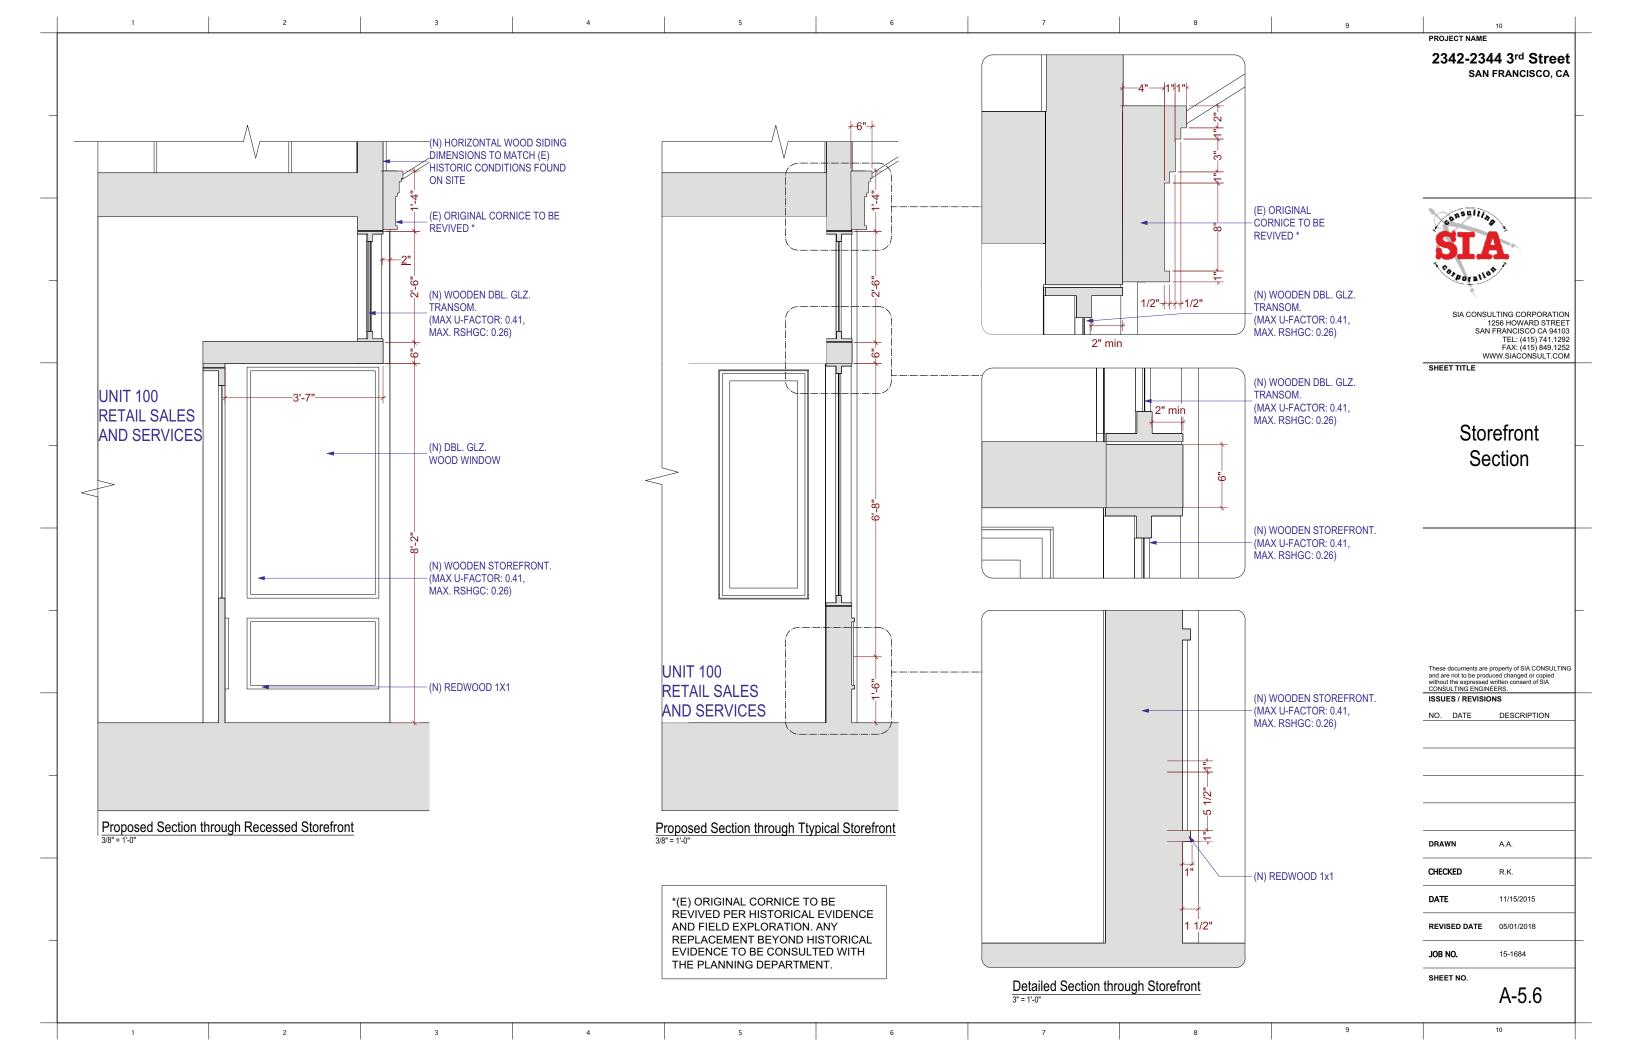
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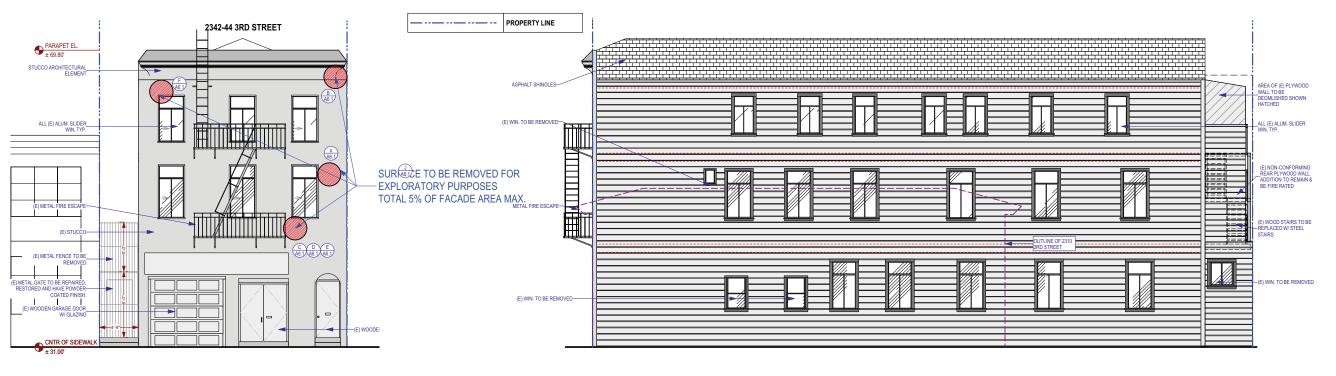
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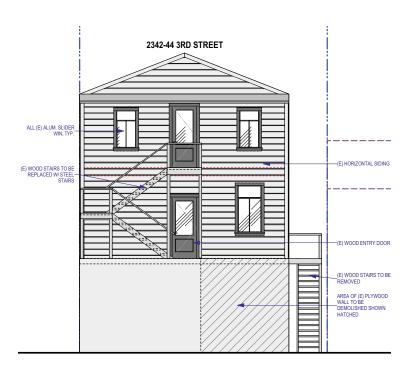
15-1684







Existing Front Elevation (East)
3/16" = 1'-0"




Existing Rear Elevation (West)

Existing Right Elevation (North)

SURFACE TO BE REMOVED FOR

EXPLORATORY PURPOSES

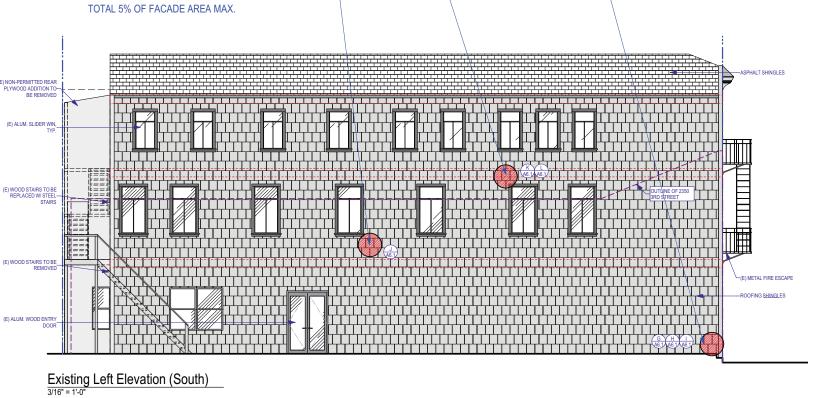

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Exploratory Surface Removal Diagram

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Exploratory Demo Photos (1)

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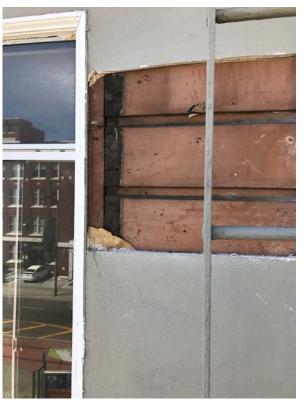
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Front Façade

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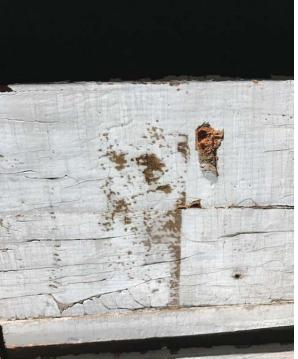
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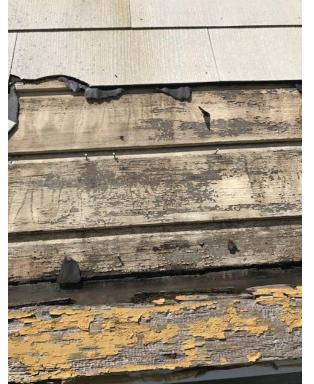














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