

MEMO

**DATE:** March 25, 2015

**TO:** Architectural Review Committee of the Historic Preservation

Commission

**FROM:** Rich Sucré, Historic Preservation Technical Specialist, (415) 575-9108

**REVIEWED BY:** Tim Frye, Preservation Coordinator, (415) 575-6822

RE: Review and Comment: 3751-3753 20th Street

Case No. 2014.0655A

1650 Mission St. Suite 400 San Francisco, CA 94103-2479

Reception: 415.558.6378

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415.558.6409

Planning Information: 415.558.6377

#### **BACKGROUND**

On January 21, 2015, the Historic Preservation Commission (HPC) requested additional review and comment before the Architectural Review Committee (ARC) regarding the proposal for façade alterations, construction of a new three-car garage, and a three-story rear addition and roof deck at 3751-3753 20<sup>th</sup> Street within the Liberty-Hill Landmark District, which is listed in Appendix F of Article 10 of the San Francisco Planning Code.

#### PROPERTY DESCRIPTION

3751-3753 20th STREET is a three-story, two-family residence designed in a simple Greek Revival architectural style located on a rectangular lot (measuring approximately 25 ft x 114 ft) on the south side of 20th Street between Dolores and Guerrero Streets. Constructed prior to 1900, the existing building features wood-frame construction, wood siding, aluminum-sash and wood-sash windows, a gable roof, and is slightly setback from the street edge. At the street, the subject property features a brick retaining wall and a set of concrete steps. Currently, the subject property does not have any off-street parking.

Per Article 10 of the San Francisco Planning Code, 3751-3753 20th Street is designated as contributing resource to the Liberty-Hill Landmark District. The project site is located within RH-2 (Residential, House, Two-Family) Zoning District with a 40-X Height and Bulk Limit.

# PROJECT DESCRIPTION

The proposed project consists of rehabilitation of the two-family residence, including:

- Construction of a New Garage/Basement Level: The project would construct a new three-car garage. The new garage opening would be approximately 9-ft wide and would feature painted, wood panel garage doors. The proposed curb cut would measure approximately 10-ft wide. As part of the work at the basement level, the project would replace the existing foundation with a new concrete foundation.
- *Primary Façade Alterations*: The project would remove the aluminum-sash window on the third floor and insert a pair of new eight-lite fixed windows to match the existing historic

windows on the first and second floors. In addition, portions of the existing brick retaining wall would be removed to accommodate the new garage opening.

- Inset Roof Windows: The project would construct a set of inset wood-sash windows on the west and east facades of the existing gable roof.
- Rear Yard Alterations: The project would remove portions of the grade at the rear yard to provide exposure to the ground floor level. With the grade work, the subject property appears as four-stories tall. As part of the rear yard work, the project would construct a new set of stairs from the new grade up to the existing grade.
- Construction of Rear Addition: At the rear, the project would remove the existing two-story, non-historic rear addition and construct a new three-story horizontal addition with a roof deck that would extend approximately 34-ft 6-in from the existing rear wall. This new horizontal addition would feature large wood windows, a flat roof, and tongue and groove wood siding (dimensioned at half the height of the existing wood siding on the historic property). The new addition would also feature a roof deck at the third and fourth floor levels. These roof decks would feature a simple metal cable rail system around the roof deck perimeter.
- West/East Façade Alterations: The project would add new window and door openings on the west facade. The rear façade would be clad in a smooth stucco finish, and would feature wood-sash casement windows.

The proposed project would increase the square footage of the two-family residence from 2,347 square feet to 7,111 square feet. Original drawings date from November 4, 2014.

The proposed project requires a variance from the Zoning Administrator to address the Planning Code requirements for rear yard (Planning Code Section 134).

# **ENVIRONMENTAL REVIEW**

On January 15, 2015, the Project was determined to be exempt from the California Environmental Quality Act ("CEQA") as a Class 32 Categorical Exemption under CEQA as described in the determination contained in the Planning Department files for this Project.

# **JANUARY 21, 2015 HPC HEARING**

On January 21, 2015, the HPC reviewed the proposed project, and expressed concern over the following:

- Reduction of gable window on upper level of the front façade;
- Size, scale and design of new addition;
- Courtyard (light court) in rear yard; and
- Amount of excavation and potential archaeological issues.

The HPC supports the revisions to the front façade and the insertion of a new three-car garage.

# STAFF ANALYSIS & RECOMMENDATIONS

The Department seeks the advice of the ARC regarding the concerns expressed by the HPC, and the subsequent revisions to the project, as outlined in the revised architectural drawings dated March 18, 2015.

Since the January 21, 2015 HPC Hearing, the Project Sponsor has made the following modifications to the proposed project:

- Removal of the rear sub-grade light court;
- Addition of a small window on the front façade to address dwelling unit exposure for the lower residential unit;
- Regrading and terracing of the rear yard to step more gracefully from the back of the new addition;
- Alignment of the second-story rear addition with the rear of the adjacent neighbor's house (to address neighbor's request);
- Reduction of the height of the third-story of the rear addition;
- Revisions to the rear façade with less glazing and more wall surface;
- Incorporation of a 1-ft wide by 6-in deep "hyphen" connection to separate existing residence and new addition on the west and east facades;
- Revision to the gable window on the front façade from a two-panel casement window to a single-panel casement window (thus matching the single-panel casement window on the second floor);
- Addition of structural narrative (Sheet A07); and,
- Update of the demolition calculations.

The Department would like the ARC to consider the following information:

Reduction of Gable Window on Upper Level of the Front Façade

In response to comments from the HPC, the Project Sponsor has modified the design of the window on the gable on the top floor of the front façade. This window has been revised to a single-panel, eight-lite, wood-sash window, which would match the single panel window on the second floor.

#### Recommendation:

Department staff supports the proposed revisions to the gable, and recommends no further revisions.

Size, Scale and Design of the New Addition

In response to comments from the HPC and surrounding neighbors, the Project Sponsor has modified the size and scale of the proposed three-story rear horizontal addition. Specifically, the Project Sponsor has reduced the length of this addition on the second floor by approximately 2-ft

to match the adjacent neighbor to the north. In addition, the Project Sponsor has reduced the overall height of the rear vertical addition by approximately 1-ft 3-in. The Project Sponsor has also reduced the amount of glazing on the rear façade, and also increased the amount of stained wood tongue and groove wood siding.

#### Recommendation:

Department staff supports the proposed revisions to the rear addition, and recommends no further revisions. As noted in the original case report, the new three-story horizontal addition is clearly differentiated from the historic mass of the original residence, as noted by the roofline, the change in siding, and the newly-added hyphen on the west and east facades. This hyphen is accentuated by the addition of trim board, which highlights the distinction between the historic residence and the new addition. The new addition has a flat roof, while the existing historic residence features a gable roof. The new additions would be constructed on top of an existing non-historic addition currently located at the rear of the existing residence. The new addition is considered to be compatible with the subject property's overall historic character, since the new work is occurring on a rear and non-visible façade, the new wood siding is similar in material and design to the property's historic wood siding (evident on the primary facades), and the mass of the new addition is differential to the historic mass of the original residence. Although the overall scale of the project appears large due to the extent of the excavation, the Department considers the above grade portion of the new addition to be consistent and compatible with the residence and surrounding district, since the new addition is differentiated to the mass of the existing residence and is smaller in scale relative to the existing building.

#### Courtyard (Light Court) in Rear Yard/New Exterior Window

In response to comments from the HPC, the Project Sponsor has removed the two-story, rear yard light court, which would have required excavation of 21-ft 10-in. In response, the Project has modified the rear landscaping to include a series of rear yard terraces and retaining walls. To provide additional light to the lower residential unit, the project includes a skylight/light well and a new exterior window on the front facade. As proposed, the new exterior window appears out of scale with the other windows on the front façade.

#### Recommendation:

Department staff supports the proposed revisions to the rear light court, and recommends no further revisions. The Department seeks the input of the HPC on the design, size and scale of the new exterior window.

# Amount of Excavation and Potential Archaeological Issues

The proposed project underwent archaeological review as part of the environmental review. At the request of the HPC, the Department has provided additional information on the proposed excavation from the Department's staff archaeologist (See Attached).

SAN FRANCISCO
PLANNING DEPARTMENT 4 of 4

# **REQUESTED ACTION**

Specifically, the Department seeks comments on:

- Reduction of gable window on upper level of the front façade;
- Size, scale and design of new addition; and,
- Courtyard (light court) in rear yard/new exterior window.


# **ATTACHMENTS**

- Revised Proposed Project Architectural Drawings by Matarozzi Pelsinger Design + Build (March 18, 2015); and,
- Original Architectural Drawings by Matarozzi Pelsinger Design + Building (November 4, 2014).

#### **ABBREVIATIONS**

NEW
NATURAL
NOT IN CONTRACT
NUMBER
NUMBER
NOMINAL
NOT TO SCALE (N) NAT. N.I.C. NO. # NOM. N.T.S. AND
AT
ABOVE
AIR CONDITIONING
ACOUSTIC CEILING TILE
ADJUSTABLE
ADJ ABV. A.C., A.C.T. ADJ. AFF. ALT. ALUM. ANOD. APPRO) ARCH. AXON. OBSCURE
ON CENTER
OUTSIDE DIAMETER
OPPOSITE HAND
OPERABLE
OPENING
OPPOSITE OBSC. O.C. O.D. O.H. OPER. OPNG. OPP. BD. B.J. BLDG. BLKG. B.O. B.P. BRZ. B.U.R. BOARD BUTT-JOINT BUILDING BLOCKING BOTTOM OF BUILDING PAPER BRONZE BUILT-UP ROOF PARTITION
PERFORATED
PLATE
PROPERTY LINE
PLASTIC LAMINATE
PLASTIC LAMINATE
PLASTIC LAMINATE
PLASTIC LAMINATE
PANEL
PANEL
PANEL
PANEL
PANEL
PANEL
PROPERTY
PANESURE TREATED
PHOTOVOLTAIC PART. PERF. PL. PLAM. PLAS. PLY. PNL. PNT. PROP. PTD. P.T. P.V. BOIL-TOP ROOF
CABINET
CEMENT
CEMENT
CEMENT
CEMENT
CEMENT
CEMENT
CEMENT
CEMENT
CHANNEL
CEMENT
CEMENT
CEMENT
CEMENT
CEMENT
CEMENT
CEMENT
CEMENT
CONCRETE MASONRY UNIT
COULUMN
CONCRETE
CONTROL
CONCRETE
CONTROL
CONTROL CAB.
CEM.
CER.
CHAN.
C.L.
C.L.
CL.
CLG.
CLG.
CLG.
CONC.
CONC.
CONC.
CONC.
COTR.
CTR. RISER
RESILIENT BASE
REFLECTED CEILIING PLAN
REFERENCE
REFRIGERATOR
REFINISH
REINFORCED
REVISIOWREVISED
ROOM
ROUGH OPENING
RATED
RAIN WATER LEADER R.B. R.C.P. REF. REF. REFIN. REINF. REQD. REV. RM. R.O. RTD. R.W.L. DEPARTMENT DETAIL DOUGLAS FIR DIAMETER DIMENSION DOWN DOOR DISHWASHER DRAWING DEPT. DET. D.F. DIA. DIM. DN. DR. DW. DW. SOLID CORE
SOLID CORE
SOLID LES
SOLID DISPENSER
SECTION
SEE ELECTRICAL DRAWINGS
SHEET
SHEATHING
SIMILAR
SEE LANDSCAPE DRAWINGS
SEE MECHANICAL DRAWINGS
SEE PLUMBING DRAWINGS
SPECIFICATION
STAINLESS STEEL
SEE STRUCTURAL DRAWINGS
STANDARD
STEEL S.C. SCHED.
S.ACT.
S.E.D.
SHTIG.
SHTIG.
SIM.
S.L.D.
S.P.D.
S.P.D.
STD.
STD.
STD.
STOR.
STRUCT.
SUSP. EXISTING
EACH
ELEVATION
ELEVATION
ELECTRICAL
ENGINEER
EQUIPMENT
EXECUTIVE
EXPANSION
EXTERIOR EL ELEV. ELECT. ENGR. EQ. EQPT. EXEC. EXP. EXT. STEEL STONE STORAGE STRUCTURAL SUSPENDED SYMMETRICAL FABRIC
FURNISHED BY OWNER
FLOOR DRAIN
FINISH
FIXTURE
FLOOR
FINISHED OPENING
FACE OF FINISH
FACE OF STUD
FACE OF CONCRETE
FRAME
FRAMING
FROOT OR FEET
FURRING FAB. FB.O. FIN. FIXT. FL. FO.F. FO.S. FO.C. FRM. FRMG. FT. FURR. TREAD
TO BE DETERMINED
TELEPHONE
TELEPHONE
TEMPERED
TEMPORARY
TRANSPARENT FINISH
TRANSPARENT FINISH
TRANSPARENT FINISHED WOOD
TONGUE AND GROOVE
TOP OF
TOP OF CONCRETE
TOP OF WALL
TRANSLUSCENT
TELEVISION
TYPICAL T.
T.B.D.
TEL
TEMP.
TEMP.
T.F.
TFWD.
T&G
T.O.
T.O.C.
T.O.W.
TRANS.
TV. GALV. GALV. G.D. GEN. GL. GYP. G.W.B. GAUGE GALVANIZED GARBAGE DISPOSAL GENERAL GLASS GYPSUM GYPSUM WALL BOARD U.B.C. U.C. U.O.N. UTIL UNIFORM BUILDING CODE UNDER COUNTER UNLESS OTHERWISE NOTED UTILITY H.B. H.C. HDWD. HT. HORIZ. HR. H.M. H.W. HOSE BIB
HOLLOW CORE
HARDWOOD
HEIGHT
HORIZONTAL
HOUR
HOLLOW METAL
HOT WATER VARIES
VINYL COMPOSITION TILE
VENEER
VERTICAL
VESTIBULE
VERIFY IN FIELD
VENEER PLASTER VAR. V.T. VEN. VERT. VEST. V.P. WITH
WATER CLOSET
WOOD
WASHER/DRYER
WINDOW
WATER HEATER
WITHOUT
WHERE OCCURS
WATERPROOFING
WEIGHT I.D. IN. INSUL. INT. INSIDE DIAMETER INSULATION INTERIOR JAN. JT. JANITOR JOINT KIT. KITCHEN LAMINATE LAVITORY LOCATION LIGHTWEIGHT LEVEL LAM. LAV. LOC. LTWT. LVL MATERIAL
MAXIMUM
MOISTURE BARRIER
MEDICINE CABINET
MECHANICAL
MEMBRANE
MANUFACTURER
MINIMUM
MIRROR
MISCELLANEOUS
MASONRY
MOUNTED
METAL MAT. MAX. M.B. M.C. MECH. MEMB. MFR. MIN. MISC. MSRY. MTD. MTL

# **SYMBOLS**

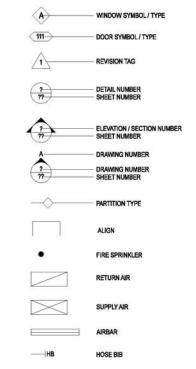

#### DIRECTORY

NAME ADDRESS EMAIL

MATAROZZI PELSINGER DESIGN+BUILD 355 11TH STREET, SUITE 200 SAN FRANCISCO, CA 94103 T 415.285.6930

#### VICINITY MAP



#### PROJECT DATA

3751/3753 20TH STREET SAN FRANCISCO, CA 9411

BLOCK/LOT #

ZONING DISTRICT

OCCUPANCY GROUP

RESIDENTIAL UNITS -2 EXISTING (NO CHANGE)

TYPE OF CONSTRUCTION

HEIGHT LIMIT

(N) VERTICAL ADDITION BELOW (E) GRADE
(N) HORIZONTAL ADDITION @ REAR
(N) ELEVATOR
(N) CURB CUT & GARAGE DOOR
(N) DORMER WINDOWS
REPLACE (E) FRONT GABLE WINDOW WITH (N) WOOD WINDOW

PARCEL AREA 2,848 SQ.FT.

**BUILDING AREA (GROSS)** 

-EXISITNG; 2,347 SQ.FT, -PROPOSED: 7,111 SQ.FT. (INCLUDES GARAGE/STORAGE)

APPLICABLE BUILDING CODES

2013 CALIFORNIA BUILDING CODE (C.B.C.)
2013 CALIFORNIA PLUMBING CODE (C.P.C.)
2013 CALIFORNIA RECHANICAL CODE (C.M.C.)
2013 CALIFORNIA RECETTICAL CODE (C.E.C.)
2013 CALIFORNIA RECETTICAL CODE (C.E.C.)
2013 CAL GREEN BUILDING CODE (CALIGREEN)
2013 SAM FRANCISCO AMEROMENTS TO C.B.C.
C.P.C., C.M.C., C.E.C., AND CALGREEN

# SHEET INDEX

ARCHITECTURAL

C.O - SURVEY

A1.1 - SITE PLANS - EXISTING & PROPOSED

A3.1 - SECTION - NORTH/SOUTH, EXISTING
A3.2 - SECTION - NORTH/SOUTH, PROPOSE
A3.3 - SECTION - EAST-WEST, PROPOSED
A3.4 - ELEVATION - NORTH, EXISTING
A3.5 - ELEVATION - NORTH, PROPOSED
A3.6 - ELEVATION - SOUTH, EXISTING
A3.7 - ELEVATION - SOUTH, PROPOSED
A3.8 - ELEVATION - EAST, EXISTING
A3.9 - ELEVATION - LEAST, EXISTING
A3.9 - ELEVATION - LEAST, EXISTING
A3.1 - ELEVATION - LEAST, PROPOSED
A3.10 - ELEVATION - LEAST, PROPOSED

355 11TH STREET, SUITE 200 SAN FRANCISCO CA 94103 T 415.285.8930 F 415.285.7266 WWW.MATPELBUILDERS.COM MATAROZZI PELSINGER

STREET **20th** 

3751 / 3753

20TH STREET, FRANCISCO, CA, 94110

3751 SAN

13045.70

SITE PERMIT

03.18.2015

SHEET TITLE

**COVER SHEET** 

SHEET NUMBER:



20TH STREET - SOUTH SIDE NOT TO SCALE



355 11TH STREET, SUITE 200 SAN FRANCISCO CA 94103 T 415.285.6830 F 415.285.7266 WWW.MATPELBUILDERS.COM

MATAROZZI PELSINGER DESIGN + BUILD



2

3751 / 3753 20th STREET

3751 20TH STREET, SAN FRANCISCO, CA, 94110

JOB: 13045.70

SITE PERMIT

10.2.2014

REVISION:

SHEET TITLE:

PHOTOGRAPHS: NORTH & SOUTH 20TH STREET

SHEET NUMBER:



SUBJECT PROPERTY

VIEW FROM REAR OF SUBJECT PROPERTY NOT TO SCALE



SUBJECT PROPERTY & ADJACENT NEIGHBORS - REAR NOT TO SCALE

SUBJECT PROPERTY



SUBJECT PROPERTY & ADJACENT NEIGHBORS - FRONT NOT TO SCALE

MATAROZZI PELSINGER DESIGN + BUILD

355 11TH STREET, SUITE 200 SAN FRANCISCO CA 94103 T 415.285,6930 F 415.285,7266 WWW.MATPELBUILDERS.COM



3751 / 3753 20th STREET

3751 20TH STREET, SAN FRANCISCO, CA, 94110

13045.70


SITE PERMIT

10.2.2014

SHEET TITLE:

PHOTOGRAPHS: SUBJECT PROPERTY FRONT & REAR

SHEET NUMBER:

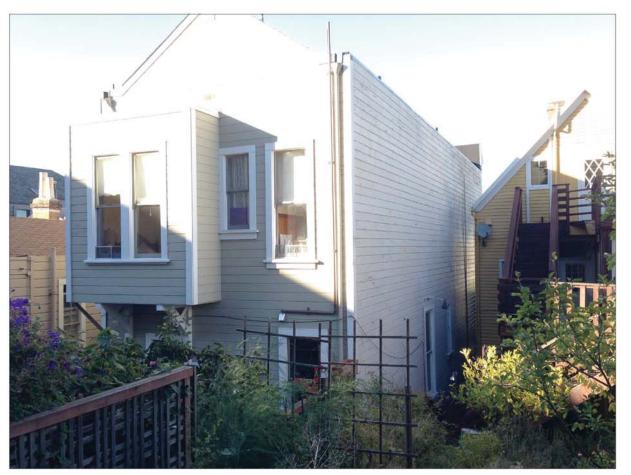



3



EAST NEIGHBOR - REAR NOT TO SCALE

3751 / 3753 20th STREET

355 11TH STREET, SUITE 200 SAN FRANCISCO CA 94103 T 415.285.6830 F 415.285.7266 WWW.MATPELBUILDERS.COM

MATAROZZI PELSINGER DESIGN + BUILD

13045.70

SITE PERMIT

11.04.2014

SHEET TITLE:

PHOTOGRAPHS: NEIGHBORS

SHEET NUMBER:

A0.3B



WEST NEIGHBOR - PROPERTY LINE WINDOWS NOT TO SCALE



Affected to Pre-Application Meeting

Affidavit for Pre-Application Meeting

Afficiav't for Pre-Application Meeting

Meeting Time 6pm Meeting Time 6pm Meeting Address 3751 20th Street, San Francisco, CA 94110 Project Address 3751 20th San Francisco, CA 94110 Project Address 3751 20th San Francisco, CA 94110 Project Address 3751 20th San Francisco, CA 94110 Projec	Pre-Applica	ation Meeting Sign	n-in Sheet		
your phone number. Providing your name below does not represent support or opposition to the project it is for documentation purposes only.  NAME/ORGANIZATION ADDRESS PHONE # EMAIL SEND PLANS  LIMBSHY Nefacille 3739 20th St. Liberty above 18 June 18 18 J	Meeting Time: 6pm Meeting Address: 37 Project Address: 375 Property Owner Nar	51 20th Street, San Francisco, CA 1 20th Street, San Francisco, CA S	4110	ulld	
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2/25/2014			
Meeting Date: 3/25/2014			70 50
Meeting Time: 6:00pm Meeting Address: 3751 20th St.	an Francisco CA 94110		-
Project Address: 3751 20th St., Si	in Francisco, CA 94110		
Property Owner Name: Justin M	Baine		
Project Sponsor/Representative: S	hane Curnyn, Matarozzi Pe	elsinger Design + Build	
Please summarize the questions/c space below. Please state if/how t	omments and your respons he project has been modifie	e from the Pre-Applicati d in response to any con	on meeting in the
Question/Concern #1 by (name of Ingrid Eggers (3749 20th St.): Th	concerned neighbor/neight construction phase of th	borhood group): e project will negatively	effect my Airbnb
business.	-		
Project Sponsor Response: We intend to do everything with	in our power to mitigate t	he effect of construction	n on 3749. If there
are specific concerns, please let	is know so we can addres:	s them together.	
Question/Concern #2:	roar addition come large	or than what Planning w	rould allow given
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Affidavit of Conduc	cting a Pre-Application Meeting,
Sign-in Sheet and	Issues/Responses submittal

I, Jus	stin McBaine, do hereby declare as follows:	
1.	I have conducted a Pre-Application Meeting for the proposed new construction submitting any entitlement (Building Permit, Variance, Conditional Use, etc. Planning Commission Pre-Application Policy.	
2.	The meeting was conducted at 3751 20th Street, San Francisco, CA 94110 on 3/25/2014 (date) from 6pm-7pm (time).	(location/addres
3.	I have included the mailing list, meeting initiation, sign-in sheet, issue/respon- reduced plans with the entitlement Application. I understand that I am respon of this information and that erroneous information may lead to suspension or of the permit.	sible for the accura

 $I \ declare \ under \ penalty \ of \ perjury \ under \ the \ laws \ of \ the \ State \ of \ California \ that \ the \ foregoing \ is \ true \ and \ correct.$ 

I have prepared these materials in good faith and to the best of my ability.

EXECUTED ON THIS DAY, 3/25 ....., 20 14 IN SAN FRANCISCO.

Justin McBaine

Name (type or pant)

Owner
RaleRonatilp to Project (e.g. Owner, Agent)
(f Agent, give business name & profession)

3751 20th Street, San Francisco, CA 94110

3751 / 3753 20th STREET

365 11TH STREET, SUITE 200 SAN FRANCISCO CA 94103 T 415.285.6930 F 415.285,7266 WWW.MATPELBUILDERS.COM

MATAROZZI PELSINGER Design + Build

13045.70

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SITE PERMIT

3751 20TH STREET, SAN FRANCISCO, CA, 94110

in corre

03.18.2015

REVISION:

SHEET TITLE:

PLANNING PRE-APPLICATION MEETING INFO

SHEET NUMBER:

# equired Checklist for ing and Protection

# Tree Planting and Protection

1. Applicant Information

ADDRESS	TELEPHONE
Matarozzi Pelsinger Builders	(415 ) 466-8239
355 11th St., Ste. 200	DMAL
San Francisco, CA, 94103	jtmcb@yahoo.com
STREET ADDRESS OF PROJECT	
STREET ADDRESS OF PROJECT	
STREET ADDRESS OF PROJECT 3751 / 3753 20th St. ORGAS STREETS	
STREET ADDRESS OF PROJECT 3751 / 3753 20th St.	
ONOSS STREETS	JOANA DETHICE

#### 3. Scope of Project

Requirements for new street trees and tree protection apply to the types of projects identified in the chart below. Please check all boxes which apply to your project. If no boxes are checked, you do not need to complete this form.

	DEVELOPMENT PEATURES
	construction of a new building
	relocation of a building
	pering at receiving more than 200 square test of the front settack
X	addition of gross floor area (GFA) equal to 20% or more of the OFA of the existing building
	addition of a new dwating unit
(X)	addition of one or more parking spaces
x	addition of a garage

4. Disclosure of Existing Protected Trees

SIGNIFICANT TREES

Only the following specific types of trees require protection under the Public Works Code: Street Irees, Significant Trees and Landmark Trees. These trees are collectively known as "Protected Trees." in the following table, please indicate the presence or lack thereof of such on, over, or adjacent to the parcel containing the proposed construction

any portion of its trunk within 10	Significant Tree" is a tree that is planted on the subject property (i.e. outside of the public right-of-way) w portion of its trunk within 10 feet of the public right-of-way that has (i.e. dia a diameter at breast height (DRH ses of twelve inches OR (ii) a height in excess of twenty feet OR (ii) a canopy in excess of fiftheen feet.			
CHECK ALL BOXES THAT AFFLY AND NOICATE GUANTITY OF EACH THEE TYPE & APPROPRIATE.	Significant Tree(s) exist on the subject property	ary		
If you are unsure of the boundary of the public	Significant Tree(s) exist on any adjacent property	OTY		

☐ Sig	inificant Tree(s) exist on any adjacent property	one
X The	ere are no Significant Trees on or adjacent to the	subject property.

LANDMARK TREES		
	gnated as such by the Board of Supervisors owing to particul ciation, visual quality, or other contribution to the City's chara	
CHECK ALL BOXES THAT APPLY AND NORCHTE QUANTITY OF	Landmark Trees exist on the subject property	arv
EACH TREE TWYE, IF APPROPRIATE.  If you have questions about the presence of	Landmark Trees exist on the adjacent sidewalk	an
If you have guestions about the presence of Landmark Trake, places consult with CPW or visit www.eldpw.org/trake.	Landmark Trees exist on any adjacent property	
	[X] There are no Landmark Trees on or adjacent to the subject prop	
	COMPLETE LIST OF LANDMARK TRIES AS OF SUMMER 2012	

COMPLETE LIST OF LANDMARK TREES AS OF SUMM	ER 2012
Six Stor Gores adjacent to 1801 Book Street	Backer popper of Third St. and Youasite Street in the major-
Plater papers at a 1781 frankly Street	Toward Day of 555 Bulliary Street
Nove Zestand Christinian Tree of 122h Steriyon Street	At Canary Mand Date Palms to the center Hand on Delores Street
13 Cerwy Idano Cate Fame in Quesalle St median west of 342 61	Two Paints in median process. 750 Bulanes St J. 1945 Bolones St.
Scialakiye Parita in the median across from 1926-1980 Solores St.	Court he can't he harbyed of 20.08 Reserved Place
California laschepe in the lastyand of 190 888 Avenue	Could be set in the budgest of 4194 23rd Novel
Two Processing Auth at the Serina's Allowy at 500 Contined Street	the Discours our respector of Paleses & Bernal Heights Bloo
Monton Bay Fig of 3555 Center Chayest St / 1580 Vulencia St	Alberteray Cyprose in the bushwell of 242% Wallego Street
Howel's Mandanto in the bestyord of \$15 Review Avenue	Colfornia Statement was located belong 267 Permayborite Street.
Northite falance From Toward From County and of 2040-00 Suppor Street	Two Canady letting Plants in the countywell of 2040-00 Sellies St.

STREET TREES		
A "Street Tree" is any tree growi	ng within the public right-of-way (e.g. sidewalk) that is not also	a Landmark Tree.
CHECK THE BOX THAT APPLIES AND INDICATE QUANTITY IF APPROPRIATE.	$[\underline{X}]$ . Street Trees exist adjacent to the subject property	ary 1
Regardless of stat, all tress in the public right- of way are protected under Article 18 of the	There are no Street Trees adjacent to the property.	

5. Impact of Project on Existing Protected Trees

If your responses above indicate that any Protected Tree(s) exist on, over or adjacent to the subject property, please check the applicable boxes, below:

BOX 1 IX The project will not remove or have any other impact on Protected Trees, as follows: No construction-related activity whatsoever will occur within the dripline of any Significant Tree or Street Tree. This includes, but is not limited to, the following: (1) No grading or excervation will take place within the dripline of any Significant Tree or Street Tree. (2) No construction staging and/or storage of materials and/or equipment will occur within the dripline of any Significant Tree or Street Tree. (3) Any pruning of Significant Tree or Street Tree will be limited and consistent with applicable regulations. (4) No dumping of trash and/or liquids (such as project waste-water) will take place within the basin or dripline of any Significant Tree or Street Tree.

If you have checked this box, a Tree Protection Plan is not required.

BOX 2 The project involves the removal of one or more Protected Trees. A permit from DPW is required in order to remove any Protected Tree. The Planning Department will not approve a building permit for a project which involves the removal of a Protected Tree unless DPW has first reviewed the proposal and found it to be consistent with applicable rules and regulations.

If you have checked this box, a Tree Protection Plan is not required, however you must provide evidence to the Planning Department that DPW has reviewed the removal request and found it to be "approvable."

BOX 3 The project may have an impact on one or more Protected Trees which are not proposed for removal, as follows: Either (1) any construction-related activity, no matter how minor, is planned or is reasonably foreseeable to occur within the dripline of a Significant Tree or a Street Tree or (2) regardless of the location of construction activity, the property contains a Landmark Tree.

If you have checked this box, a Tree Protection Pian must be submitted to the Department of Public Works Bureau of Urban Forestry prior to the commencement of any construction activity.

Such plan must meet the following minimum standards:

 The Tree Protection Plan must be developed by an International Society of Arboriculture (ISA) Certified Arborist.

The project sponsor must submit a written declaration that the protections specified in the Tree Protection Plan will be completely in place prior to the start of any construction, demolition, or grading.

Full-size size plans submitted along with the associated construction project must clearly indicate the street, curb, sidewalk, driveway, structure(s), and the locations of all Protected Trees and non-protected trees. Protected Trees must also be shown to include accurate tree height, accurate canopy dripline and trunk and canopy diameters. The plans must graphically depict implementation of all measures called for in the Tree Protection Plan. Additionally, the Tree Protection Plan isself along with the written declaration must be reproduced on full-size plans.

- 8

# Required Checklist for

6. Calculation of Number of New Required Street Trees

One street tree is required for each 20 feet of street frontage of the subject property, with fractions of 0.5 rounded up, however credit is given for existing street trees. Please complete the table below to determine the number of street trees required for your project. If no street trees are required, please skip to the Applicant's Affadwist at the end of this form and once signed, return it to the Planning Department along with your Building Permit Application or other application.

COMMINED LENGTH OF ALL	DWDED BY TREE	GROSS NUMBER OF	MINUS NUMBER OF	NET STREET THEE REQUIREMENT
STREET FRONTAGES	SPACING REQUIREMENT	TREES REQUIRED	EXISTING TREES	
25'	÷ 20' =	. 1	1 :	0

Unless site conditions physically prevent the planting of a street tree, a waiver or modification of street tree requirements is available only under extremely limited circumstances and only outside of Residential Districts (i.e. RH, RM, RTO, RED). Be aware that even when available, an in-kind improvement or in-lieu payment is required for every such waiver. Please contact the Planning Department for information regarding the waiver process.

#### 7. Applicable Requirements for New Street Trees

The Planning Department has developed three distinct "Tree Schedules' to aid in the implementation of the Planning Code's street tree requirements. The particular Tree Schedule applicable to your project will depend on the zoning district in which your property is located, the scope of your project, and the type of authorization that your project requires. In general terms, Tree Schedule A applies to small-scale projects in residential or industrial zoning districts, Tree Schedule B applies to moderate-scale projects or projects in commercial or mixed-use zoning districts, and Tree Schedule C applies to larger projects. In the following chart, please check the applicable box based on the characteristics of your project.

	DCHEDULE					
The project is located in a Residential (RH, RM, RTO, RED), industrial (M) or Production/Distribution 20 parties and does not involve a Parned Unit Development (PUD). A PUD is a special authority the Panning Commission that applies only to major projects involving large properties.					ed Unit Development (PUD). A PUD is a special authorization granted by	
	В	1. The project is located in a RH, RM, RTO, RED, M or PDR Zoning District and Involves a PUD				
		OR				
			The project is located outside of an RH, RM, RTO, RED, M or 2. PDR Zoring District and meets neither OR one of the following criteria, but not both:	4	It is located on a percel that contains (1) more than 1/2-acre in total area or (2) more than 250 feet of total street frontage or (3) street frontage which spans the entire block face between the nearest two intersections.	
		2.		¥	It involves (1) the construction of a new building or (2) the addition of more than 20% of the gross floor area of the existing building or (3) a change of use of more than 50% of the existing square footage of the building.	
	С	The project is located outside of an RH, RM, RTO, RED, M or PDR Zoning District and meets both criterie of Tre Schedule B(2) above.				

REE	SCH	LEA	

	REQUIREMENT	SPECIFICATION .	
90	Location	either In the public right-of-way (is a sidewell) adjacent to the property or writen an unbuilt wise at the hord of the property	
1	Stre	minimum of 24 inch box size	

#### Planning Department Determination

TO BE COMPLETED BY STAFF ONLY, DO NOT LEAVE ANY SECTION SLANK

BULDING PERMY / GALLING	
PLANS DAYED	
New Street Trees	New street trees are not required as part of this project
	Street Trees are required as part of this project:
	Number of new street trees required:
	Applicable Tree Schedule II A B II B II C
	Compliance with as-of-right requirements shown on plans?  If yes  If his Acceptantin on waver Approved,  EXPLAIN IN COMMENTS BELOW.
Existing Tree	A Tree Protection Plan is not required. Box 1 or Box 2 in Section 5 has been market
Protection	A Tree Protection Plan is required. Box 3 in Section 5 has been marked.
Existing Tree	No Proteoted Trees are proposed for removal.
Removal	One or more Protected Trees are proposed for removal
STAFF TO SIGN UNLESS AV	WVER OR MODIFICATION HAS BEEN APPROVED, BY WHICH CASE ZA SIGNATURE IS REQUIRED.
Spreize	Print Norw Digits

#### Staff Checklist

- The applicant has completed this entire checklist including the affidavit on the preceding page.
- If street trees are required, a building permit cannot be approved until the applicant provides evidence from DPW that the required planting permit can be issued.
- If Protected Trees are proposed for removal; a building permit cannot be approved until the applicant provides evidence from DPW that tree removal permits can be issued.
- If a Tree Protection Plan is required, the applicant has been informed verbally and/or in writing of his or her obligation to submit one directly to DPW prior to the commencement of construction.
- Once signed, a copy of this checklist has been returned to the applicant. The original has been included in the project file or if processed over-the-counter, it has been routed upsteins for scanning by support staff.

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3751 / 3753 20th STREET

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MATAROZZI PELSINGER

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SITE PERMIT

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03.18.2015

DEVISION

SHEET TITLE:

TREE PLANTING & PROTECTION CHECKLIST

SHEET NUMBER:

# L Wong Engineering

#### MEMORANDUM

TO:

DATE March 5, 2015

Justin McBaine (Homeowner)

Shane Curnyn (Architect, Matarozzi Pelsinger Builders)

FROM: Larry Wong, SE (L Wong Engineering Inc.)

PROJECT: 3751 20th Street, Structural Schematic Narrative

#### Overall Project Description

The existing building located at 3751 20th Street is a 3-story, 2-unit, wood-framed residence situated on the south side of 20th Street and on a lot that slopes up from street level towards the rear. The front entry to the existing first floor is approximately 16 feet higher than the elevation of the sidewalk, with access to the entry provided by a set of concrete stairs. The footprint of the existing building, including the rear deck, is approximately 22 feet wide by 53 ft long.

The proposed remodel requiring substantial structural modifications includes a 2-story excavation below the existing first floor (1 garage level and 1 habitable level), a 3-story rear addition extending approximately 12 feet beyond the existing rear deek, excavation for a new yard, and a seismic upgrade to the entire structure per the current San Francisco Building Code.

The neighboring structure to the east is a 2-story, wood-framed, single-family house with a partial basement garage. The elevation of the existing first floor is approximately the same as the first floor of the subject building.

The neighboring structure to the west is a 5-story, wood-framed, single-family house. It appears that the building underwent a major renovation circa 2001, in which two subterranean levels (1 garage level and 1 habitable level) were excavated and added under the existing 3-story structure at that time. The new garage level extends back approximately 40 feet from the sidewalk, and Level 2 extends as far back as to match the existing rear facade. The proposed garage level of the subject building will match approximately the garage level of the west neighboring building.

#### Proposed Structural System

The proposed gravity framing system for the structure is as follows:

. Level 1 (Garage/Street Level): A 14-inch reinforced concrete mat slab laying over moisture barrier, drain rocks, and compacted subgrade or native soil

Page 2

- . Level 2: Concrete-filled metal deck (5-inch total depth) supported by a series of 12-inch deep steel beams spanning in the east-west direction between side retaining walls. The retaining walls along the property lines will consist of 12-inch reinforced concrete walls.
- . Level 3: The existing wood-framed floor will be replaced with a concrete-filled metal deck (5inch total depth) supported by a series of 12-inch deep steel beams spanning in the east-west direction between side retaining walls. The retaining walls along the property lines will consist of 12-inch reinforced concrete walls.
- Level 4: The existing wood joist framing will remain largely intact, with localized structural. modifications and strengthening where required by the architectural floor plans. The floor framing of the new addition will consist of conventional wood framing.
- · Level 5: The existing wood joist framing will remain largely intact, with localized structural modifications and strengthening where required by the architectural floor plans. The roof over
- the addition, which will serve as a roof deck, will consist of conventional wood framing. · Roof: The existing wood joist framing will remain largely intact.

The proposed lateral-force-resisting system for the structure is as follows

- Level 1 (Garage/Street Level): 12-inch reinforced concrete shear walls (also serving as retaining walls) in the north-south direction (Gridlines A & C), and 12-inch reinforced concrete shear walls in the east-west direction (Gridlines 2, 4 & 6).
- . Level 2: 12-inch reinforced concrete shear walls (also serving as retaining walls) in the northsouth direction (Gridlines A & C), and a combination of 12-inch reinforced concrete shear walls (Gridlines 4 & 6) and steel braced frame (Gridline 3) in the east-west direction.
- Level 3: Plywood shear walls in the north-south direction (Gridlines A & C), and a combination of plywood shear walls (Gridlines 3, 4 & 5) and steel moment frame (Gridline 6)
- Level 4: Plywood shear walls in the north-south direction (Gridlines A & C), and a combination of plywood shear walls (Gridlines 3, 4 & 5) and steel moment frame (Gridline 6).
- Level 5: Plywood shear walls in the north-south direction (Gridlines A & C), and a combination of plywood shear walls (Gridlines 3, 4 & 5) and steel moment frame (Gridline 6).

The proposed construction of the rear yard will consist of 16-inch concrete retaining walls on the east, south, and west sides (Gridlines A, D & 9). On the north side, the proposed 12-inch concrete retaining wall at Gridline 6 will also serve as wall bracing for the retaining walls along the east and west sides.

#### **Excavation and Shoring of Soil and Neighboring Structures**

In order to construct the proposed Level 1 and Level 2, it is expected that a 2-story deep excavation will occur along the east property line (the entire length of the proposed building) and along the west property line (from the point south of the west neighbor's garage). A shoring scheme was devised to protect adjacent buildings and their foundations during construction. Shoring along the east and west property lines will consist of 18-inch diameter drilled piers with 12-inch deep steel soldier beams embedded in each drilled pier. The piers are estimated to be spaced at 6 feet embedded into bedrock per the recommendations of the geotechnical engineer. This shoring scheme proposed will be installed prior to any excavation of soil for the subterranean levels.

#### Shoring of Existing Structure (Subject Building)

The shoring of the upper levels of the existing subject building, while the subterranean levels are being constructed, will consist of conventional house shoring techniques. Four lines of steel shoring beams will be placed in the longitudinal direction below the 2<sup>rd</sup> floor framing (approximately west of Line A, approximately east of Line C, and two interior lines near Line B). If necessary, the 3<sup>rd</sup> floor and roof framing can also be supported by the same line of steel beams. Steel shoring beams will be supported by conventional "cribbing" towers (consisting of criss-crossed 6x6 lumber) at 4 locations (one at the front of the building, one in the rear yard, and two evenly spaced in the interior of the building). Cribbing towers will be supported by temporary concrete footings. Prior to construction, it is expected that proper shoring drawings will be submitted to SFDBI for permit application by the shoring engineer.

Please do not hesitate to contact me with any questions regarding this memorandum.

Yours Sincerely



Page 3

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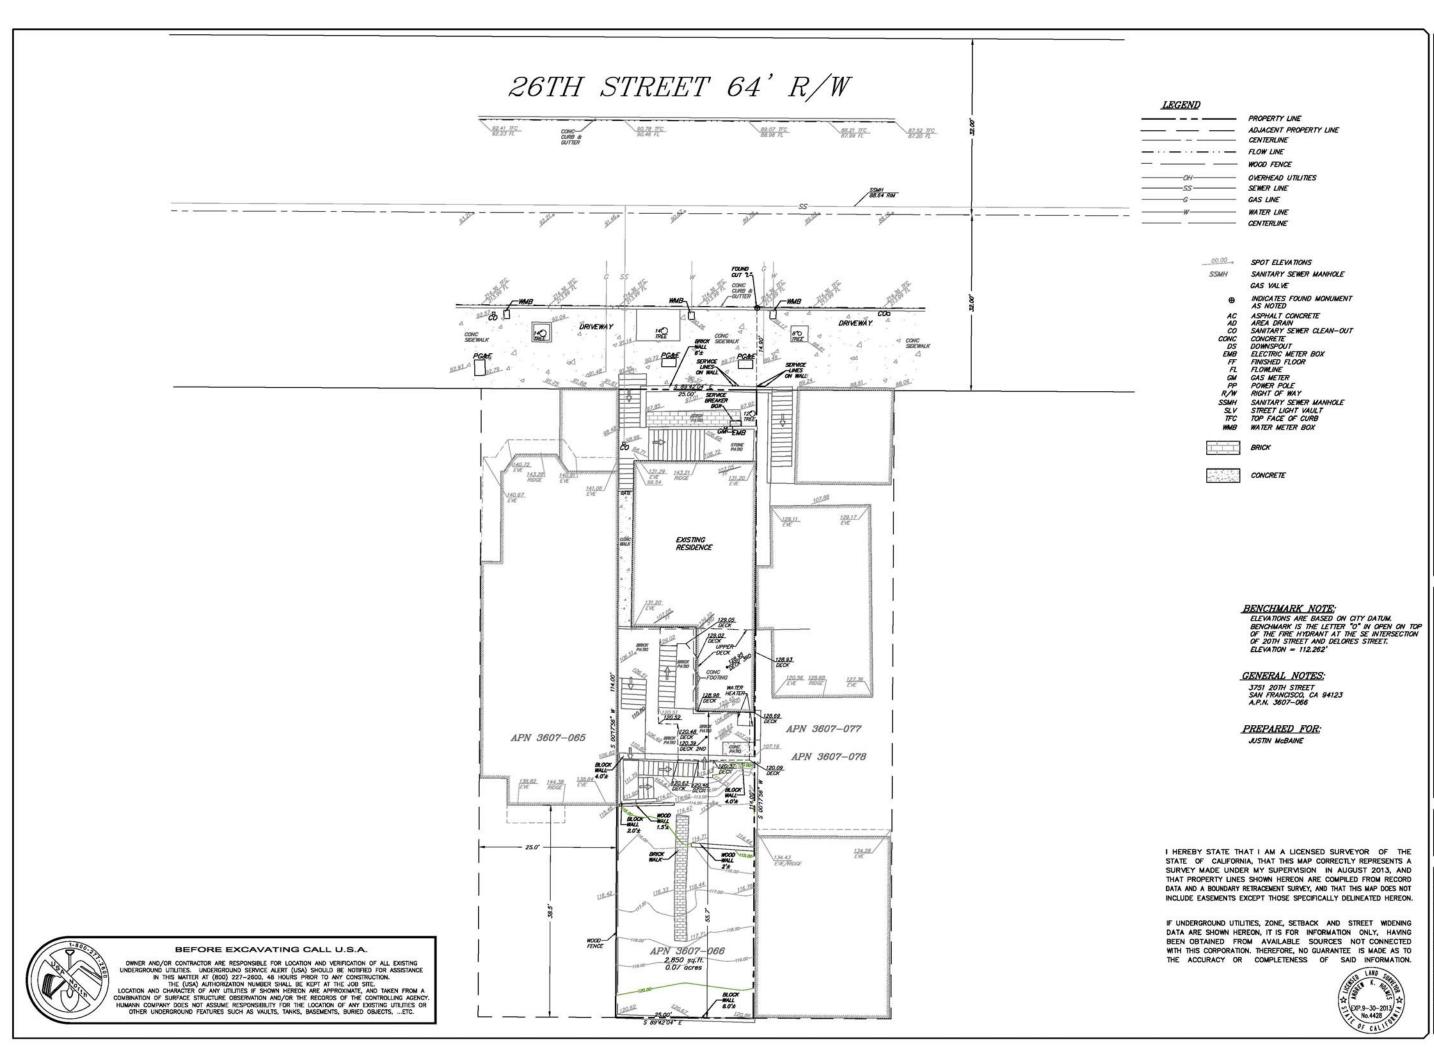
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SHEET TITLE:

STRUCTURAL **NARRATIVE** 

SHEET NUMBER:



TOPOGRAPHIC SURVEY

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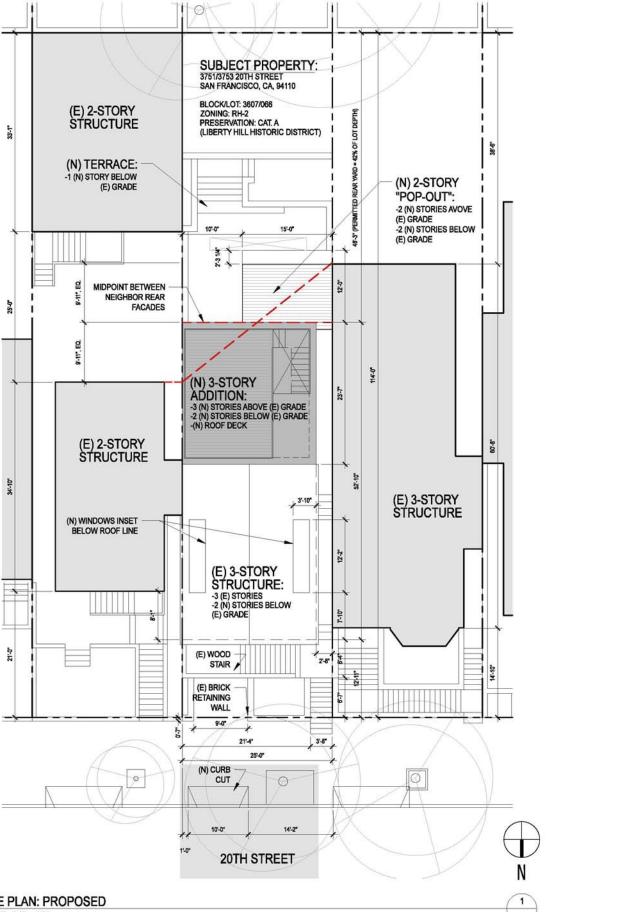
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SITE PERMIT


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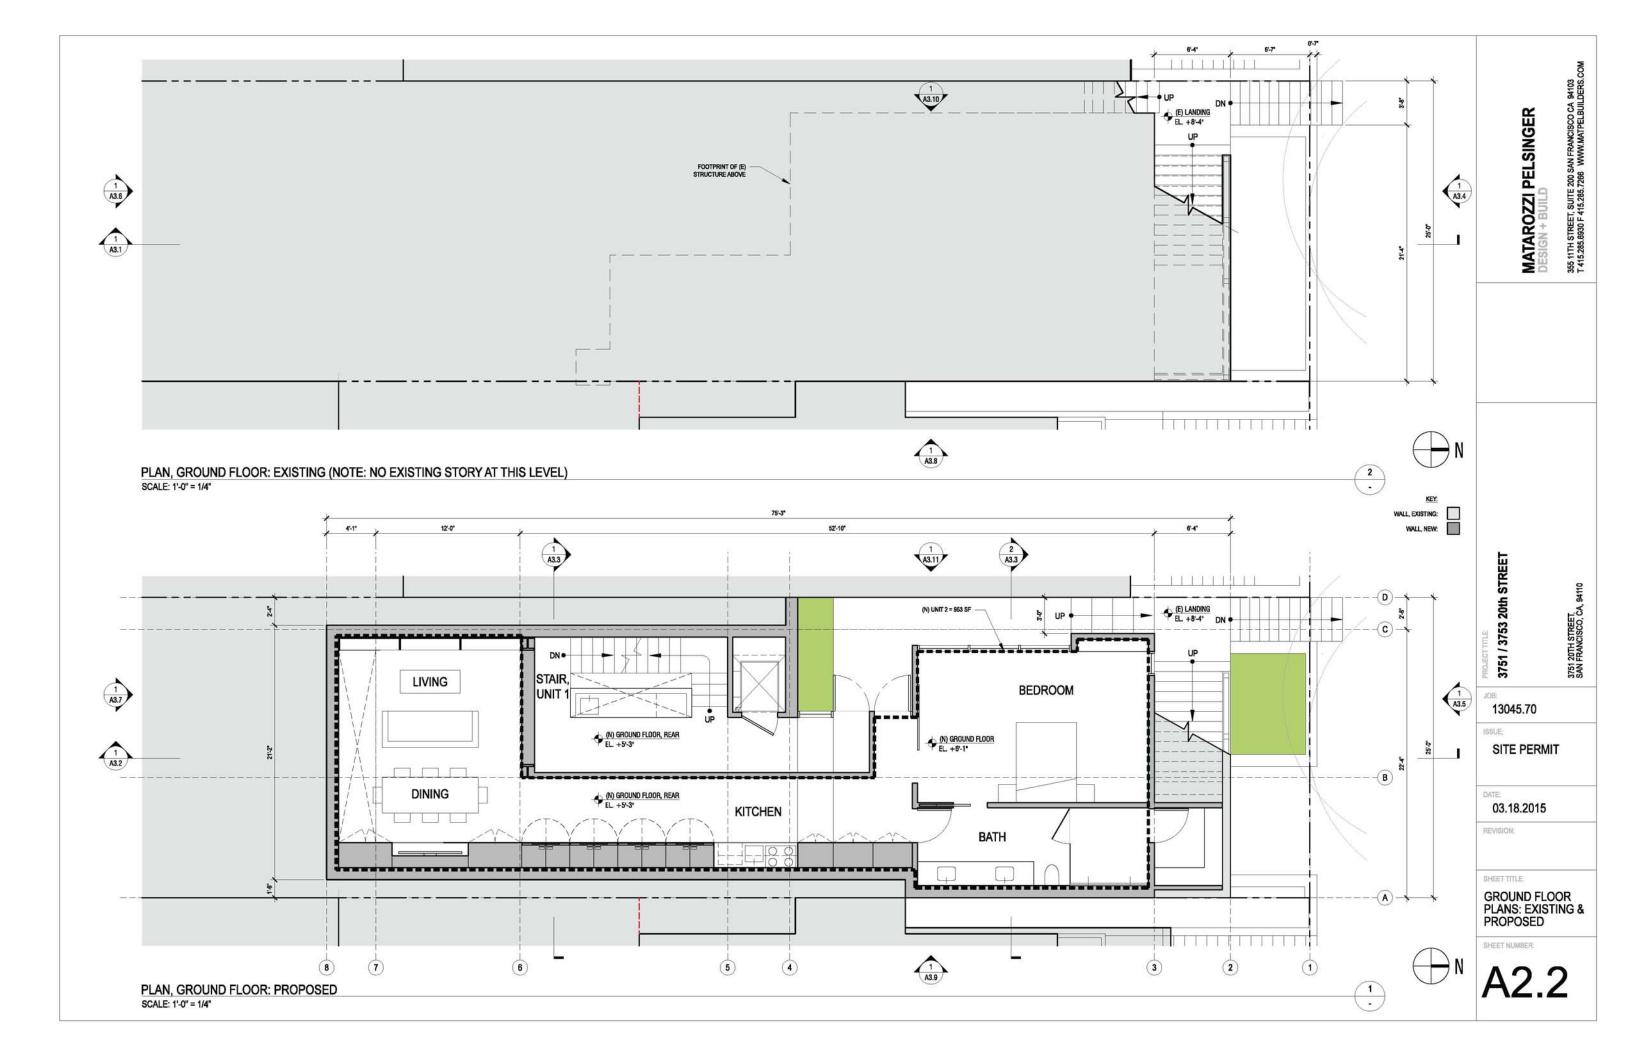
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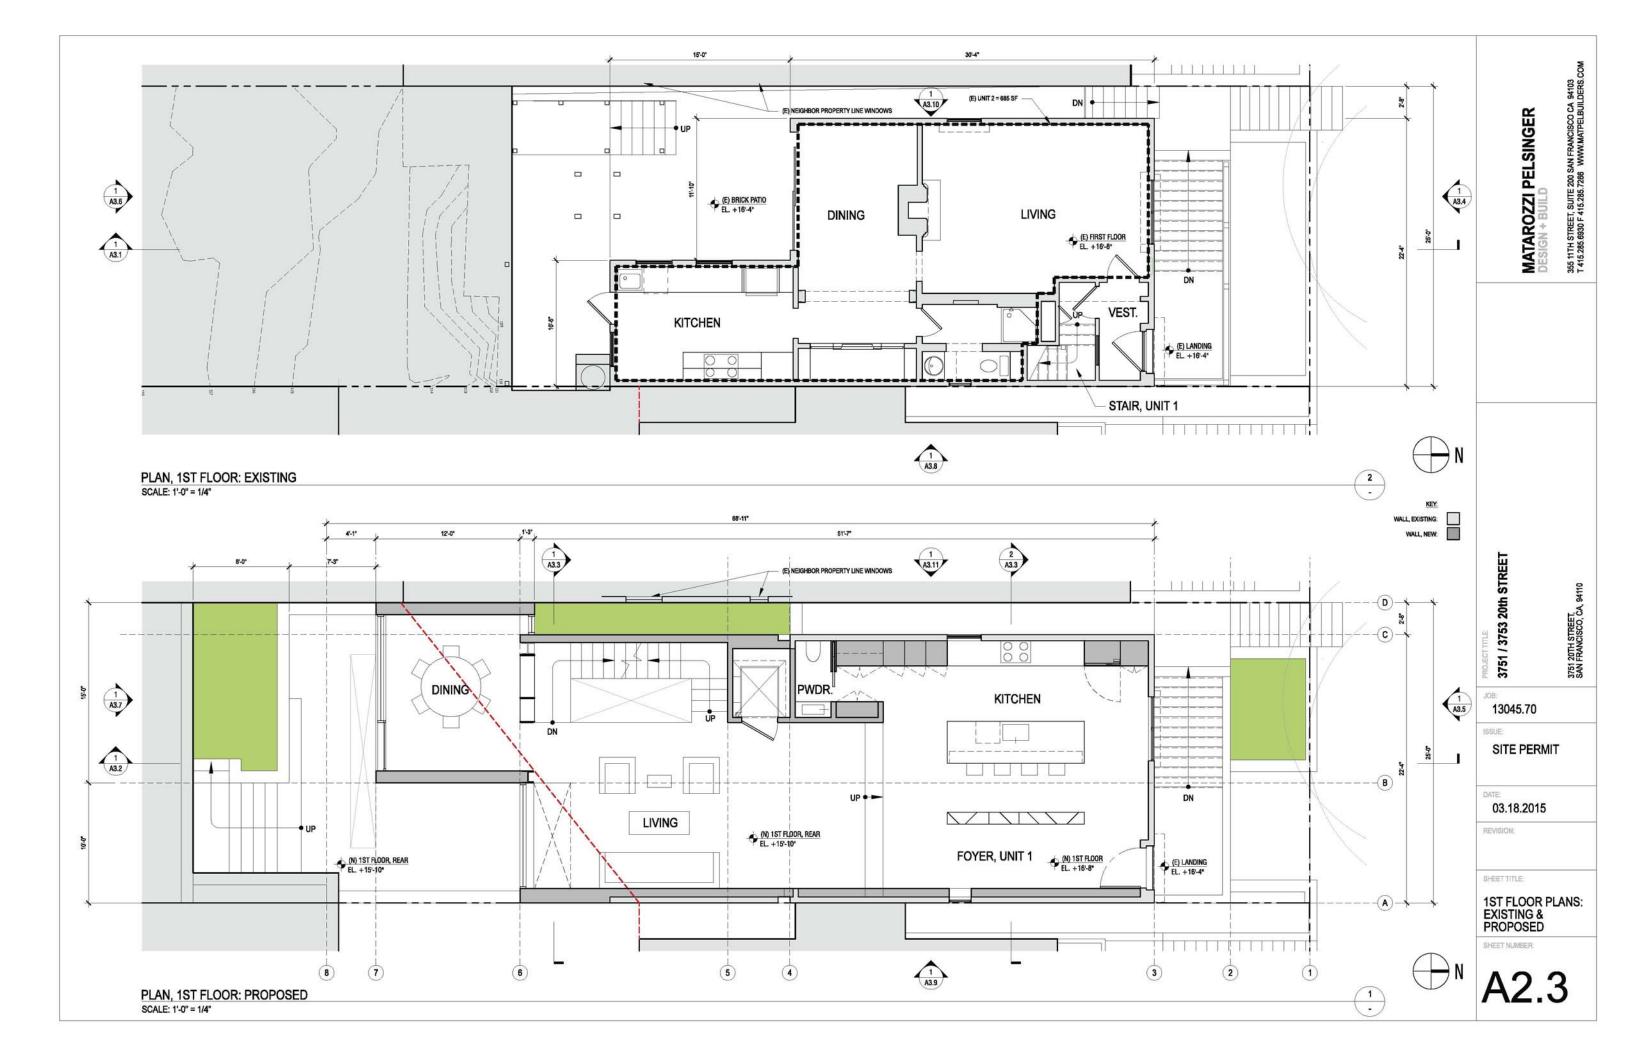
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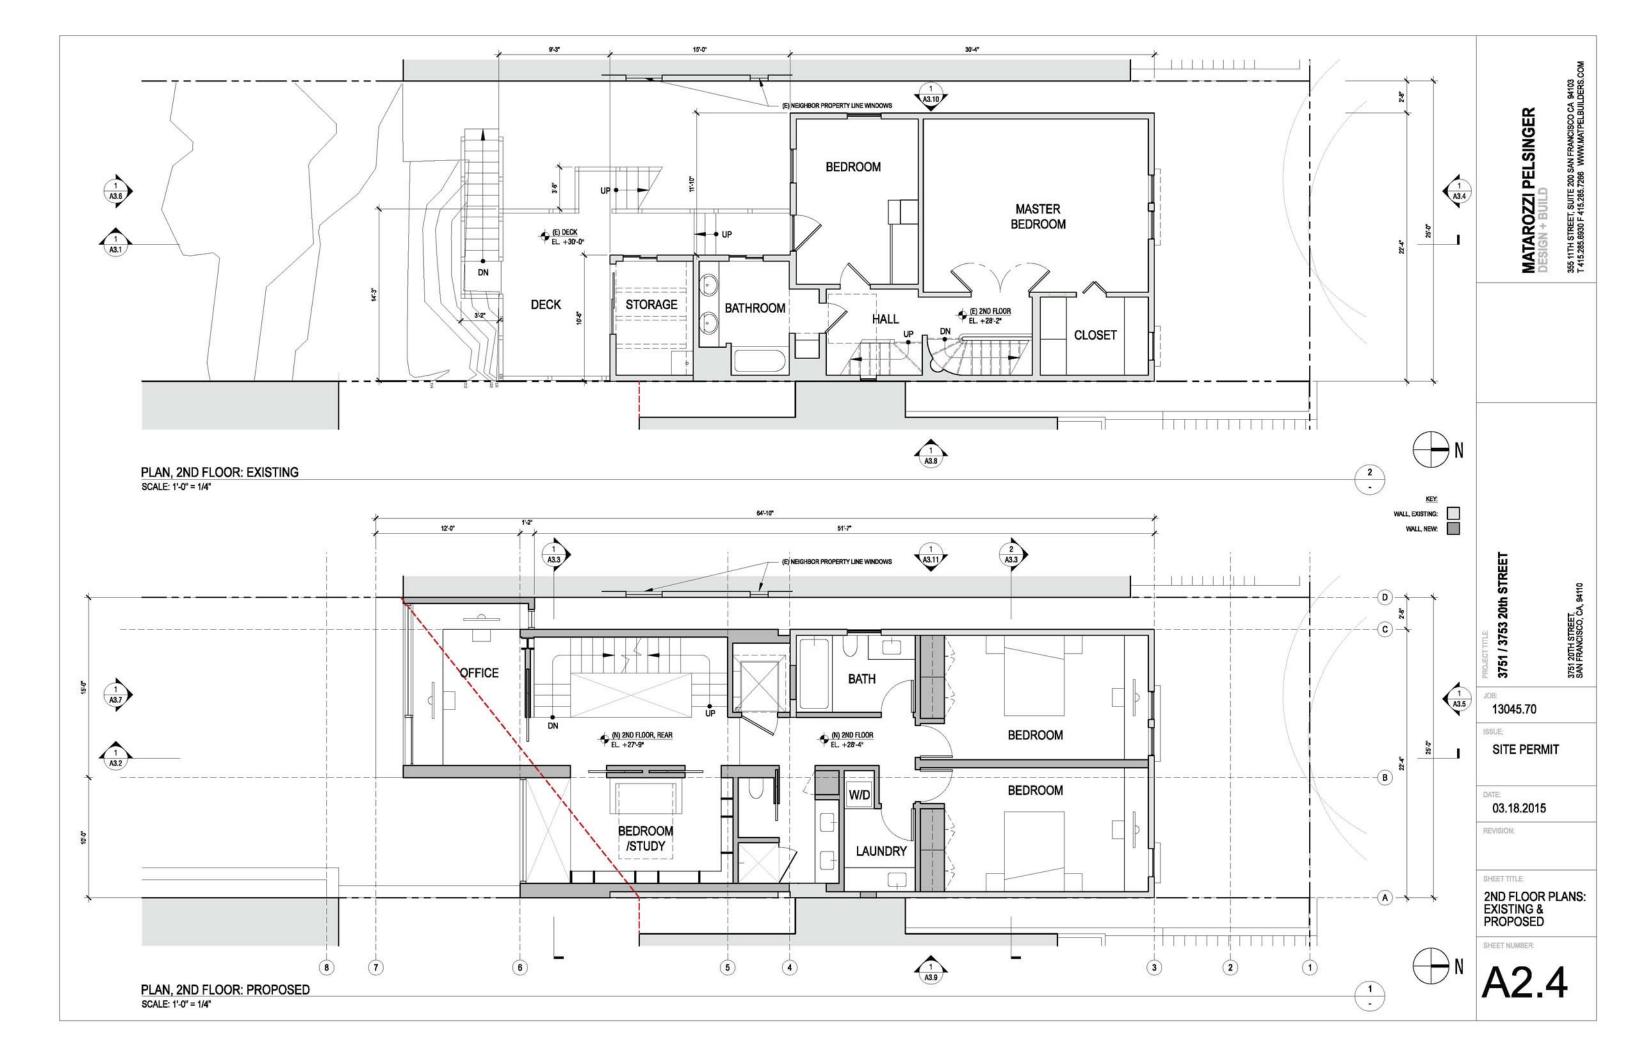
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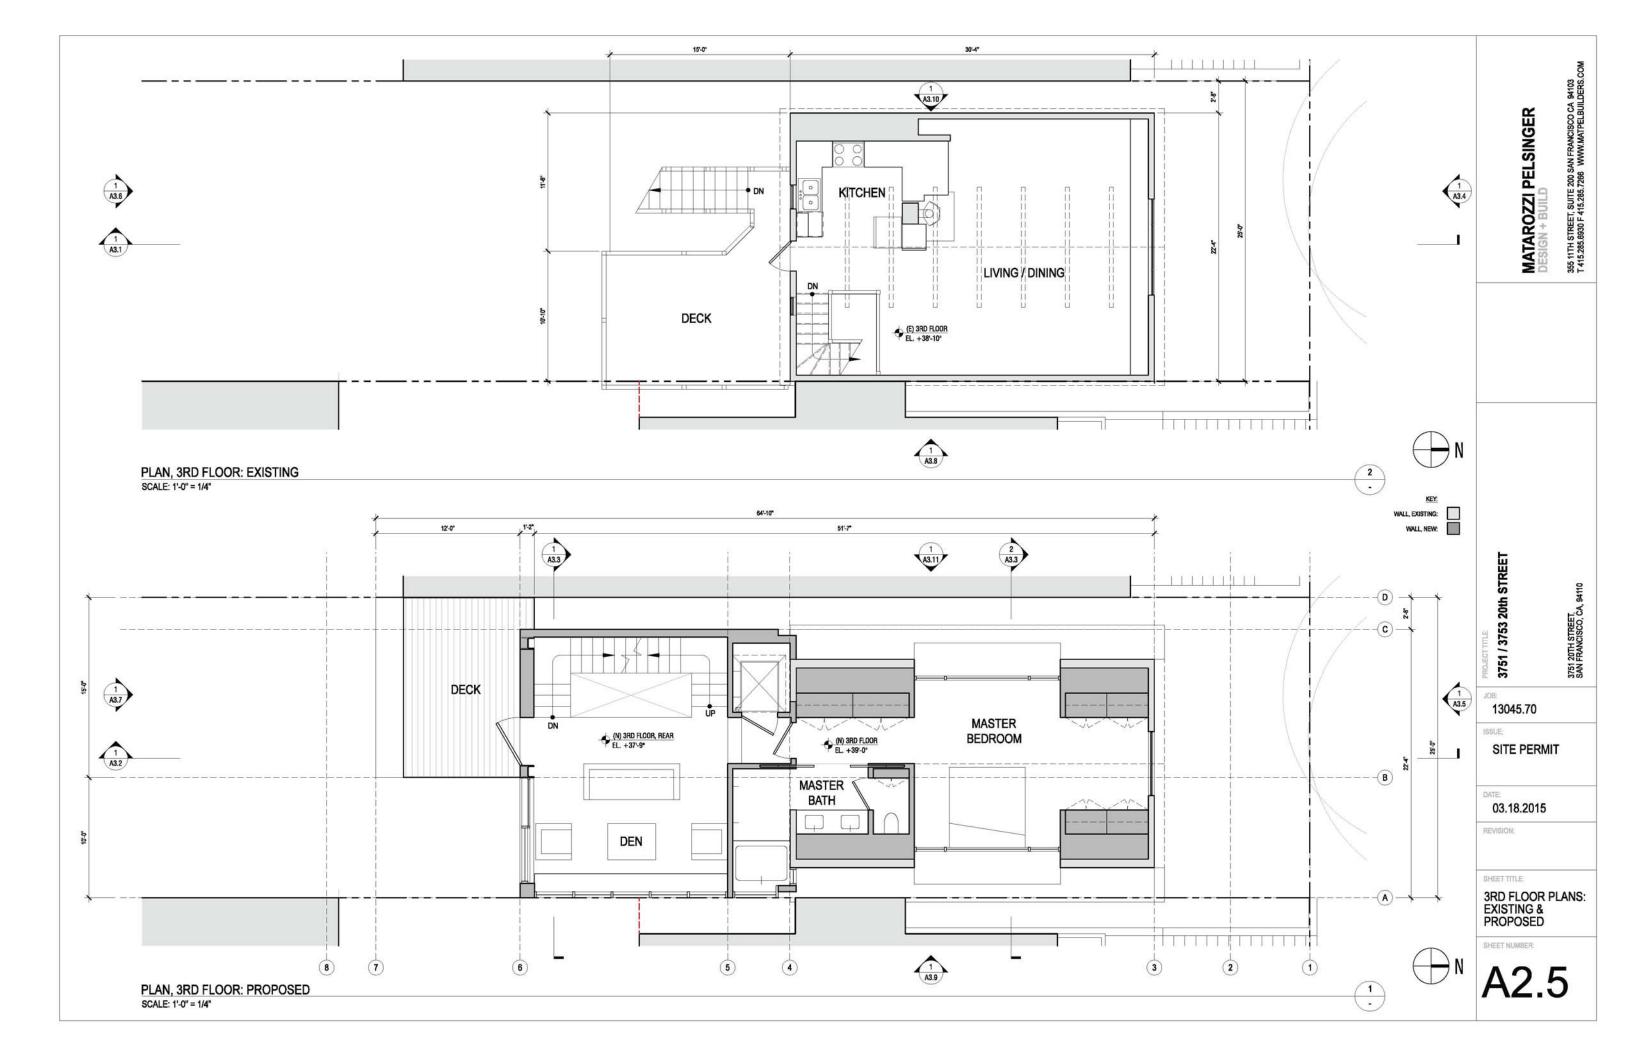
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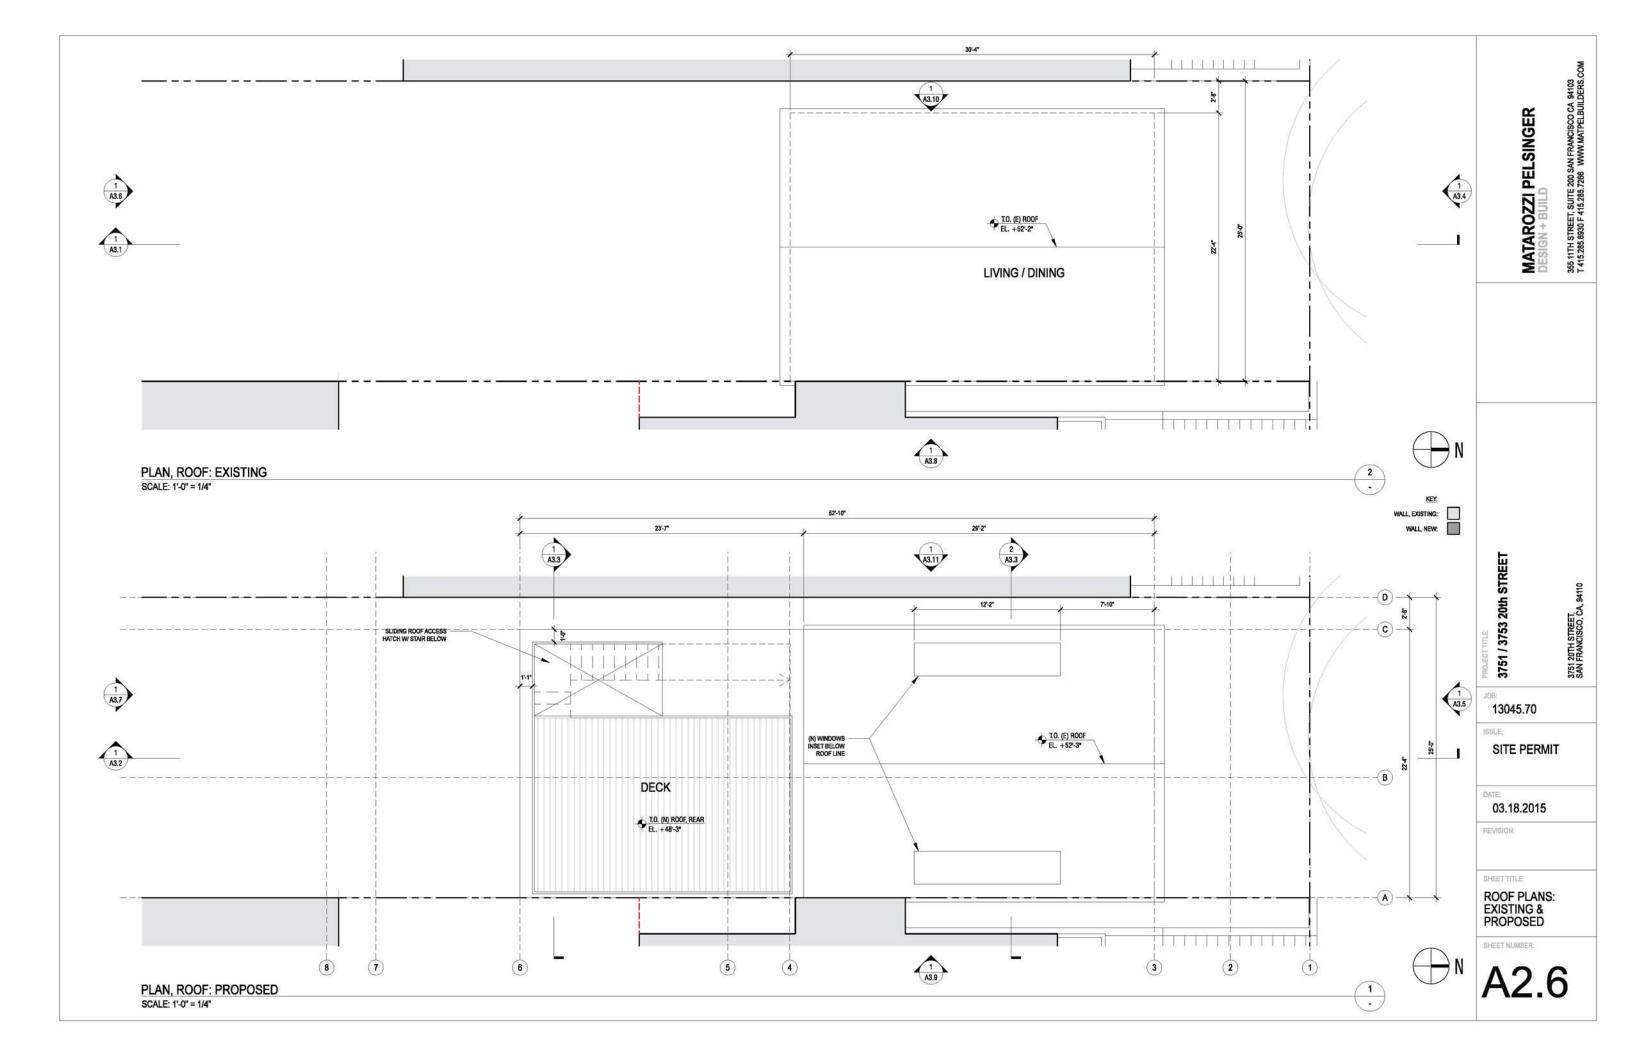













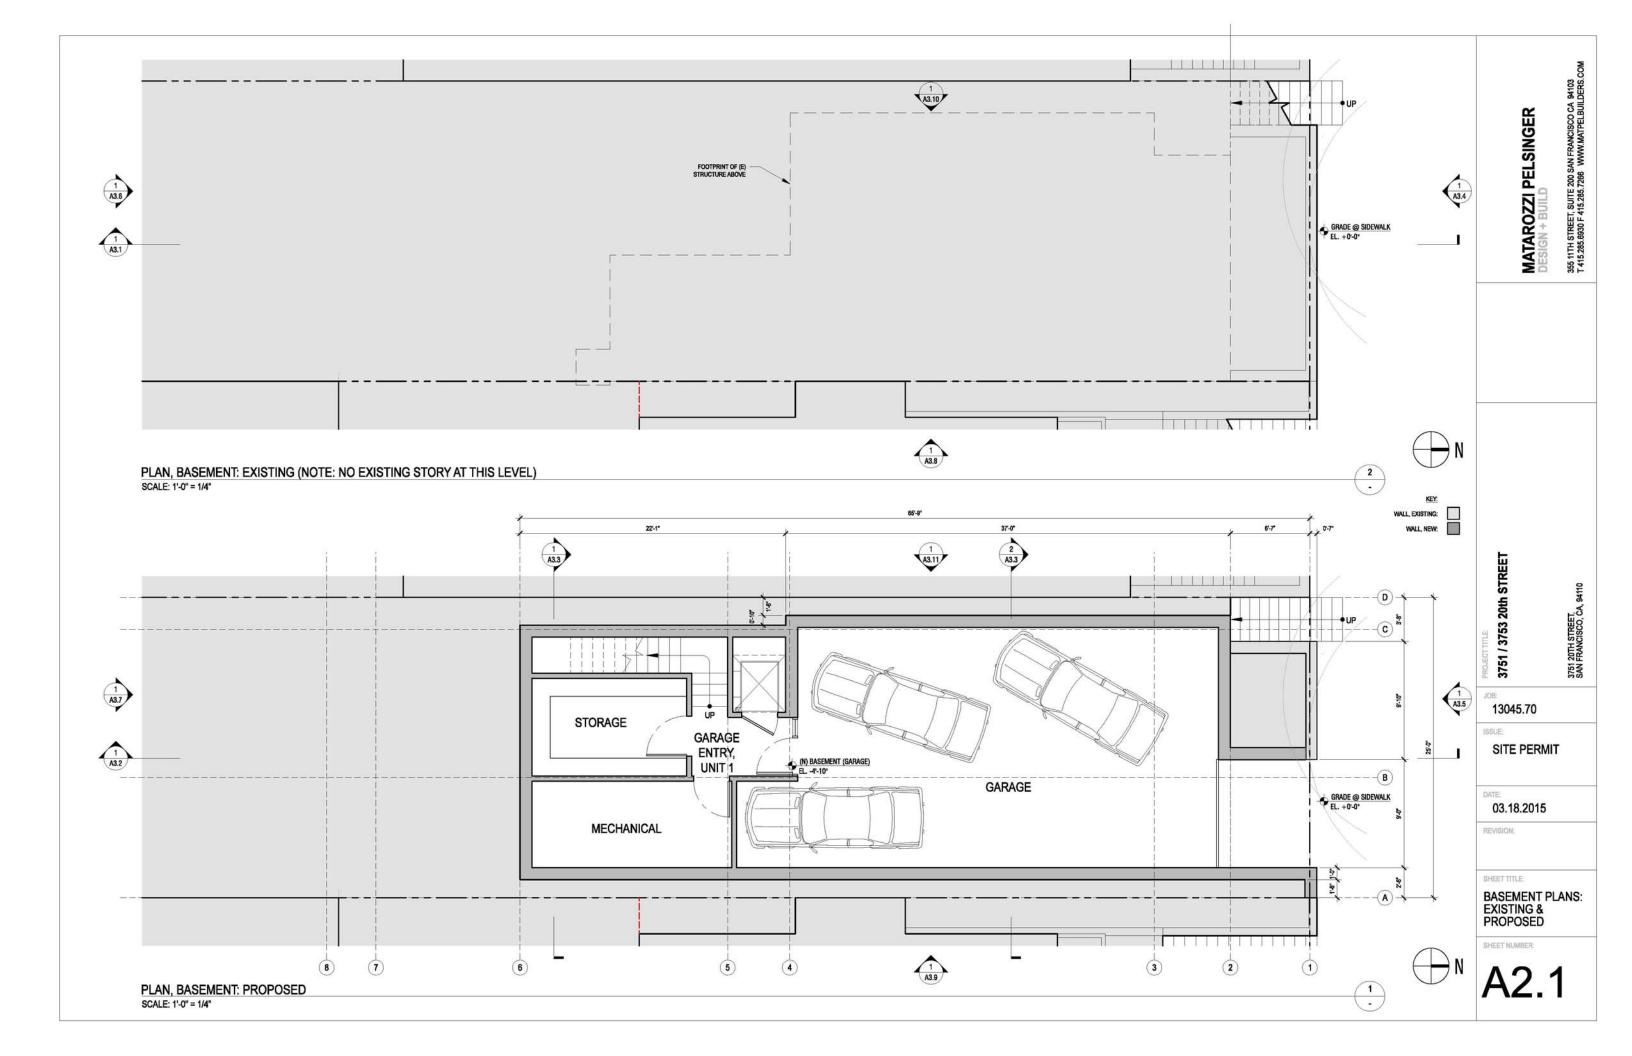

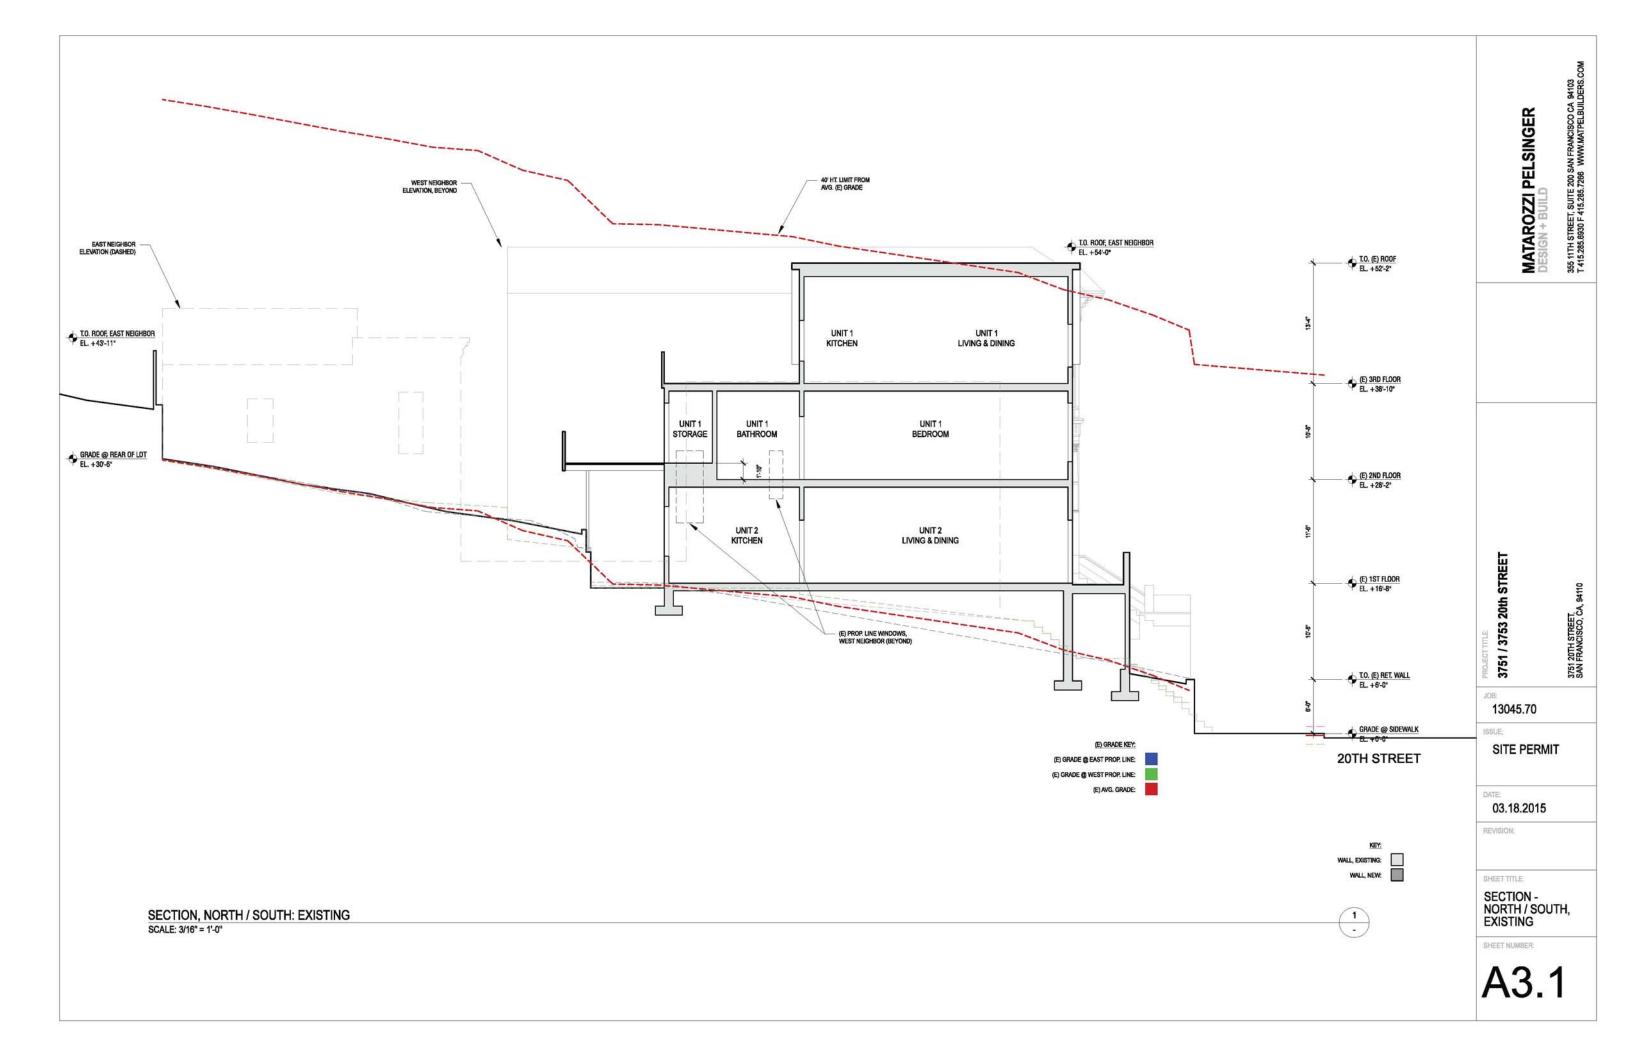

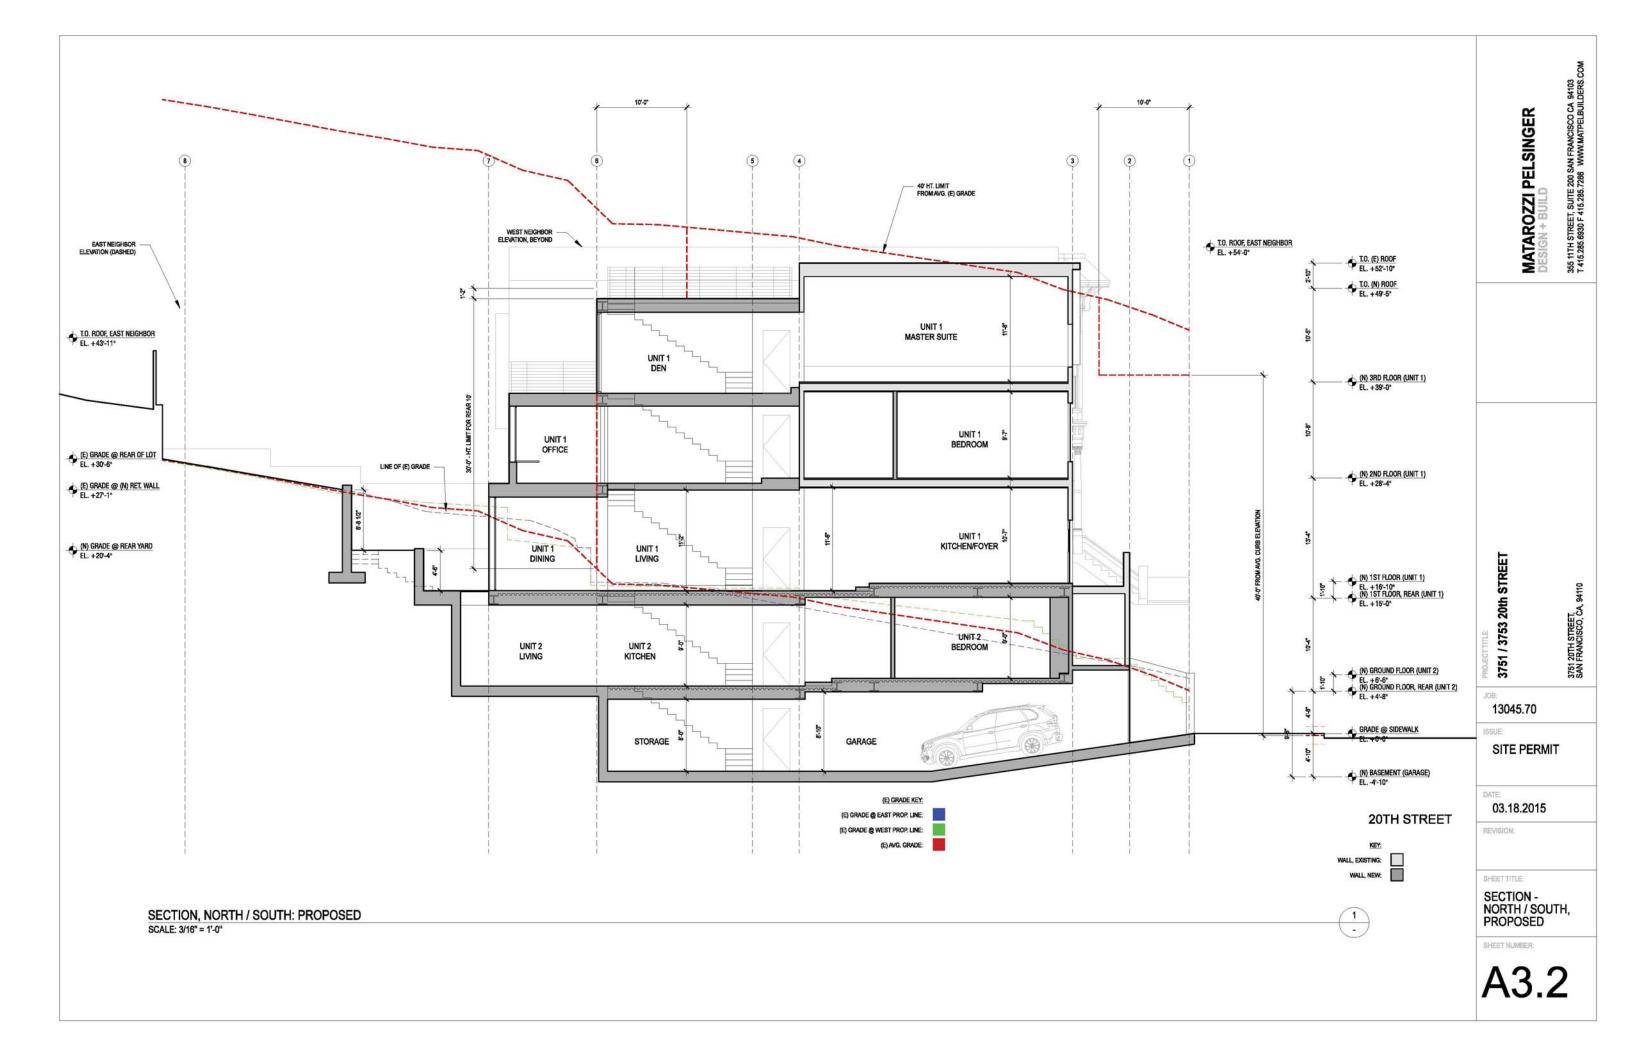

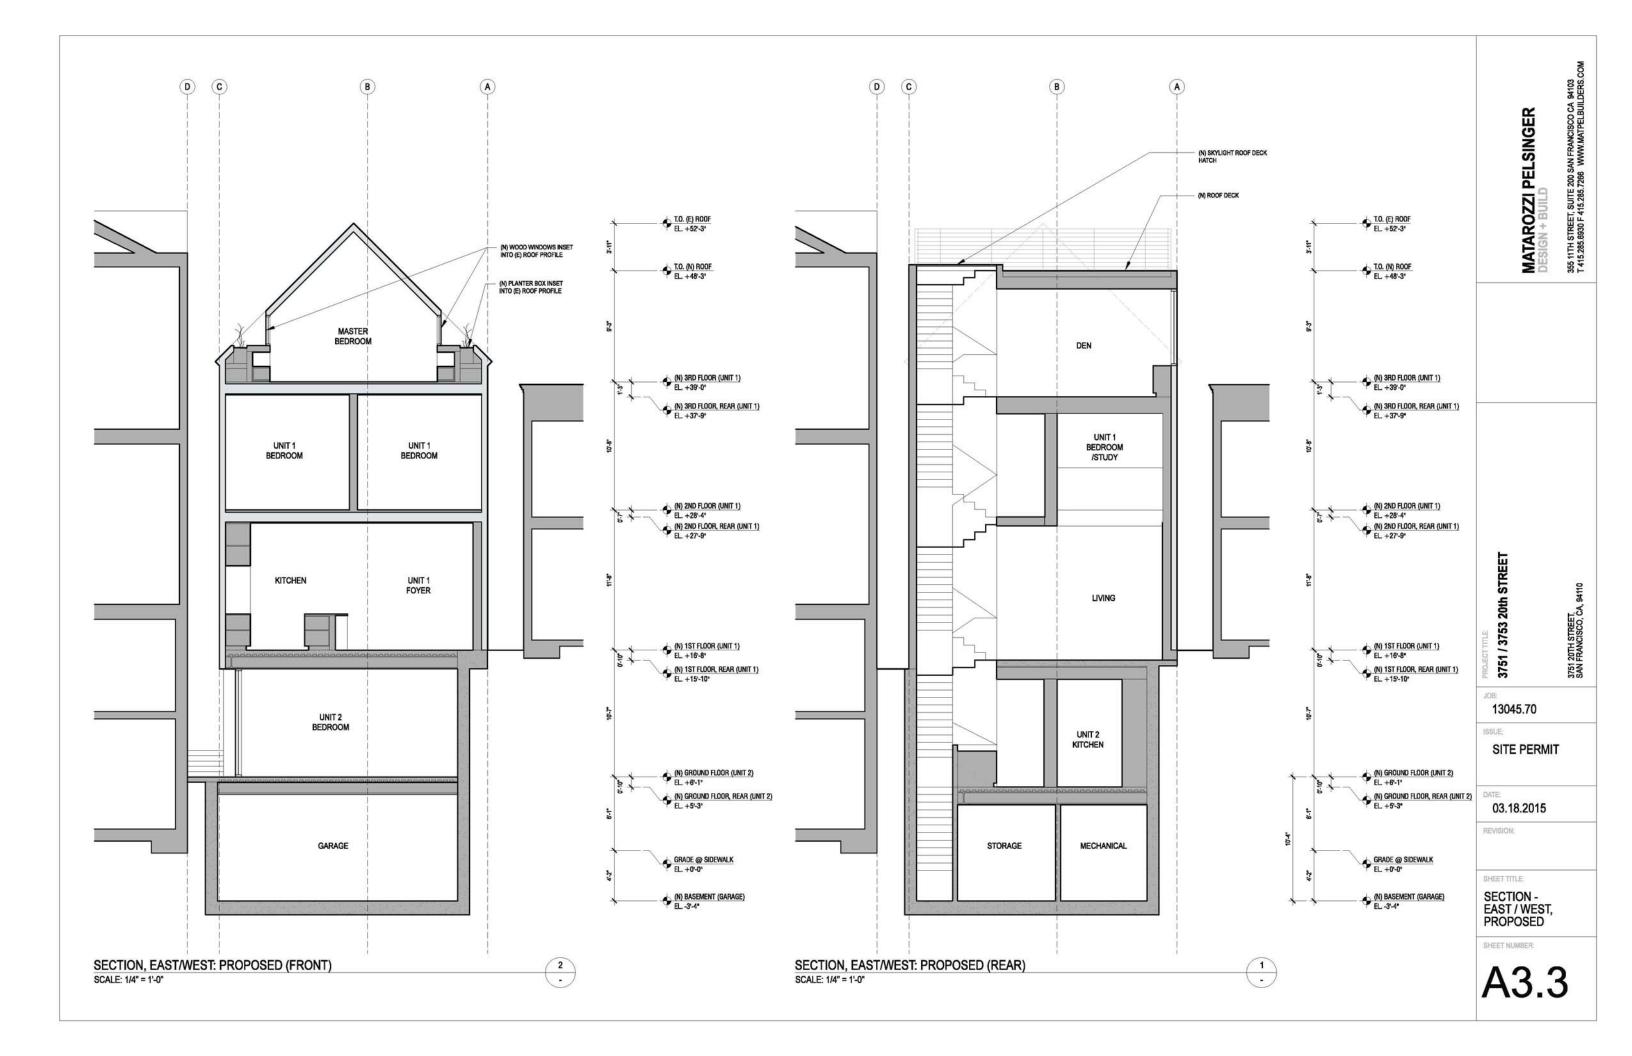



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SHEET TITLE: ELEVATION -NORTH, EXISTING

SHEET NUMBER:


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ELEVATION, NORTH: EXISTING

SCALE: 1/4" = 1'-0"





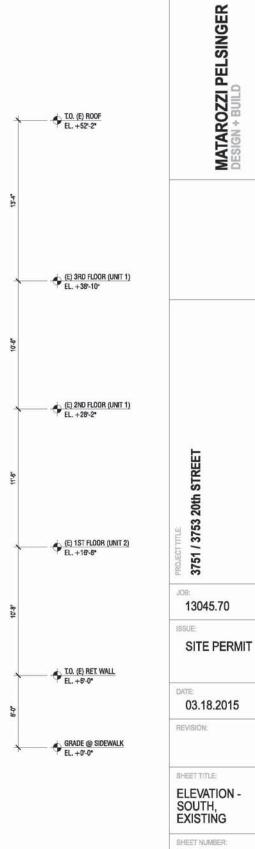


ELEVATION, SOUTH: EXISTING

SCALE: 1/4" = 1'-0"

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> 3751 20TH STREET, SAN FRANCISCO, CA, 94110



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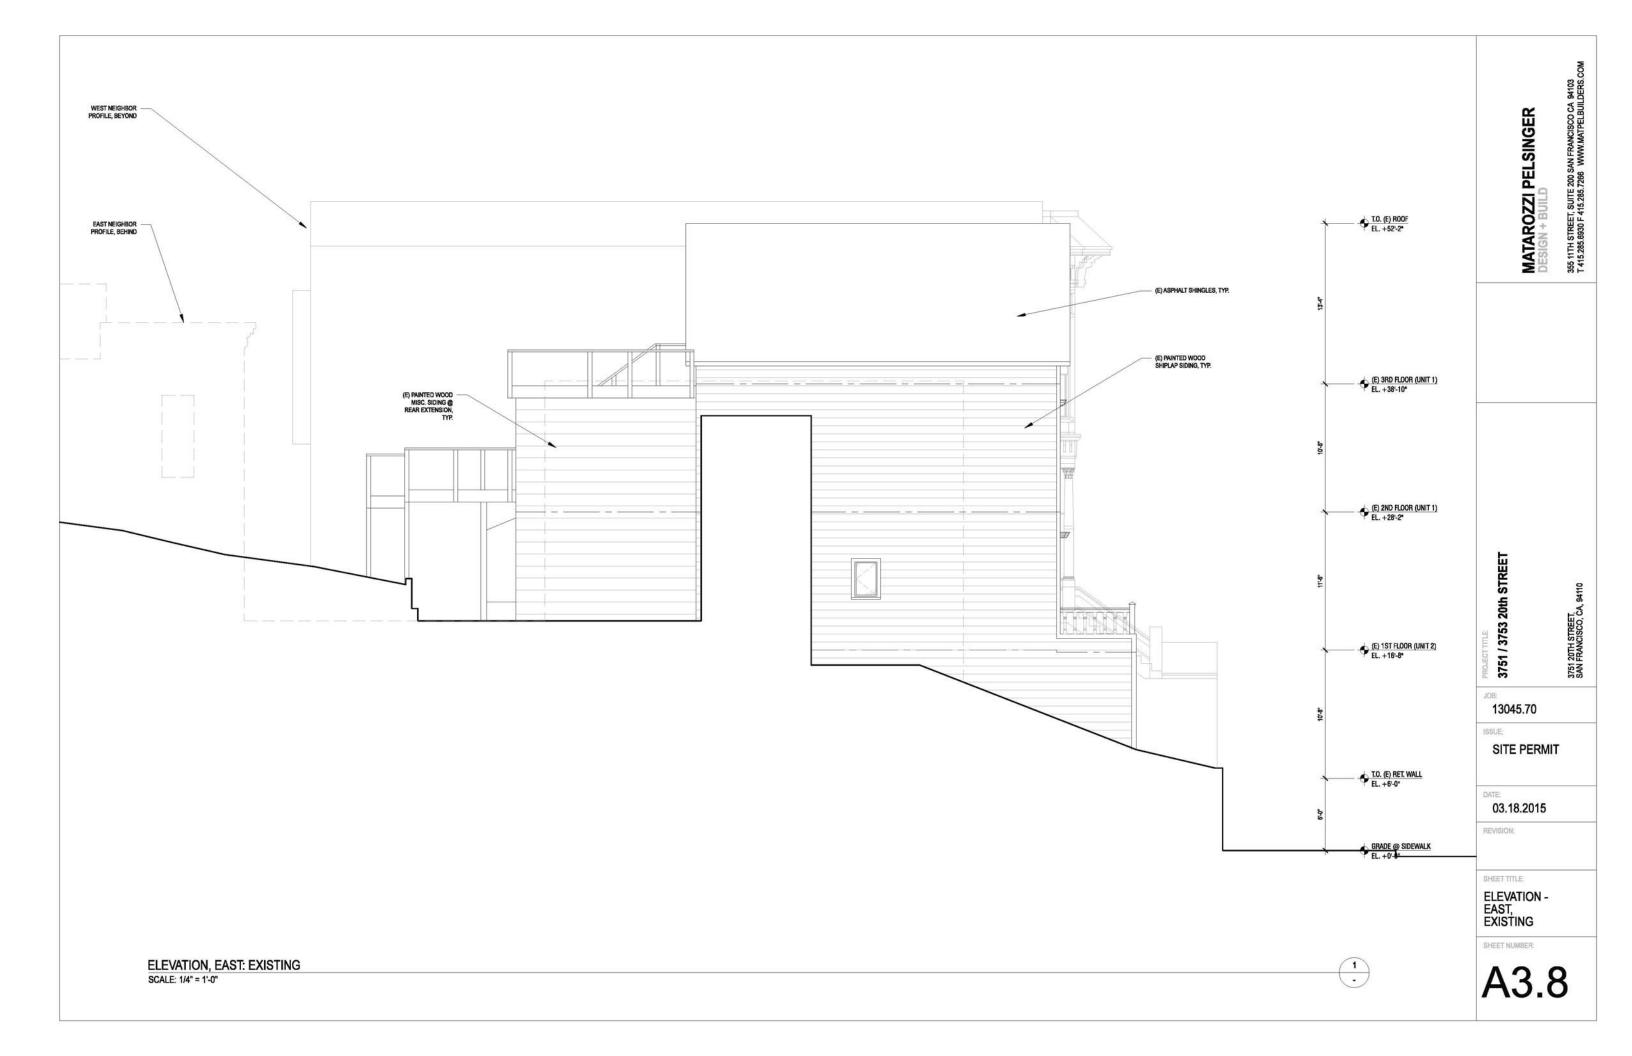
ELEVATION -SOUTH, PROPOSED

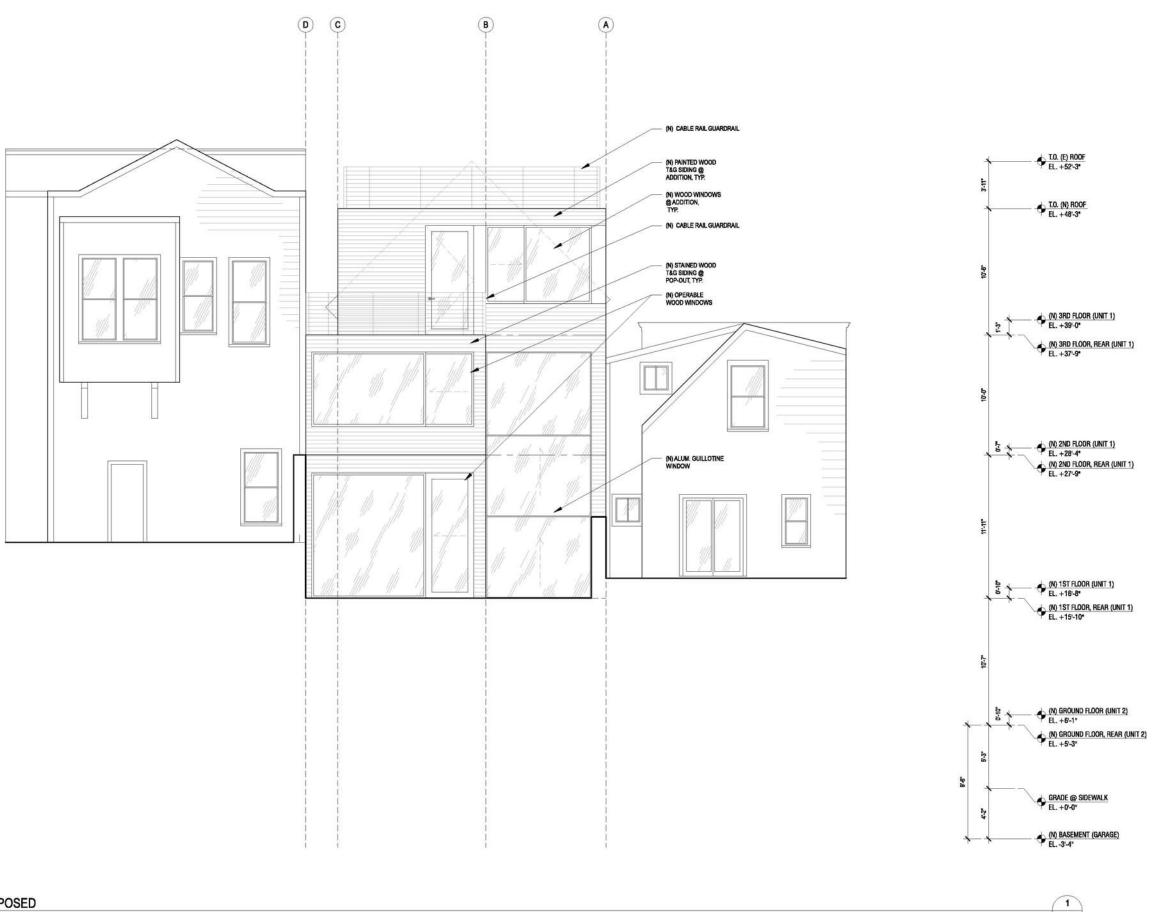
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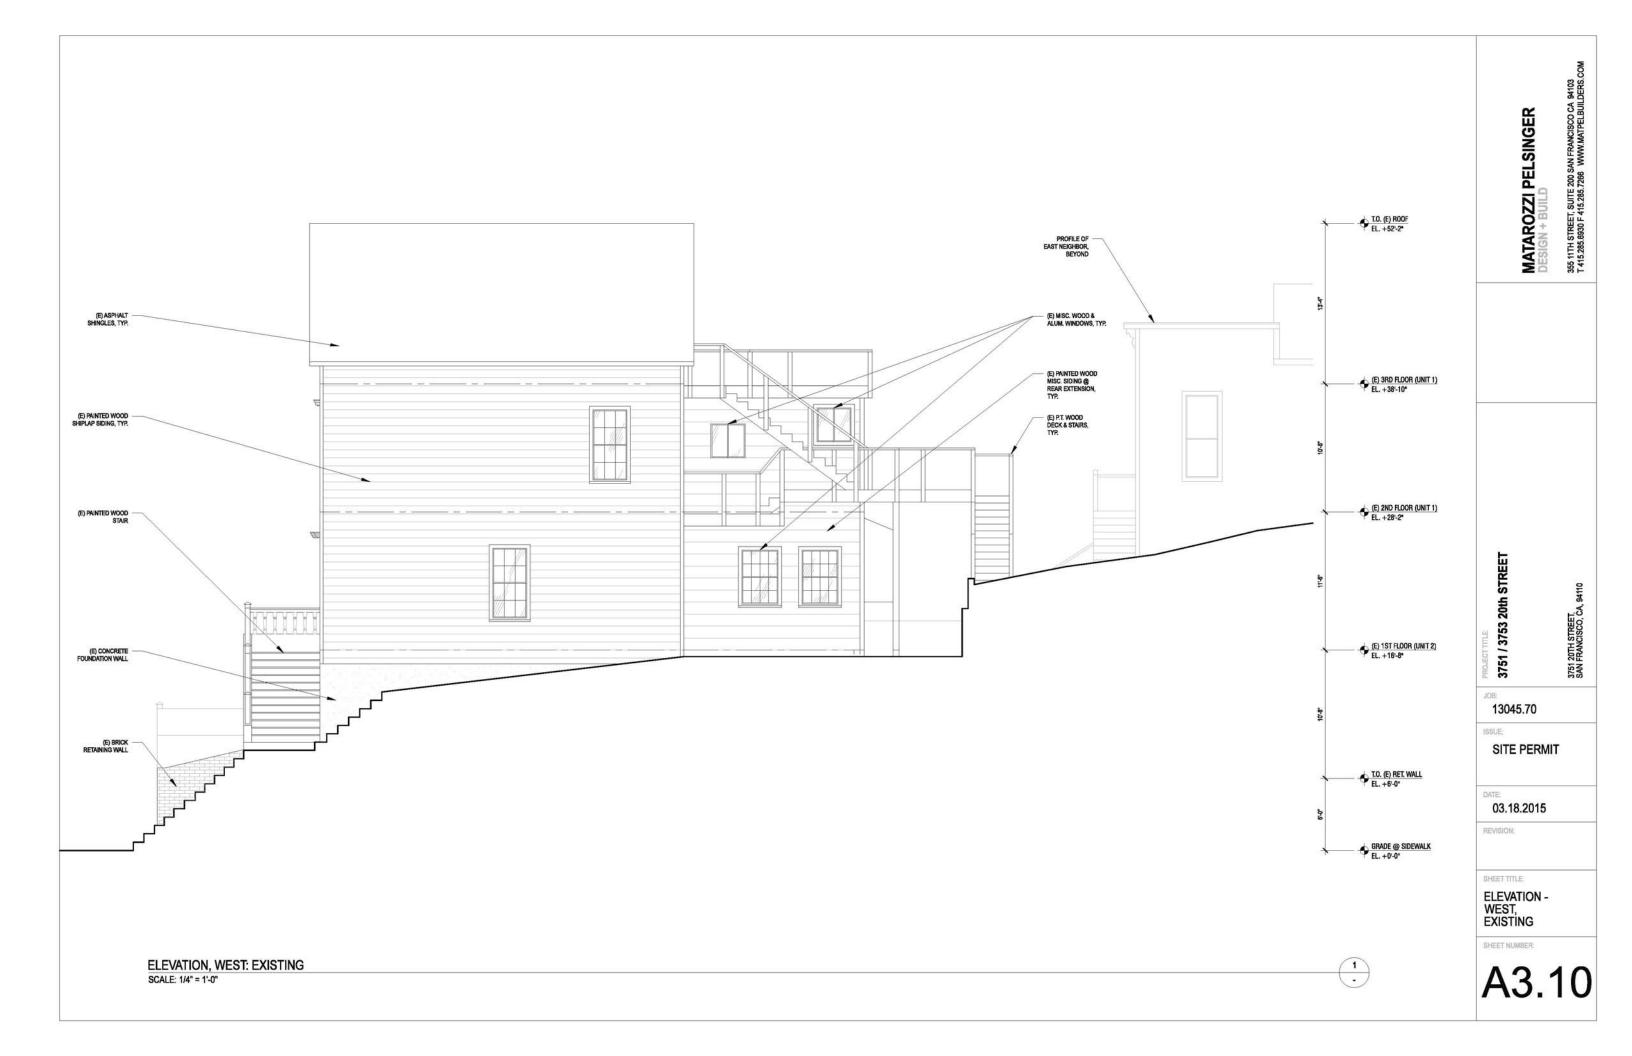
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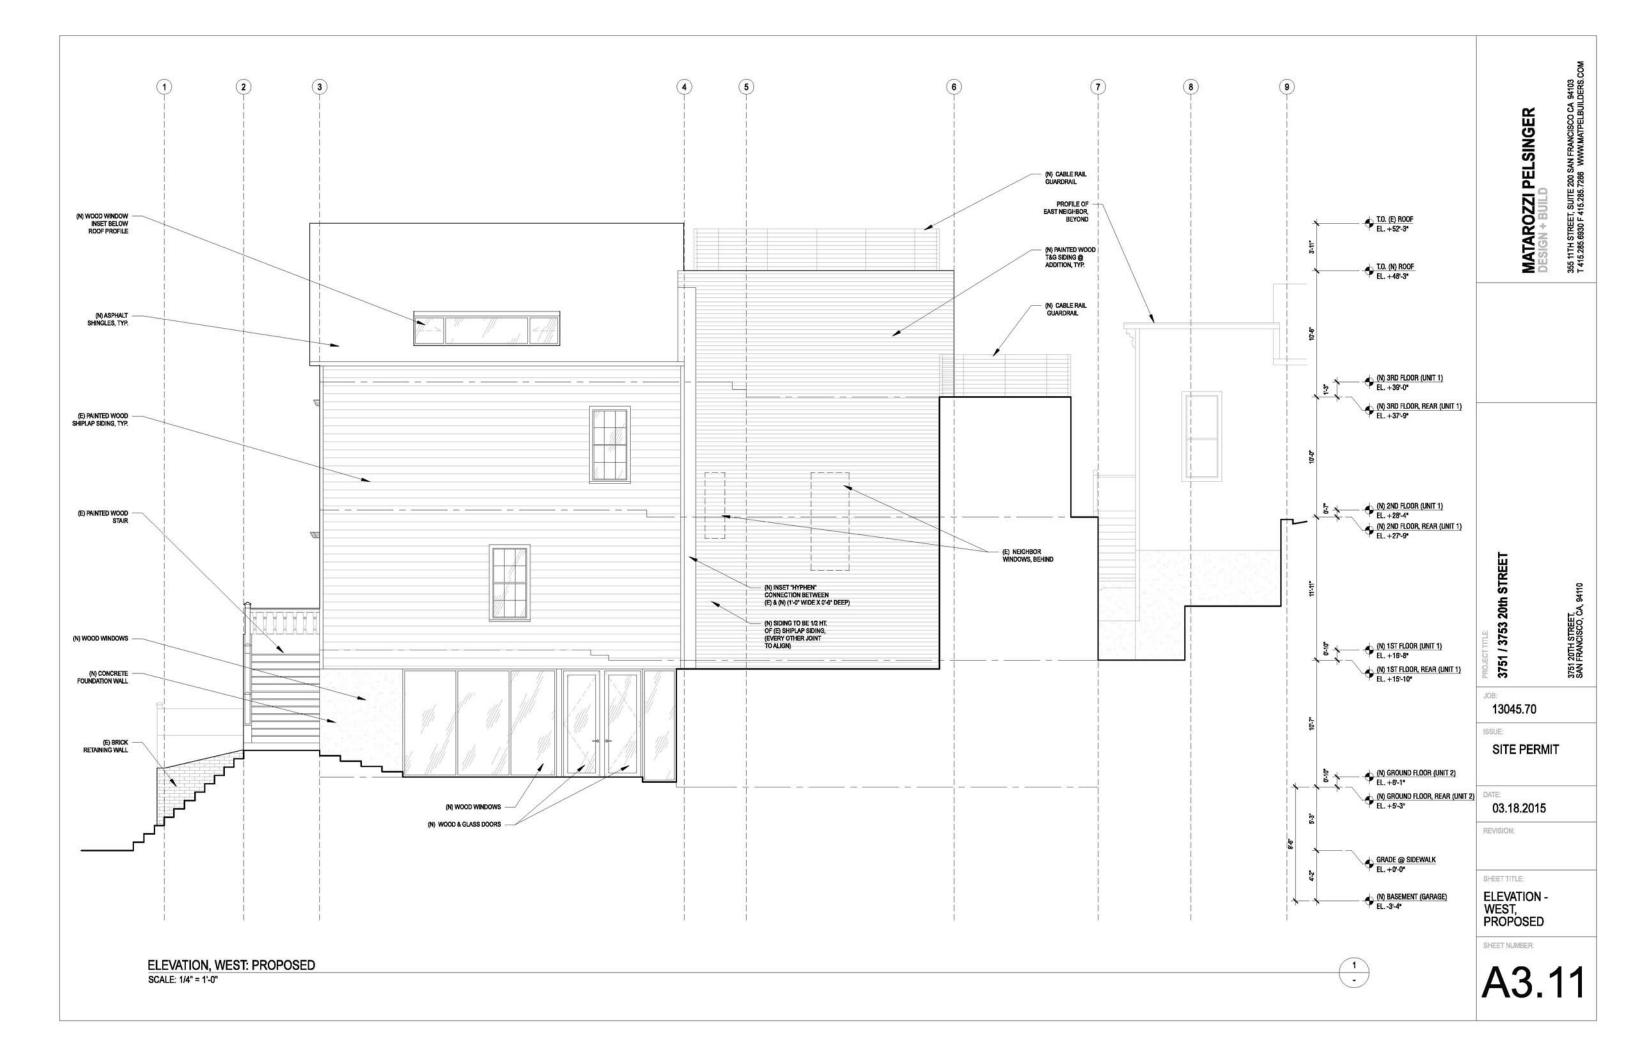
ELEVATION, SOUTH: PROPOSED

SCALE: 1/4" = 1'-0"







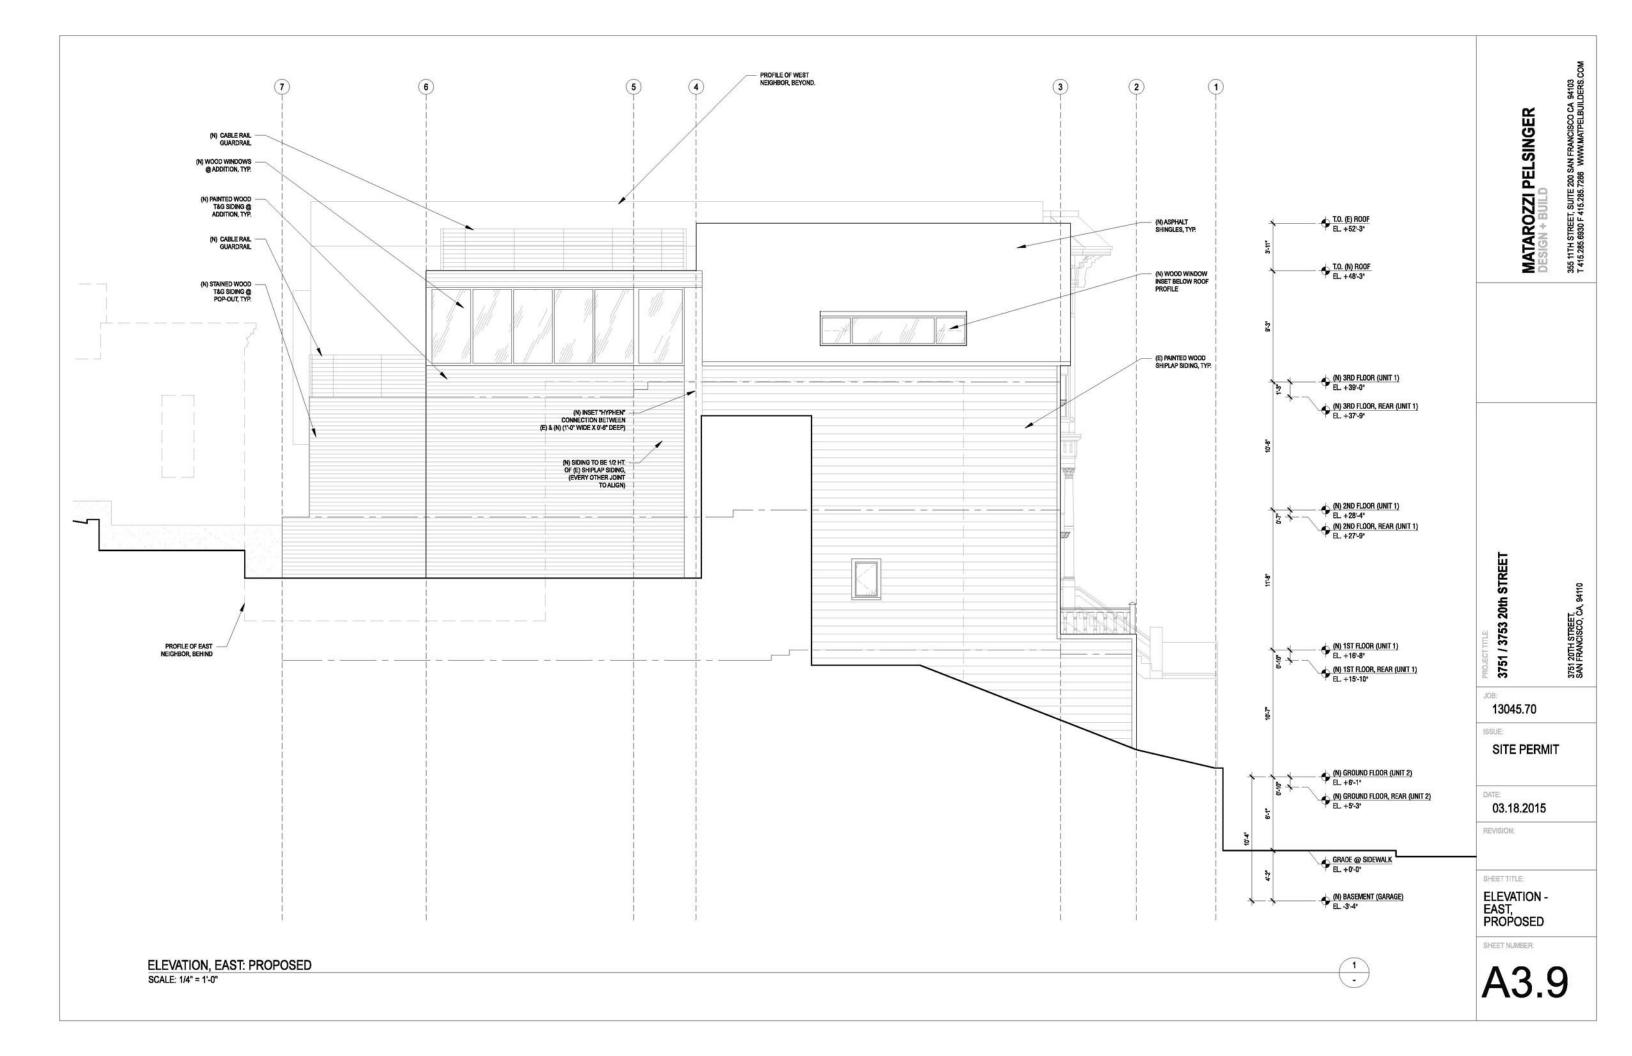

3751 / 3753 20TH STREET: PERSPECTIVE VIEWS MARCH 24, 2015 McBAINE RESIDENCE 3751 / 3753 20<sup>TH</sup> STREET MATAROZZI PELSINGER DESIGN + BUILD

























Original Proposal – 3751-3753 20<sup>th</sup> Street (dated November 4, 2014)

# **ABBREVIATIONS**

ADDR	EVIATIONS	
& ABV. AC.T. ADJ. ADJ.C. AFF. ALL. ANOD. APPROX. ARCH. AXON.	AND AT ABOVE AR CONDITIONING ACOUSTIC CEILING TILE ADJUSTABLE ADJACENT ABOVE FINISHED FLOOR ALTERNATE ALJUNINUM ANODIZED APPROXIMATE ACCHITECTURAL AXONOMETRIC	(N) NAT. N.I.C. NO. # NOM. N.T.S. OBSC. O.C. O.D. O.H. OPER. OPP.
BD. B.J. BLDG. BLKG. B.O. B.P. BRZ. B.U.R.	BOARD BUTT-JOINT BUILDING BLOCKING BOTTOM OF BUILDING PAPER BRONZE BUILT-UP ROOF	PART. PERF. PL. P.L. P.LAM. PLAS. PLY.
CAB. CER. CHAN. C.I.P. C.L. CLG. CLG. CLG. CLG. CLG. CMU. CONC. CONT. CONT. CPT.	CABINET CEMENT CERAMIC CHANNEL CAST-IN-PLACE CENTERLINE CLEAR CELING CLOSET CLEAR CONCRETE MASONRY UNIT COLUMN CONCRETE CONTINUOUS CARPET CENTER	PNT. PROP. PTD. PT. P.V. R. R. B. P. REF. REF. REFIN. REQD. REV. RM
DEPT. DET. D.F. DIA. DIM. DN. DR. DW. DWG.	DEPARTMENT DETAIL DOUGLAS FIR DIAMETER DIMENSION DOWN DOOR DISHWASHER DRAWING	R.O. RTD. R.W.L. S.C. SCHED. S.A SECT. S.E.D.
(E) EA. ELEV. ELECT. ENGR. EQ. EQPT. EXEC. EXP. EXT.	EXISTING EACH ELEVATION ELEVATION ELECTRICAL ENGINEER EQUIAL EQUIPMENT EXECUTIVE EXPANSION EXTERIOR	SHT. SHTG. SIM. S.L.D. S.M.D. S.P.D. S.P.E. S.S. S.S.D. STD. STL. STOR.
FAB. F.B.O. F.D. FIN. FIXT. F.O. F.O.F. F.O.C. FRM. FRMG. FT. FURR.	FABRIC FURNISHED BY OWNER FLOOR DRAIN FINISH FIXTURE FLOOR FINISHED OPENING FACE OF FINISH FACE OF STUD FACE OF CONCRETE FRAME FRAME FOOT OR FEET FURRING	STRUCT. SUSP. SYM. T.B.D. TEL. TEMP. TEMP. TF.WD. T&G. TO. T.O.C. T.O.C.
GA. GALV. G.D. GEN. GL. GYP. G.W.B.	GAUGE GALVANIZED GARBAGE DISPOSAL GENERAL CLASS GYPSUM GYPSUM WALL BOARD	TRANS. TV. TYP. U.B.C. U.C. U.O.N. UTIL
H.B. H.C. HDWD. HT. HORIZ. HR. H.M. H.W.	HOSE BIB HOLLOW CORE HARDWOOD HEIGHT HORIZONTAL HOUR HOLLOW METAL HOT WATER	VAR. V.T. VEN. VERT. VEST. VI.F. VP.
I.D. IN. INSUL. INT.	INSIDE DIAMETER INCH INSULATION INTERIOR	W/C. WD. W/D
JAN. JT.	JANITOR JOINT	WIN. W.H. W/O
KIT.	KITCHEN	W.O. W.P. WT.
LAM, LAV, LOC, LTWT, LVL.	LAMINATE LAVITORY LOCATION LIGHTWEIGHT LEVEL	270
MAT. MAX. M.B. M.C. MECH. MEMB. MFR. MIN. MIR. MISC. MSRY. MTL.	MATERIAL MAXIMUM MOISTURE BARRIER MEDICINE CABINET MECHANICAL MEMBRANE MANUFACTURER MINIMUM MIRROR MISCELLANEOUS MASONRY MOUNTED METAL	

# **SYMBOLS**

NEW
NATURAL
NOT IN CONTRACT
NUMBER
NUMBER
NOMINAL
NOT TO SCALE

OBSCURE
ON CENTER
OUTSIDE DIAMETER
OPPOSITE HAND
OPERABLE
OPENING
OPPOSITE

PARTITION
PERFORATED
PLATE
PLASTIC LAMINATE
PLASTIC LAMINATE
PLASTER
PLYMOOD.
PANEL
PAINT
PROPERTY
PAINTED
PRESSURE TREATED
PHOTOVOLTAIC

RADIUS
RISER
RESILIENT BASE
RESILIENT BASE
REFLECTED CEILIING PLAN
REFERENCE
REFRIGERATOR
REFINISH
REINEORCED

REFINISH REINFORCED REQUIRED REVISION/REVISED ROOM ROUGH OPENING RATED RAIN WATER LEADER


RAIN WATER LEADER
SOLID CORE
SCHEDULE
SOAP DISPENSER
SECTION
SEE ELECTRICAL DRAWINGS
SHEET
SHEATHING
SEE LANDSCAPE DRAWINGS
SEE MECHANICAL DRAWINGS
SEE PLUMBING DRAWINGS
SPECIFICATION
STAINLESS STEEL
STONG
STANDARD
STEEL
STONG
STONE
STORAGE
STRUCTURAL
STONE
STORAGE
STRUCTURAL
SUSPENDED
SYMMETRICAL

TREAD
TO BE DETERMINED
TELEPHONE
TELEPHONE
TEMPERED
TEMPORARY
TRANSPARENT FINISH
TRANSPARENT FINISH
TRANSPARENT FINISHED WOOD
TONGUE AND GROOVE
TOP OF CONCRETE
TOP OF CONCRETE
TOP OF WALL
TRANSLUSCENT
TELEVISION
TYPICAL

UNIFORM BUILDING CODE UNDER COUNTER UNLESS OTHERWISE NOTED UTILITY

VARIES
VINYL COMPOSITION TILE
VENEER
VERTICAL
VESTIBULE
VERIFY IN FIELD
VENEER PLASTER

WITH
WATER CLOSET
WOOD
WASHER/DRYER
WINDOW
WATER HEATER
WITHOUT
WHERE OCCURS
WATERPROOFING
WEIGHT

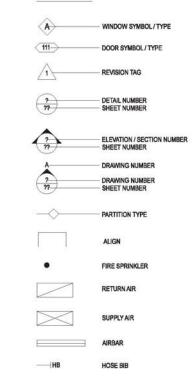

# DIRECTORY

NAME ADDRESS EMAIL

MATAROZZI PELSINGER DESIGN+BUILD 355 11TH STREET, SUITE 200 SAN FRANCISCO, CA 94103 T 415.285.6930

## **VICINITY MAP**



PROJECT SITE

# **PROJECT DATA**

3751/3753 20TH STREET SAN FRANCISCO, CA 94110

BLOCK/LOT#

ZONING DISTRICT

OCCUPANCY GROUP

RESIDENTIAL UNITS -2 EXISTING (NO CHANGE)

TYPE OF CONSTRUCTION

HEIGHT LIMIT 40-X

SCOPE OF WORK

AN YERTICAL ADDITION BELOW (F) GRADE
(N) HORIZONTAL ADDITION @ REAR
(N) ELEVATOR
(N) CURB CUT & GARAGE DOOR
(N) CURB CUT & GARAGE DOOR
(N) DORNER WINDOWS
RÉPLACE (E) FRONT GABLE WINDOW WITH (N) WOOD WINDOW

PARCEL AREA 2,848 SQ.FT.

**BUILDING AREA (GROSS)** 

-EXISITNG: 2,347 SQ.FT. -PROPOSED: 7,111 SQ.FT.

APPLICABLE BUILDING CODES

2013 CALIFORNIA BUILDING CODE (C.B.C.)
2013 CALIFORNIA BUILDING CODE (C.P.C.)
2013 CALIFORNIA MECHANICAL CODE (C.M.C.)
2013 CALIFORNIA ELECTRICAL CODE (C.B.C.)
2013 CALIFORNIA ELECTRICAL CODE (C.B.C.)
2013 CAL GREEN BUILDING CODE (CALGREEN)
2013 SAN FRANCISCO AMENOMENTS TO C.B.C,
C.P.C., C.M.C, C.E.C., AND CALGREEN

# SHEET INDEX

### ARCHITECTURAL

ARCHITECTURAL
A0.1 - PROJECT INFORMATION
A0.2 - PHOTOS- NORTH & SOUTH STREET FACADES (BLOCK)
A0.3 - PHOTOS- SUBJECT PROPERTY & NEIGHBORS
A0.38 - PHOTOS - NEIGHBORS
A0.4 - ARTICLE 10 DEMOLITION CALCULATIONS
A0.5 - PRE-APPLICATION MEETING INFO
A0.6 - TREE PLANTING AND PROTECTION CHECKLIST

C.0 - SURVEY

A1.1 - SITE PLANS - EXISTING & PROPOSED

A3.1 - SECTION - NORTH-ISOUTH, EXISTING
A3.2 - SECTION - NORTH-ISOUTH, PROPOSED
A3.3 - (UNUSED)
A3.4 - ELEVATION - NORTH, EXISTING
A3.5 - ELEVATION - NORTH, PROPOSED
A3.6 - ELEVATION - SOUTH, EVISTING
A3.7 - ELEVATION - SOUTH, PROPOSED
A3.8 - ELEVATION - EAST, EVISTING
A3.9 - ELEVATION - EAST, PROPOSED
A3.10 - ELEVATION - EAST, EXISTING
A3.11 - ELEVATION - WEST, EXISTING
A3.11 - ELEVATION - WEST, PROPOSED



3751 / 3753 20th STREET

3751 20TH STREET, SAN FRANCISCO, CA,

13045.70

JOR

SITE PERMIT

11.04.2014

REVISION:

SHEET TITLE:

**COVER SHEET** 

SHEET NUMBER:



20TH STREET - SOUTH SIDE NOT TO SCALE



20TH STREET - NORTH SIDE NOT TO SCALE

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3751 / 3753 20th STREET

2

3751 20TH STREET, SAN FRANCISCO, CA, 94110

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10.2.2014

REVISION:

SHEET TITLE:

PHOTOGRAPHS: NORTH & SOUTH 20TH STREET

SHEET NUMBER:



SUBJECT PROPERTY

VIEW FROM REAR OF SUBJECT PROPERTY

NOT TO SCALE



SUBJECT PROPERTY & ADJACENT NEIGHBORS - REAR NOT TO SCALE

SUBJECT PROPERTY



SUBJECT PROPERTY & ADJACENT NEIGHBORS - FRONT NOT TO SCALE

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3751 20TH STREET, SAN FRANCISCO, CA, 94110

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10.2.2014

REVISION:

SHEET TITLE:

PHOTOGRAPHS: SUBJECT PROPERTY FRONT & REAR


SHEET NUMBER:







WEST NEIGHBOR - PROPERTY LINE WINDOWS NOT TO SCALE

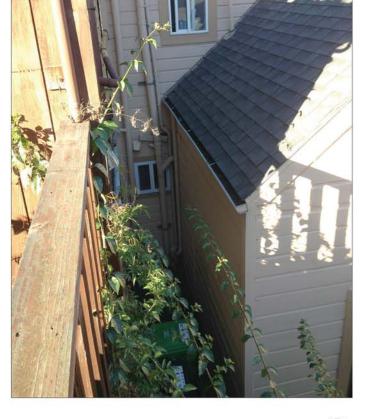

EAST NEIGHBOR - REAR NOT TO SCALE

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3751 20TH STREET, SAN FRANCISCO, CA, 94110

11.04.2014

SHEET TITLE:

PHOTOGRAPHS: NEIGHBORS

SHEET NUMBER:

A0.3B



NORTH ELEVATION, (E)

SCALE: 1'-0" = 1/8"

WEST ELEVATION, (E)

SCALE: 1'-0" = 1/8"

Internal Structural	Walls and Floorplates	, Removal (Limit = 7	75%):
Element	Total Area	Removed Area	% Removed
1st Floor Walls	1067.04	1067.04	100.0%
1st Floor Plate	960	776	80.8%
2nd Floor Walls	720.5	720.5	100.0%
2nd Floor Plate	836	200.5	24%
3rd Floor Walls	0	0	0%
3rd Floor Plate	650.4	18	3%
Roof	N/A	N/A	N/A
Total:	4233.94	2782.04	65.7%

ARTICLE 10 DEMOLITION CALCULATIONS

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3751 / 3753 20th STREET

13045.70

SITE PERMIT

10.2.2014

REVISION:

SHEET TITLE: ARTICLE 10: DEMOLITION CALCULATIONS

SHEET NUMBER:

Alboard for Pre-Application Meeting

Affidavit for Pre-Application Meeting

Alkalad for Pre-Application Meeting

Pre-Application Meeting Sign-in Sheet	
Meeting Date: 3/25/2014 Meeting Time: 6pm Meeting Address; 3751 20th Street, San Francisco, CA 94110 Project Address; 3751 20th Street, San Francisco, CA 94110 Property Owner Name: Justin McBaine Project Sponsor/Representative: Shane Curnyn, Matarozzi Pelsinger Design + Build	
Please print your name below, state your address and/or affiliation, with a neighborhood gro your phone number. Providing your name below does not represent support or opposition is for documentation purposes only.	oup, and provide to the project; it
NAMEJORGANIZATION ADDRESS PHONE: EMAIL  1. LINGSBY Refaurely 3739 20th St. Liberty allower  2. VINGINIA WILLIAM 156 Liberty allower  3. Injuly Eggas 3749 20th St.  4. PATM GOODE 3750 20th St. Pja	send Plans en@sbcglobal ivet of
5	
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9.	(1)
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18.	.0

feeting Date: 3/25/2014 feeting Time: 6:00pm feeting Address: 3751 20th St., San Francisco, CA 9 roject Address: 3751 20th St., San Francisco, CA 94 roperty Owner Name: Justin McBaine	4110
leeting Time: 6:00pm leeting Address: 3751 20th St., San Francisco, CA 9 roject Address: 3751 20th St., San Francisco, CA 94	4110
roject Address: 3751 20th St., San Francisco, CA 94	4110
ronarty Owner Name: Justin McBaine	110
roject Sponsor/Representative: Shane Curnyn, Matz	rozzi Pelsinger Design + Build
lease summarize the questions/comments and your bace below. Please state if/now the project has been	response from the Pre-Application meeting in the modified in response to any concerns.
ruestion/Concern #1 by (name of concerned neighbo agrid Eggers (3749 20th St.): The construction pha	r/neighborhood group):
ngrid Eggers (3749 20th St.): The construction pha usiness.	se of the project will negatively effect my Airbnb
roject Spansor Response: le intend to do everything within our power to mi	itigate the effect of construction on 3749. If there
re specific concerns, please let us know so we can	
igrid Eggers (3749 20th St.): The rear addition seen the fact that my unit is at the rear of our lot.	ns larger than what Planning would allow given
the rock trial triy trial 15 of the real of our for	
roject Sponsor Response: /e have met with Planning twice and have confirm	
mensions. Pushing the Pop-Out to the west will n	equire a variance, but we are prepared to pursue
imensions. Pushing the Pop Out to the west will ruls in order to provide 3749 with a more generous	equire a variance, but we are prepared to pursue
imensions. Pushing the Pop-Out to the west will rule in order to provide 3749 with a more generous	equire a variance, but we are prepared to pursue
mensions. Pushing the Pop-Out to the west will n	equire a variance, but we are prepared to pursue
imensions. Pushing the Pop-Out to the west will rule in order to provide 3749 with a more generous	equire a variance, but we are prepared to pursue
mensions. Pushing the Pop-Out to the west will rules in order to provide 3749 with a more generous tuestion/Concern #3:	equire a variance, but we are prepared to pursue
imensions. Pushing the Pop-Out to the west will rule in order to provide 3749 with a more generous	equire a variance, but we are prepared to pursue
mensions. Pushing the Pop-Out to the west will rules in order to provide 3749 with a more generous tuestion/Concern #3:	equire a variance, but we are prepared to pursue
mensions. Pushing the Pop-Out to the west will rules in order to provide 3749 with a more generous tuestion/Concern #3:	equire a variance, but we are prepared to pursue
mensions. Pushing the Pop-Out to the west will rules in order to provide 3749 with a more generous tuestion/Concern #3:	equire a variance, but we are prepared to pursue
mensions. Pushing the Pop-Out to the west will rolls in order to provide 3749 with a more generous tuestion/Concern #3:	equire a variance, but we are prepared to pursue
mensions. Pushing the Pop-Out to the west will rules in order to provide 3749 with a more generous tuestion/Concern #3:	equire a variance, but we are prepared to pursue
mensions. Pushing the Pop-Out to the west will rolls in order to provide 3749 with a more generous tuestion/Concern #3:	equire a variance, but we are prepared to pursue
mensions. Pushing the Pop-Out to the west will rolls in order to provide 3749 with a more generous tuestion/Concern #3:	equire a variance, but we are prepared to pursue connection to the mid-block open space.

Affidavit of Conducting a Pre-Application	Meeting,
Sign-in Sheet and Issues/Responses sub	mittal

1, Justin McBaine , do hereby declare as follows:

- I have conducted a Pre-Application Meeting for the proposed new construction or alteration prior to submitting any entitlement (Building Permit, Variance, Conditional Use, etc.) in accordance with Planning Commission Pre-Application Policy.
- The meeting was conducted at 3751 20th Street, San Francisco, CA 94110 (location/address) on 3/25/2014 (date) from 6pm-7pm (time).

  (in time).
- I have included the mailing list, meeting initiation, sign-in sheet, issue/response summary, and reduced plans with the entitlement Application. I understand that I am responsible for the accuracy of this information and that erroneous information may lead to suspension or revocation of the permit.
- 1 have prepared these materials in good faith and to the best of my ability.

I declare under penalty of perjury under the laws of the State of California that the foregoing is true and

, 20 14 IN SAN FRANCISCO.

EXECUTED ON THIS DAY, 3/25

Justin McBaine

3751 20th Street, San Francisco, CA 94110

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3751 / 3753 20th STREET

3751 20TH STREET, SAN FRANCISCO, CA, 94110

13045.70

SITE PERMIT

11.04.2014

SHEET TITLE:

PLANNING PRE-APPLICATION MEETING INFO

# REQUIRED CHECKLIST FOR **Tree Planting** and Protection

1. Applicant Information

Justin McBaine	
ADDRESS	TELEPHONE
Matarozzi Pelsinger Builders	(415 ) 466-8239
355 11th St., Ste. 200	EMAL
San Francisco, CA, 94103	jtmcb@yahoo.com

2. Location and Classification of Property

OSS STREE	18:		
20th & D	olores		
SSESSORS II	DOKLOT	LENGTH OF ALL LOT FRONTAGE(S):	20NNS DISTRICT:
		25'	RH-2

### 3. Scope of Project

Requirements for new street trees and tree protection apply to the types of projects identified in the chart belor Please check all boxes which apply to your project. If no boxes are checked, you do not need to complete this f

	DEVELOPMENT FEATURES			
	construction of a rewilluliding			
	setopation of a fullifying			
	paving or regarding more than 200 square feet of the front settack.			
X)	addition of gross floor axes (GFA) equal to 20% or more of the GFA of the existing building			
	addition of a new detailing unit			
X)	addition of one or more parking spaces			
X	addition of a garage			

### 4. Disclosure of Existing Protected Trees

SIGNIFICANT TREES		
any portion of its trunk within 10	is planted on the subject property (i.e. outside of the public feet of the public right-of-way that has (a) a dismeter at brea height in excess of twenty feet OR (c) a canopy in excess of	st height (DBH)
CHECK ALL BOXES THAT APPLY AND NOKATE QUANTITY OF EACH TIRES TYPE. IF APPROPRIATE.	Significant Tree(s) exist on the subject property	are
If you are unable of the boundary of the public signs of way, contact DFW's Bureau of Street	Significant Tree(s) exist on any adjacent property	QTX
Use and Mapping. Please note that the public right of way may be wider than the sidewalk.	X There are no Significant Trees on or adjacent to the si	ibject property.

LANDMARK TREES						
	ignated as such by the Board of Supervisionistion, visual quality, or other contribution					
OHIOK ALL BOXES THAT APPLY AND ADICATE GLANTITY OF EACH TREE TYPE, IF APPROPRIATE.	Landmark Trees exist on the subje	QTY				
	Landmark Trees exist on the adjacent sidewalk					
If you have questions about the presence of Landmark Trees, please consult with CFW or visit seew above originals.	Landmark Trees exist on any adjac	OTY				
	There are no Landmark Trees on or adjacent to the subject property.					
	COMPLETE LIST OF LAHOMARK TREES AS OF SUMM	ICA 2012				
	the More Owner originates to 1801 Book Street	Social paper at Tried St. and Viscentin Street in the Hallon				
	Flamed papertiest at 1791 Franklin Street	Sweet Stop at 555 Bullery Street				
	Non-Zealand Christmas Tree of 1221 Stamper Street	All Canals Island Cate Pains In the center strend on Dateses Str				
	19 Cervey foliated Data Falms in Oversigns fit median west of troi for	Test Pains in moder account 750 Docume \$8.0.1546 Docume				
	Quality a Patric in the median arrows hore 1606-1050 Carinese St.	Cirell his call in the basingest of 2028 Resemble Place				
	California bulkeye in Perbodipani of 730 28th Avenue	Contine on the halfour of 40	of 4124 23rd Street			
	Two Howevery Author Steme Library at 500 Confiand Street	Sin Distary has remarked of f	Principles of Federal & Denial Heights St.			
	Moneton Buy Fig at 1655 Cener Chower St / 1580 Valencia St	Monkey Cypress in the busyand of	2520 Vallejo Street			
	Hower's Managerta in the beoxyant of 115 Parker Avenue.	California Buckeye terr (socied byte)	nd 757 Perrosylvania Street.			
	Named States From Tree in the county-and of 2000-00 Sultan Street	hand of 2003-80 ballow Sk.				

STREET TREES							
"Street Tree" is any tree growing within the public right-of-way (e.g. sidewalk) that is not also a Landmark Tree							
HECK THE BOX THAT APPLIES AND ICICATE GUARTITY IF APPROPRIATE.	[X] Street Trees exist adjacent to the subject property	are	1.				
ingenthese of size, all trees in the public right-	There are no Street Trees adjacent to the property						

5. Impact of Project on Existing Protected Trees

If your responses above indicate that any Protected Tree(s) exist on, over or adjacent to the subject property, please check the applicable boxes, below:

BOX 1 The project will not remove or have any other impact on Protected Trees, as follows: No construction-related activity whatscever will occur within the displine of any Significant Tree or Street Tree. This includes, but is not limited to, the following: (1) No grading or excavation will take place within the dripline of any Significant Tree or Street Tree, (2) No construction staging and/or storage of materials and/or equipment will occur within the dripline of any Significant Tree or Street Tree, (3) Any pruning of Significant Tree or Street Tree, will be limited and consistent with applicable regulations.

(4) No dumping of trash and/or liquide (such as project waste-water) will take place within the basin or dripline of any Significant Tree or Street Tree.

If you have checked this box, a Tree Protection Plan is not required.

BOX 2 The project involves the removal of one or more Protected Trees. A permit from DPW is required in order to remove any Protected Tree. The Planning Department will not approve a building permit for a project which involves the removal of a Protected Tree unless DPW has first reviewed the proposal and found it to be consistent with applicable rules and regulations.

If you have checked this box, a Tree Protection Plan is not required, however you must provide evidence to the Planning Department that DPW has reviewed the removal request and found it to be "approvable."

BOX 3 The project may have an impact on one or more Protected Trees which are not proposed for removal, as follows: Ether (1) any construction-related activity, no matter how minor, is planned or is reasonably foreseeable to occur within the dripline of a Significant Tree or a Street Tree or (2) regardless of the location of construction activity, the property contains a Landmark Tree.

If you have checked this box, a Tree Protection Plan must be submitted to the Department of Public Works Bureau of Urban Forestry prior to the commencement of any construction activity,

Such plan must meet the following minimum standards:

- The Tree Protection Plan must be developed by an International Society of Arboriculture (ISA) Certified Arborist.
- The project sponsor must submit a written declaration that the protections specified in the Tree Protection Plan will be completely in place prior to the start of any construction, demolition, or grading.
- √ Full-size site plans submitted along with the associated construction project must clearly indicate Full-size aside plans submitted along with the associated construction project must clearly indict the street, carry, sidewalk, drivway, structure(s), and the locations of all Protected Trees and non-protected trees. Protected Trees must also be a hown to include accurate tree height plans must graphically depict implementation for all measures called for in the Tee Protection Plans Additionally, the Tree Protection Plan height along with the written destination must be resproduced on full-size plans.

### 6. Calculation of Number of New Required Street Trees

One street tree is required for each 20 feet of street frontage of the subject property, with fractions of 0.5 rounded up, however credit is given for existing street trees. Please complete the table below to determine the number of street trees required for your project. In on street trees are required, please skips to the Applicant's Affaliads at the end of this form and once signed, return it to the Planning Department along with your Building Permit Application or other application.

COMMINED LENGTH OF ALL STREET FRONTAGES		CING REQUIREN				MINUS NUMBER O	×	NET STREET THE REQUIRENENT
25'	+	20'	=	1	(rounted)	1	-	. 0

Unless site conditions physically prevent the planting of a street tree, a waiver or modification of street free requirements is available only under extremely limited circumstances and only outside of Residential Districts (i.e. RH, RM, RTO, RED). Be aware that even when available, an in-kind improvement or in-lieu payment is required for every such weiver. Please contact the Planning Department for information regarding the waiver process.

### 7. Applicable Requirements for New Street Trees

The Planning Department has developed three distinct Thee Schedules' to aid in the implementation of the Planning Code's street tree requirements. The particular Tree Schedule applicable to your project will depend on the zoning district in which your property is located, the scope of your project, and the type of authorization that your project requires. In general terms, Tree Schedule A applies to small-scale projects in residential or industrial zoning districts. Tree Schedule B applies to moderate-scale projects or projects in commercial or mixed-use zoning districts, and Tree Schedule C applies to larger projects. In the following chart, please check the applicable box based on the characteristics

	THEE	PRO	DJECT CHARACTERISTICS			
	Α	The project is located in a Recidential (RH, RM, RTO, RED), Industrial (M) or Production/Distribution/Repair (PDR) Zoning District and does not involve a Flanned Unit Development (FUD), A PUD is a special authorization granted by the Planning Commission that applies only to major projects knowling large properties.				
	В	1.	The project is located in a RH. RM	л нтс	D. RED, M or PDR Zoning District and Involves a PUD	
		OR				
		2.	The project is located outside of an RH. RM, RTO, RED, M or PDR Zoning Desict and maets neither OR one of the following criteria, but not both:	~	It is located on a percel that contains (1) more than 1/2-acre in total oran or (2) more than 250 feet of total street frontage or (3) street frontage which spans the entire block face between the nearest two intersections.	
				~	It involves (1) the construction of a new building or (2) the addition of more than 20% of the gross floor area of the existing building or (3) a change of use of more than 50% of the existing square footage of the building.	
	С		project is located outside of an Rie edule B(2), above.	H. PM	f, RTO, RED, M or PDR Zoning District and meets both criteria of Tree	

	TREE SCHEE	CHEDULE A		
	REQUIREMENT	SPECIFICATION		
V	Location	either in the public rights of-way (e.g. sidewald) adjacent to this properly or within an unbuilt area at the front of the property		
1	Size	minimum of Sélandh besistre		

	THE RESERVE OF THE PARTY OF THE		
1	Leadings	eliter in the public right of early jet, sidewide sopport to the	property or within an unexalt erea at the first of the property.
		manus. Contractor measured at bread hards	
V.	No.	Dental a receipt of SC inches above extensive cracks	
		be planted in a pidewalk opening of at least 15 souther feet	
		have a minimum and death of 2 feet of increase	
1	Doesno		ins or coboles (edging will not court against the renormin 14 secure
		foot opening if the edging instead is permeable. A permeable Permeable welcook shall include, but not be limited by voget	rounts is one that allows atomics to still have the underlying units fire printing back, purple supplies, purples concerns, eight-educt is hone-set and without morter framework surfaces are largured to be
	TREE SCHEE	DULEC	
	MONOSAWI I	tres product	Co. Carp Company
1	1/1/45/91	78	
	the	As set forth in Schodula S. above.	
9	Opers		
-			
	Treading	Tress that be planted in a portinuous solf-filled trends penals be covered by permastile surfaces (as described above), exp	I to the out, each that the basic his each time is consisted. The is only has get at required true basins, where the EST must remain underlock.
5)	20 85		
here anny wence The uniformal drawn und nimin etiwi	by attest under p lodgo, and that I I r, familiar with th indersigned agrees nation in responsibility a violation or nistrative fines. costand that about them requirement fies. Such submits	have read and understood this form, and that I am in property, and able to provide accurate and compli- s to the conditions of this form. I understand that it e to this disclosure requirement may lead to detail of the Son Francisco Municipal Code, which can lead of the Son Francisco Municipal Code, which can lead full my project be subject to a required. The Protection	newingly or negligently providing false or midealing or reassistent of my permit or other authorization and may to criminal and/or civil legal action and the impossition of in Plan, that I will have a plan meeting or exceeding the ic Works prior to the commencement of any countractive strypermitsels.
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### Planning Department Determination

BUILDING PERIOR COASE NO				
PUAS DITED				
New Street Trees	New street trees are not required as part of this project.			
	Street Trees are required as part of this project.  Number of new street trees required:			
	App loable Tree Schedule:			
	Compliance with an-cf-right requirements shown on plans?  57 148  C NO-ROCATION OR VIN VER APPROVED. ESPERATION COMMENTS, BELOW.			
Existing Tree	A Tree Protection Plan is not required: Box 1 or Box 2 in Section 5 has been marked			
Protection	A Tree Protection Plan is required: 3 ox 3 in Section 5 has been marked.			
Existing Tree	No Protected Trace are proposed for removal.			
Removal	One or more Protected Trees are proposed for removal.			
STAFF TO SIGN UNLESS A W	SAVER OR MODIFICATION HAS REEN APPROVED, IN WHICH CASE ZA MONATURE IS RECURRED.			
Significa	Print Name Date			
Signature	Print Norms Date			
Comment (if env)				

### Staff Checklist

- The applicant has completed this entire checklist including the affidavit on the preceding page.
- If sized trees are required, a building permit carnot be approved until the applicant provides evidence from DPW that the required planting permit can be issued.
- If Protected Trees are proposed for removal, a building permit cannot be approved until the applicant provides evidence from DPW that tree removal permits can be issued.
- If a Tree Protection Plan is required, the applicant has been informed verbally end/or in writing of his or her obligation to submit one directly to DPW prior to the commencement of construction.
- Once signed, a copy of this checklist has been returned to the applicant. The original has been included in the project file or, if processed over-the-counter, it has been routed upstains for scanning by support staff.

355 11TH STREET, SUITE 200 SAN FRANCISCO CA 94103 T 415.285.6930 F 415.285.7266 WWW.MATPELBUILDERS. MATAROZZI PELSINGER DESIGN + BUILD



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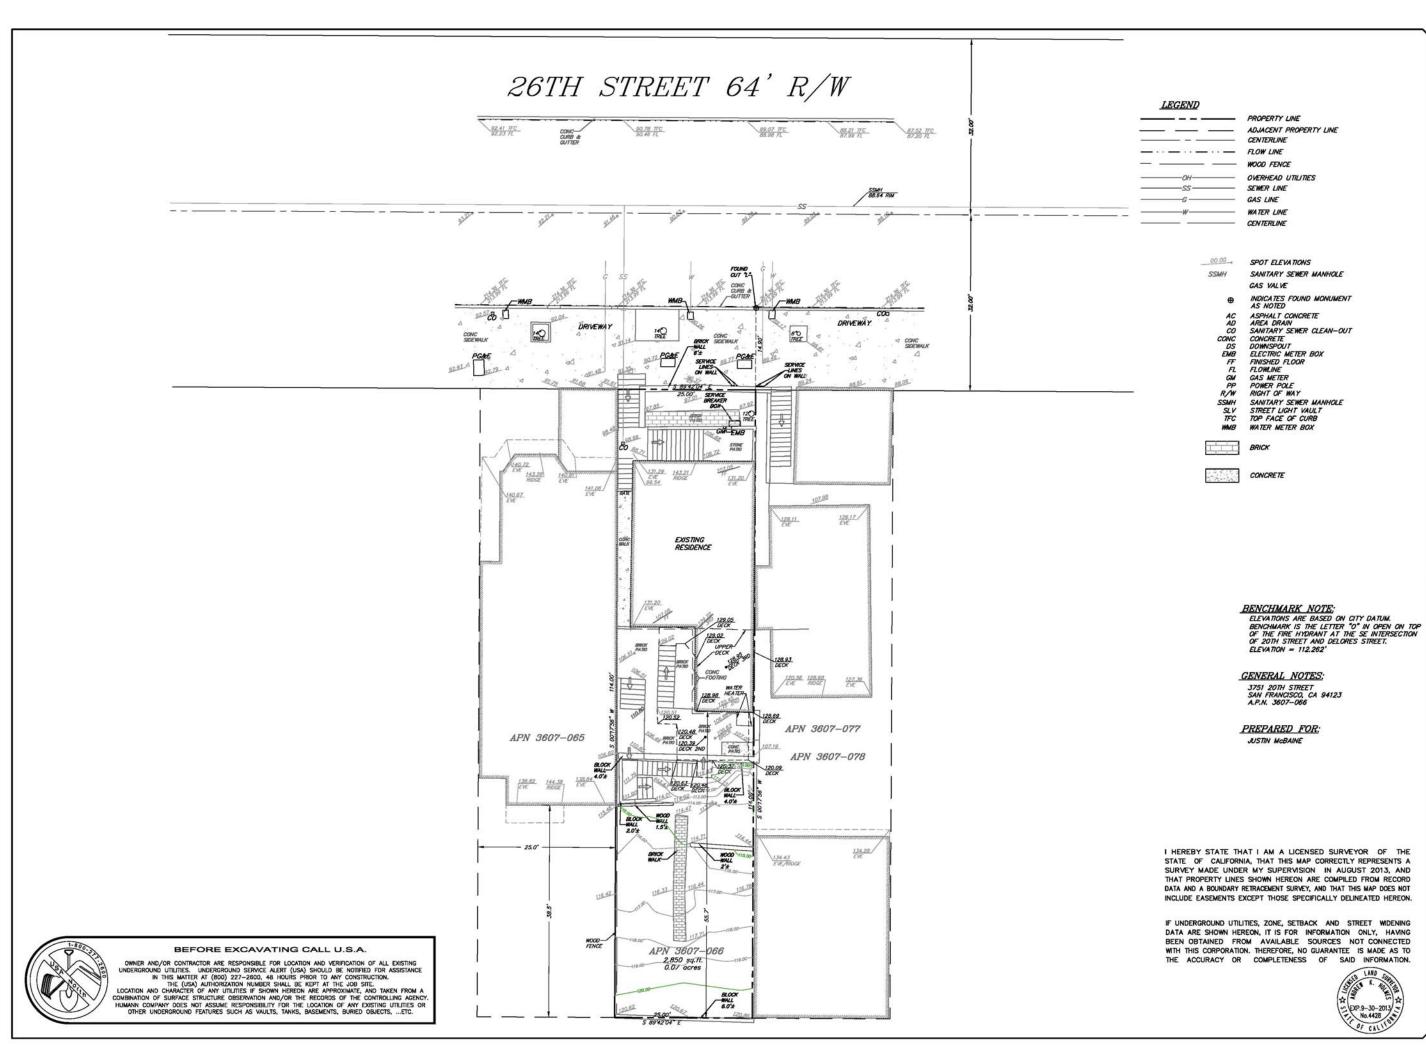
13045.70

SITE PERMIT

11.04.2014

SHEET TITLE:

TREE PLANTING & **PROTECTION** CHECKLIST



TOPOGRAPHIC SURVEY
751 20TH STREET

GIY AND COUNTY OF SAN FRANCISCO


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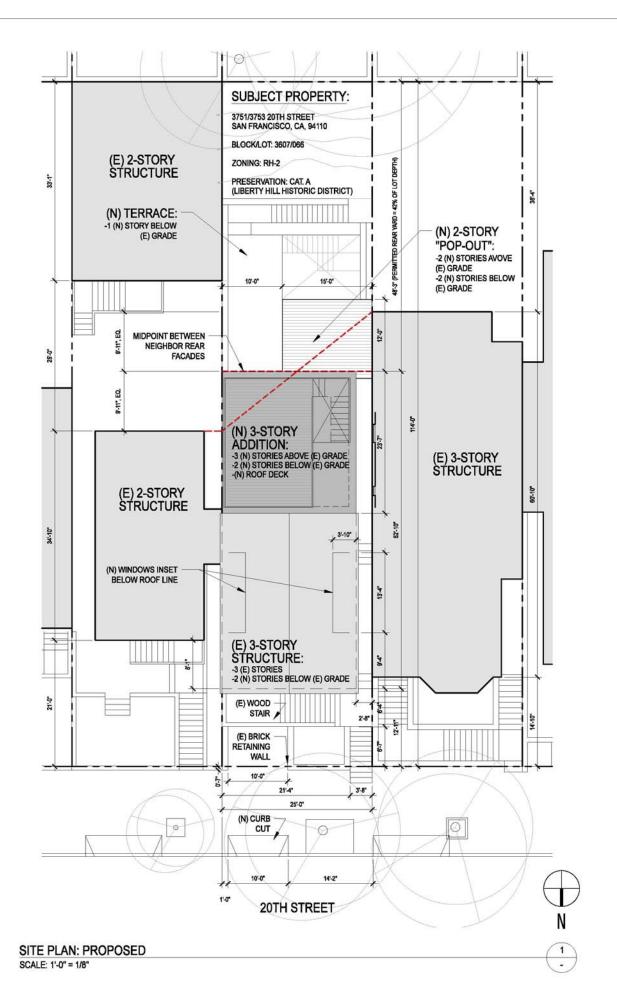
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REMISIONS

08/15/13 E 1"=8'

MN MN 09-1561
09-1571 TOPO

C. C



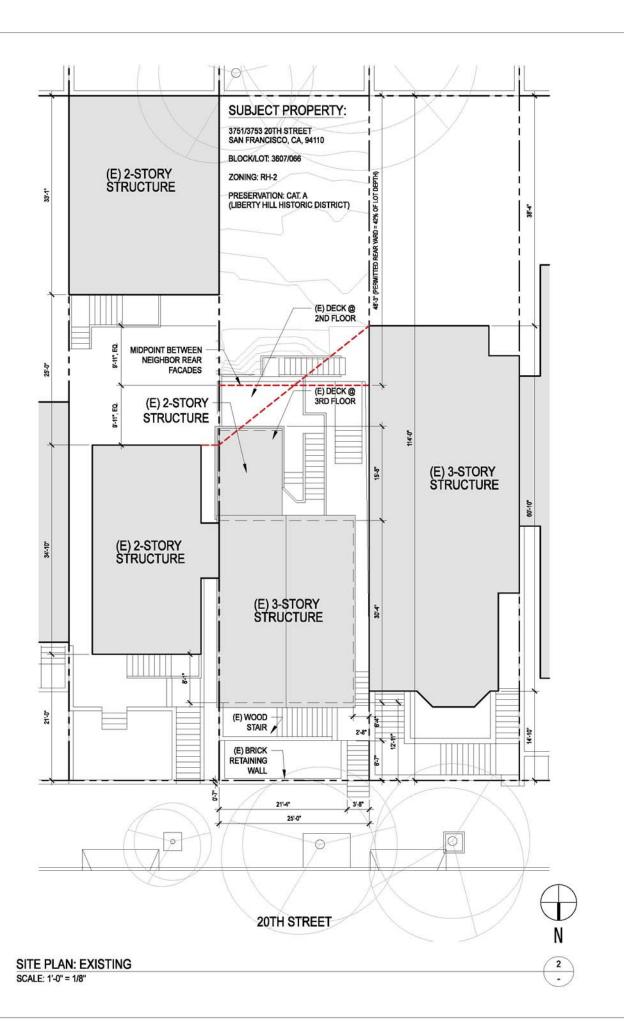

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SITE PERMIT


10.28.2014


REVISION:


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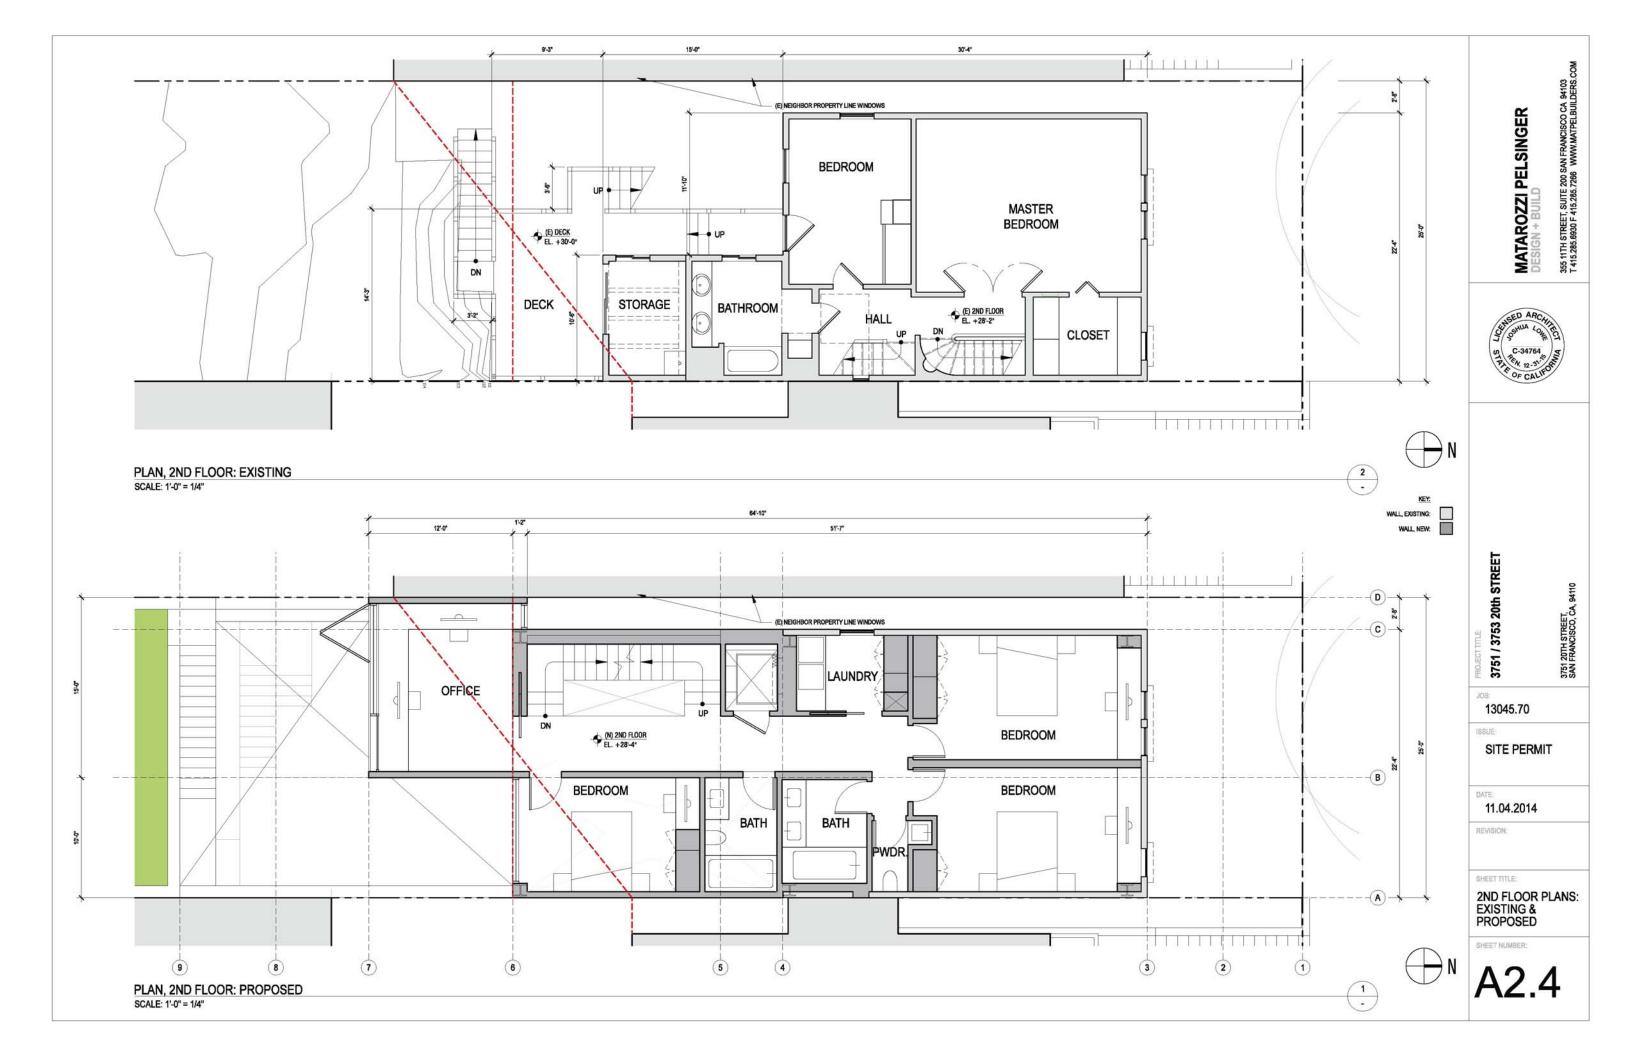
SITE PLAN: EXISTING & PROPOSED


SHEET NUMBER:




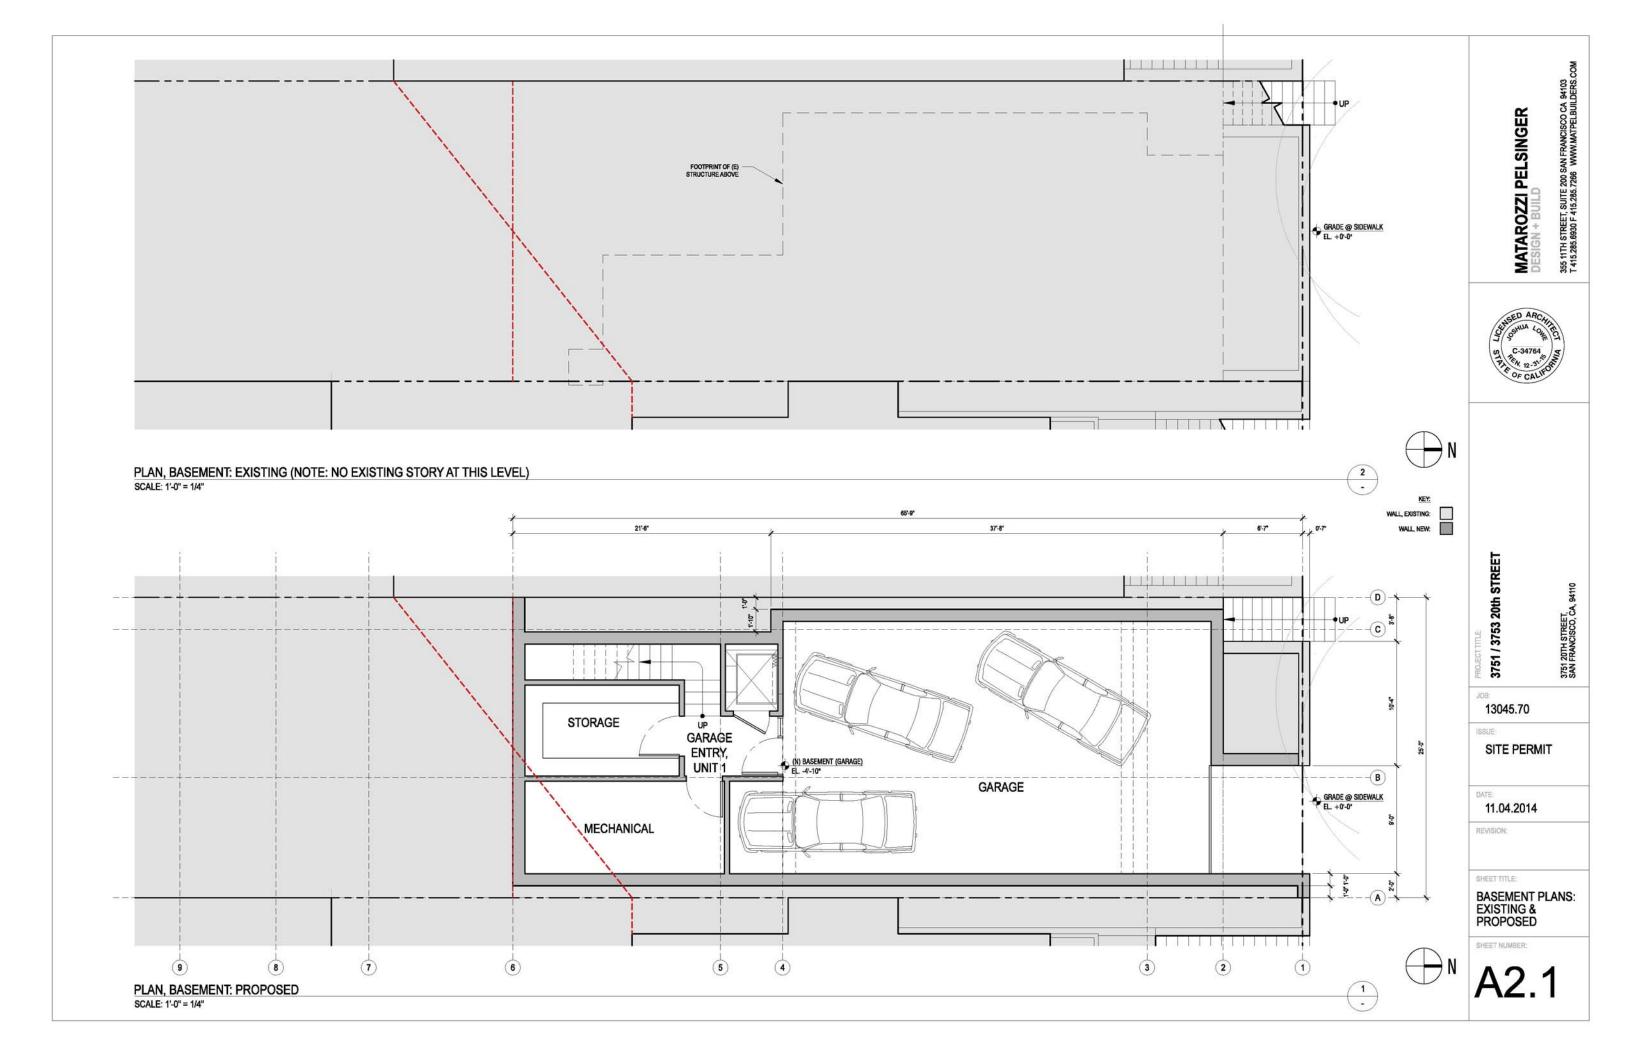


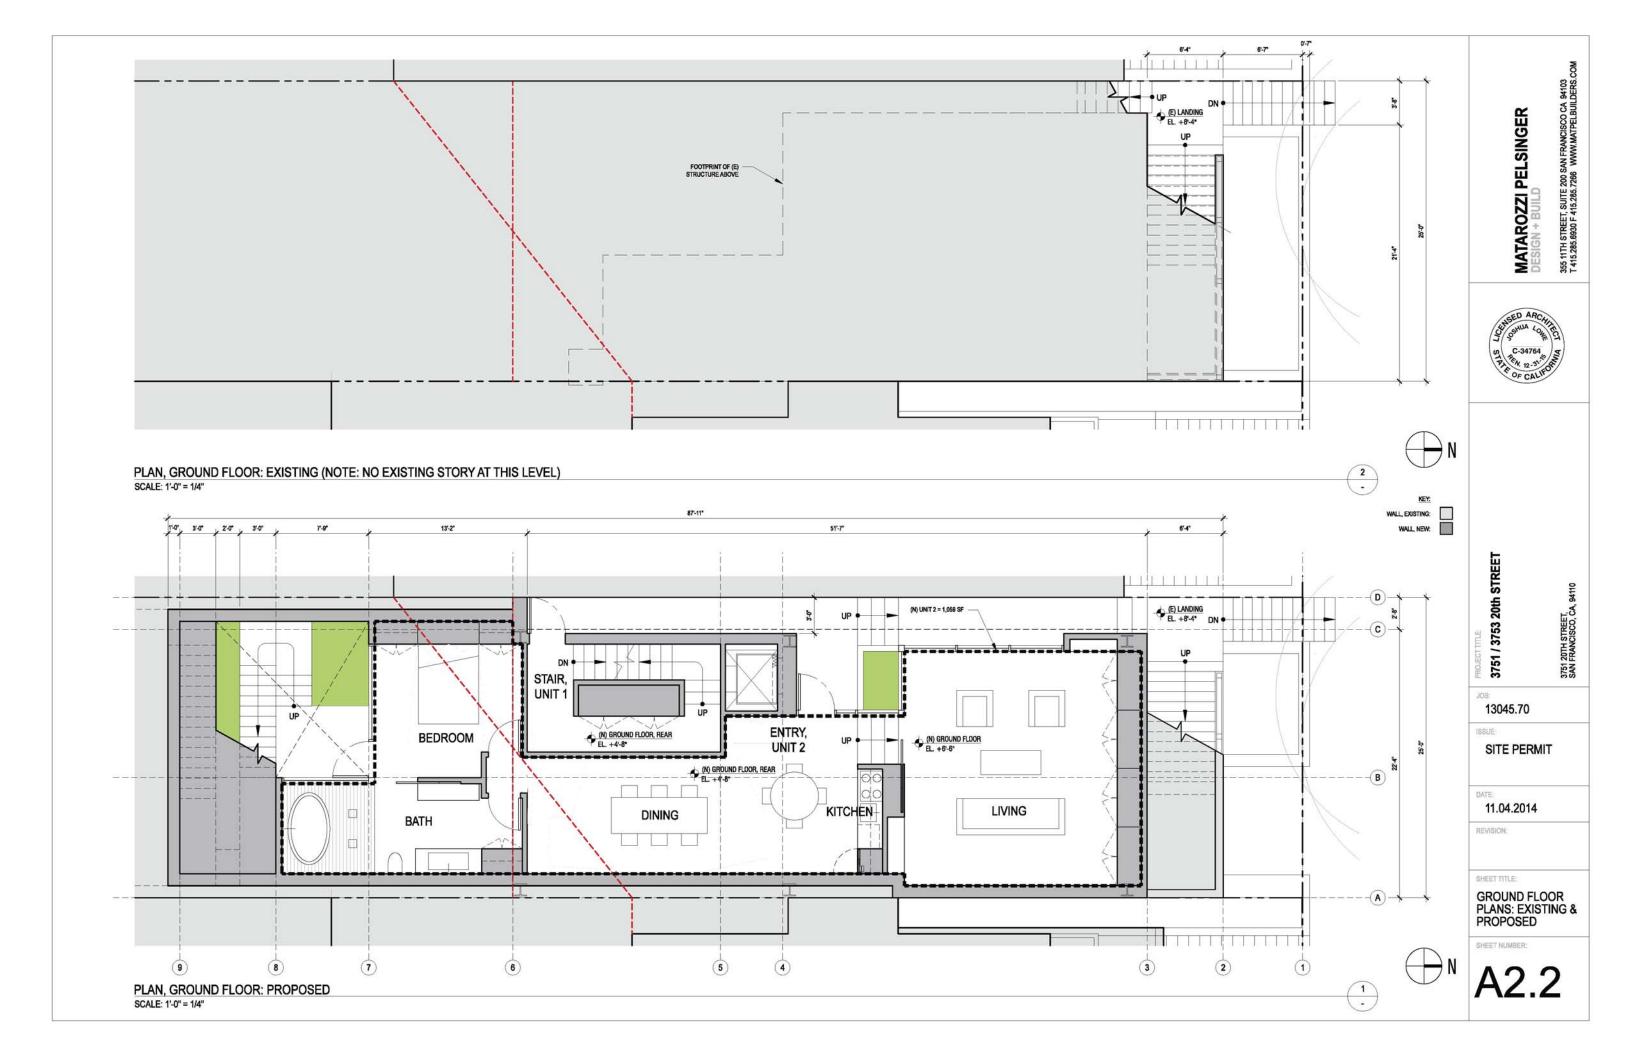


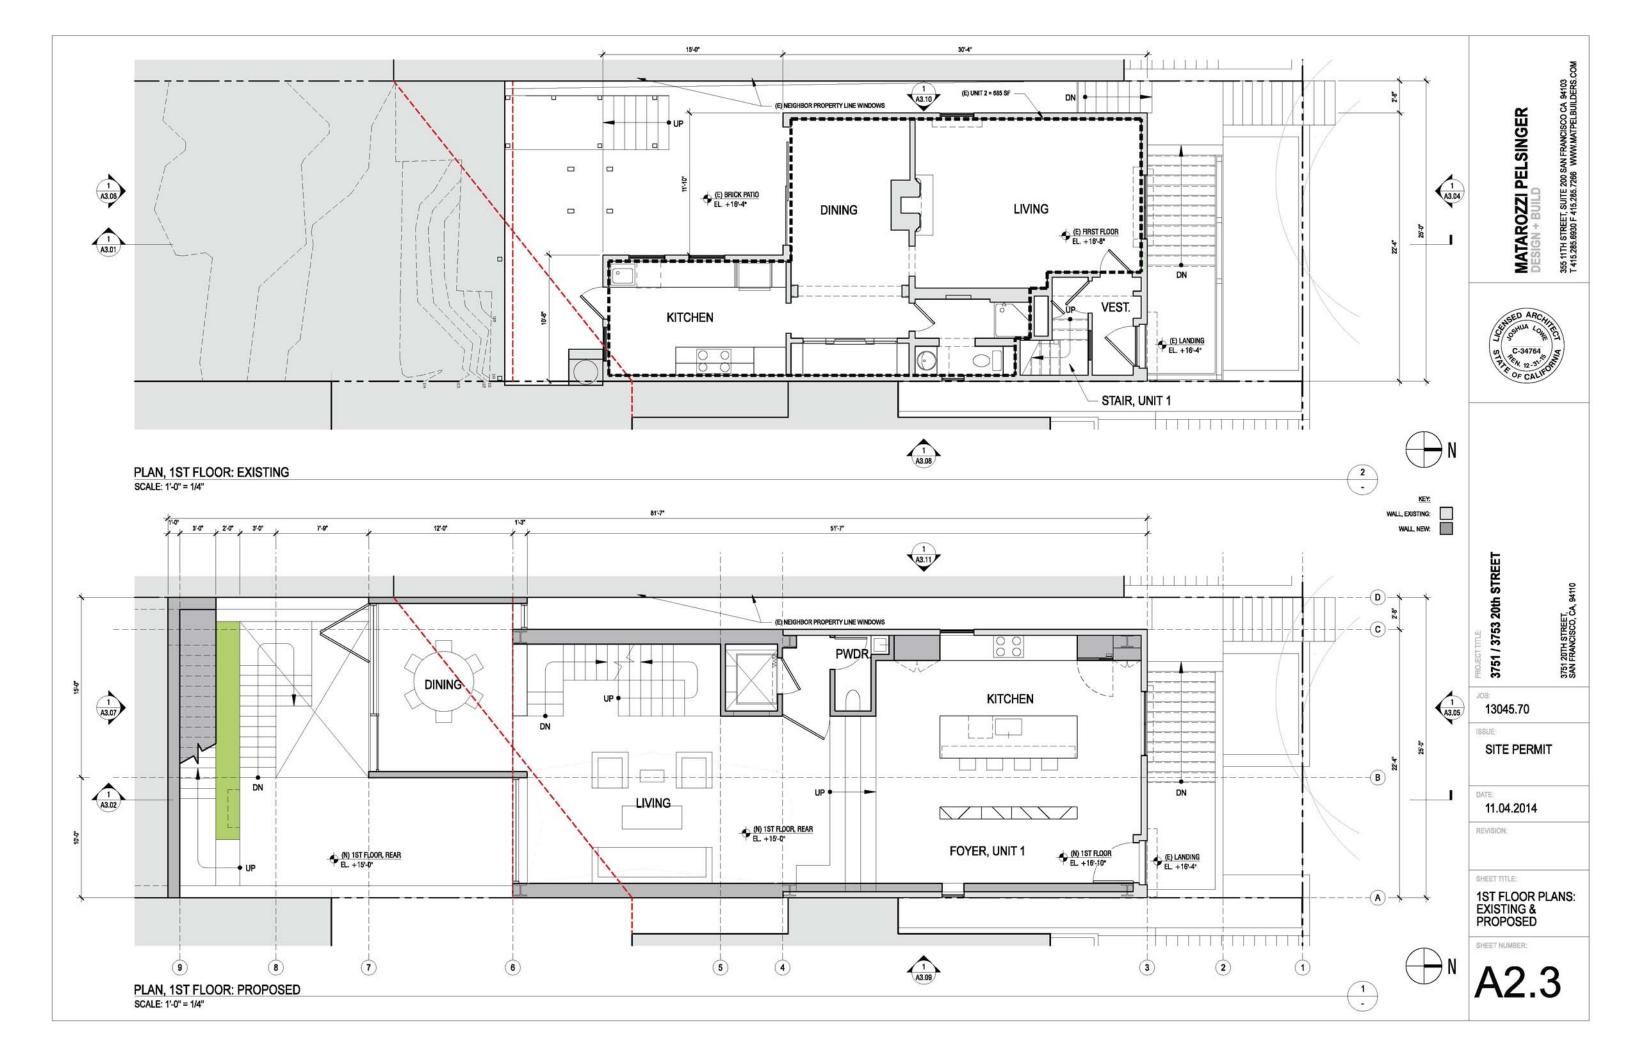


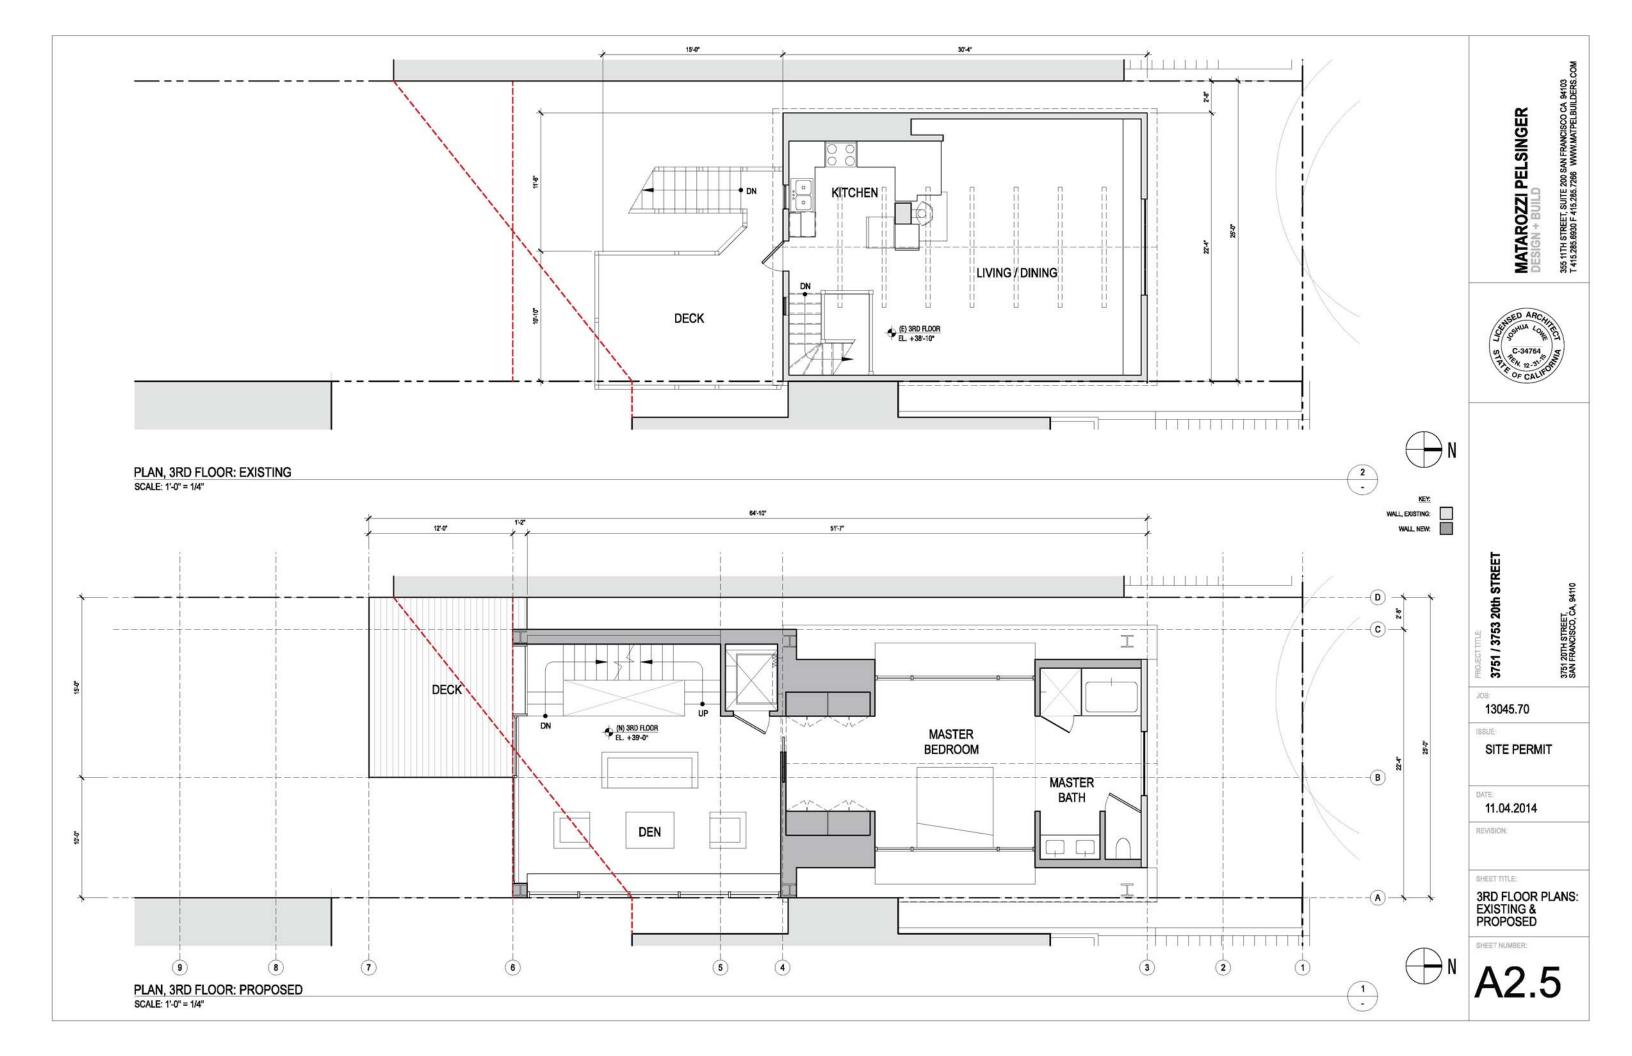

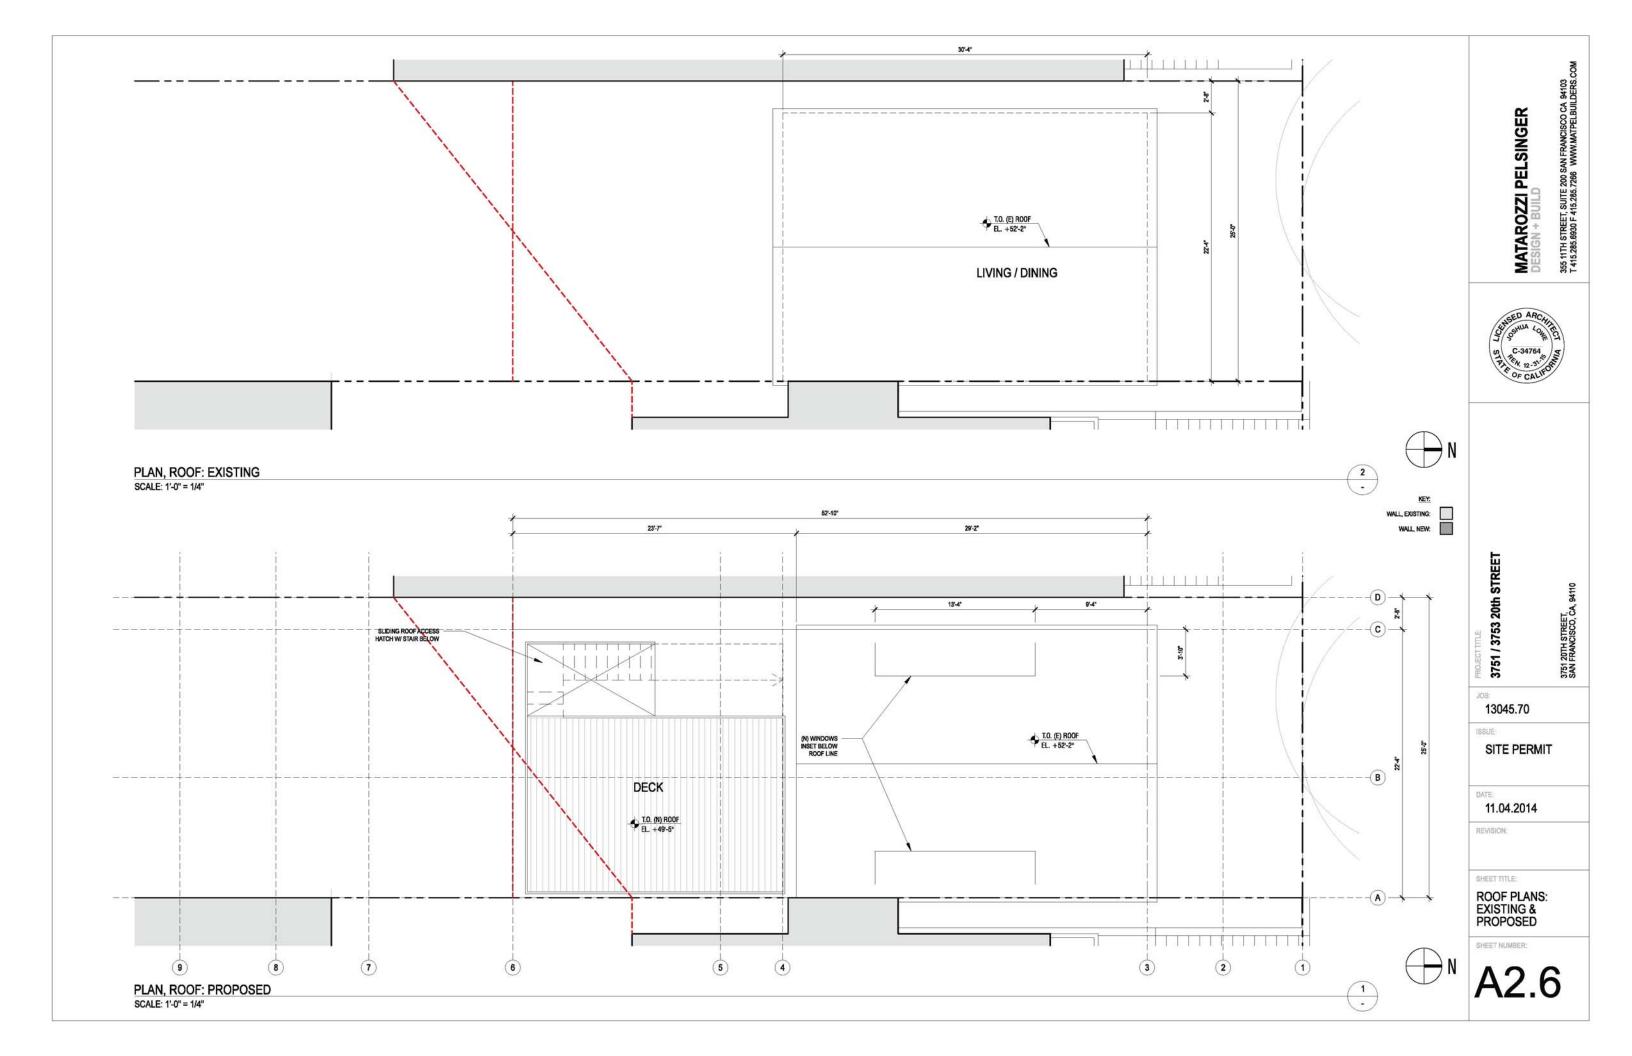

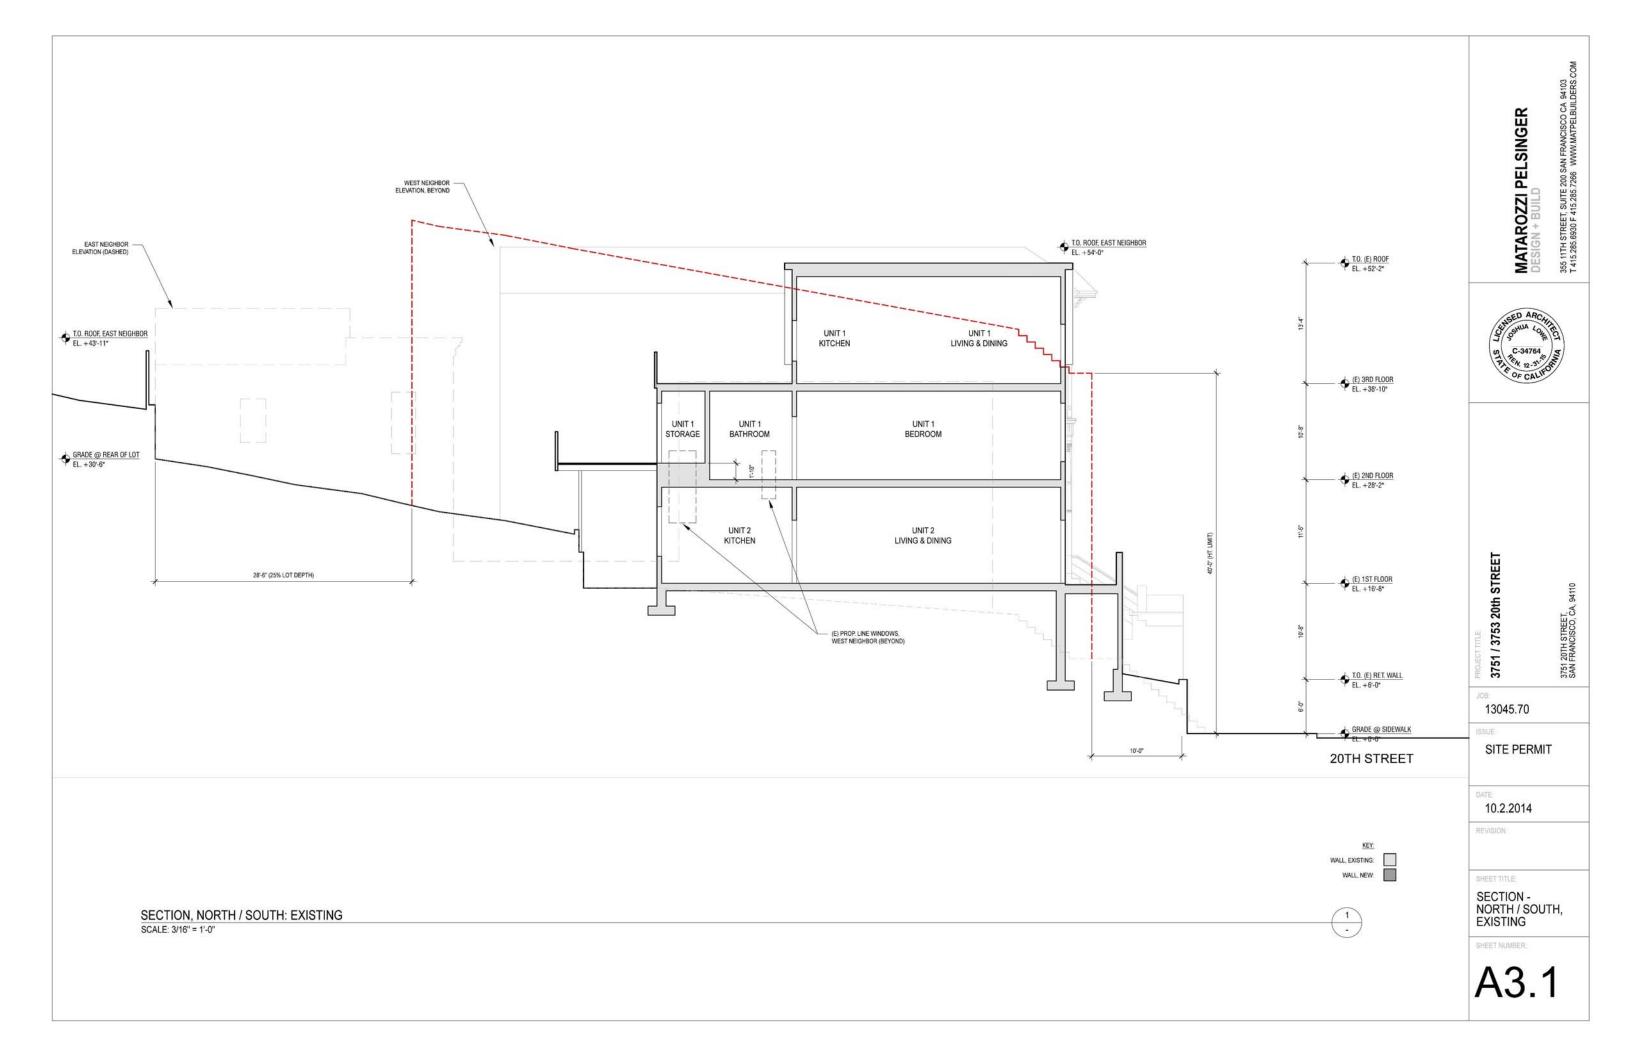

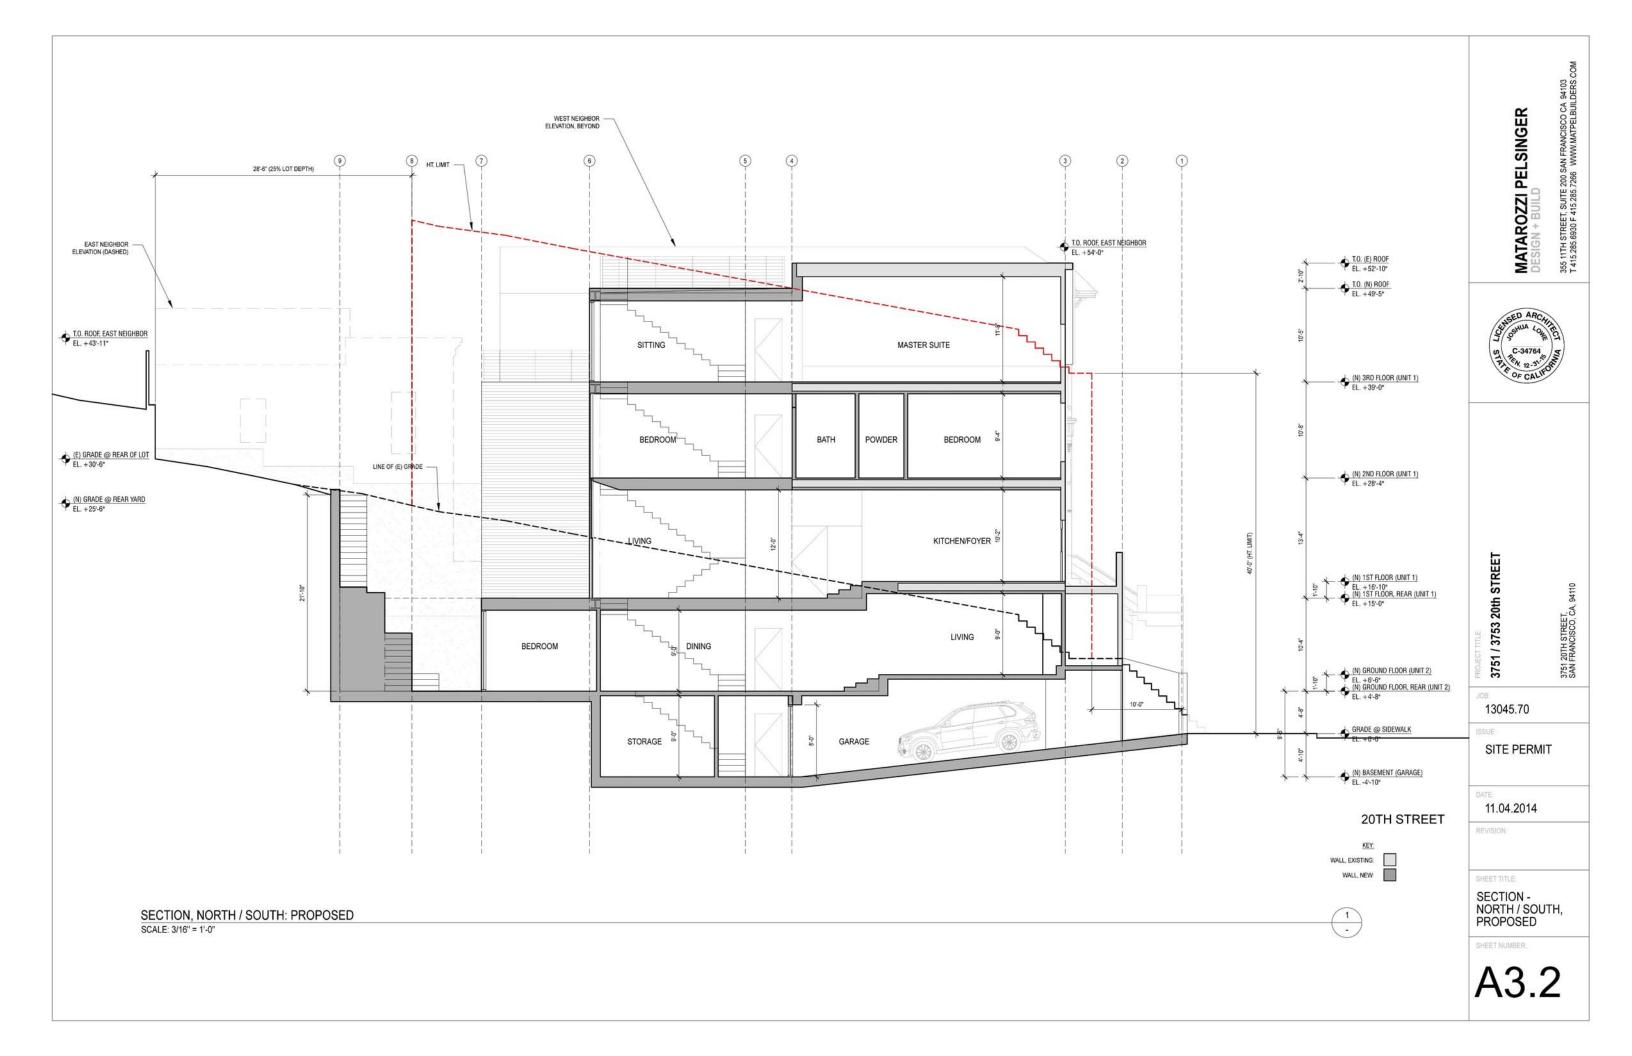

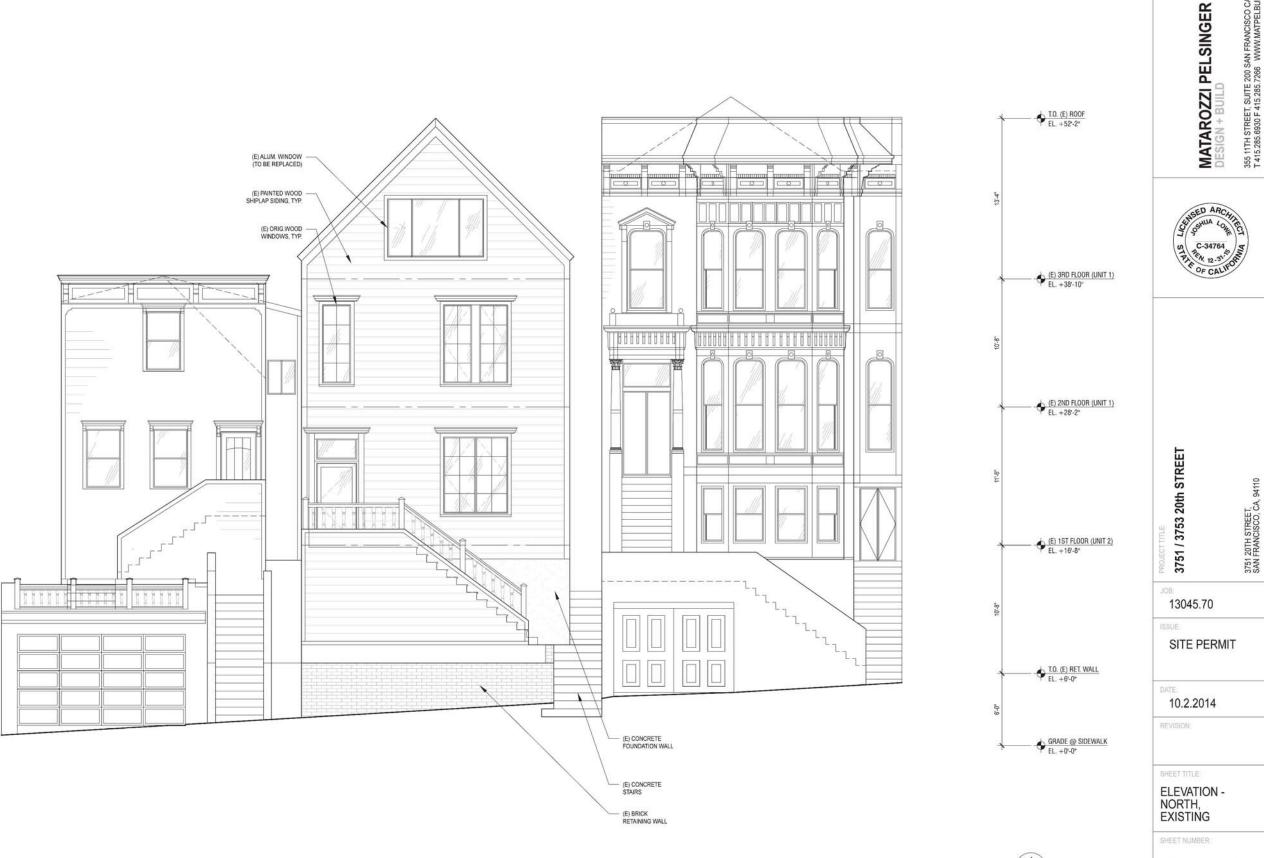


ELEVATION, NORTH: EXISTING

SCALE: 1/4" = 1'-0"

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A3.4



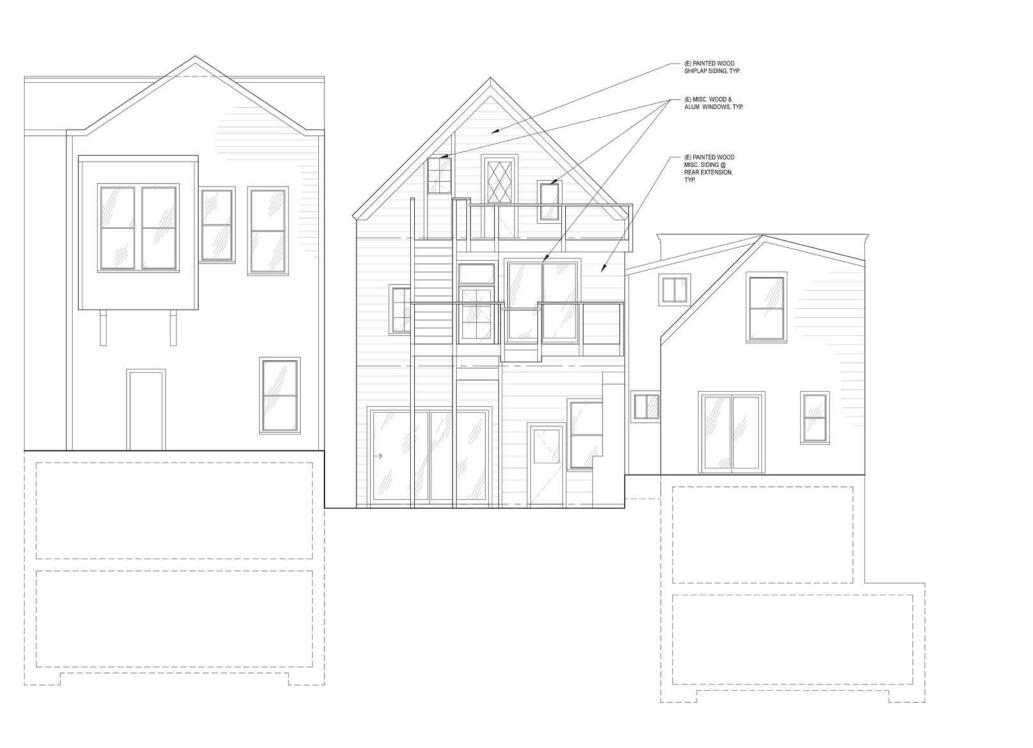

T.O. (E) ROOF EL. +52'-2" (E) 3RD FLOOR (UNIT 1) EL. +38'-10" (E) 2ND FLOOR (UNIT 1) EL. +28'-2" (E) 1ST FLOOR (UNIT 2) EL. +16'-8" T.O. (E) RET. WALL EL. +6"-0" GRADE @ SIDEWALK EL. +0"-0"

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SAN FRANCISCO, CA, 94110

13045.70


SITE PERMIT

10.2.2014

ELEVATION -SOUTH, EXISTING

SHEET NUMBER

A3.6

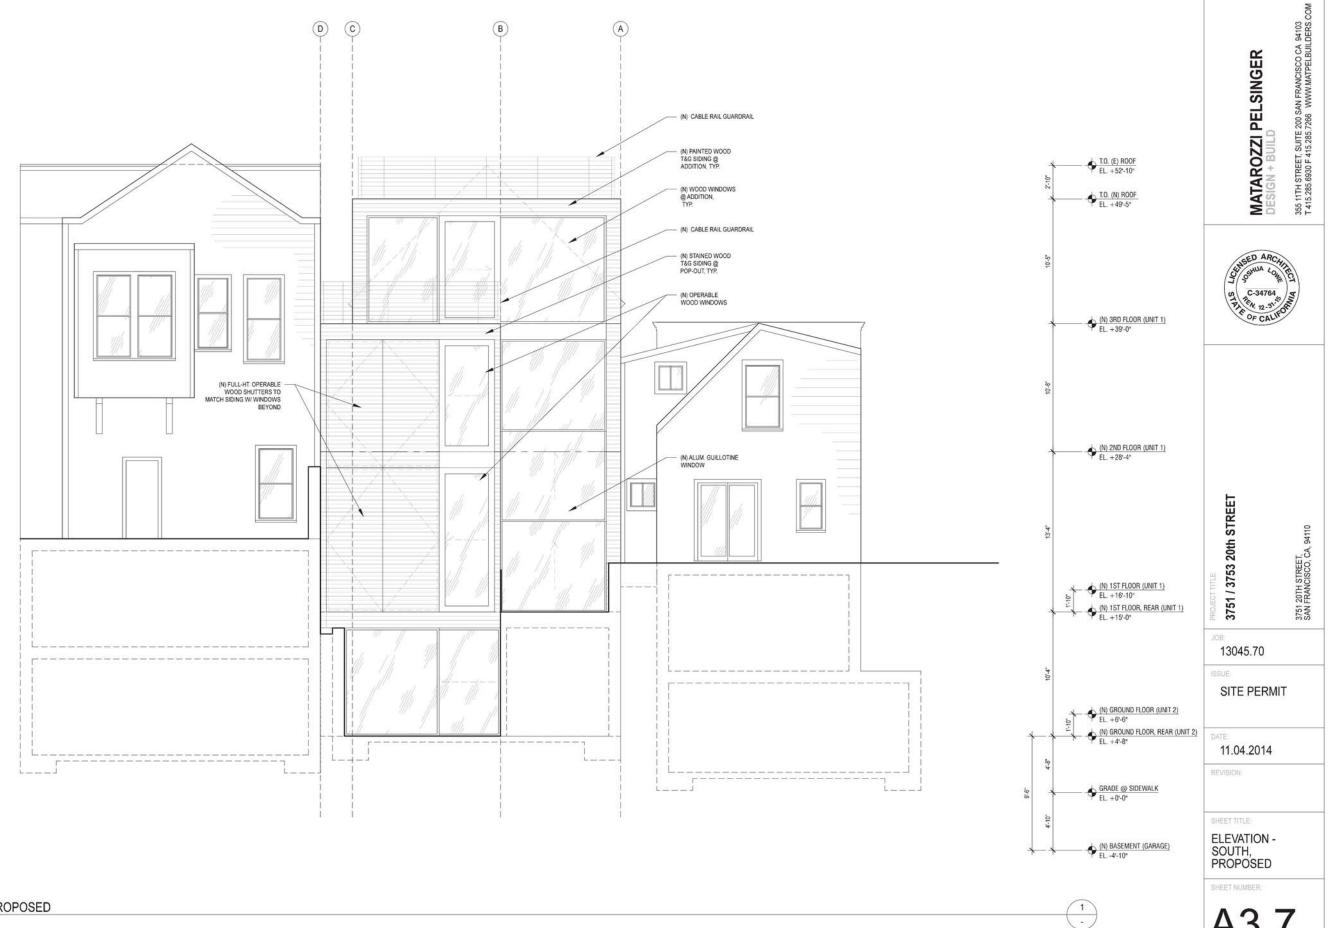

ELEVATION, SOUTH: PROPOSED

SCALE: 1/4" = 1'-0"

A3.7

