




3

BUILDABLE AREA DIAGRAM - STREET ELEVATION (NTS)

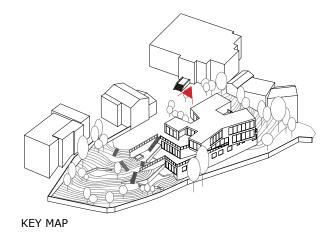



4 SEA CLIFF FROM 25TH AVENUE - PROPOSED




4 SEA CLIFF FROM 25TH AVENUE - EXISTING

COMPARISON BETWEEN EXISTING AND PROPOSED

4 SEA CLIFF

BUTLER ARMSDEN
ARCHITECTS



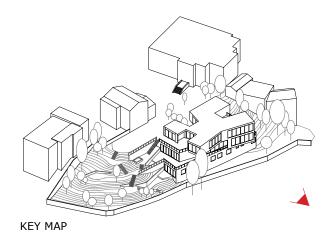

4 SEA CLIFF FROM BAKER BEACH - PROPOSED



4 SEA CLIFF FROM BAKER BEACH - EXISTING

COMPARISON BETWEEN EXISTING AND PROPOSED







890 EL CAMINO DEL MAR SUBJECT PROPERTY (4SEA CLIFF)

KEY MAP

RENDERING OF 4 SEA CLIFF FROM 25TH AVENUE



890 EL CAMINO DEL MAR (1963/RENOVATED 2003)

HISTORICAL PRECEDENTS

4 SEA CLIFF

4 Sea Cliff Avenue facades' articulation, detailing and materials selection draws close parallels to the residence at 890 El Camino Del Mar, designed by Joseph Esherick in 1963. Both the residence at 890 El Camino Del Mar and the project at 4 Sea Cliff Avenue implement a quiet and unimposing appearance that blends into the surroundings; both residences occupy similar siting by embodying the transitional properties to the adjacent parks. 4 Sea Cliff's design resonates with the surrounding context of the Presidio on the east and the north while 890 El Camino Del Mar relates to Lincoln Park to its west. Both properties bookend the neighborhood and are architecturally addressing a different context than the more typical Sea Cliff neighborhood lot.

Additionally, the low one-story street façade of 4 Sea Cliff enhances the view of the Golden Gate Bridge for anyone

walking or driving down 25th Avenue.



535 EL CAMINO DEL MAR

SUBJECT
PROPERTY
(4SEA CLIFF)

SSA CLIFF NEIGHBORHOOD BOUNDARY

PRESIDIO

KEY MAP

RENDERING OF 4 SEA CLIFF FROM BAKER BEACH



535 EL CAMINO DEL MAR (1951/RENOVATED 2014)


HISTORICAL PRECEDENTS

4 SEA CLIFF

The massing, the rhythm of the openings within the facades and the meticulous detailing of the exterior materials of the project at 4 Sea Cliff Avenue resemble the Modern aesthetic of the residence at 535 El Camino Del Mar, designed by J. Lloyd Conrich in 1951. 535 El Camino Del Mar is primarily characterized by the simplicity of the facades, mostly cladded in stained horizontal

wood siding, the large openings, and the lack of ornamentation. In spite of being surrounded by many historical residences, both 535 El Camino Del Mar and 4 Sea Cliff Avenue create a natural presence that fits appropriately in the context of the Sea Cliff neighborhood.



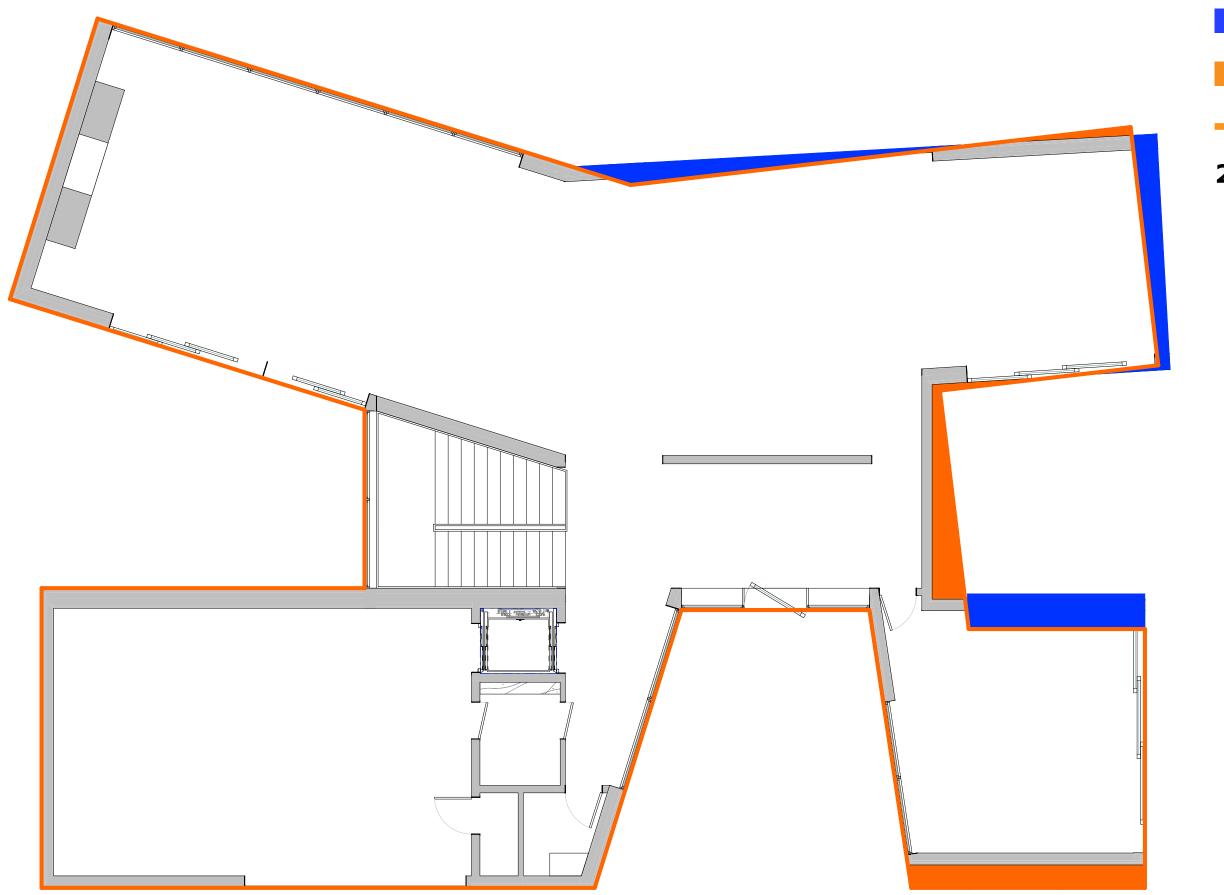

AREA ADDED
91 SQFT

AREA DELETED
63 SQFT

MAIN LV. FOOTPRINT
PRIOR TO THE CHANGE

28 SQFT ADDED TOTAL

8

ADJUSTED AREA DIAGRAM - PLAN (NTS)

ALL FILL SHALL BE COMPACTED PER THE GEOTECHNICAL REPORT AND THE CONTRACTOR SHALL COORDINATE AND COMPLY WITH THE GEOTECHNICAL ENGINEER TO TAKE THE APPROPRIATE TESTS TO VERIFY COMPACTION VALUES.

- IMPORT SOILS SHOULD MEET THE REQUIREMENTS OF THE SOILS REPORT AND SPECIFICATIONS.
- COORDINATE THE PLACEMENT OF ALL SLEEVES FOR LANDSCAPE IRRIGATION (WATER 12. TRENCHES SHALL NOT BE LEFT OPEN OVERNIGHT IN EXISTING PUBLIC STREET AREAS. AND CONTROL WIRING) AND SITE LIGHTING PRIOR TO THE PLACEMENT OF ANY ASPHALT, BASEROCK OR CONCRETE SURFACING. SEE LANDSCAPING AND SITE
- ENGINEER/ARCHITECT.

ELECTRICAL DRAWINGS.

- 11. IT SHALL BE THE CONTRACTOR'S RESPONSIBILITY TO CONFIRM THE GROUND ELEVATIONS AND OVERALL TOPOGRAPHY OF THE SITE PRIOR TO THE START OF CONSTRUCTION AS TO THE ACCURACY BETWEEN THE WORK SET FORTH ON THESE PLANS AND THE WORK IN THE FIELD. ANY DISCREPANCIES SHALL BE IMMEDIATELY BROUGHT TO THE ATTENTION OF THE ENGINEER/ARCHITECT IN WRITING PRIOR TO START OF CONSTRUCTION WHICH MAY REQUIRE CHANGES IN DESIGN AND/OR AFFECT THE EARTHWORK QUANTITIES.
- CONTRACTOR SHALL BACKFILL TRENCHES, OR PLACE STEEL PLATING WITH ADEQUATE CUTBACK TO PREVENT SHIFTING OF STEEL PLATE AND/OR HOT-MIX ASPHALT REQUIRED TO PROTECT OPEN TRENCHES AT THE END OF THE WORKING DAY.
- DO NOT ADJUST GRADES ON THIS PLAN WITHOUT PRIOR WRITTEN APPROVAL OF THE 13. DISTURBED AREAS OF THE SITE SHOULD BE STABILIZED DURING THE RAINY SEASON USING STRAW MULCH (EC-6) OR WOOD MULCHING (EC-8).

14. PERMANENT EROSION CONTROL SHALL BE PROVIDED BY LANDSCAPING SUCH AS

SHRUBS, SOD OR MULCH. LANDSCAPE DESIGN MAY BE SUBJECT TO CHANGE.

- 1. PAVEMENT SECTION TO BE APPROVED BY GEOTECHNICAL ENGINEER
- 2. COLOR AND FINISH OF CONCRETE TO BE SPECIFIED BY LANDSCAPE ARCHITECT.
- 3. SEE LANDSCAPE PLANS FOR ALL WALKWAY FINISHES AND MATERIALS

TOTAL PROPERTY AREA	26,544 SF
IMPERVIOUS AREAS:	
PRE-CONSTRUCTION POST-CONSTRUCTION	14,800 SF 9,000 SF

IMPERVIOUS AREAS

CLEAN OUT TO GRADE FOUND MONUMENT DOUBLE DETECTOR CHECK VALVE VALVE METER BOX STREET LIGHT DRAIN CATCH BASIN

FIRE HYDRANT

BENCHMARK

SPLASH BLOCK

MANHOLE

SIGN

 \Rightarrow

FIRE DEPARTMENT CONNECTION


0000

HIGH POINT INVERT ELEVATION JOINT POLE LANDSCAPE DRAIN LINEAR FEET LOW POINT POINT OF CONNECTION RIM ELEVATION SLOPE SPLASH BLOCK STORM SUB DRAIN STORM DRAIN SEE LANDSCAPE PLANS SANITARY SEWER SANITARY SEWER CLEANOUT TOP OF STEP ELEVATION TOP OF WALL ELEVATION TYPICAL DOMESTIC WATER LINE

WATER METER

OF

Drawing Number:

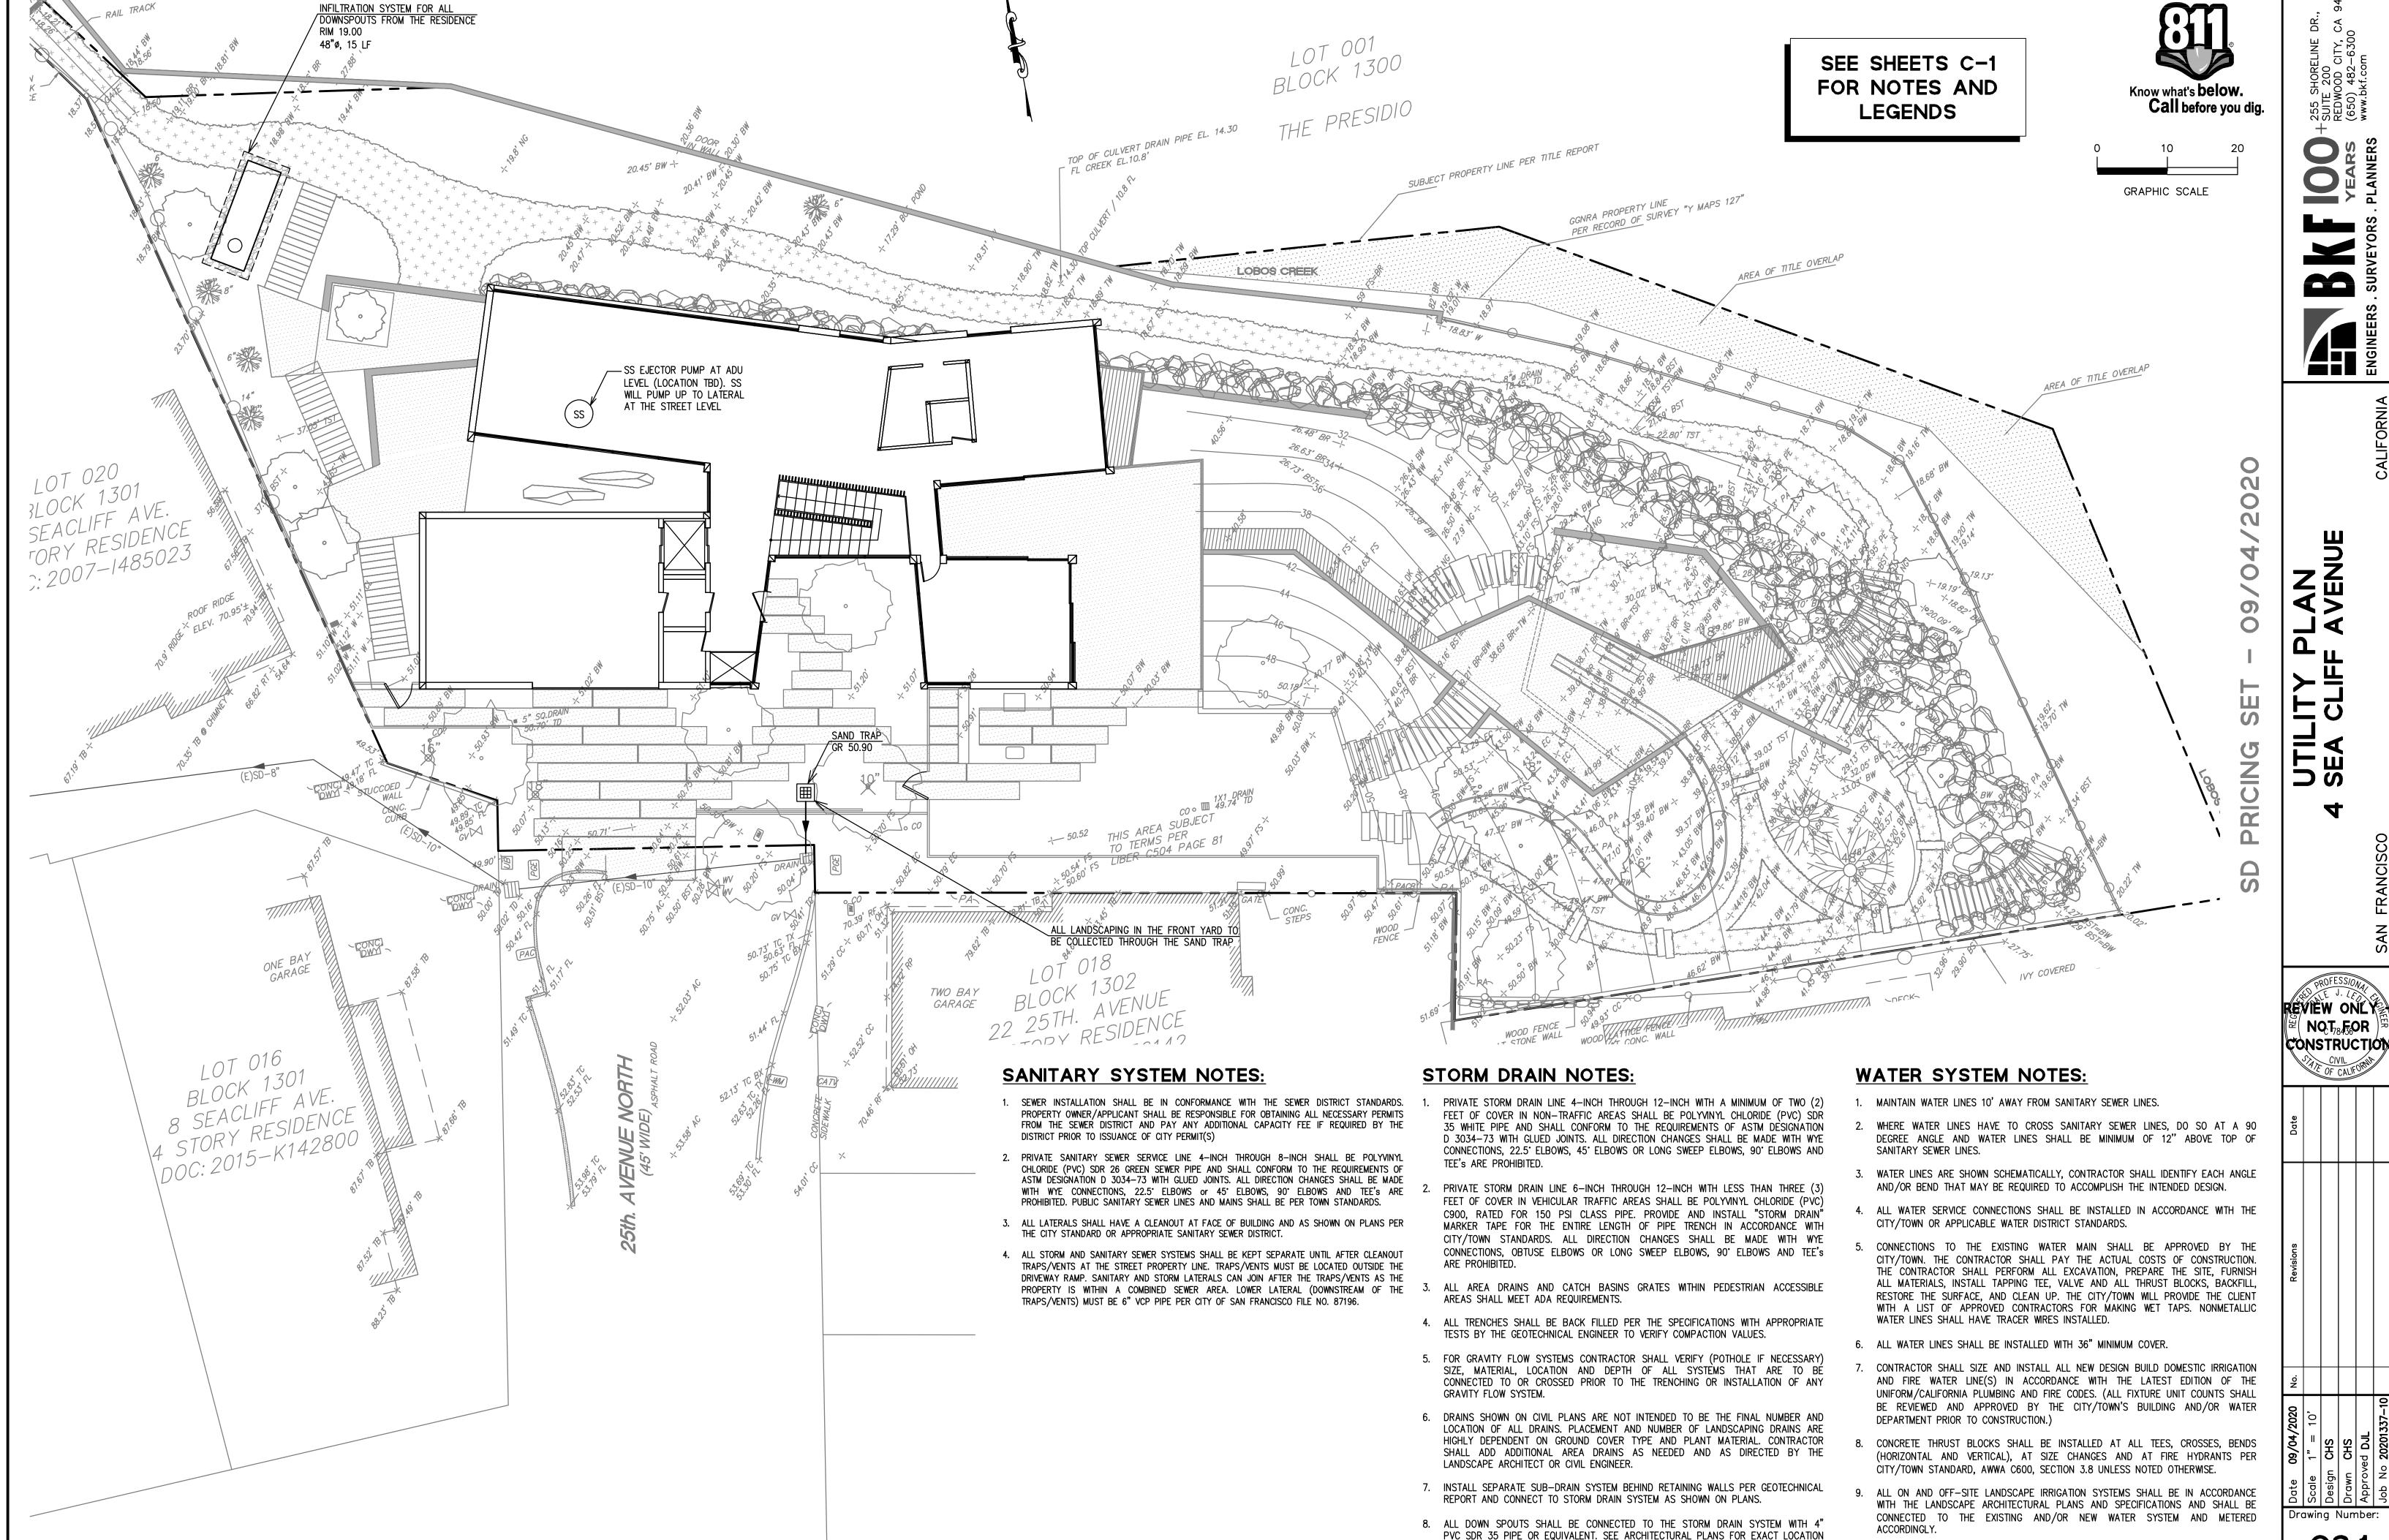


OF THE DOWN SPOUTS. ALL DOWNSPOUT FLOWS MUST BYPASS THE SAND TRAP.


C3.1

10. INSTALL CITY/TOWN APPROVED PRESSURE REGULATOR AND REDUCED BACKFLOW PREVENTOR ON WATER LINE AT ENTRANCE TO BUILDING. REFERENCE PLUMBING PLANS



202 SE **N**4 $\mathbf{\alpha}$ Ш REVIEW ONLY NOT,8F50R CONSTRUCTION ROLLS BY 12 INCHES

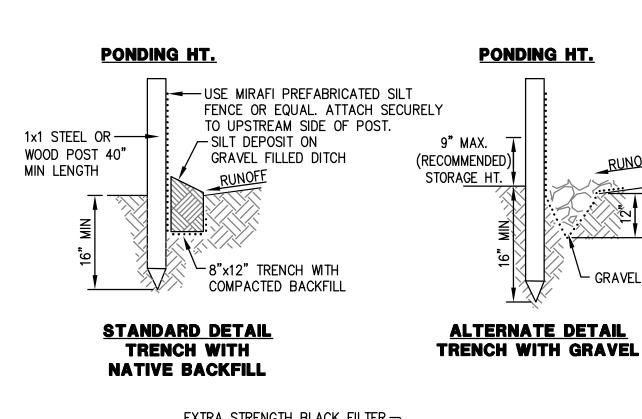

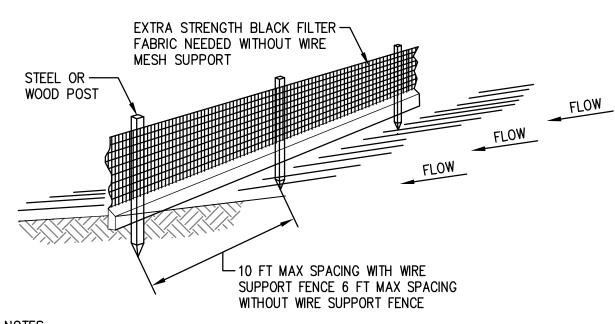

- 1. INSPECT AND REPAIR FENCE AFTER EACH STORM EVENT AND REMOVE SEDIMENT WHEN NECESSARY.
- 2. REMOVED SEDIMENT SHALL BE DEPOSITED TO AN AREA THAT WILL NOT CONTRIBUTE
- SEDIMENT OFF-SITE AND CAN BE PERMANENTLY STABILIZED. 3. SILT FENCE SHALL BE PLACED ON SLOPE CONTOURS TO MAXIMIZE PONDING EFFICIENCY.

SILT FENCE NTS

-MAX. WATER LEVEL. WATERPROOF PLASTIC ----PUMP OUT WHEN IT MEMBRANE, MIRAFI, MCF1212, REACHES THIS LEVEL. OR APPROVED EQUAL. GRAVEL BAG BERM-SECTION A-A

STAGING AREA

DRAINAGE SWALE

-SEDIMENTATION POND TO COLLECT STORMWATER

SILT FENCE AROUND CREEK/CULVERT OPENING

VEHICLE/EQUIPMENT

WASHOUT PIT (NS-8)

FLOWS AND ALLOW SEDIMENT TO SETTLE BEFORE DISCHARGING OFFSITE VIA SWALE

FIBER ROLLS

1. TREE PROTECTION SHALL BE COMPRISED OF SIX-FOOT HIGH

MIN. RADIAL DISTANCE (R):

DO NOT OBSTRUCT PUBLIC

TREE PROTECTION FENCING.

SIDEWALKS OR STREETS WITH

 $R = (6) \times TRUNK DIAMETER$

TREE PROTECTION FENCING -

TYPE I - LANDSCAPE ONLY

CONTINUE FENCING BEYOND SIDEWALK WHERE REQUIRED. -

TYPE II - NEAR PUBLIC ROW

CHAIN LINK FENCING MOUNTED ON

EIGHT-FOOT TALL, 2-INCH

DIAMETER GALVANIZED POSTS,

DRIVEN 24 INCHES INTO THE

GROUND AND SPACED NO MORE

POSTED WITH SIGNS SAYING, "TREE PROTECTION FENCE - DO NOT

MOVE OR REMOVE WITHOUT

WHEREVER PROTECTION IS NEEDED

OUTSIDE OF FENCES,

UNPROCESSED WOOD CHIPS, OR

APPROVED EQUIVALENT, SHALL BE

PLACED TO THE EDGE OF THE

TREE'S CANOPY AND TO A DEPTH

(R) AT THE BASE OF THE TREE, OR EXTENDING TO THE LIMITS OF THE TREE DRIPLINE, WHICHEVER IS

FENCING MUST BE INSTALLED

PRIOR TO ARRIVAL OF MATERIALS,

VEHICLES, OR CONSTRUCTION

NO STOCKPILING OF CONSTRUCTION MATERIALS OR SOIL IS ALLOWED

TRENCHING FOR UNDERGROUND

UTILITIES WITHIN THE TPF MUST BE

APPROVED BY A CERTIFIED

ARBORIST AND BE COMPLETED BY

HAND. NO ROOTS ENCOUNTERED

SHALL BE CUT WITHOUT

APPROVAL OF A CERTIFIED

4. TREE PROTECTION FENCING (TPF) SHALL BE SET A RADIAL DISTANCE

APPROVAL FROM CITY ARBORIST".

2. TREE PROTECTION SHALL BE

THAN 10 FEET APART.

OF 6 INCHES.

GREATER.


EQUIPMENT.

ARBORIST.


TREE PROTECTION FENCING

NTS

VEHICLE/EQUIPMENT WASHOUT PIT

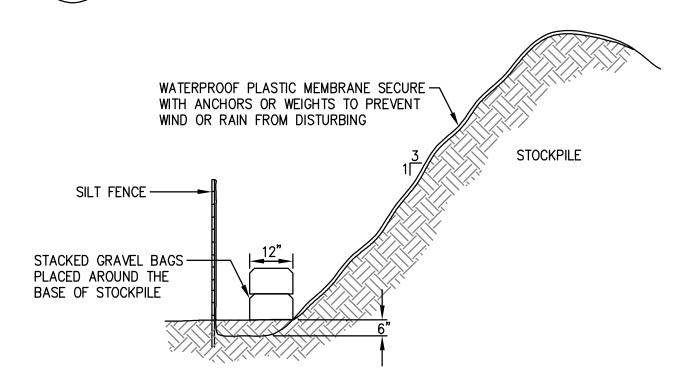

STOCKPILE COVERING

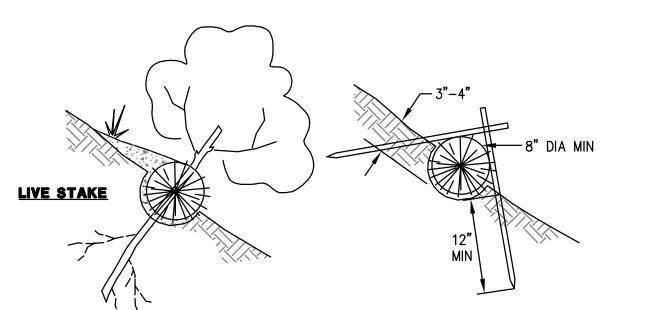

VERTICAL SPACING

DEPENDS SLOPE

STEEPNESS. SEE

NOTE NUMBER 2.

FIBER ROLLS MUST

BE PLACED ALONG

SLOPE CONTOURS

- SEDIMENT, ORGANIC MATTER,

"CAPTURED BEHIND THE ROLLS.

AND NATIVE SEEDS ARE

(2) 1' X 1' STAKES CROSSED

GRAPHIC SCALE

- EXISTING CONCRETE WALL TO REMAIN. EXCAVATE

12"X12" TRENCH OF SAND OR BRICK IN FRONT OF WALL

AND LAY SILT FENCE MATERIAL IN TRENCH AND THEN

CONSTRUCTION TO BE COORDINATED WITH CONTRACTOR.

ATTACH TO BOTTOM OF FENCE ABOVE. DETAILS OF

- 1. FIBER ROLL INSTALLATION REQUIRES THE PLACEMENT AND SECURE STAKING OF THE ROLL IN A TRENCH, 3" TO 4" DEEP, DUG ON CONTOUR. RUNOFF MUST NOT BE ALLOWED TO RUN UNDER OR AROUND ROLL.
- 1. VERTICAL SPACING FOR SLOPE INSTALLATIONS: SLOPE OF 2:1 OR GREATER = 10 FEET APART
- SLOPE BETWEEN 4:1 AND 2:1 = 15 FEET APART SLOPE OF 4:1 OR FLATTER = 20 FEET APART 2. INSPECT AND REPAIR FIBER ROLLS AFTER EACH STORM EVENT AND
- REMOVE SEDIMENT WHEN NECESSARY.
- 3. REMOVED SEDIMENT SHALL BE DEPOSITED TO AN AREA THAT WILL NOT CONTRIBUTE SEDIMENT OFF-SITE AND CAN BE PERMANENTLY STABILIZED.

FIBER ROLL NTS

337_4_Seq_Cliff_Ave PLOTTED BY: smic

Drawing Number:

PROPOSED



1	
SDEN.COM	4
	ш
	ш
	\Box
	-
	_
	U
	4

94121

S 0,

A ರ

SEA

4

PROPOSED

PROJ	ECT DA	TA	
BLOCK: LOT:	1302 017	ZONED: HEIGHT LIMIT:	
LOT SIZE:	26,432 SQFT.	OCCUPANCY:	R-3
UNCONDITI	ONED SPACE		PROPOSED
MAIN LEVEL MID LEVEL LOWER LEV	FLOOR		790 SQFT. 965 SQFT. 44 SQFT.
SUB TOTAL:			1,799 SQFT.
CONDITION	ED SPACE		PROPOSED
MAIN LEVEL MID LEVEL LOWER LEV		CLUDING ADU)	2,988 SQFT. 3,504 SQFT. 2,849 SQFT.
ADU			PROPOSED
@ LOWER L	EVEL FLOOR		799 SQFT.
SUB TOTAL:			10,140 SQFT.
			PROPOSED
DWELLING	UNITS		1 + ADU

SCOPE OF WORK

PROJECT TEAM

420 SUTTER ST., FIRST FLOOR SAN FRANCISCO, CA 94109

415-735-6180

989 SUTTER STREET

GEOTECHNICAL ENGINEER:

SAN FRANCISCO, CA 94109 T 415-670-9123

LANDSCAPE DESIGNER:

TRUCTURAL ENGINEER

REDWOOD CITY, CA 94065 T 650-482-6300

BKF ENGINEERS 255 SHORELINE DRIVE, SUITE 200

511 15TH STREET SAN FRANCISCO, CA 94103

415-778-8726

CIVIL ENGINEER:

415-674-5554 INFO@BUTLERARMSDEN.COM

THE PROJECT CONSISTS OF CONSTRUCTION OF A NEW, 3- STORY, SINGLE FAMILY RESIDENCE WITH ADU AT THE LOWER LEVEL FLOOR. NEW RESIDENCE SHALL HAVE A ONE BEDROOM ADU WITH BATHROOM AND KITCHEN AT THE LOWER LEVEL FLOOR. THE RESIDENCE SHALL HAVE 5 BEDROOMS, 2 1/2 BATHS AND 5 FULL BATHROOMS. THE PROJECT WILL REQUIRE A CONDITIONAL USE PERMIT SINCE IT INVOLVES THE DEMOLITION OF AN EXISTING RESIDENCE.

CONSTRUCTION CLASSIFICATION

SHEET INDEX

2019 S.F. MECHANICAL CODE 2019 S.F. PLUMBING CODE 2019 S.F. PLUMBING CODE 2019 S.F. FIRE CODE

CODES

GENERAL NOTES

ALL WORK SHALL BE IN COMPLIANCE WITH ALL APPLICABLE LOCAL BUILDING CODES AND REGULATIONS. CONTRACTOR SHALL BE RESPONSIBLE FOR PERMITS APPLICABLE TO SPECIFIC TRADES OR SUBCONTRACTORS.

CONTRACTOR WILL HAVE EXAMINED THE PREMISES AND SITE SO AS TO COMPARE THEM WITH CONTRACTOR WILL HAVE EXAMINED THE PREMISES AND SITE SO AS TO COMPARE THEM WITH THE DAWNINGS AND WILL HAVE SATISFIED SELF AS TO THE CONDITION OF ENGSTHIC WORK AND THE CONTRACTOR BY RESPONDING THE SUBSEQUENT OF THE CONTRACTOR BY REASON OF ANY OMNISCION OF ENGSTHIC WORK AND INCLUDE THE COSTS OF ALL ITEMS OF WORK, ETHER LABOR OR MATERIALS, WHETHER THEY ARE OR ARE NOT ESPECIALLY OR PARTICULARLY SHOWN OR NOTED BUT WHICH ARE IMPLEED OR REQUIRED TO ATTAIN THE COMPLETED CONDITIONS PROPOSED IN THE DRAWINGS. ALL SUBCONTRACTORS TO THE GENERAL CONTRACTORS SHALL CONVEY ANY QUESTIONS REGARDING DESIGN INTENT AND SCOPE OF WORK TO THE ARCHITECT PRIZOR TO SUBMITTING BID AND PRIOR TO COMPINENCING WORK.

CONTRACTOR SHALL COORDINATE THE WORK OF THE VARIOUS TRADES AND SUBCONTRACTORS AND OF PERSONS DIFFECTIVE OR INDIRECTIVE PRIZOR TO SUBMITTION BID AND PRICE TO COMPISSIONS, OR RERORDS OF THE SUBCONTRACTORS AND SHALL BE RESPONSIBLE OR RESPONSIBLE TO BURNETIVE FOR DIFFERENCE ON THE SUBCONTRACTORS AND OF PERSONS DIFFECTIVE OR INDIRECTIVE PRIZOR TO SUBMISSIONS, OR RERORDS OF THE SUBCONTRACTORS AND SHALD BE RESPONSIBLE OR RESPONSIBLE TO BURNETIVE FOR DISTECTIVE OR THE SUBCONTRACTORS AND OF PERSONS DIFFECTIVE OR RESPONSIBLE TO BURNETIVE FOR DISTECTIVE OR BURNETIVE FOR THE SUBCONTRACTORS OF PERSONS DIFFERENCY OR RESPONSIBLE TO BURNETIVE OR FOR DISTECTIVE OR BURNETIVE FOR THE SUBCONTRACTOR TO OFFICE TO MATERIAL TO REPORT THE SUBCONTRACTOR SO OFFICE TO MATERIAL TO REPORT TO THE SUBCONTRACTOR SO OFFICE TO MATERIAL TO REPORT TO THE SUBCONTRACTOR SO OFFICE TO MATERIAL TO THE SUBCONTRACTOR SO OFFICE TO SUBCONTRACTOR SO O

OF PRESONS AND PROPERTY FOR THE AUGUSTATION OF THE BRIDGE.

OF TRESONS AND PROPERTY FOR THE AUGUSTATION OF THE BRIDGE.

CONTRACTOR TO COMPORN TO MOMEDIMENS ASSOCIATION RULES AND QUIDELINES.

CONTRACTOR TO CONTRACTOR TO MOMEDIMENS ASSOCIATION RULES AND QUIDELINES.

CONTRACTOR TO NOTIFY ARCHITECT IMMEDIATELY AND PRIOR TO ORDERING OF ALL LONG LEAD ITEMS AND OF APPROXIMATE DELIVERY DATES.

ALL CONSTRUCTION MATERIALS AND SUPPLIES TO BE STORED, HANDLED, AND INSTALLED ACCORDING TO MANUFACTURES' RECOMMENDATIONS.

IF ERRORS OR OMISSIONS ARE FOUND IN THE DRAWINGS THE SHALL BE BROUGHT TO THE DRAWINGS SCHEMATICALLY INDICATE NEW CONSTRUCTION. THE CONTRACTOR SHOULD ANTICIPATE, BASED ON EXPERIENCE, A REASONABLE NUMBER OF ADJUSTMENTS TO BE NECESSARY TO MEET THE DESIGN OBJECTURES AND SHOULD CONSIDER SUCH ADJUSTMENTS AS INCLUDED IN THE SCOPE OF WORK.

WHEN SPECIFIC FEATURES OF CONSTRUCTION ARE NOT FULLY SHOWN ON THE DRAWINGS OR CALLED ON THE THE DEFINANCE OF CONSTRUCTION SHALL BE OF THE SAME CHARACTER ALL DIMENSIONS TO BE TEACHER AND MOMENT OF AND THE ADDRESS OF THE SAME CHARACTER ALL DIMENSIONS TO BE TAKEN FROM INITIATIVE DESCINATIONS AND A PROVINCIAL DRAWS OF THE ADDRESS OF THE SAME CHARACTER ALL DIMENSIONS TO BE TAKEN FROM INITIATIVE DESCINATIONS AND AND A PROVINCIAL DRAWS OF THE SAME CHARACTER ALL DIMENSIONS TO BE TAKEN FROM INITIATIVE DESCINATIONS AND AND A PROVINCIAL DRAWS OF THE PROVINC

AS SINUAR CONDITIONS. IN THE CONSTRUCTION SHALL BE OF THE SAME CHARACLER AS SINUAR CONDITIONS.

ALL DIMENSIONS ARE TO PARTICULAR DIVISIONS OF THE WORK. SEE SPECIFIC REQUIREMENTS ARE INDICATED APPLICABLE TO PARTICULAR DIVISIONS OF THE WORK. SEE SPECIFICATIONS AND GENERAL NOTES IN THE SUBSECTIONS OF THESE DRAWINGS.

ALL DIMENSIONS ARE TO FACE OF FINISH, U.O.N.

WEATHER STRIPPIAL LL DOORS LEADING FROM HEATED TO UNHEATED AREAS. PROVIDE VINYL BEAD TYPE WEATHER STRIPPING AT THESE DOORS AND WINDOWS. ALL SIDES OF THE DOOR MUST BE WEATHERSTRIPPED, INCLUDING THE THESEFOLD.

CAULK AND SEAL OPENINGS IN BUILDING EXTERIOR 1/8" OR GREATER TO PREVENT AIR INFILITATION.

INFLITATION.
WILLIAM TO BE OPERABLE AND CLEANED, U.O.N.
WILLIAM TO BE OPERABLE AND CLEANED TO BE OPERABLE OF THE O

U.O.N. STRUCTURAL WOOD MEMBERS ADJACENT TO CONCRETE ARE TO BE PRESSURE TREATED DOUGLA:

NOTE: DESIGN BASED ON THE ADJACENT MENTIONED CODE SECTIONS. CONSTRUCTION SHALL CONFORM TO ALL APPLICABLE CODES.

SHEET	NAME	SITE PERMIT 5/29/20	REVISION 1 5/26/21	7/16/21
A0.0	TITLE SHEET	х	x	х
A0.1	SURVEY	x		
A0.2	SURVEY	x		
A0.4	PROPOSED SITE PLAN	x	×	х
A0.5	STREET VIEWS	x		
A0.6	STREET VIEWS	x		
A0.7	RENDERINGS	x	х	
A0.8	GREEN BUILDING CHECKLIST	x		
A2.1	(NOT USED)			
A2.2	PROPOSED LOWER LEVEL PLAN	x	×	х
A2.3	PROPOSED MID LEVEL PLAN	x	×	х
A2.4	PROPOSED MAIN LEVEL PLAN	x	х	х
A2.5	PROPOSED ROOF PLAN	x	×	х
A3.1	PROPOSED ELEVATION	x	×	
A3.2	PROPOSED ELEVATION	x	×	×
A3.3	PROPOSED ELEVATION	x	х	х
A3.4	PROPOSED ELEVATION	x	х	х
A3.5	PROPOSED SECTION	х	х	х
A3.6	PROPOSED SECTION	х	х	х
A3.7	PROPOSED SECTION	×	x	×

VICINITY MAP

4	O.R.B.	OIL RUBBED BRONZE			WATERPROOFING
	P.G. PL. PLAM.	PAINT GRADE PLATE PLASTIC LAMINATE			
	PLYWD. PR.	PLYWOOD PAIR		ROOF UNDERLA	YMENT OR SELF ADHERING
	P.T.	PRESSURE TREATED			
483 THESE	PL P.T. PTD.	PROPERTY LINE	A A A S S S S S S S S S S S S S S S S S	No DEL MAR.	1302 SEA CLIFF-1 LOTS 1 TO 19 ACVISED 151 AVAILABLE 151 AVAILAB
\ (499			
SANBORN MA	Р		ASSES	SORS BLOCK	MAP

SYMBOLS

A9.1

A5.1

(00)

00

1

1

1

_ _ _ _

V V V V

DRAWING/DETAIL REFERENCE TAG

DRAWING OR DETAIL
SHEET WHERE DRAWING/DETAIL OCCURS

SECTION/ELEVATION REFERENCE TAG BUILDING SECTION
SHEET WHERE SECTION OCCURS

INTERIOR ELEVATION REFERENCE TAG

DOOR TAG

WINDOW TAG

APPLIANCE TAG

REVISION TAG

ALIGN

LINE ABOVE

PROPERTY LINE

DOOR/WINDOW OPERATION CENTER LINE

INSULATION IN SECTION (BATT)

INSULATION IN SECTION (RIGID)

LATH AND PLASTER IN SECTION

SHEET APPLIED WATERPROOFING

PRE-APPLIED SHEET MEMBRANE

GYPSUM BOARD IN SECTION

FINISH WOOD IN SECTION

PLYWOOD IN SECTION

GLASS IN SECTION

DRAIN MAT

DRAINABLE BATTENS

SETBACK

CONCRETE

WORKPOINT OR DATUM THRESHOLD

INTERIOR ELEVATION SHEET WHERE INTERIOR ELEVATION OCCURS

ABBREVIATIONS

NEW REPLACE IN KIND

ANCHOR BOLT
ABOVE
ADJACENT
ABOVE FINISHED FLOOR
AGGREGATE
ALIGN
AUMINUM
APPROXIMATE
ARCHITECTURAL
AUDIO VISUAL

BOARD
BETWEEN
BUILDING
BLOCK
BLOCKING
BEAM
BOTTOM OF
BOTTOM OF WALL
BUILT-UP ROOFING

BD. BET. BLDG. BLK. BLKG. BM. B.O. B.O.W. B.U.R.

DBL. DTL. DIA. DIM. DN DR. DS. DWG. DWG.

FINISH CEILING FLOOR DRAIN FURNITURE, FIXTURES & EQUIP. FINISH FLOOR

GAGE
GROUND FAULT INTERCEPTOR CIRCUIT
GLASS
GRADE
GROUND
GALVANIZED SHEET METAL

GALVANIZED

HOSE BIB HOLLOW CORE HARDWOOD HARDWARE HEIGHT HORIZONTAL HOUR

INCH OR INCHES INSULATION INTERIOR

NORTH NOT IN CONTRACT

OVER OVERALL OR APPROVED EQUAL

NOMINAL NOT TO SCALE

F.D. F.F. & E.

FIN. FLR. FLUOR FIXT. F.O. F.O.C. F.O.S. FNDN. FT. FTG. FURR.

GALV. GA. G.F.I.C.

H.B. H.C. HDWD. HDWR. HT. HORIZ. HR.

N. N.I.C. NO. NOM. N.T.S.

RAD. R.D. REC. RDWE REF. REFR. REINF. REQ. RESIL. R.L. RM.

U.O.N.

REINFORCED REQUIRED RESILIENT RAIN LEADER

SOUTH SOLID CORE

TREAD TOWEL BAR

TELEPHONE TONGUE AND GROVE THICK

THICK
TEMPERED
TOP OF
TOP OF PAVEMENT
TOP OF WALL
TOILET PAPER HOLDER
TUBULAR STEEL
TELEVISION
TYPICAL

UNLESS OTHERWISE NOTED

VINYL COMPOSITION TILE

WITHOUT WATERPROOFING WEIGHT

SMOKE DETECTOR

SLOPE
SEE LANDSCAPE DRAWINGS
SLAB ON GRADE
SPECIFICATION
SQUARE
SEE STRUCTURAL DRAWINGS
STAINLESS STEEL
STANDARD
STEEL
STORMAGE


SITE PERMIT

REVISIONS:	BY:					
1 REVISION 1	1 REVISION 1 5/26/2021					
2 REVISION 2	7/16/2021	AM				
						


JOB#:	1920
DATE:	5/29/2020
DRAWN:	JW, SK, AM
CHECKED:	GF, JW
SCALE:	AS NOTED





TITLE SHEET

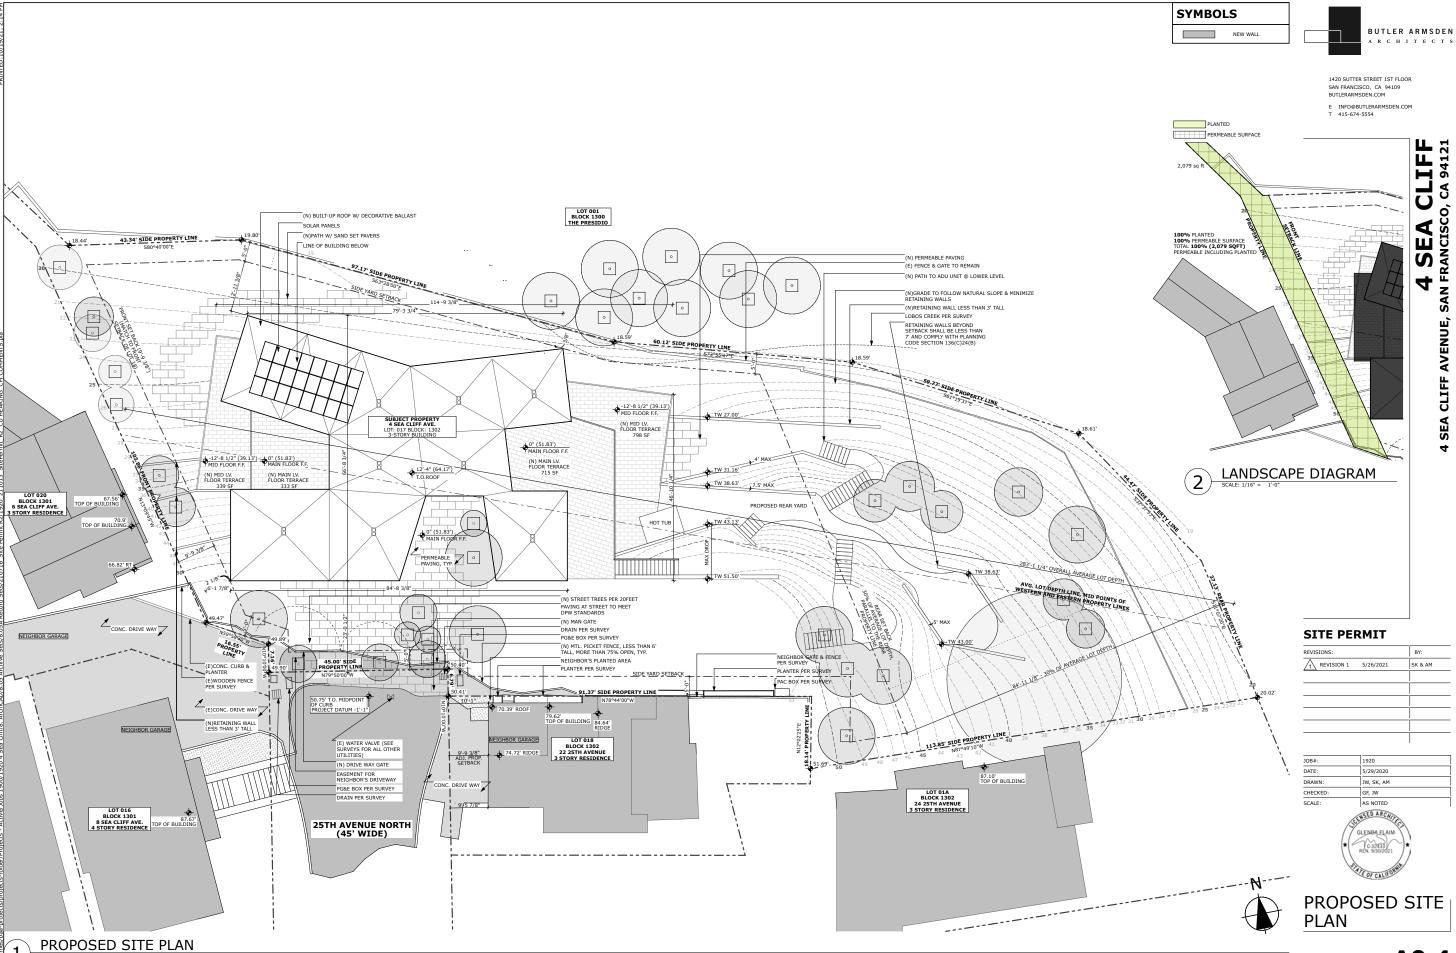



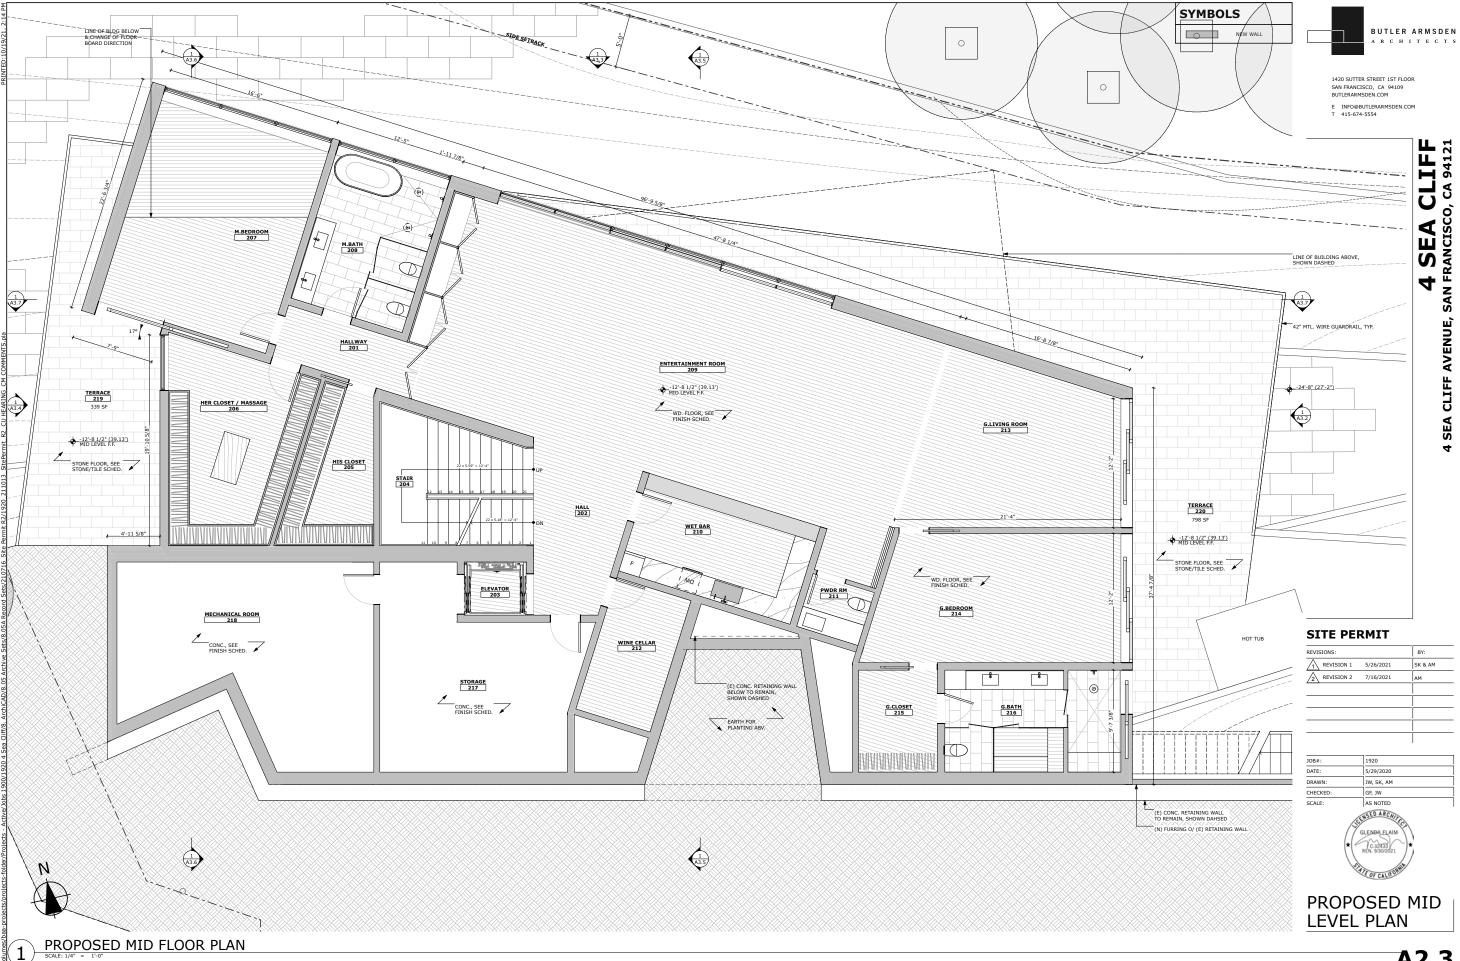

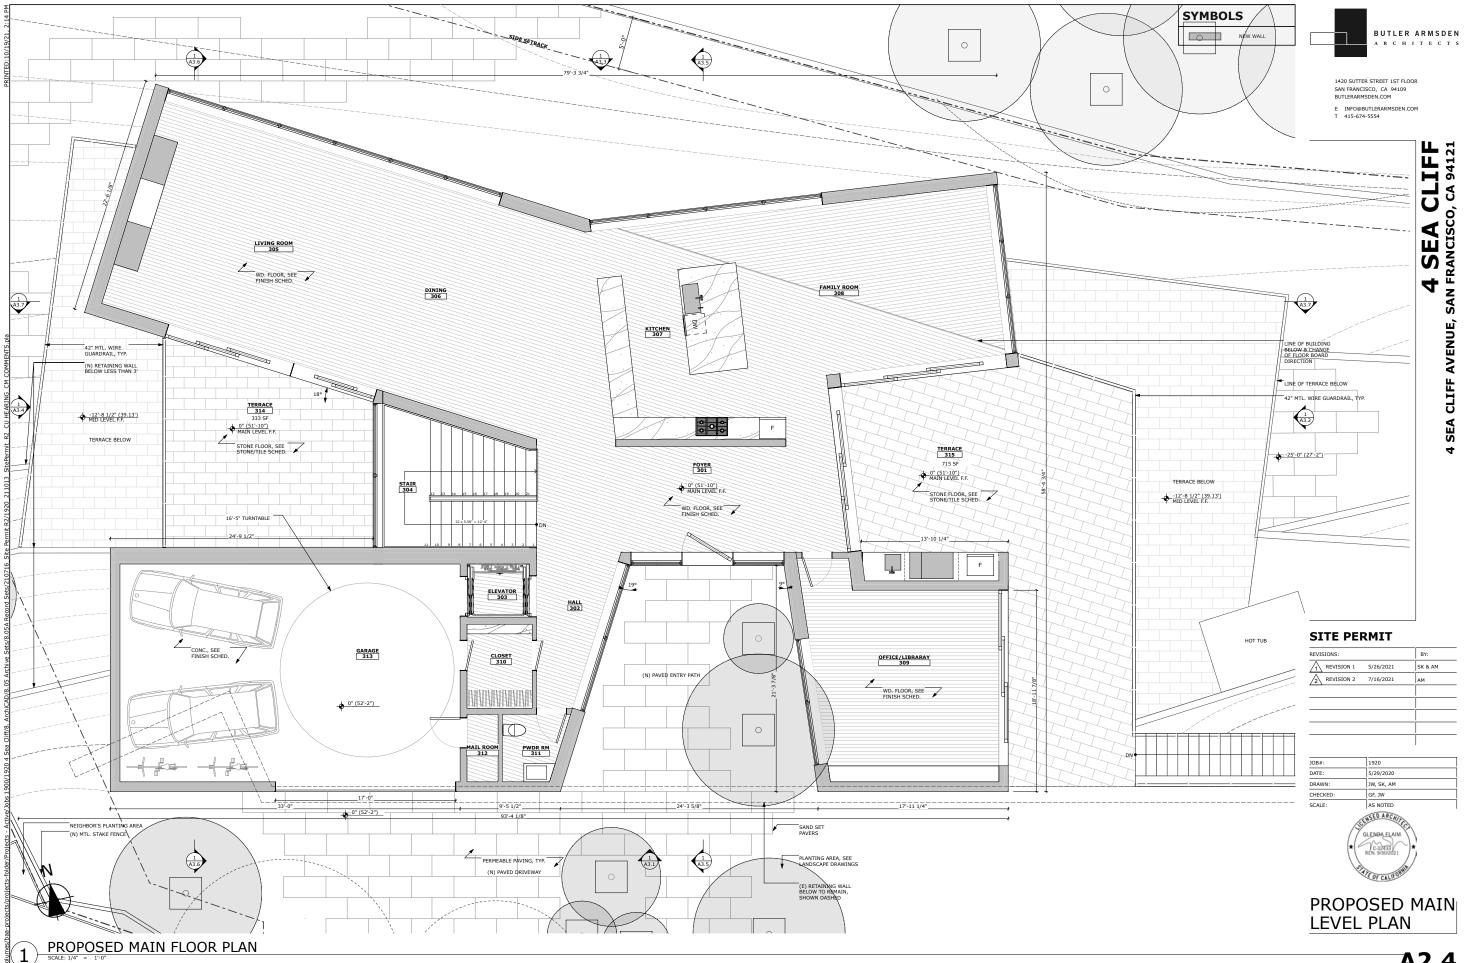


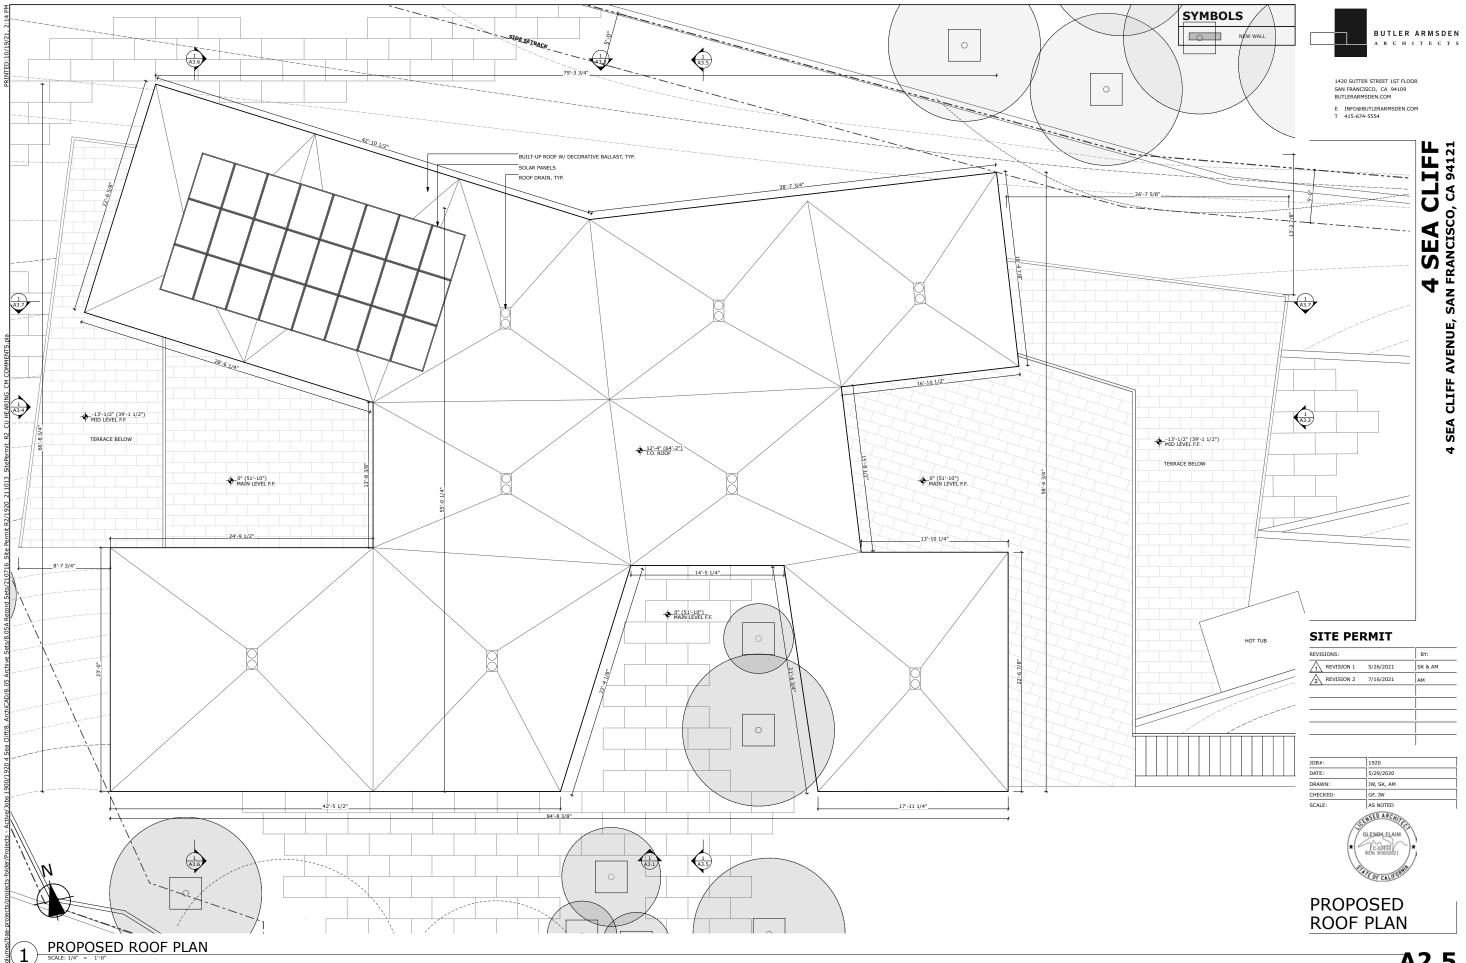





SEA CLIFF AVENUE,

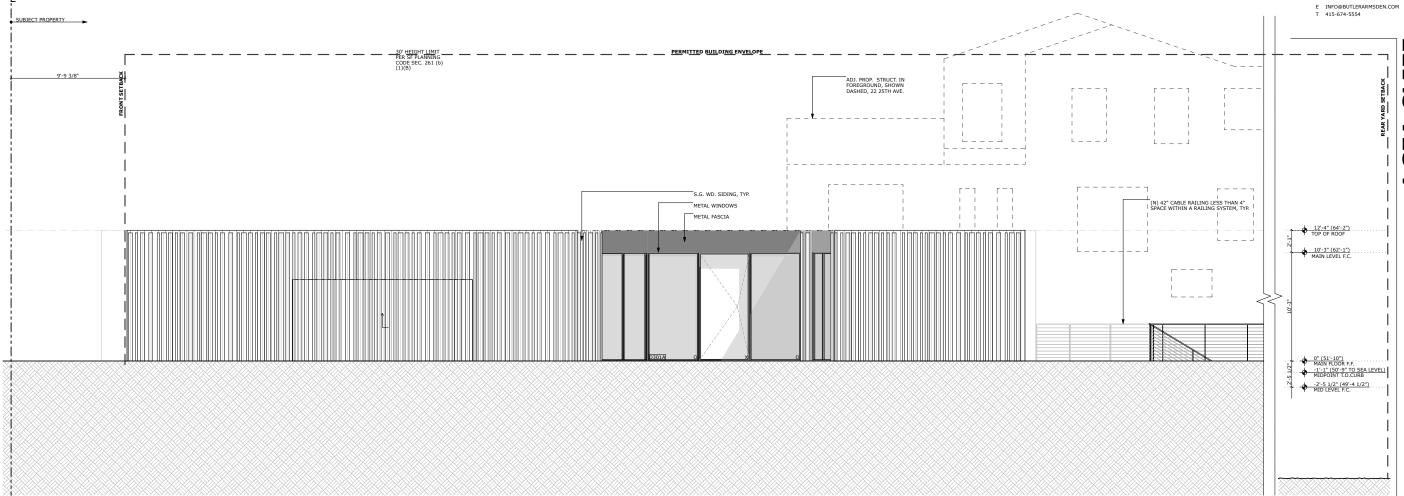

PROPOSED SOUTH ELEVATION
SCALE: 1/4" = 1'-0"

SITE PERMIT


REVISIONS:		BY:
1 REVISION 1	5/26/2021	SK & AM
2 REVISION 2	7/16/2021	AM
		_

JOB#:	1920
DATE:	5/29/2020
DRAWN:	JW, SK, AM
CHECKED:	GF, JW
SCALE:	AS NOTED




PROPOSED ELEVATION



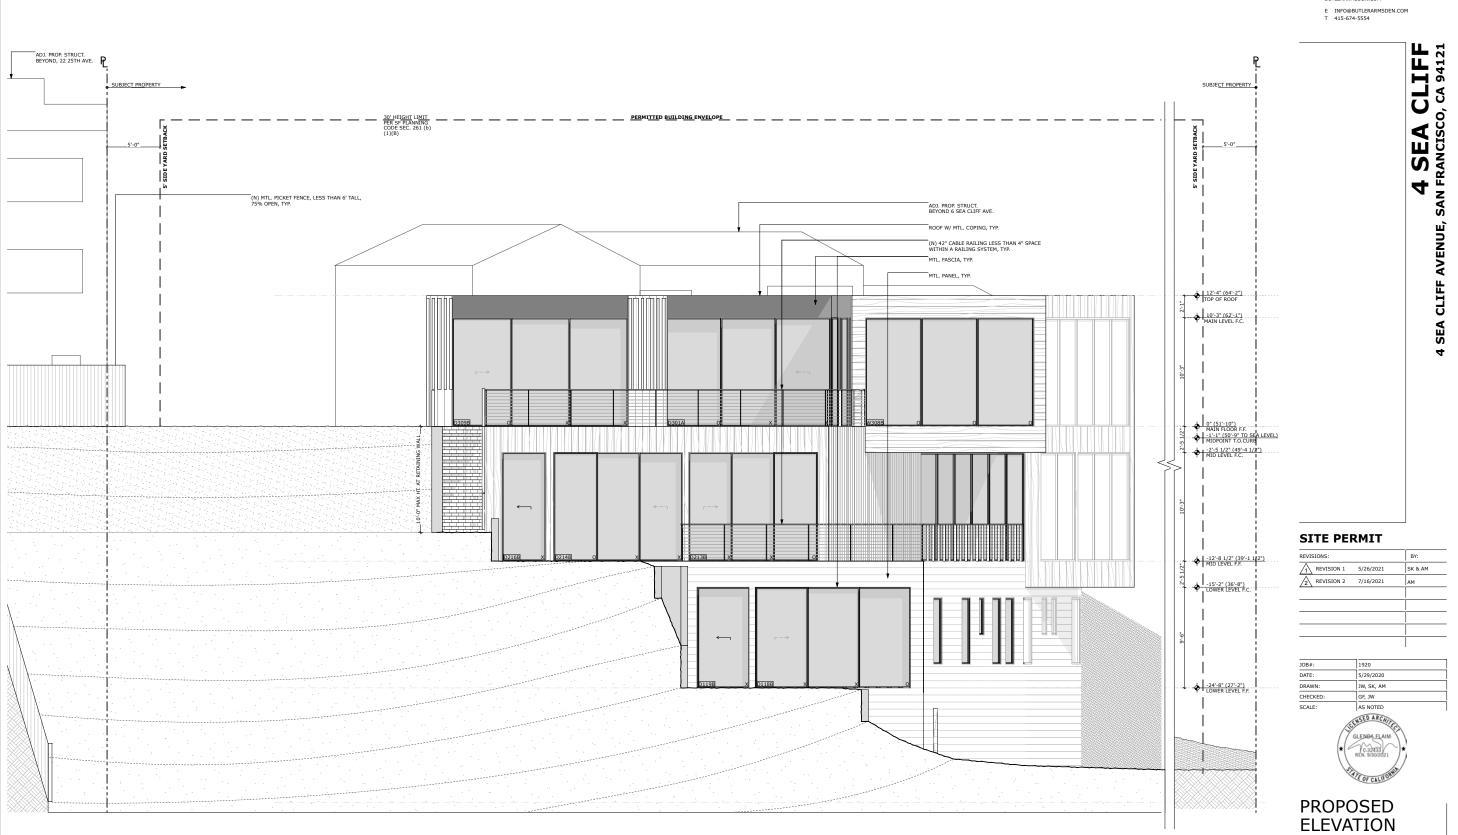

PROPOSED EAST ELEVATION

SCALE: 1/4" = 1'-0"

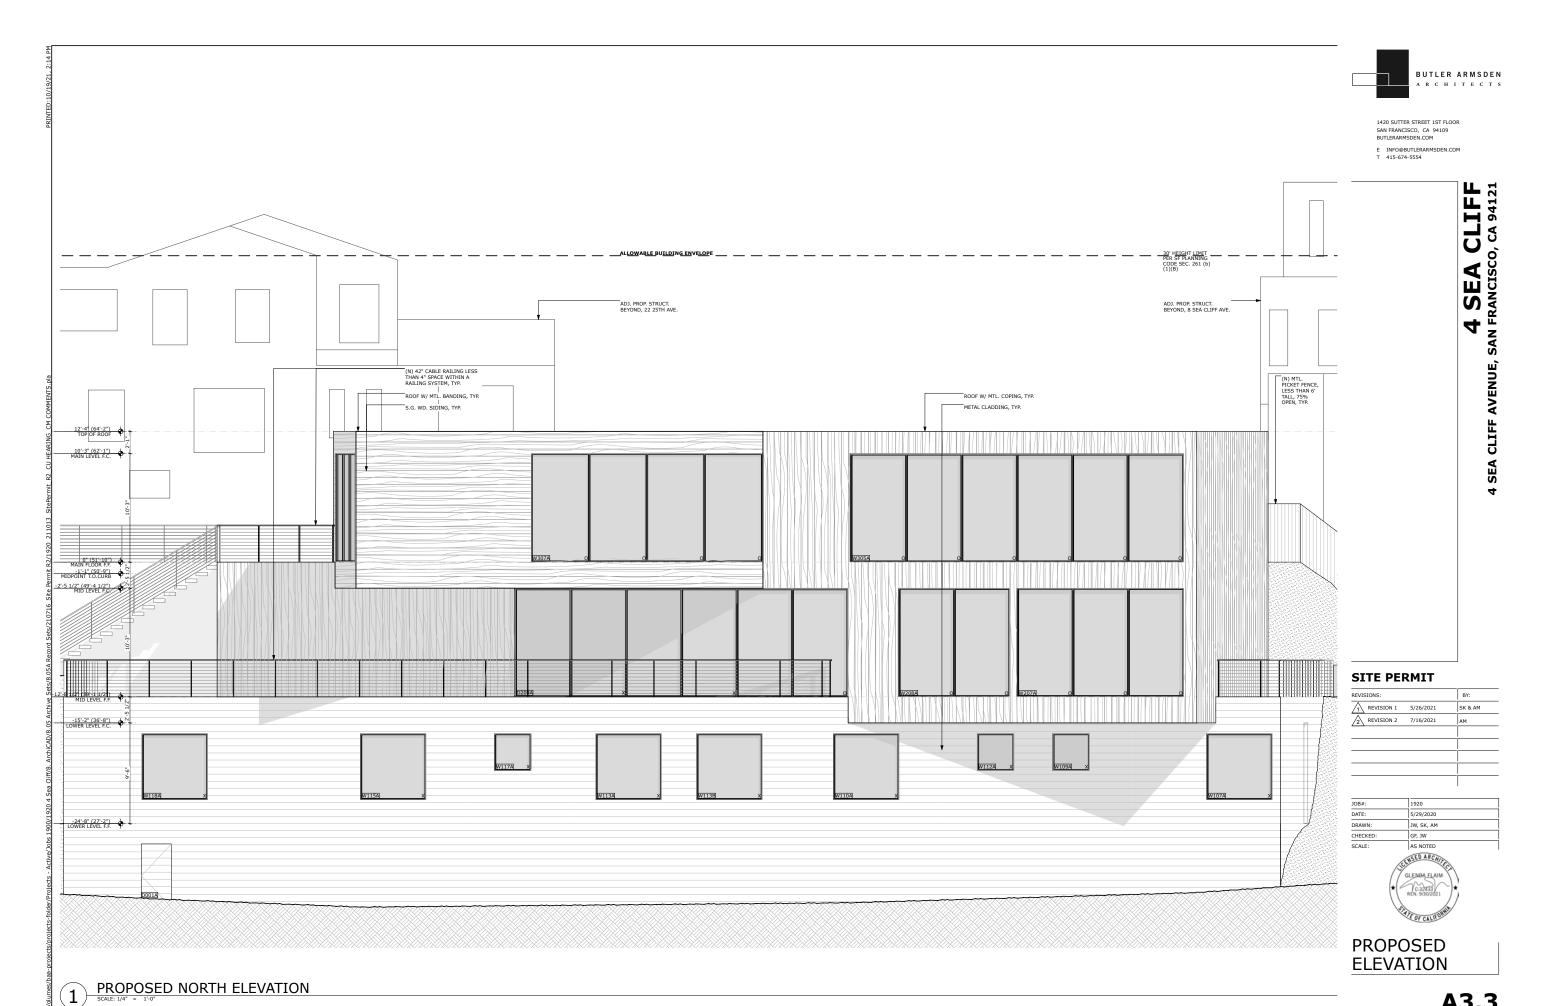




E INFO@BUTLERARMSDEN.COM T 415-674-5554

CLIFF 0, CA 94121

4 SEA CLIFF AVENUE,

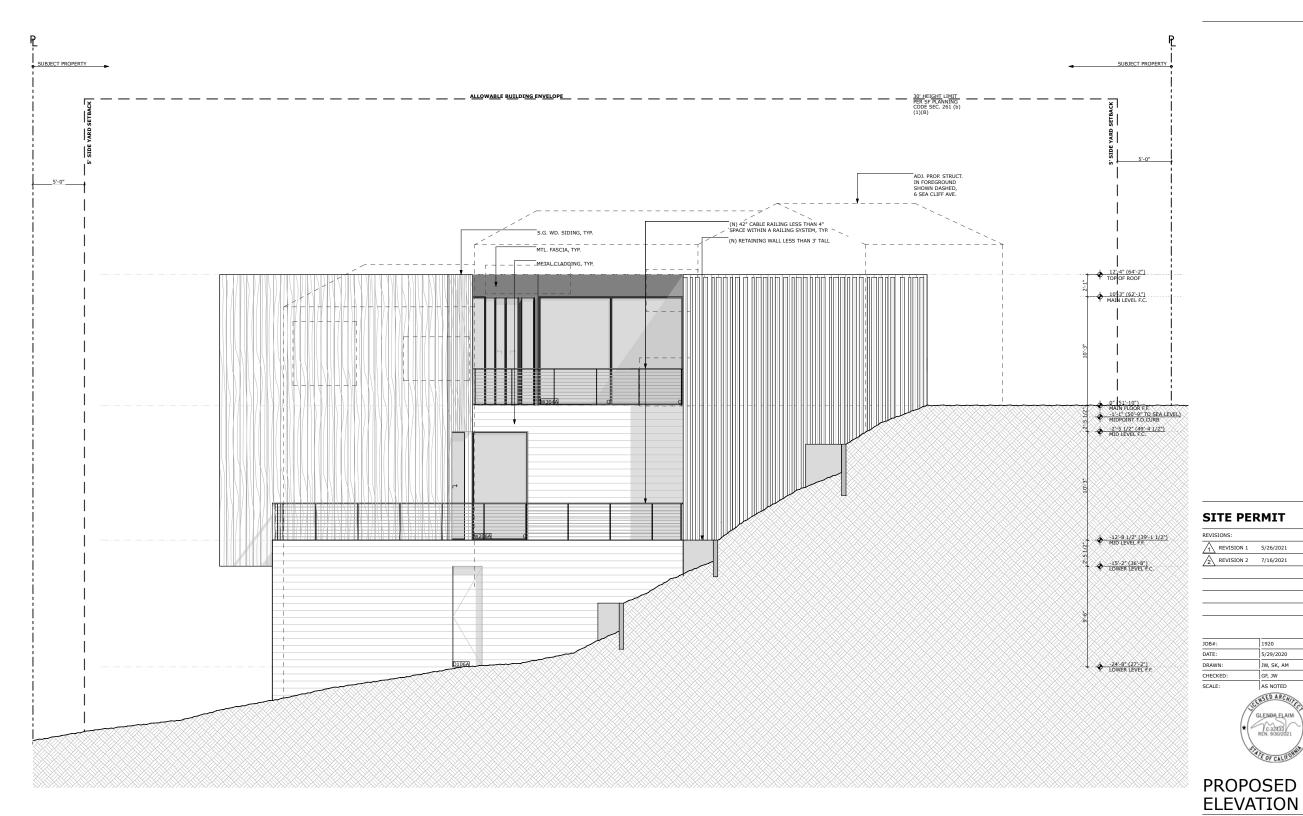

1920 5/29/2020 JW, SK, AM

GF, JW AS NOTED ELHSED ARCHITEC





PROPOSED TRANSVERSE SECTION-2



E INFO@BUTLERARMSDEN.COM T 415-674-5554

4 SEA CLIFF AVENUE, SAN FRANCISCO, CA 94121



SITE PERMIT

	BY:
5/26/2021	SK & AM
7/16/2021	AM

JOB#:	1920
DATE:	5/29/2020
DRAWN:	JW, SK, AM
CHECKED:	GF, JW
SCALE:	AS NOTED



PROPOSED SECTION



PROPOSED SECTION



S

¥ ರ SEA

4

VICINITY MAP

415-735-6180 GEOTECHNICAL ENGINEER

989 SUTTER STREET SAN FRANCISCO, CA 94109 T 415-670-9123

PROJECT TEAM

420 SUTTER ST., FIRST FLOOR SAN FRANCISCO, CA 94109

415-674-5554 INFO@BUTLERARMSDEN.COM

ALL WORK SHALL BE IN COMPLIANCE WITH ALL APPLICABLE LOCAL BUILDING CODES AND REGULATIONS. CONTRACTOR SHALL BE RESPONSIBLE FOR PERMITS APPLICABLE TO SPECIFIC TRADES OR SUBCONTRACTOR SHALL BE RESPONSIBLE FOR PERMITS APPLICABLE TO SPECIFIC TRADES OR SUBCONTRACTOR SHALL BE RESPONSIBLE FOR PERMITS APPLICABLE TO SPECIFIC TRADES OR SUBCONTRACTOR WILL HAVE SATISFIED SELF AS TO THE CONDITION OF EXISTING WORK AND ADJACENT ROPERTY PRICE OF SUBMISSION OF BID. NO ALLOWANCES WILL SUBSEQUENTLY BE MADE ON BEHALF OF THE CONTRACTOR BY REASON OF ANY OMISSION ON HISHIRET PART TO LOW ADJACENT PRACTICAL STREAM OF THE CONTRACTOR BY REASON OF ANY OMISSION ON HISHIRET PART TO LOW ARE MILL SPECTALLY OR PRACTICAL STREAM OF THE CONTRACTOR BY REASON OF ANY OMISSION ON HISHIRET PART TO REQUIRED TO ATTAIN THE COMPLETED CONDITIONS PROPOSED BIT THE DRAWINGS.
ALL SUBCONTRACTORS TO THE GENERAL CONTRACTOR SHALL CONVEY ANY QUESTIONS REGARDING DESIGN INTENT AND SCOPE OF WORK TO THE ARCHITECT PRIOR TO SUBMITTING BID AND PRIOR TO COMPRECION OF THE SUBCONTRACTORS AND SHALD ERESPONSIBLE FOR ANY ACTS, OMISSIONS, OR ERRORS OF THE SUBCONTRACTORS AND SHALD ERESPONSIBLE FOR ANY ACTS, OMISSIONS, OR ERRORS OF THE SUBCONTRACTORS OF PERSONS AND PROPERTY FOR THE DUBRATION OF THE PROJECT.
CONTRACTOR TO ASSIME SOLE RESPONSIBILITY FOR JOB SITE CONDITIONS INCLUDING SAFETY OF PERSONS AND PROPERTY FOR THE DUBRATICETY AND PRIOR TO ORDERING OF ALL LONG LEAD ITEMS AND OF APPROXIMATE DELIVERY DATES.
ALL CONSTRUCTOR TO NOTIFY ARCHITECT IMMEDIATELY AND PRIOR TO ORDERING OF ALL LONG LEAD ACCORDING TO MAINTACTURERS ARE COMMENDATIONS. THE WORK.

PRAVINGS SCHEMATICALLY INDICATE NEW CONSCIENCES FOR ADMINISTRACE OF ALL LONG LEAD ACCORDING TO HEAD ACCORDING TO THE ACCORDING TO THE ACCORDING TO THE WORK.

PRAVINGS SCHEMATICALLY INDICATE NEW CONSTRUCTION SHALL BE BROUGHT TO THE ACTESTICAL PROPERS OF THE SUBCENCE, A REASONABLE NUMBER OF ADJUSTMENTS TO BE NECESSARY TO MEET THE DESIGN OBJECTIVES AND SHOULD CONSIDER SUCH ADJUSTMENTS AS INCLUDED IN THE SCOPE OF WORK.

WHEN SPECIFIC FEATU LANDSCAPE DESIGNER:

FIRE SPRINKLER

BLOCK: LOT:	1302 017	ZONED: HEIGHT LIMIT:	RH-1(D) 40-X (30' PER SITE CONDITION)
LOT SIZE:	26,432 SQFT.	OCCUPANCY:	R-3
UNCONDITIO	NED SPACE	EXISTING	
MAIN LEVEL MID LEVEL F LOWER LEVE	LOOR	510 SQFT. 691 SQFT. 447 SQFT.	
SUB TOTAL:	_	1,648 SQFT.	
CONDITIONE	D SPACE	EXISTING	
MAIN LEVEL MID LEVEL F LOWER LEVE	LOOR	3,729 SQFT. 3,782 SQFT. 3,840 SQFT.	
SUB TOTAL:		11,351 SQFT.	
DECK / TERR	ACE	EXISTING	
MAIN LEVEL MID LEVEL F LOWER LEVE	LOOR	434 SQFT. 2,239 SQFT. 1,893 SQFT.	
SUB TOTAL:		4,566 SQFT.	
DWFILING U	NITS	EXISTING	
		EXISTING	
CONSTRUCT		V-B	
CLASSIFICA	ION	FYISTING	

SCOPE OF WORK

HE PROJECT CONSISTS OF THE DEMOLITION OF AN EXISTING SINGLE FAMILY RESIDENCE

CODES

LUIP S.F. MECHANICAL CODE 2019 S.F. MECHANICAL CODE 2019 S.F. PLUMBING CODE 2019 S.F. FIRE CODE

SHEET INDEX

SYMBOLS

(1) (A9.1)

A5.1

(00)

00

 $\langle 1 \rangle$

1

1

chocquiotourg/funo chapterine grantes

//

700

V V V V

ASSESSORS BLOCK MAP

— — — SETBACK

DRAWING/DETAIL REFERENCE TAG

DRAWING OR DETAIL
SHEET WHERE DRAWING/DETAIL OCCURS

SECTION/ELEVATION REFERENCE TAG BUILDING SECTION
SHEET WHERE SECTION OCCURS

INTERIOR ELEVATION REFERENCE TAG

DOOR TAG

WINDOW TAG

APPLIANCE TAG

REVISION TAG

WALL TYPE TAG

ALIGN

LINE ABOVE

PROPERTY LINE

CONCRETE

DOOR/WINDOW OPERATION CENTER LINE

INSULATION IN SECTION (BATT)

INSULATION IN SECTION (RIGID)

LATH AND PLASTER IN SECTION

SHEET APPLIED WATERPROOFING

PRE-APPLIED SHEET MEMBRANE

FLUID APPLIED WATERPROOFING FILITO APPLIED ATR BARRIER

ROOF UNDERLAYMENT OR SELF ADHERING

GYPSUM BOARD IN SECTION

PLYWOOD IN SECTION

GLASS IN SECTION

DRAIN MAT

DRAINABLE BATTENS

FINISH WOOD IN SECTION

WORKPOINT OR DATUM THRESHOLD

INTERIOR ELEVATION
SHEET WHERE INTERIOR ELEVATION OCCURS

SHEET	NAME	DEMO PERMIT 5/29/20	REVISION 1 5/26/21
A0.0	TITLE SHEET	x	X
A0.1	SURVEY	x	
A0.2	SURVEY	x	
A0.3	EXISTING/DEMO SITE PLAN	x	х
A1.1	EXISTING LOWER LEVEL PLAN	x	х
A1.2	EXISTING MID LEVEL PLAN	х	
A1.3	EXISTING MAIN LEVEL PLAN	х	
A1.4	EXISTING ROOF PLAN	x	
A1.5	EXISTING ELEVATION	x	
A1.6	EXISTING ELEVATION	х	
A1.7	EXISTING ELEVATION	х	
A1.8	EXISTING ELEVATION	х	
A1.9	EXISTING SECTIONS	x	×

SALED YOU TO THE DESCRIPTION TO THEIR CONSTINUTION SHALLE OF THE SAME CHARACTER AS SIMILAR CONDITIONS.

SIMILAR CONDITIONS THE TAKEN FROM NUMERIC DESIGNATIONS ONLY; DIMENSIONS ARE NOT TO BE SCALED OFF DRAWNINGS.

THESE MOTES TO APPLY TO ALL DRAWNINGS AND GOVERN UNLESS MORE SPECIFIC REQUIREMENTS ARE INDICATED APPLICABLE TO PARTICULAR DIVISIONS OF THE WORK. SEE SPECIFICATIONS AND GOVERN UNLESS MORE SPECIFICATIONS AND GENERAL NOTES IN THE SUBSECTIONS OF THESE PORWINGS.

ALL DIMENSIONS ARE TO FACE OF FINISH, U.O.N.
WEATHER STRIPPING AT THESE DOORS AND WINDOWS. ALL SIDES OF THE DOOR MUST BE WEATHER STRIPPING AT THESE DOORS AND WINDOWS. ALL SIDES OF THE DOOR MUST BE WEATHER STRIPPING AT THESE DOORS AND WINDOWS. ALL SIDES OF THE DOOR MUST BE WEATHER STRIPPING AT THESE DOORS AND WINDOWS. ALL SIDES OF THE DOOR MUST BE WEATHER STRIPPING AT THESE DOORS AND WINDOWS. ALL SIDES OF THE DOOR MUST BE WEATHER STRIPPING AT THESE DOORS AND WINDOWS. ALL SIDES OF THE DOOR MUST BE WEATHER STRIPPING AT THESE DOORS AND WINDOWS. ALL SIDES OF THE DOOR MUST BE WEATHER STRIPPING AT THESE DOORS AND WINDOWS. ALL SIDES OF THE DOOR MUST BE WEATHER STRIPPING AT THESE DOORS AND WINDOWS. ALL SIDES OF THE DOOR MUST BE WEATHER STRIPPING AT THESE DOORS AND WINDOWS. ALL SIDES OF THE DOOR MUST BE WEATHER STRIPPING AT THESE DOORS AND WINDOWS. ALL SIDES OF THE DOOR MUST BE WEATHER STRIPPING AT THESE DOORS AND WINDOWS. ALL SIDES OF THE DOOR MUST BE WEATHER STRIPPING AT THESE DOORS AND WINDOWS. ALL SIDES OF THE DOOR MUST BE WEATHER STRIPPING AT THESE DOORS AND WINDOWS. ALL SIDES OF THE DOOR MUST BE WEATHER STRIPPING AT THESE DOORS AND WINDOWS. ALL SIDES OF THE DOOR MUST BE WEATHER STRIPPING AT THESE DOORS AND WINDOWS. ALL SIDES OF THE WORK.

CAULY AND SHALL OPENINGS IN BOILDING EXTERIOR 1/8 OR GREATER TO PREVENT AIR INFILITATION.
WINDOWS TO BE OPERABLE AND CLEANED, U.O.N.
ALL WALL FRAMING SHALL BE 2/4 @ 16" O.C. MINIMUM, U.O.N.
ALL OFFSUM BOARD SHALL BE 3/8" THICK, TYPE "X", U.O.N.
ALL OFFSUM BOOK ON THE STATE OF T

U.O.N. STRUCTURAL WOOD MEMBERS ADJACENT TO CONCRETE ARE TO BE PRESSURE TREATED DOUGLA:

NOTE: DESIGN BASED ON THE ADJACENT MENTIONED CODE SECTIONS. CONSTRUCTION SHALL CONFORM TO ALL APPLICABLE CODES.

GENERAL NOTES

483		1302
	The state of the s	E. CAMINO OF MAP

ABBREVIATIONS

NEW REPLACE IN KIND

ANCHOR BOLT
ABOVE
ADJACENT
ABOVE FINISHED FLOOR
AGGREGATE
ALIGN
AUMINUM
APPROXIMATE
ARCHITECTURAL
AUDIO VISUAL

BOARD
BETWEEN
BUILDING
BLOCK
BLOCKING
BEAM
BOTTOM OF
BOTTOM OF WALL
BUILT-UP ROOFING

CABINET
CEMENT
CERAMIC
CELING
CAULKING
CLEAR
CONC. MASONRY UNIT
CENTER LINE
CENTER OF
COLUMN
CONCRETE
CONTINUOUS

EAST EACH ELECTRICAL ELEVATION ENCLOSURE

SANBORN MAP

BD. BET. BLDG. BLK. BLKG. BM. B.O. B.O.W. B.U.R.

DBL. DTL. DIA. DIM. DN DR. DS. DWG. DWG.

FINISH CEILING FLOOR DRAIN FURNITURE, FIXTURES & EQUIP. FINISH FLOOR

GAGE
GROUND FAULT INTERCEPTOR CIRCUIT
GLASS
GRADE
GROUND
GALVANIZED SHEET METAL

GALVANIZED

HOSE BIB HOLLOW CORE HARDWOOD HARDWARE HEIGHT HORIZONTAL HOUR

INCH OR INCHES INSULATION INTERIOR

NORTH NOT IN CONTRACT

OVER
OVERALL
OR APPROVED EQUAL
OBSCURE
ON CENTER
OUTSIDE DIAMETER
OPENING

OPENING OPPOSITE OIL RUBBED BRONZE

PAINT GRADE
PLATE
PLASTIC LAMINATE
PLYWOOD
PAIR
PROPERTY LINE
PRESSURE TREATED
PAINTED

NOMINAL NOT TO SCALE

F.D. F.F. & E.

FIN. FLR. FLUOR FIXT. F.O. F.O.C. F.O.S. FNDN. FT. FTG. FURR.

GALV. GA. G.F.I.C.

H.B. H.C. HDWD. HDWR. HT. HORIZ. HR.

N. N.I.C. NO. NOM. N.T.S.

O/ O.A. O.A.E. OBS. O.C. O.D. OPNG. OPP. O.R.B.

RAD. R.D. REC. RDWD REF. REFR. REINF REQ. RESIL R.L. RM. R.O.

S. S.C. SCHED. SD SECT. S.G. SHR. SHT. SIM. SL. D. S.O.G. SPEC. SQ. S.S.D. STD. STD. STD. STRUC. SYM.

U.O.N.

REINFORCED REQUIRED RESILIENT RAIN LEADER

SOUTH SOLID CORE SCHEDULE

TREAD TOWEL BAR TELEPHONE TONGUE AND GROVE THICK

THICK
TEMPERED
TOP OF
TOP OF PAVEMENT
TOP OF WALL
TOILET PAPER HOLDER
TUBULAR STEEL
TELEVISION
TYPICAL

UNLESS OTHERWISE NOTED

VINYL COMPOSITION TILE VERTICAL VERIFY IN FIELD

WEST
WITH
WOOD
WITHOUT
WATERPROOFING
WEIGHT

SMOKE DETECTOR

SLOPE
SEE LANDSCAPE DRAWINGS
SLAB ON GRADE
SPECIFICATION
SQUARE
SEE STRUCTURAL DRAWINGS
STAINLESS STEEL
STANDARD
STEEL
STORMAGE


DEMO P	ERMIT
--------	-------


REVISIONS:		BY:
1 REVISION 1	5/26/2021	SK & AM


1920
5/29/2020
JW, SK, AM
GF, JW
AS NOTED





TITLE SHEET

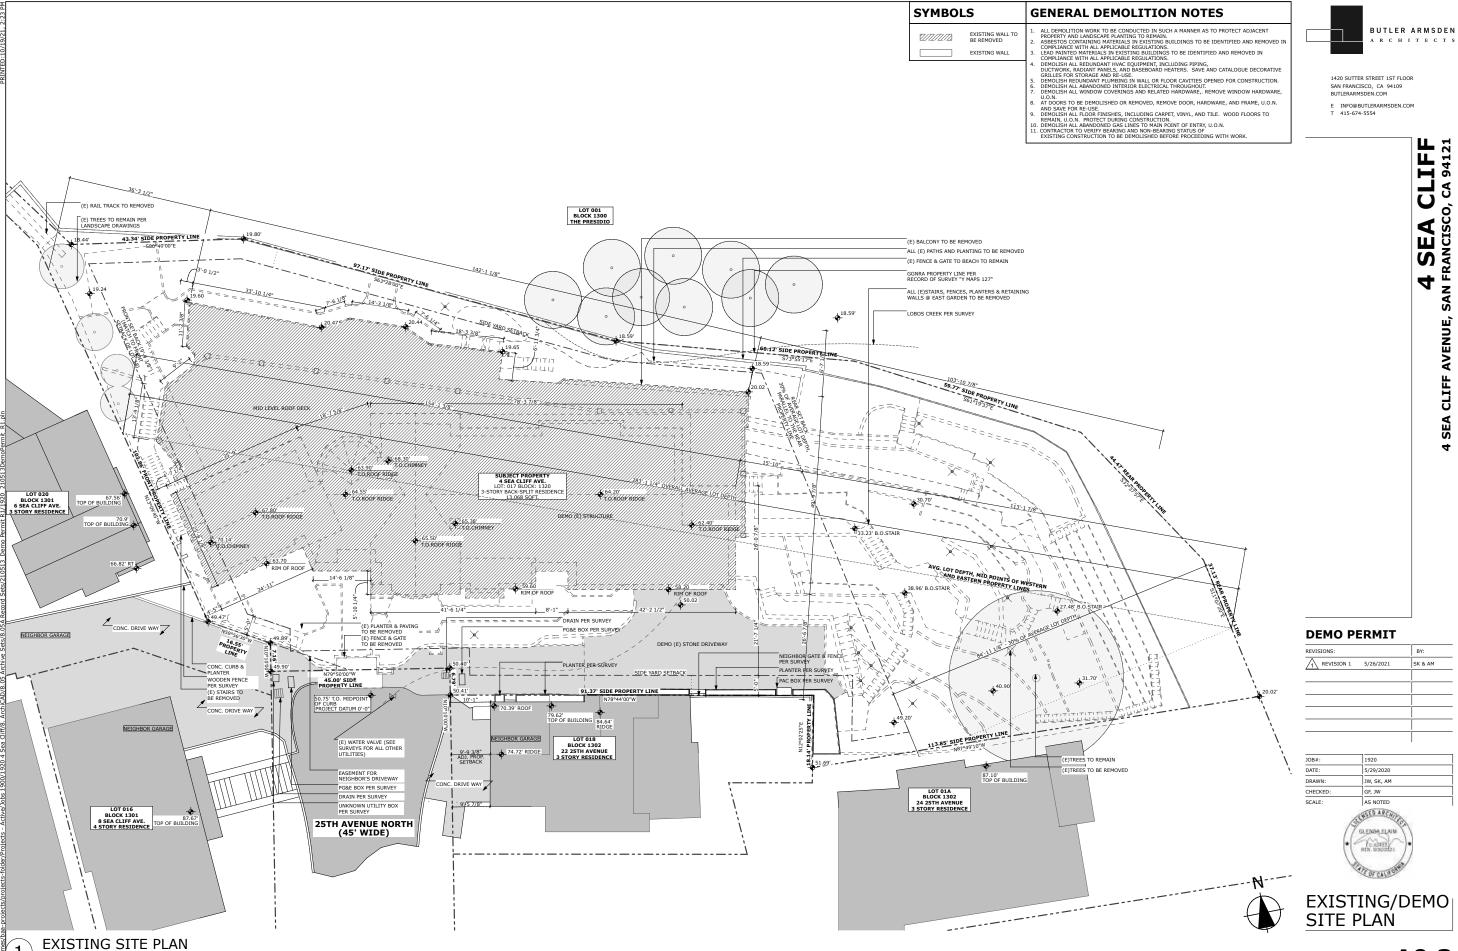

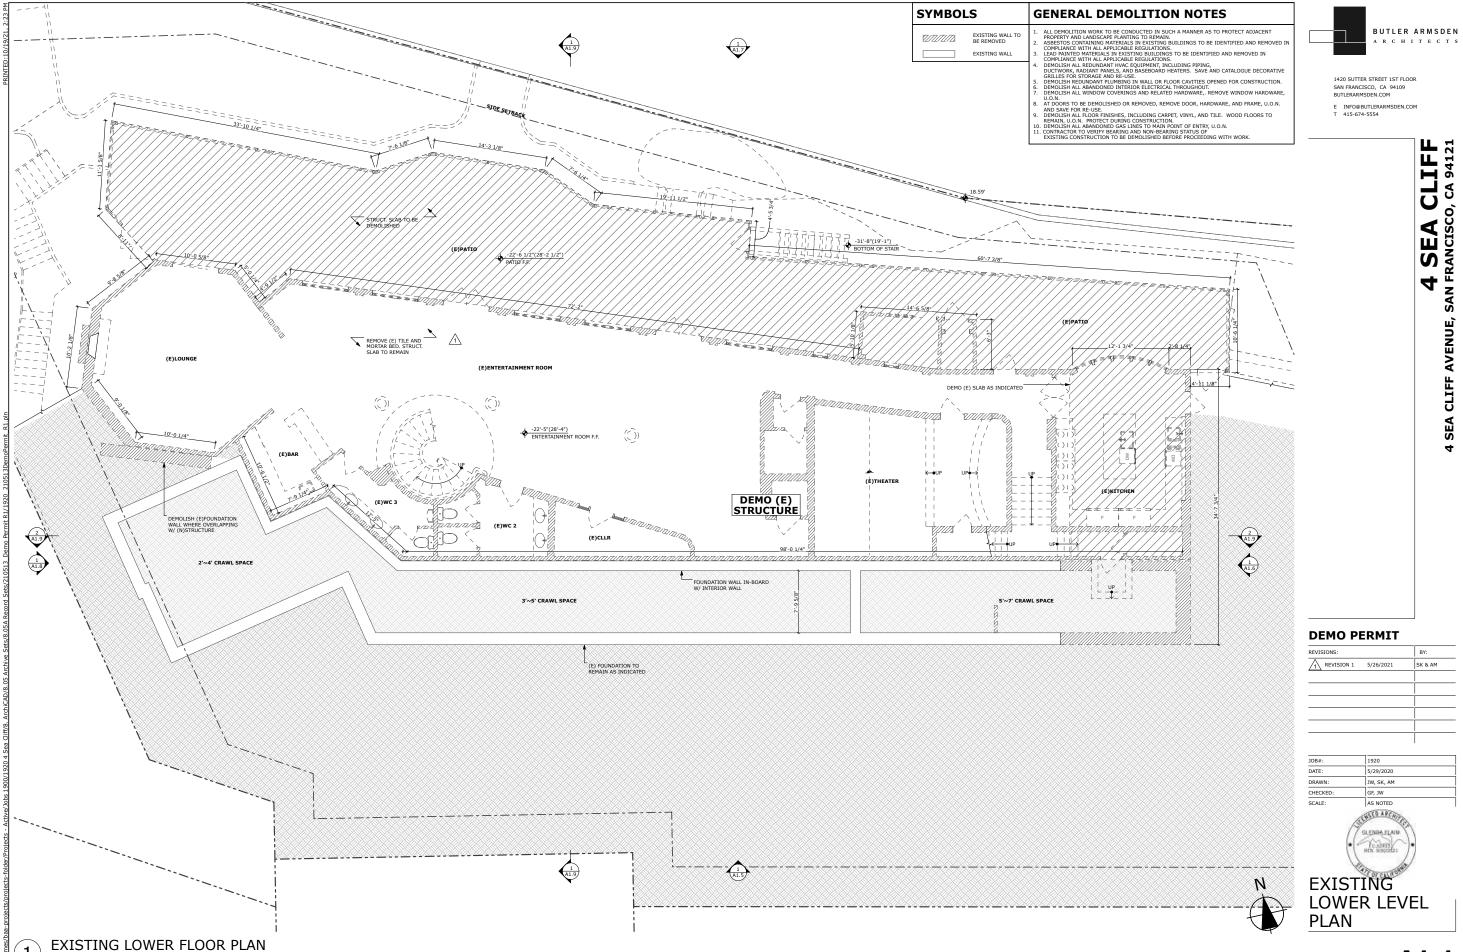


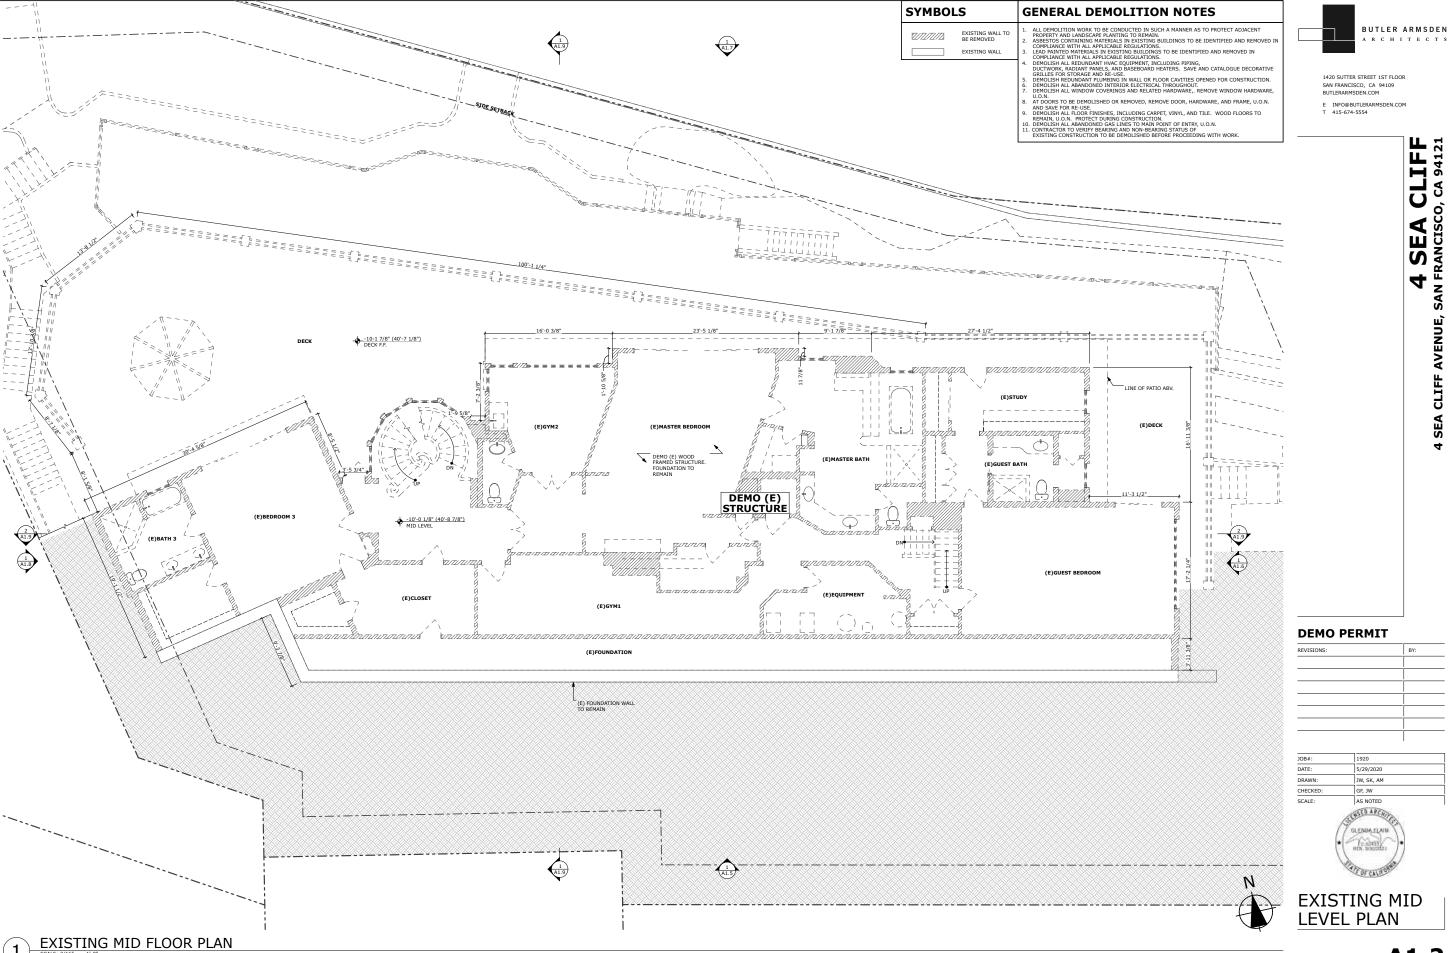

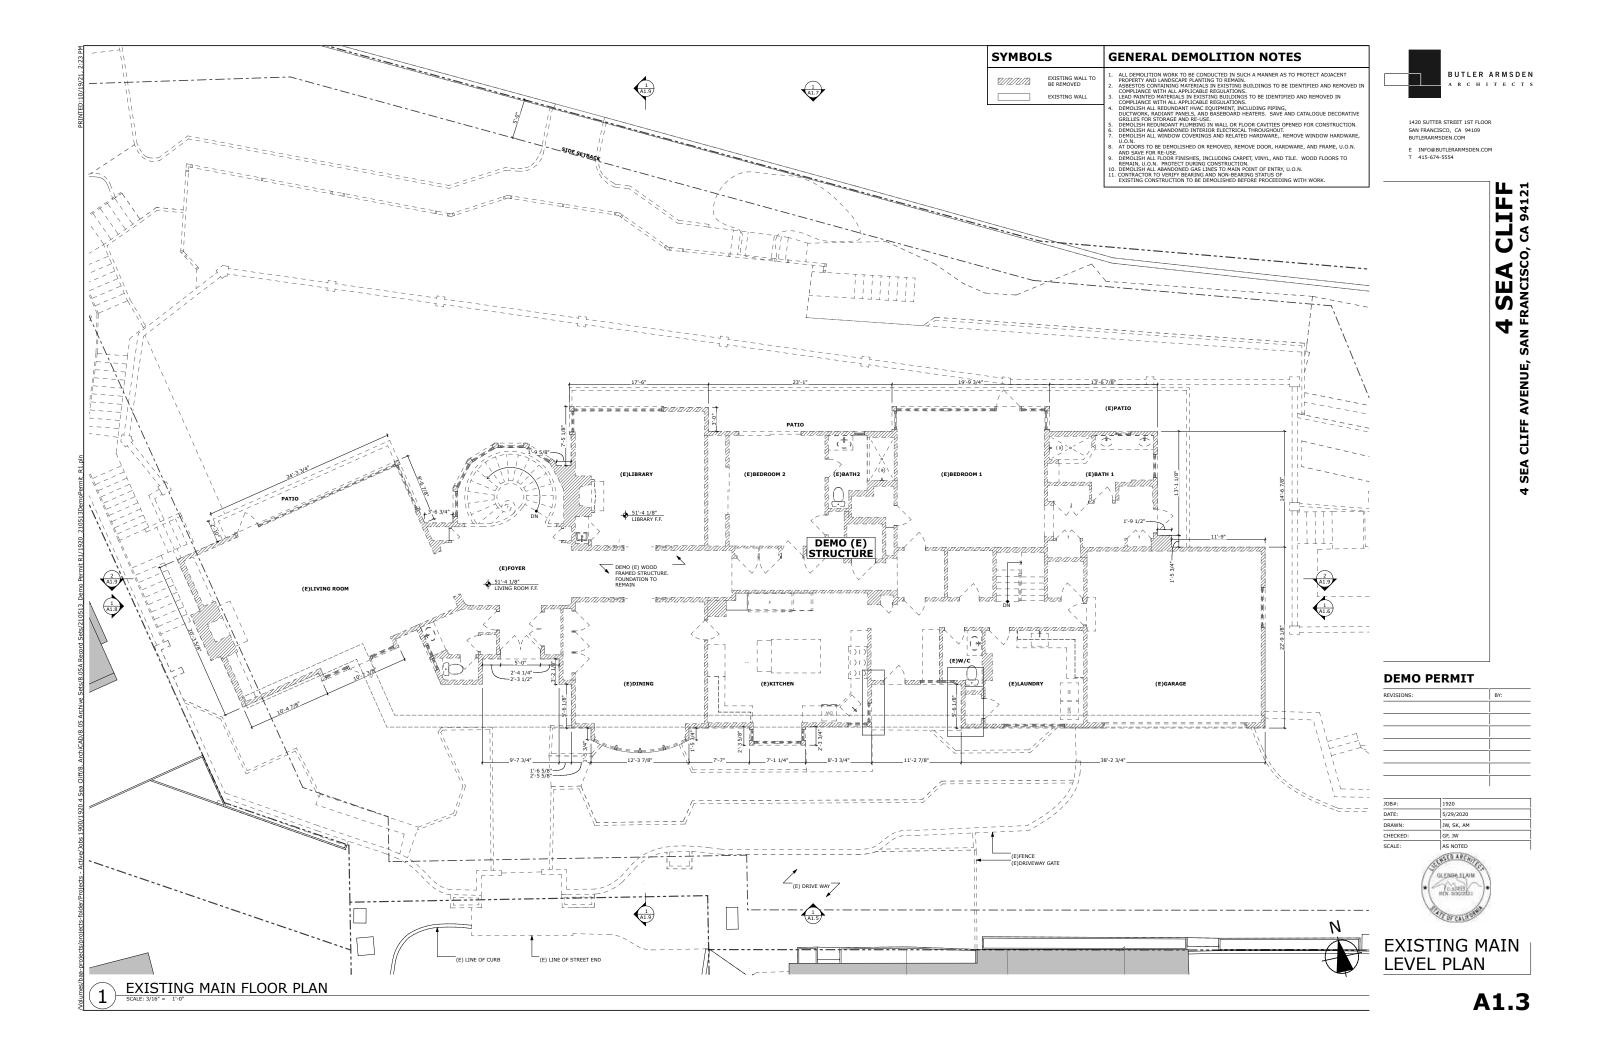

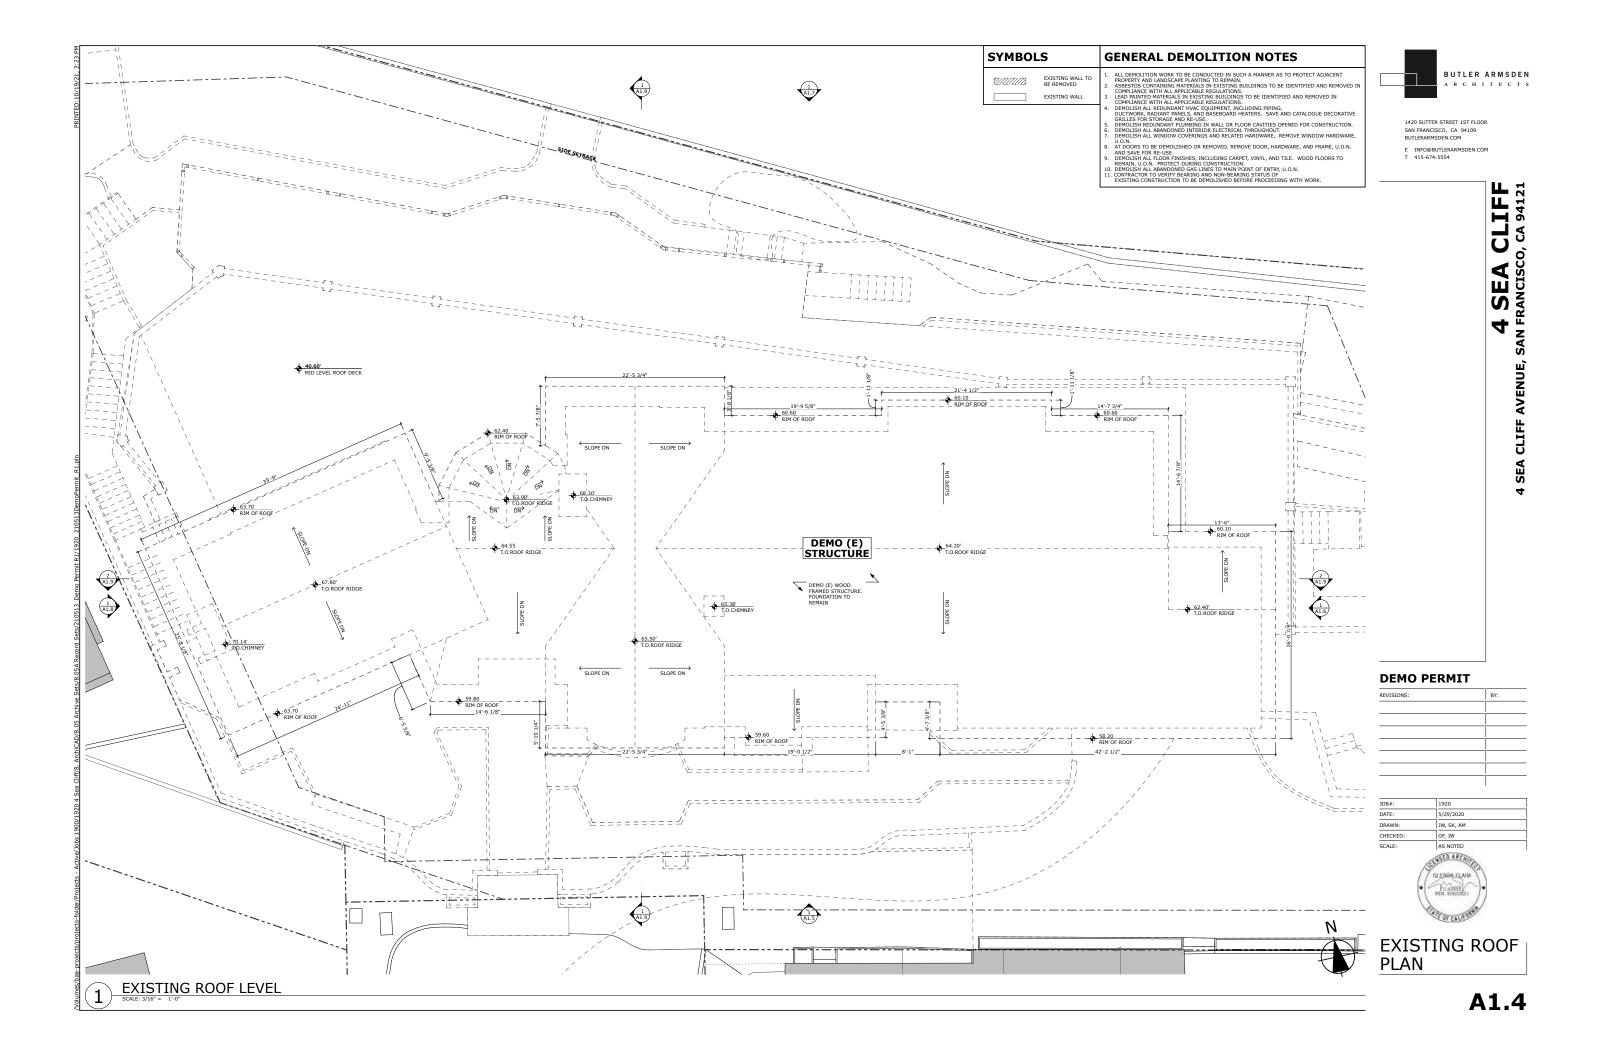

- E INFO@BUTLERARMSDEN.COM T 415-674-5554

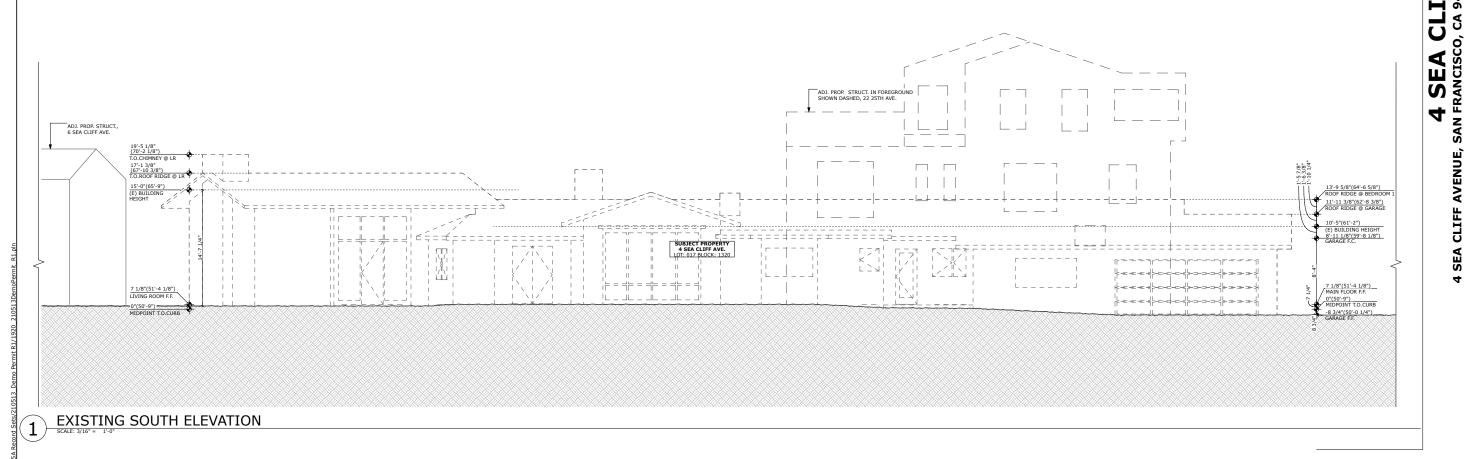

DEMO PERMIT

REVISIONS:	BY:	

JOB#:	1920
DATE:	5/29/2020
DRAWN:	JW, SK, AM
CHECKED:	GF, JW
SCALE:	AS NOTED
	ATT TOTAL



EXISTING ELEVATION



E INFO@BUTLERARMSDEN.COM T 415-674-5554




DEMO PERMIT

REVISIONS:	BY:
	i i

JOB#:	1920
DATE:	5/29/2020
DRAWN:	JW, SK, AM
CHECKED:	GF, JW
SCALE:	AS NOTED
(-	GLENDALLAIN HEN SONOLE

EXISTING ELEVATION

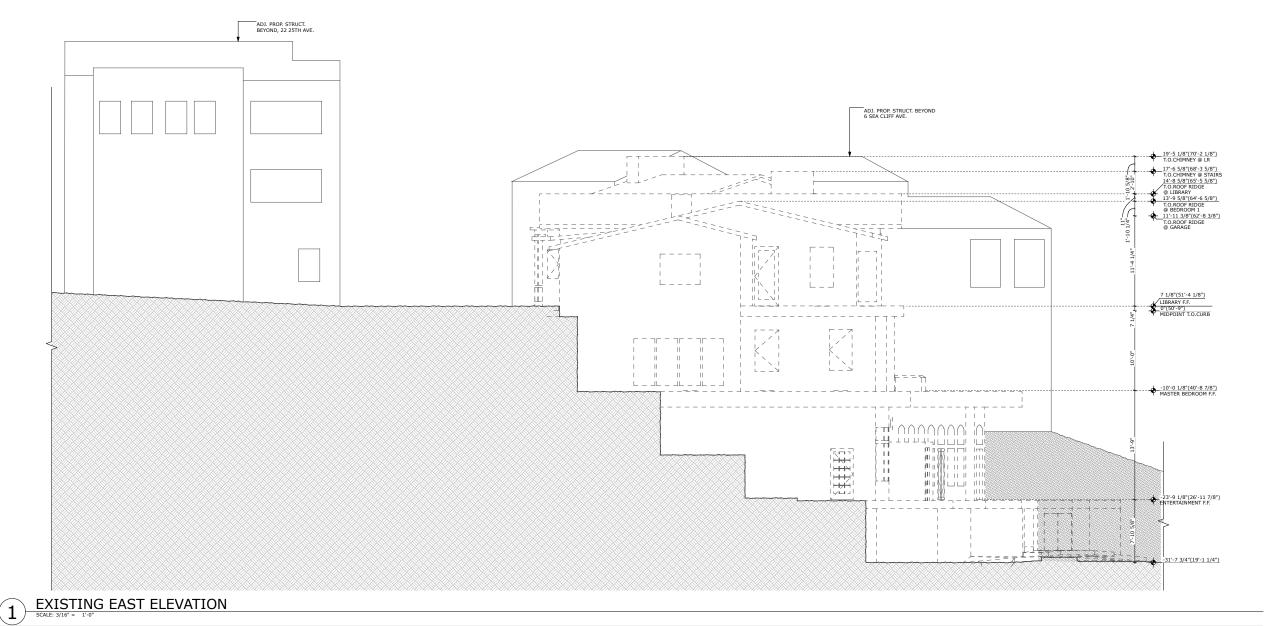



- E INFO@BUTLERARMSDEN.COM T 415-674-5554



4 SEA CLIFF AVENUE,

DEMO PERMIT

_	
REVISIONS:	BY:

JOB#:	1920
DATE:	5/29/2020
DRAWN:	JW, SK, AM
CHECKED:	GF, JW
SCALE:	AS NOTED



EXISTING ELEVATION

