

EXECUTIVE SUMMARY CONDITIONAL USE AUTHORIZATION

HEARING DATE: November 19, 2020

Record No.: 2019-022661CUA **Project Address:** 628 Shotwell Street

Zoning: Residential-House, Three Family (RH-3) Zoning District

40-X Height and Bulk District

Block/Lot: 3611 / 036 **Project Sponsor: Mark Thomas**

440 Spear Street

San Francisco, CA 94105

460 Natoma, LLC **Property Owner:**

4153 24TH St

San Francisco, CA 94114

Staff Contact: Claire Feeney - (628) 652-7313

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Recommendation: Approval with Conditions

Project Description

The proposal is for the change of use from Residential Care Facility to two Dwelling Units. Currently, the existing building contains a Residential Care Facility on the ground floor and a dwelling unit on the second floor. The Project includes restoration to fire damage, interior improvements, façade work, a new rear deck, and the addition of a one-bedroom dwelling unit on the ground floor. The existing top unit will contain four bedrooms. The existing building would retain the one off-street parking space and would add two Class 1 bicycle parking spaces. The building footprint and massing will not be altered.

Required Commission Action

In order for the Project to proceed, the Commission must grant a Conditional Use Authorization, pursuant to Planning Code Sections 209.1 and 303 and Board of Supervisors File No. 190908, to change the use of a Residential Care Facility to two dwelling units at 628 Shotwell Street.

Issues and Other Considerations

- Public Comment & Outreach.
 - o The Project Sponsor conducted a Pre-Application meeting on June 18, 2020 which one person attended. The attendee was a reporter who asked about regulatory compliance.
 - o **Support/Opposition:** To date the Department has received 2 messages in support and no messages in oppositions to the Project.
 - Support for the Project is centered on restoring a dilapidated building that has had issues with people trespassing on the property.
 - o **Outreach**: The Project Sponsor contacted United Save the Mission (USM) multiple times between August and November 2020 to check if the community had particular opinions on the change of use. USM did not respond.
- **History.** The existing building is a single-family home that was later converted into apartments. In 1984 the first floor was converted to a Residential Care Facility that remained until a fire in 2015. The building is now vacant.
- Interim Zoning Control. On October 11, 2019, the Board of Supervisors passed Board File No. 190907 enacting a resolution to require Conditional Use Authorization from the Planning Commission to change the use of a Residential Care Facility to another use. As part of this resolution, the Commission must adopt certain findings, as detailed in the draft motion.

Environmental Review

The Project is exempt from the California Environmental Quality Act ("CEQA") as a Class 1 categorical exemption.

Basis for Recommendation

The Department finds that the Project is, on balance, consistent with the intent of the RH-3 Zoning District, the Mission Area Plan, the Objectives and Policies of the General Plan, and the findings of the Interim Zoning Controls adopted by the Board of Supervisors. The Project will restore a severely damaged, vacant building and will create a new market-rate dwelling unit. Tenants of the previous Residential Care Facility were relocated in 2015 after the fire and the facility closed five-years ago, which is greater then the three-year time limit for land uses to be formally discontinued and abandoned. The Department also finds the project to be necessary, desirable, and compatible with the surrounding neighborhood, and not to be detrimental to persons or adjacent properties in the vicinity.

Attachments:

Draft Motion – Conditional Use Authorization with Conditions of Approval (Exhibit A)

Exhibit B – Plans and Renderings

Exhibit C – Environmental Determination

Exhibit D - Land Use Data



Executive Summary Record No. 2020-005123CUA Hearing Date: November 19, 2020 628 Shotwell Street

Exhibit E – Maps and Context Photos Exhibit G - Project Sponsor Brief



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PLANNING COMMISSION DRAFT MOTION

HEARING DATE: November 19, 2020

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Zoning: Residential-House, Three Family (RH-3) Zoning District

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Block/Lot: 3611 / 036 **Project Sponsor:** Mark Thomas

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ADOPTING FINDINGS RELATING TO A CONDITIONAL USE AUTHORIZATION, PURSUANT TO PLANNING CODE SECTIONS 209.1 AND 303 AND BOARD OF SUPERVISORS FILE NO. 190908 TO ALLOW THE CHANGE IN USE OF A RESIDENTIAL CARE FACILITY USE TO A DWELLING UNIT WITHIN THE EXISTING THREE-STORY RESIDENTIAL BUILDING, LOCATED AT 628 SHOTWELL STREET, LOT 036 IN ASSESSOR'S BLOCK 3611, WITHIN THE RH-3 (RESIDENTIAL-HOUSE, THREE FAMILY) (RH-3) ZONING DISTRICT AND A 40-X HEIGHT AND BULK DISTRICT, AND ADOPTING FINDINGS UNDER THE CALIFORNIA ENVIRONMENTAL QUALITY ACT.

PREAMBLE

On December 9, 2019, Mark Thomas of Thomas Hood Architects (hereinafter "Project Sponsor") filed a building permit application (Record No. 2019-022661PRJ) received by the Planning Department (hereinafter "Department") for improvements to the building at 628 Shotwell Street, Block 3611 Lot 036 (hereinafter "Project Site"). On September 27, 2020, the Project Sponsor filed Record No. 2019-022661CUA (hereinafter "Application") with the Department for a change of use from Residential Care Facility to a Residential Use.

On November 19, 2020 the Commission conducted a duly noticed public hearing at a regularly scheduled meeting on Conditional Use Authorization Application No. 2019-022661CUA.

The Planning Department Commission Secretary is the custodian of records; the File for Record No. 2019-022661CUA is located at 49 South Van Ness Avenue, Suite 1400, San Francisco, California.

The Commission has heard and considered the testimony presented to it at the public hearing and has further considered written materials and oral testimony presented on behalf of the applicant, Department staff, and other interested parties.

MOVED, that the Commission hereby authorizes the Conditional Use Authorization as requested in Application No. 2019-022661CUA, subject to the conditions contained in "EXHIBIT A" of this motion, based on the following findings:



FINDINGS

Having reviewed the materials identified in the preamble above, and having heard all testimony and arguments, this Commission finds, concludes, and determines as follows:

- 1. The above recitals are accurate and constitute findings of this Commission.
- 2. **Project Description.** The proposal is for the change of use from Residential Care Facility to a Dwelling Unit. Currently, the existing building contains a Residential Care Facility on the ground floor and a dwelling unit on the second floor. The Project includes restoration to fire damage, interior improvements, façade work, a new rear deck, and the addition of a one-bedroom dwelling unit on the ground floor. The existing top unit will contain four bedrooms. The existing building would retain the one off-street parking space and would add two Class 1 bicycle parking spaces. The building footprint and massing will not be altered.
- 3. Site Description and Present Use. The Project is located on an approximately 3,721 square foot lot with approximately 30-feet of frontage along Shotwell Street. The Project Site contains one three-story that is currently vacant. Previously there was a Residential Care Facility on the ground floor and a residence on the second floor. A summary timeline that has been assembled from Department files and property records is below:
 - 1885: A single-family home is constructed
 - 1955: The building is divided into 6 apartments.
 - 1962: The building is divided into 7 apartments total.
 - 1984: The ground floor is converted to a Residential Care Facility.
 - 2015: A fire severely damages the building and the Lorne House Residential Care Facility vacates the property.
 - 2019: Interim Zoning Control 2019-017654PCA which requires a CUA to remove or abandon Residential Care Facility uses is passed by the Board of Supervisors.
 - 2019: The Project Sponsor applies to restore the building and re-establish a Residential use.
- **4. Surrounding Properties and Neighborhood.** The Project Site is located within the RH-3 Zoning District in the Mission Area Plan. The immediate context is mixed in character with residential and commercial uses. The immediate neighborhood includes two-to-four-story single and multifamily residential buildings, as well as mixed-use buildings with ground floor commercial uses. Jose Coronado Playground is located down the block to the south.
- 5. Public Outreach and Comments. The Project Sponsor conducted a Pre-Application meeting on June 18, 2020 which one person attended. The attendee was a reporter who asked about regulatory compliance. The Department has received two messages in support and no messages in oppositions to the Project. Support for the Project is centered on restoring a dilapidated building that has had issues with people trespassing on the property. The Project Sponsor also contacted United Save the Mission (USM) multiple between August and November 2020 to check if the community had particular opinions



on the change of use. USM did not respond.

- **6. Planning Code Compliance.** The Commission finds that the Project is consistent with the relevant provisions of the Planning Code in the following manner:
 - A. Residential. A Use Category consisting of uses that provide housing for San Francisco residents, rather than visitors, including Dwelling Units, Group Housing, Residential Hotels, Senior Housing, Homeless Shelters, and for the purposes of Article 4 only any residential components of Institutional Uses. Single Room Occupancy, Intermediate Length Occupancy, and Student Housing designations are considered characteristics of certain Residential Uses.

The Project Sponsor is proposing to change retain the single-family residence on third floor, convert the second floor back from a Residential Care Facility use to a single-family home, and to construct a new one-bedroom apartment on the ground floor. The property owner intends to live in the re-merged unit on floors two and three with their family and keep the ground floor unit available to rent.

B. Bicycle Parking. Per Section 155.2, one on-site bike parking space is required per dwelling unit.

The proposed project will include two bike parking spaces within the garage.

C. Rear Yard. The RH-3 Zoning District requires a rear yard equal to 45% of lot depth.

The existing building is a legal non-conforming structure that extends approximately 15-feet into the required rear yard. The Project is restoring the existing building and is maintaining the same rear façade depth. Therefore, the Project can be approved as proposed without a Variance.

D. Open Space. A minimum of 100 square feet of private outdoor space, or 133 square feet of common outdoor space, are required for residential units within the RH-3 Zoning District.

The existing front and rear yards are being retained and are accessible to both units, totaling approximately 1,600 square feet.

E. Dwelling Unit Exposure. Section 140 of the Planning Code requires all dwelling units have at least one room that faces a street, yard, or open space that is at least 20-feet deep.

Both units face and have direct access to the rear yard which is approximately 40-feet deep. The top unit also has multiple rooms that face Shotwell Street which is approximately 60-feet deep.

- F. Eastern Neighborhoods Infrastructure Impact Fee. The Project includes the creation of at least one new residential unit and is therefore subject to the Eastern Neighborhoods Infrastructure Impact Fee per Section 423.
- G. Residential Child Care Fee. The Project includes the creation of at least one new residential unit and is therefore subject to the Residential Child Care Impact Fee per Section 414A.
- 7. **Conditional Use Findings.** Planning Code Section 303 establishes criteria for the Planning Commission to consider when reviewing applications for Conditional Use authorization. On balance, the project



complies with said criteria in that:

- A. The proposed new uses and building, at the size and intensity contemplated and at the proposed location, will provide a development that is necessary or desirable, and compatible with, the neighborhood or the community.
 - The proposed new residences will be 828 and 3,419 square feet and will exist almost entirely within the existing footprint and massing of the building on site. Some alterations are proposed to the rear façade to accommodate outdoor space. The building is currently vacant and has severe fire damage, creating two new occupiable dwelling units fits with the adjacent block, which is largely residential. The Project will benefit the whole City as we face a housing shortage.
- B. The proposed project will not be detrimental to the health, safety, convenience or general welfare of persons residing or working in the vicinity. There are no features of the project that could be detrimental to the health, safety or convenience of those residing or working the area, in that:
 - (1) Nature of proposed site, including its size and shape, and the proposed size, shape and arrangement of structures;
 - The size and shape of the site and the size, shape, and arrangement of the building, e.g. height and bulk, will be minimally altered as part of this Project. The historic front façade will be restored, extensive interior improvements are planned, and there will be some changes to the rear façade to accommodate reconfigured outdoor spaces. The Project does not include any exterior expansion.
 - (2) The accessibility and traffic patterns for persons and vehicles, the type and volume of such traffic, and the adequacy of proposed off-street parking and loading;
 - The Planning Code does not require off-street parking for Residential uses. The existing building will retain the one off-street parking space.
 - (3) The safeguards afforded to prevent noxious or offensive emissions such as noise, glare, dust and odor;
 - The Project will not produce noxious or offensive emissions related to noise, glare, dust, or odor.
 - (4) Treatment given, as appropriate, to such aspects as landscaping, screening, open spaces, parking and loading areas, service areas, lighting and signs;
 - The Project will alter the front setback to come into compliance with landscaping and permeability requirements, as well as to change the driveway slope to align with new ground floor elevation. There will be more greenery and improved drainage with the proposed work.



- C. That the use as proposed will comply with the applicable provisions of the Planning Code and will not adversely affect the General Plan.
 - The Project complies with all relevant requirements and standards of the Planning Code and is consistent with objectives and policies of the General Plan as detailed below.
- D. That the use as proposed would provide development that is in conformity with the purpose of the applicable Use District.
 - The Project will restore a damaged and vacant building and contribute two new occupiable dwelling units. The Project Site is located in the RH-3 Zoning District so the creation of the ground floor apartment is more suitable than if the building was converted to a single-family dwelling unit. Residential Uses are principally permitted within the RH-3 District.
- 8. Interim Zoning Controls Findings: Change of Use to a Residential Care Facility. Effective on October 11, 2019, the Board of Supervisors passed an interim zoning control to require Conditional Use Authorization for a change in use of a residential care facility. In addition to the criteria of Section 303(c) of this Code, the Commission shall consider the extent to which the following criteria are met:
 - A. Any findings by the Department of Public Health, the Human Services Agency, the Department of Aging and Adult Services, or the San Francisco Long-Term Care Coordinating Council regarding the capacity of the existing Residential Care Facility Use, the population served, and the nature and quality of services provided.
 - The Project Site was previously home to the Lorne House, a Residential Care Facility that operated until a fire substantially damaged the building in 2015. There is not currently an operating Residential Care Facility on the property so the capacity of the use is zero patients. There are therefore no available findings by the agencies listed above.
 - B. The impact of the change of use on the neighborhood and community.
 - The Project Site is on a primarily residential block with single-family homes and multifamily buildings, as well as, a bar and hair salon. The building is currently a vacant and dilapidated and neighbors have reported incidents of squatters staying on site. Uses are considered abandoned after three-years, however Residential Care Facilities are a principally permitted within the RH-3 Zoning District and therefore cannot be abandoned. The change of use from a vacant Residential Care Facility to occupied residential units will benefit its block and the larger neighborhood. Public safety and sidewalk life will both benefit from the additional housing units and family residents. Rehabilitating a blighted building with two residential dwelling units is beneficial to the neighborhood and community.
 - C. Whether there are sufficient available beds at a licensed Residential Care Facility within a one-mile radius of the site.



The Lorne House Residential Care Facility closed in 2015 and all six residents were relocated to other facilities by their care provider, Golden Gate Regional. This change of use will not displace any residents. Currently, the California Department of Social Services licensing database lists four residential care facilities within a mile of the site: South Van Ness Manor (822 South Van Ness Avenue), San Francisco Adult Residential Facility (887 Potrero Avenue), RJ Starlight Home (2680 Bryant Street), and Rustan Adult Residential Care Home (460 Utah Street). There are also three additional facilities within the 94110 zip code: Lady of Perpetual Help, Merced Three, and Holly Park Family Home.

D. Whether the Residential Care Facility Use to be converted will be relocated or replaced with another Residential Care Facility Use. The intensity of activity in the district is not such that allowing the larger use will be likely to foreclose the location of other needed neighborhood-serving uses in the area.

The Residential Care Facility on site closed in 2015. All patients were relocated after the fire and no relocation services or replacement facilities are currently required. The intensity of on-site activity will diminish with the conversion to two dwelling units. There will be less people living on the site and no regular demand for medical and support services. No neighborhood serving uses will be foreclosed upon due to this Project.

9. General Plan Compliance. The Project is, on balance, consistent with the following Objectives and Policies of the General Plan:

HOUSING ELEMENT

Objectives and Policies

OBJECTIVE 2

RETAIN EXISTING HOUSING UNITS, AND PROMOTE SAFETY AND MAINTENANCE STANDARDS, WITHOUT JEOPARDIZING AFFORDABILITY.

Policy 2.1

Discourage the demolition of sound existing housing, unless the demolition results in a net increase in affordable housing.

Policy 2.2

Retain existing housing by controlling the merger of residential units, except where a merger clearly creates new family housing.

Policy 2.4

Promote improvements and continued maintenance to existing units to ensure long term habitation and safety.

Policy 2.5

Encourage and support the seismic retrofitting of the existing housing stock.



OBJECTIVE 11

SUPPORT AND RESPECT THE DIVERSE AND DISTINCT CHARACTER OF SAN FRANCISCO'S NEIGHBORHOODS.

Policy 11.1

Promote the construction and rehabilitation of well-designed housing that emphasizes beauty, flexibility, and innovative design, and respects existing neighborhood character.

Policy 11.2

Ensure implementation of accepted design standards in project approvals.

Policy 11.3

Ensure growth is accommodated without substantially and adversely impacting existing residential neighborhood character.

Policy 11.4

Continue to utilize zoning districts which conform to a generalized residential land use and density plan and the general plan.

Policy 11.5

Ensure densities in established residential areas promote compatibility with prevailing neighborhood character.

Policy 11.6

Foster a sense of community through architectural design, using features that promote community interaction.

Policy 11.7

Respect San Francisco's historic fabric, by preserving landmark buildings and ensuring consistency with historic districts.

Policy 11.8

Consider a neighborhood's character when integrating new uses, and minimize disruption caused by expansion of institutions into residential areas.

COMMUNITY SAFETY ELEMENT

Objectives and Policies

OBJECTIVE 1

REDUCE STRUCTURAL AND NONSTRUCTURAL HAZARDS TO LIFE SAFETY AND MINIMIZE PROPERTY DAMAGE RESULTING FROM FUTURE DISASTERS.

Policy 1.14

Reduce the earthquake and fire risks posed by older small wood-frame residential buildings.



Policy 1.16

Preserve, consistent with life safety considerations, the architectural character of buildings and structures important to the unique visual image of San Francisco, and increase the likelihood that architecturally and historically valuable structures will survive future earthquakes.

OBJECTIVE 3

ESTABLISH STRATEGIES TO ADDRESS THE IMMEDIATE EFFECTS OF A DISASTER.

Policy 3.11

Ensure historic resources are protected in the aftermath of a disaster.

MISSION AREA PLAN

Land Use

Objectives and Policies

OBJECTIVE 1.1

IN AREAS OF THE MISSION WHERE HOUSING AND MIXED-USE IS ENCOURAGED, MAXIMIZE DEVELOPMENT POTENTIAL IN KEEPING WITH NEIGHBORHOOD CHARACTER.

Policy 1.2.1

Ensure that in-fill housing development is compatible with its surroundings.

OBJECTIVE 2.2

RETAIN AND IMPROVE EXISTING HOUSING AFFORDABLE TO PEOPLE OF ALL INCOMES.

Policy 2.2.2

Preserve viability of existing rental units.

Policy 2.2.4

Ensure that at-risk tenants, including low-income families, seniors, and people with disabilities, are not evicted without adequate protection.

OBJECTIVE 2.5

PROMOTE HEALTH THROUGH RESIDENTIAL DEVELOPMENT DESIGN AND LOCATION.

Policy 2.5.1

Consider how the production of new housing can improve the conditions required for health of San Francisco residents.

Policy 2.5.2

Develop affordable family housing in areas where families can safely walk to schools, parks, retail, and other services.



Policy 2.5.3

Require new development to meet minimum levels of "green" construction.

OBJECTIVE 3.1

PROMOTE AN URBAN FORM THAT REINFORCES THE MISSION'S DISTINCTIVE PLACE IN THE CITY'S LARGER FORM AND STRENGTHENS ITS PHYSICAL FABRIC AND CHARACTER

Policy 3.1.9

Preserve notable landmarks and areas of historic, architectural or aesthetic value, and promote the preservation of other buildings and features that provide continuity with past development.

OBJECTIVE 3.2

PROMOTE AN URBAN FORM AND ARCHITECTURAL CHARACTER THAT SUPPORTS WALKING AND SUSTAINS A DIVERSE, ACTIVE AND SAFE PUBLIC REALM

Policy 3.2.1

Require high quality design of street-facing building exteriors.

Policy 3.2.4

Strengthen the relationship between a building and its fronting sidewalk.

OBJECTIVE 3.3

PROMOTE THE ENVIRONMENTAL SUSTAINABILITY, ECOLOGICAL FUNCTIONING AND THE OVERALL QUALITY OF THE NATURAL ENVIRONMENT IN THE PLAN AREA

Policy 3.3.1

Require new development to adhere to a new performance-based ecological evaluation tool to improve the amount and quality of green landscaping.

Policy 3.3.5

Compliance with strict environmental efficiency standards for new buildings is strongly encouraged.

OBJECTIVE 5.2

ENSURE THAT NEW DEVELOPMENT INCLUDES HIGH QUALITY, PRIVATE OPEN SPACE

Policy 5.2.1

Require new residential and mixed-use residential development to provide on-site, private open space designed to meet the needs of residents.

Policy 5.2.3

Encourage private open space to be provided as common spaces for residents and workers of the building wherever possible.



OBJECTIVE 5.3

CREATE A NETWORK OF GREEN STREETS THAT CONNECTS OPEN SPACES AND IMPROVES THE WALKABILITY, AESTHETICS AND ECOLOGICAL SUSTAINABILITY OF THE NEIGHBORHOOD.

Policy 5.3.2

Maximize sidewalk landscaping, street trees and pedestrian scale street furnishing to the greatest extent feasible.

OBJECTIVE 5.4

THE OPEN SPACE SYSTEM SHOULD BOTH BEAUTIFY THE NEIGHBORHOOD AND STRENGTHEN THE ENVIRONMENT

Policy 5.4.1

Increase the environmental sustainability of the Mission's system of public and private open spaces by improving the ecological functioning of all open space.

OBJECTIVE 8.2

PROTECT, PRESERVE, AND REUSE HISTORIC RESOURCES WITHIN THE MISSION PLAN AREA

Policy 8.2.1

Protect individually significant historic and cultural resources and historic districts in the Mission plan area from demolition or adverse alteration.

Policy 8.2.2

Apply the Secretary of the Interior's Standards for the Treatment of Historic Properties in conjunction with the Mission Area Plan objectives and policies for all projects involving historic or cultural resources.

The Project includes the conversion of a vacant Residential Care Facility use to a Residential use containing two dwelling units. The Project includes restoring the severely fire-damaged historic building on-site. One unit will be 3,419 square foot and have four bedrooms and can accommodate a family with children. The new ground floor unit will be 828 square feet and have one bedroom. The reactivation of a damaged and vacant building will benefit the immediate area, while establishing two dwelling units will contribute to the City's efforts to increase the housing stock.

The Project Site shifted between Residential and Residential Care Facility uses over multiple decades. The Lorne House most recently occupied the property until a fire severely damaged the building in 2015. All 6 residents were relocated to other Residential Care Facilities in the wake of this disaster and the Lorne House ceased operation. Since the fire the building has been vacant and has become a nuisance to some neighbors, 8 complaints have been filed with the Department of Building Inspection.

The Project will not cause any residents or patients to be displaced. It includes the restoration of a Category A historic resource, as well as building safety, energy efficiency, and green landscaping improvements. The proposal is to re-establish the original use of an existing building in the Mission District. On balance, the Project is consistent with the Objectives and Policies of the General Plan.



- **10. Planning Code Section 101.1(b)** establishes eight priority-planning policies and requires review of permits for consistency with said policies. On balance, the project complies with said policies in that:
 - A. That existing neighborhood-serving retail uses be preserved and enhanced and future opportunities for resident employment in and ownership of such businesses be enhanced.
 - The Project is not anticipated to significantly affect the existing mix of neighborhood-serving retail uses. The Project is a residential rather than commercial use.
 - B. That existing housing and neighborhood character be conserved and protected in order to preserve the cultural and economic diversity of our neighborhoods.
 - The Project is not anticipated to adversely affect the character or diversity of the neighborhood. The Project will create two new housing units. In addition, the historic façade of this fire damaged building will be restored and minimal changes are proposed to the overall building footprint and massing.
 - C. That the City's supply of affordable housing be preserved and enhanced,
 - The Project would not have any adverse effect on the City's supply of affordable housing.
 - D. That commuter traffic not impede MUNI transit service or overburden our streets or neighborhood parking.
 - The Project Site is served by nearby public transportation options. The Project is located near multiple Muni bus lines (12 Folsom/Pacific, 14 Mission, 14R Mission Rapid, 33 Ashbury/18th Street, and 49 Van Ness/Mission.) The 24th Street Mission BART Station is also four-blocks away. The Project is retaining one parking space within the existing garage. Therefore, traffic and transit ridership generated by the Project will not overburden the streets or MUNI service.
 - E. That a diverse economic base be maintained by protecting our industrial and service sectors from displacement due to commercial office development, and that future opportunities for resident employment and ownership in these sectors be enhanced.
 - The Project will not displace or adversely affect any service sector or industrial businesses and it does not include any commercial office development.
 - F. That the City achieve the greatest possible preparedness to protect against injury and loss of life in an earthquake.
 - This Project will not adversely affect the property's ability to withstand an earthquake. The Project will comply with the requirements of the San Francisco Building Code.
 - G. That landmarks and historic buildings be preserved.



The Project Site contains a historic resource that contributes to the eligible National Register Shotwell Street Historic District. The Project proposes to restore extensive fire damage to the building and retain architectural details on the front and side facades. Most changes to the building are internal, as well as some modifications to the rear façade to accommodate open space. Therefore, the historic building will be preserved.

H. That our parks and open space and their access to sunlight and vistas be protected from development.

The Project will have no negative effect on existing parks and open spaces, and will not adversely affect their access to sunlight, or vistas.

- 11. The Project is consistent with and would promote the general and specific purposes of the Code provided under Section 101.1(b) in that, as designed, the Project would contribute to the character and stability of the neighborhood and would constitute a beneficial development.
- **12.** The Commission hereby finds that approval of the Conditional Use Authorization would promote the health, safety and welfare of the City.



DECISION

That based upon the Record, the submissions by the Applicant, the staff of the Department and other interested parties, the oral testimony presented to this Commission at the public hearings, and all other written materials submitted by all parties, the Commission hereby **APPROVES Conditional Use Authorization Application No. 2020-005123CUA** subject to the following conditions attached hereto as "EXHIBIT A" in general conformance with plans on file, dated July 7, 2020, and stamped "EXHIBIT B", which is incorporated herein by reference as though fully set forth.

APPEAL AND EFFECTIVE DATE OF MOTION: Any aggrieved person may appeal this Conditional Use Authorization to the Board of Supervisors within thirty (30) days after the date of this Motion. The effective date of this Motion shall be the date of this Motion if not appealed (after the 30-day period has expired) OR the date of the decision of the Board of Supervisors if appealed to the Board of Supervisors. For further information, please contact the Board of Supervisors at (415) 554-5184, City Hall, Room 244, 1 Dr. Carlton B. Goodlett Place, San Francisco, CA 94102.

Protest of Fee or Exaction: You may protest any fee or exaction subject to Government Code Section 66000 that is imposed as a condition of approval by following the procedures set forth in Government Code Section 66020. The protest must satisfy the requirements of Government Code Section 66020(a) and must be filed within 90 days of the date of the first approval or conditional approval of the development referencing the challenged fee or exaction. For purposes of Government Code Section 66020, the date of imposition of the fee shall be the date of the earliest discretionary approval by the City of the subject development.

If the City has not previously given Notice of an earlier discretionary approval of the project, the Planning Commission's adoption of this Motion, Resolution, Discretionary Review Action or the Zoning Administrator's Variance Decision Letter constitutes the approval or conditional approval of the development and the City hereby gives **NOTICE** that the 90-day protest period under Government Code Section 66020 has begun. If the City has already given Notice that the 90-day approval period has begun for the subject development, then this document does not re-commence the 90-day approval period.

I hereby certify that the Planning Commission ADOPTED the foregoing Motion on November 19, 2020.

Commission Secretary	
AYES:	
NAYS:	
ABSENT:	

November 19, 2020



ADOPTED:

Jonas P. Ionin

EXHIBIT A

Authorization

This authorization is for a conditional use to allow a change in use from Residential Care Facility to a dwelling unit, located at 628 Shotwell Street, Lot 036 of Block 3611, pursuant to Planning Code Sections Planning Code Sections 209.1 and 303 and Board of Supervisors File No. 190908, within the RH-3 Zoning District and 40-X Height and Bulk District; in general conformance with plans, dated **July 10, 2020**, and stamped "EXHIBIT B" included in the docket for Record No. **2020-005123CUA** and subject to conditions of approval reviewed and approved by the Commission on November 19, 2020 under Motion No **XXXXXX**. This authorization and the conditions contained herein run with the property and not with a particular Project Sponsor, business, or operator.

Recordation of Conditions Of Approval

Prior to the issuance of the building permit or commencement of use for the Project the Zoning Administrator shall approve and order the recordation of a Notice in the Official Records of the Recorder of the City and County of San Francisco for the subject property. This Notice shall state that the project is subject to the conditions of approval contained herein and reviewed and approved by the Planning Commission on XXXXXX under Motion No. XXXXXX.

Printing of Conditions of Approval on Plans

The conditions of approval under the 'Exhibit A' of this Planning Commission Motion No. XXXXXX shall be reproduced on the Index Sheet of construction plans submitted with the site or building permit application for the Project. The Index Sheet of the construction plans shall reference to the Conditional Use authorization and any subsequent amendments or modifications.

Severability

The Project shall comply with all applicable City codes and requirements. If any clause, sentence, section or any part of these conditions of approval is for any reason held to be invalid, such invalidity shall not affect or impair other remaining clauses, sentences, or sections of these conditions. This decision conveys no right to construct, or to receive a building permit. "Project Sponsor" shall include any subsequent responsible party.

Changes and Modifications

Changes to the approved plans may be approved administratively by the Zoning Administrator. Significant changes and modifications of conditions shall require Planning Commission approval of a new Conditional Use authorization.



CONDITIONS OF APPROVAL, COMPLIANCE, MONITORING, AND REPORTING

Performance

1. Validity. The authorization and right vested by virtue of this action is valid for three (3) years from the effective date of the Motion. The Department of Building Inspection shall have issued a Building Permit or Site Permit to construct the project and/or commence the approved use within this three-year period.

For information about compliance, contact Code Enforcement, Planning Department at 628.652.7463, www.sfplanning.org

2. Expiration and Renewal. Should a Building or Site Permit be sought after the three (3) year period has lapsed, the project sponsor must seek a renewal of this Authorization by filing an application for an amendment to the original Authorization or a new application for Authorization. Should the project sponsor decline to so file, and decline to withdraw the permit application, the Commission shall conduct a public hearing in order to consider the revocation of the Authorization. Should the Commission not revoke the Authorization following the closure of the public hearing, the Commission shall determine the extension of time for the continued validity of the Authorization.

For information about compliance, contact Code Enforcement, Planning Department at 628.652.7463, www.sfplanning.org

3. **Diligent Pursuit.** Once a site or Building Permit has been issued, construction must commence within the timeframe required by the Department of Building Inspection and be continued diligently to completion. Failure to do so shall be grounds for the Commission to consider revoking the approval if more than three (3) years have passed since this Authorization was approved.

For information about compliance, contact Code Enforcement, Planning Department at 628.652.7463, www.sfplanning.org

4. Extension. All time limits in the preceding three paragraphs may be extended at the discretion of the Zoning Administrator where implementation of the project is delayed by a public agency, an appeal or a legal challenge and only by the length of time for which such public agency, appeal or challenge has caused delay.

For information about compliance, contact Code Enforcement, Planning Department at 628.652.7463, www.sfplanning.org

5. Conformity with Current Law. No application for Building Permit, Site Permit, or other entitlement shall be approved unless it complies with all applicable provisions of City Codes in effect at the time of such approval.



For information about compliance, contact Code Enforcement, Planning Department at 628.652.7463, www.sfplanning.org

Design - Compliance at Plan Stage

6. Final Materials. The Project Sponsor shall continue to work with Planning Department on the building design. Final materials, glazing, color, texture, landscaping, and detailing shall be subject to Department staff review and approval. The architectural addenda shall be reviewed and approved by the Planning Department prior to issuance.

For information about compliance, contact the Case Planner, Planning Department at 628.652.7313, www.sfplanning.org

7. Landscaping. Pursuant to Planning Code Section 132, the Project Sponsor shall submit a site plan to the Planning Department prior to Planning approval of the building permit application indicating that 50% of the front setback areas shall be surfaced in permeable materials and further, that 20% of the front setback areas shall be landscaped with approved plant species. The size and specie of plant materials and the nature of the permeable surface shall be as approved by the Department of Public Works.

For information about compliance, contact the Case Planner, Planning Department at 628.652.7313, www.sfplanning.org

8. Landscaping, Screening of Parking and Vehicular Use Areas. Pursuant to Planning Code Section 142, the Project Sponsor shall submit a site plan to the Planning Department prior to Planning approval of the building permit application indicating the screening of parking and vehicle use areas not within a building. The design and location of the screening and design of any fencing shall be as approved by the Planning Department. The size and species of plant materials shall be as approved by the Department of Public Works. Landscaping shall be maintained and replaced as necessary.

For information about compliance, contact the Case Planner, Planning Department at 628.652.7313, www.sfplanning.org

9. Landscaping, Permeability. Pursuant to Planning Code Section 156, the Project Sponsor shall submit a site plan to the Planning Department prior to Planning approval of the building permit application indicating that 20% of the parking lot shall be surfaced with permeable materials and further indicating that parking lot landscaping, at a ratio of one tree, of a size comparable to that required for a street tree and of an approved species, for every 5 parking stalls, shall be provided. Permeable surfaces shall be graded with less than a 5% slope. The size and specie of plant materials and the nature of the permeable surface shall be as approved by the Department of Public Works.

For information about compliance, contact the Case Planner, Planning Department at 628.652.7313, www.sfplanning.org



Parking and Traffic

10. Bicycle Parking. The Project shall provide no fewer than 2 Class 1 bicycle parking spaces as required by Planning Code Sections 155.1 and 155.2.

For information about compliance, contact Code Enforcement, Planning Department at 628.652.7463, www.sfplanning.org

11. Managing Traffic During Construction. The Project Sponsor and construction contractor(s) shall coordinate with the Traffic Engineering and Transit Divisions of the San Francisco Municipal Transportation Agency (SFMTA), the Police Department, the Fire Department, the Planning Department, and other construction contractor(s) for any concurrent nearby Projects to manage traffic congestion and pedestrian circulation effects during construction of the Project.

For information about compliance, contact Code Enforcement, Planning Department at 628.652.7463, www.sfplanning.org

Provisions

12. Residential Child Care Impact Fee. The Project is subject to the Residential Child Care Fee, as applicable, pursuant to Planning Code Section 414A.

For information about compliance, contact the Case Planner, Planning Department at 628.652.7313, www.sfplanning.org

13. Eastern Neighborhoods Infrastructure Impact Fee. The Project is subject to the Eastern Neighborhoods Infrastructure Impact Fee, as applicable, pursuant to Planning Code Section 423.

For information about compliance, contact the Case Planner, Planning Department at 628.652.7313, www.sfplanning.org

Monitoring - After Entitlement

14. Enforcement. Violation of any of the Planning Department conditions of approval contained in this Motion or of any other provisions of Planning Code applicable to this Project shall be subject to the enforcement procedures and administrative penalties set forth under Planning Code Section 176 or Section 176.1. The Planning Department may also refer the violation complaints to other city departments and agencies for appropriate enforcement action under their jurisdiction.

For information about compliance, contact Code Enforcement, Planning Department at 628.652.7463, www.sfplanning.org

15. Revocation due to Violation of Conditions. Should implementation of this Project result in complaints



from interested property owners, residents, or commercial lessees which are not resolved by the Project Sponsor and found to be in violation of the Planning Code and/or the specific conditions of approval for the Project as set forth in Exhibit A of this Motion, the Zoning Administrator shall refer such complaints to the Commission, after which it may hold a public hearing on the matter to consider revocation of this authorization.

For information about compliance, contact Code Enforcement, Planning Department at 628.652.7463, www.sfplanning.org

Operation

16. Sidewalk Maintenance. The Project Sponsor shall maintain the main entrance to the building and all sidewalks abutting the subject property in a clean and sanitary condition in compliance with the Department of Public Works Streets and Sidewalk Maintenance Standards.

For information about compliance, contact Bureau of Street Use and Mapping, Department of Public Works, 628.271.2000, <u>www.sfpublicworks.org</u>

17. Community Liaison. Prior to issuance of a building permit to construct the project and implement the approved use, the Project Sponsor shall appoint a community liaison officer to deal with the issues of concern to owners and occupants of nearby properties. The Project Sponsor shall provide the Zoning Administrator and all registered neighborhood groups for the area with written notice of the name, business address, and telephone number of the community liaison. Should the contact information change, the Zoning Administrator and registered neighborhood groups shall be made aware of such change. The community liaison shall report to the Zoning Administrator what issues, if any, are of concern to the community and what issues have not been resolved by the Project Sponsor.

For information about compliance, contact Code Enforcement, Planning Department at 628.652.7463, www.sfplanning.org



628 SHOTWELL STREET LLC

628 SHOTWELL STREET | SAN FRANCISCO | CALIFORNIA 94110

INTERIOR ALTERATION

- BUILDING PERMIT SET -

GENERAL CONSTRUCTION NOTES

- 1. ALL CONSTRUCTION SHALL CONFORM TO THE 2016 CALIFORNIA BUILDING CODE, AS AMENDED BY THE CITY OF SAN FRANCISCO, AND ANY OTHER GOVERNING CODES, RULES, REGULATION, ORDINANCES, LAWS, ORDER, APPROVALS FTC. THAT ARE REQUIRED BY PUBLIC AUTHORITIES. IN THE EVENT OF A CONFLICT. THE MOST STRINGENT REQUIREMENTS SHALL
- ANY ERRORS, OMISSIONS, OR CONFLICTS FOLIND IN THE VARIOUS PARTS. OF THE CONSTRUCTION DOCUMENTS SHALL BE BROUGHT TO THI ATTENTION OF THE ARCHITECT BEFORE PROCEEDING WITH THE WORK
- NERIEVALL DIMENSIONS IN THE FIELD. CARE HAS BEEN TAKEN TO PREPARE THESE DOCUMENTS USING ALL AVAILABLE INFORMATION PROVIDED BY THE OWNER DIMENSIONS MARKED (+/-) MAY BE ADJUSTED UP TO 2" AS REQUIRED BY FIELD CONDITIONS. ADJUSTMENTS OF MORE THAN 2" SHALL BE APPROVED BY THE ARCHITECT. DO NOT SCALE DRAWINGS. USE WRITTEN DIMENSIONS IF CONFLICTS EXIST NOTIFY THE ARCHITECT BEFORE PROCEEDING WITH WORK. DIMENSIONS ARE TO FACE OF FINISH UNLESS OTHERWISE NOTED.
- 4. GENERAL CONTRACTOR IS RESPONSIBLE FOR COORDINATION OF HIS WORK AND THAT OF ALL SUB-CONTRACTORS. VERIEY AND COORDINATE ALL ROUTING OF MECHANICAL, ELECTRICAL AND PLUMBING ITEMS, ROUGH-IN DIMENSIONS, AND REQUIRED CLEARANCES ASSOCIATED WITH THE PROJECT WORK SUCH THAT CONFLICTS DO NOT OCCUR. NOTIFY ARCHITECT OF PROBLEMATIC CONDITIONS
- WHERE WORK REQUIRES CUTTING INTO OR DISRUPTION OF EXISTING CONSTRUCTION, THE CONTRACTOR IS RESPONSIBLE FOR PATCHING AND REPAIRING BOTH THE AREA OF WORK AND ITS A ADJACENT SURFACES TO MATCH ADJACENT EXISTING SURFACES. PATCHING INCLUDES FINISHED PAINTING OF AREA DISPUIPTED
- 6. CONTRACTOR SHALL REMOVE EXISTING WALLS AND OTHER ASSOCIATED CONSTRUCTION AS INDICATED ON THE DEMOLITION PLAN BY DASHED
- 7 CONTRACTOR TO VERIEY ALL CONDITIONS BEFORE PROCEEDING WITH DEMOLITION WORK IN ANY AREA, DEMOLITION OF DOORS, WINDOWS. CABINETRY, FINISHES, PARTITIONS OR ANY OTHER NONSTRUCTURAL ITEMS MAY PROCEED AS INDICATED, WHERE DISCREPANCIES INVOLVE STRUCTURAL ITEMS. REPORT SUCH DIFFERENCES TO THE ARCHITECT AND SECURE INSTRUCTIONS BEFORE PROCEEDING IN THE AFFECTED AREA.
- 3. SEE ELECTRICAL POWER & LIGHTING DRAWINGS FOR EXTENT OF (N) LIGHTING TO BE INSTALLED. CONTRACTOR TO REMOVE CEILING PLASTER AS REQUIRED FOR INSTALLATION OF PROPOSED LIGHTING.
- 9. CONTRACTOR SHALL COORDINATE WITH OWNER THE SALVAGE OF LIGHT FIXTURES, FURNISHINGS, DOORS AND MISC. EQUIPMENT.
- 10. CONTRACTOR SHALL PROVIDE ALL NECESSARY BARRICADES AND OTHER FORMS OF PROTECTION AS REQUIRED TO GUARD THE OWNER, OTHER TENANTS AND THE GENERAL PUBLIC FROM INJURY DUE TO DEMOLITION
- 11. CONTRACTOR SHALL ENSURE THAT DEMOLITION WORK DOES NOT INTERFERE WITH OR PROHIBIT THE CONTINUING OCCUPATION OF ADJACENT DWELLINGS WITHIN THE STRUCTURE. THIS INCLUDES BUT IS NOT LIMITED TO THE SELECTIVE DEMOLITION OF PARTITIONS, ELECTRICAL AND MECHANICAL SYSTEMS. THE CONTRACTOR SHALL INFORM OWNER 72 HOURS IN ADVANCE OF DEMOLITION ACTIVITIES THAT WILL AFFECT NORMAL OPERATION OF BUILDING.
- 12. CONTRACTOR SHALL REPAIR DAMAGE CAUSED TO ADJACENT FACILITIES BY DEMOLITION WORK.

GENERAL STRUCTURAL NOTES

- STRUCTURAL OBSERVATION SHALL BE REQUIRED BY THE ENGINEER FOR STRUCTURAL CONFORMANCE TO THE APPROVED PLANS.
- 2. SEE STRUCTURAL DRAWINGS FOR ADDITIONAL NOTES &

GENERAL ENERGY CONSERVATION NOTES

- EXTERIOR WALL ROOF & RAISED FLOOR CAVITIES EXPOSED DURING DEMOLITION ARE TO BE INSULATED PER TITLE 24 ENERGY CALCULATIONS AND OR MANDATORY MEASURES PROVIDED WITHIN THIS DRAWING SET. SEE GENERAL INSULATION NOTES BELOW FOR MINIMUM INSULATION REQUIREMENTS SHOULD TITLE 24 ENERGY CALCULATION NOT BE REQUIRED FOR THIS PROJECT
- 2. ALL LIGHTING TO COMPLY WITH CCR TITLE 24, LATEST EDITION. SEE GENERAL LIGHTING NOTES & ELECTRICAL & LIGHTING PLANS FOR ENERGY CONSERVATION FEATURES

GENERAL INSULATION NOTES

. PROVIDE INSULATION AT ALL EXTERIOR WALLS, FLOORS AND ROOFS WHEN EXPOSED DURING REMODELING PER MINIMUM REQUIREMENTS LISTED. BELOW, UNLESS OTHERWISE NOTED IN TITLE 24 OR SUPPLEMENTAL GREEN COMPLIANCE DOCUMENTATION

R-15 AT 2X4 WALLS R-19 AT 2X6 WALLS AND FLOORS R-30 AT CEILING

NOTED OTHERWISE.

GENERAL ELECTRICAL NOTES

- ALL ELECTRICAL WORK IS DESIGN/RUIL D. BY CONTRACTOR. VERIEV LOCATIONS OF EQUIPMENT AND FIXTURES AS SHOWN ON THE PLANS W/ ACTUAL FIELD CONDITIONS. NOTIFY ARCHITECT OF ANY DISCREPANCIES DO NOT CUT NOTCH, HEAD OFF OR MODIFY ANY STRUCTURAL MEMBERS.
- 2. VERIFY ELECTRICAL / TELEPHONE / CATV / SPEAKER REQUIREMENTS WITH
- 3. ELECTRICAL CONTRACTOR SHALL PROVIDE PROPER ELECTRICAL SERVICE TO ALL APPLIANCES. CONSULT MANUFACTURER'S INSTALLATION INSTRUCTIONS AND SPECIFICATIONS AS REQUIRED.
- I. INSTALL THERMOSTATS AT 64" FROM CENTERLINE OF COVER PLATE TO FINISH FLOOR. MECHANICAL SUB-CONTRACTOR TO VERIFY LOCATIONS
- 5. MINIMUM REQUIREMENTS FOR ELECTRICAL WORK AT ALL HABITABLE ROOMS: PROVIDE DUPLEX RECEPTACLES TO COMPLY WITH CURRENT CEC AS AMENDED BY LOCAL BUILDING CODES AS FOLLOWS:
- A RECEPTACLES SHALL BE 6'-0" FROM DOOR OPENINGS B. RECEPTACLES SHALL BE SPACED 12'-0" MAXIMUM ON CENTER ALONG
- WALLS IN HALLWAYS AND IN ROOMS. C. ANY WALL 2'-0" OR GREATER IN LENGTH SHALL HAVE MINIMUM (1)
- ELECTRICAL OUTLET. D. RECEPTACLES SHALL BE PLACED +12" ABOVE THE FINISH FLOOR UNLESS
- 6. MINIMUM REQUIREMENTS FOR ELECTRICAL WORK AT NEW & REMODELED KITCHENS & BATHROOMS: PROVIDE DUPLEX RECEPTACLES IN COMPLIANCE WITH CURRENT CEC AND LOCAL BUILDING CODE AMENDMENTS AS
- A. RECEPTACLES SHALL BE 4'-0" MINIMUM FORM SINK LOCATIONS B. RECEPTACLES SHALL BE SPACED 4'-0" MAX. ON CENTER ALONG KITCHEN
- & BATH COUNTERS. C. PROVIDE GFIC AT RECEPTACLES WHERE REQUIRED BY CODE. D. ALL KITCHEN COUNTERS WIDER THAN 12" TO HAVE RECEPTACLE
- PROVIDE 20 AMP BRANCH CIRCUITS TO SERVE BATHROOM RECEPTACLES OUTLETS PER CEC 210 11
- 8. PROVIDE 20 BRANCH CIRCUITS TO SERVE LAUNDRY ROOM RECEPTACLE OUTLETS PER CEC 210.11.
- 9. KITCHENS SHALL BE PROVIDED WITH AT LEAST (2) 20 AMP SMALL APPLIANCE BRANCH CIRCUITS.
- 10. RANGES, DISHWASHERS, WASHER & DRYERS, HVAC EQUIPMENT & GARAGE DOOR OPENERS WHEN INSTALLED, TO BE PROVIDED WITH DEDICATED CIRCUIT AS REQUIRED BY CODE
- 11 BEDROOMS BRANCH CIRCUITS SHALL BE PROTECTED BY LISTED ARC FAULT CIRCUIT INTERRUPTER PER CEC 210.12.
- 12. INSTALL HARDWIRED SMOKE DETECTORS AT EACH FLOOR OR RESIDENCE ON WALL OR CEILING GIVING ACCESS TO SLEEPING AREAS AND INSIDE ROOMS INTENDED FOR SLEEPING. VERIFY ACCEPTABILITY OF LOCATIONS WITH FIRE MARSHALL / BUILDING INSPECTOR REFORE INSTALLATION SMOKE DETECTORS SHALL BE HARDWIRED w/ BATTERY BACK-UP & AUDIBLE IN ALL SLEEPING ROOMS
- 13 CARBON MONOXIDE ALARMS TO BE INSTALLED IN DWELLING LINITS. CONTAINING FUEL BURNING APPLIANCES. ALARM TO BE LOCATED HALLWAYS GIVING ACCESS TO BEDROOMS & ON ALL FLOORS, OF DWELLING COMBINATION CARBON MONOXIDE / SMOKE ALARMS ARE PERMITTED. IF COMBINATION UNIT IS USED, UNIT TO BE INSTALLED PER REQUIREMENTS OF
- 14. KITCHEN LIGHTING (REMODELED OR NEW) SHALL BE MIN. 50% HIGH EFFICACY & MUST BE SWITCHED SEPARATELY FROM NON-HIGH EFFICACY
- 15. BATHROOM, LAUNDRY ROOM, GARAGE & UTILITY ROOM (REMODELED & NEW) SHALL BE ALL HIGH EFFICACY LINLESS NON-HIGH EFFICACY CONTROLLED BY CERTIFIED OCCUPANCY SENSOR(S) WITH MANUAL ON MOTION SENSOR, "ALWAYS-ON" OPTION NOT PERMITTED
- 16. BEDROOM, HALLWAY, STAIR, DINING ROOM & CLOSET LIGHTING SHALL BE HIGH EFFICACY UNLESS NON-HIGH EFFICACY LIGHTING CONTROLLED BY DIMMER SWITCH OR CERTIFIED OCCUPANCY SENSOR(S) WITH MANUAL ON MOTION SENSOR, "ALWAYS-ON" OPTION NOT PERMITTED
- 17. LIGHT FIXTURES IN TUB, SHOWER OR ANY OTHER LOCATION SUBJECT TO WATER SPRAY SHALL BE LABELED "SUITABLE FOR WET LOCATION"

GENERAL ELECTRICAL NOTES

- 18. OUTDOOR LIGHTING SHALL BE HIGH EFFICACY UNLESS LIGHTING IS CONTROLLED BY CERTIFIED MOTION SENSORS & PHOTOCONTROL OF LANDSCAPE LIGHTING (NOT ATTACHED TO BUILDINGS)
- 19. RECESSED LIGHTING FIXTURES TO BE "ZERO CLEARANCE INSULATION COVER" (IC) APPROVED AT INSULATED AREAS.
- 20 CLOSET LAMPS SHALL BE ENCLOSED TYPE IF INCANDESCENT, FIXTURE

GENERAL PLUMBING NOTES

- ALL PLUMBING SYSTEMS ARE DESIGN / BUILD BY CONTRACTOR. LOCATE THE VARIOUS PLUMBING RUNS INCLUDING DWV AND VERIFY LOCATIONS. OF PROPOSED RUNS WITH ACTUAL FIELD CONDITIONS. VERIFY LOCATIONS WITH ARCHITECT. DO NOT CUT, NOTCH, HEAD OFF OR MODIFY ANY STRUCTURAL MEMBERS
- RELOCATE / RECONFIGURE ALL PLUMBING AS REQUIRED AND AS DIAGRAMMATICALLY SHOWN ON DRAWINGS TO ACHIEVE REMODELING OR ARE EITHER NEW OR REMODELED THE FOLLOWING MINIMUM STANDARDS
- 3. KITCHEN AND LAVATORY FAUCETS TO BE MAX. 1.5 G.P.M MEASURED AT
- 4. WATER CLOSETS HAVE MAX. 1.28 GPF WATER CONSUMPTION.
- 5. SHOWER HEADS NOT TO EXCEED 2.0 GPM MEASURED AT 80 PSI.
- 6 SHOWERS & TUBS TO HAVE INDIVIDUAL CONTROL VALVES OF THE PRESSURE BALANCE OR THERMOSTATIC MIX TYPE.
- . SHOWER VALVES & HEADS SHALL BE PLACED INSIDE SHOWER COMPARTMENT SUCH THAT SHOWER HEAD DOES NOT DISCHARGE DIRECTLY TOWARD THE ENTRANCE OF THE COMPARTMENT AND THE BATHER CAN ADJUST VALVES PRIOR TO STEPPING INTO SHOWER SPRAY.
- B. DISHWASHER WASTE LINE TO BE PROVIDED WITH APPROVED AIR GAP SEPARATION DEVICE
- 9. HOSE BIBBS TO HAVE APPROVED BACK-FLOW PREVENTION DEVICE.
- 10. PROVIDE SEISMIC BRACING FOR WATER HEATERS IN ACCORDANCE
- 11. ALL COLD WATER PIPES TO BE INSULATED.

GENERAL MECHANICAL NOTES

- ALL MECHANICAL WORK IS DESIGN / BUILD BY CONTRACTOR VERIEY LOCATION OF EQUIPMENT AND FIXTURES AS SHOWN ON THE PLANS WITH ACTUAL FIELD CONDITIONS. NOTIFY ARCHITECT OF ANY DISCREPANCIES DO NOT CUT, NOTCH, HEAD OFF OR MODIFY ANY STRUCTURAL MEMBERS VERIFY ALL FLECTRICAL / TELEPHONE / CATV / SPEAKER REQUIREMENTS WITH OWNER BEFORE INITIATING ANY MECHANICAL SYSTEM WORK.
- PROVIDE MINIMUM 100 S.I. COMBUSTION AIR AT NEW & REMODELED FAU'S & SPACES CONTAINING THEM PER UMC.
- 3 ALL NEW FALL'S TO BE RATED FOR THEIR SPECIFIC LOCATION
- 4. NEW & REMODELED BATHROOMS TO BE PROVIDED WITH EXHAUST AN CAPABLE OF PROVIDING 5 AIR CHANGES PER HOUR. VENT TO OUTSIDE PER CMC 504.5 PROVIDE BACK-DRAFT DAMPER
- 5. TYPE B GAS VENTS, WHEN INSTALLED AS PART OF THIS PROJECT TO BE
- 6. RANGEHOOD, BATH VENTILATION EXHAUST, DRYER EXHAUST & SIMILAR ENVIRONMENTAL DUCTS TO TERMINATE AT EXTERIOR OF BUILDING AT LEAST 3'-0" FROM PROPERTY LINE & 3'-0" FROM OPENINGS INTO BUILDINGS.
- . INTERSTITIAL SPACES SHALL NOT BE USED TO SUPPLY OR RETURN FORCED AIR


EXCAVATION SUMMARY

DESCRIPTION	PROPOSED
FIRST FLR (FOUNDATION)	169 CU. YD.
SIDE YARD (NORTH)	30 CU. YD.
SIDE YARD (SOUTH)	15 CU. YD.
FRONT YARD	20 CU. YD.
REAR YARD	76 CU. YD.
TOTAL	310 CU. YD.

VICINITY MAP



SYMBOL LEGEND

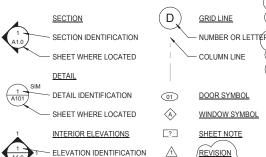

ARCHITECT

440 SPEAR STREET

T. 415.543.5005

HOOD THOMAS ARCHITECTS MARK THOMAS

SAN FRANCISCO, CA 94105

E: MARK@HOODTHOMAS.COM

PROJECT DIRECTORY

- SHEET WHERE LOCATED

- FI EVATION VIEW

OWNER 628 SHOTWELL LLC 4153 24TH STREET SAN FRANCISCO, CA. 94114 T 415 648 1200 F. 415.648.1213 STRUCTURAL ENGINEER ENERTIA DESIGNS JEFFERSON CHEN 1167 MISSION STREET FLOOR 01 SAN FRANCISCO, CA 94103 T 415 626 8300

F. 415.701.0212 E: JEFFERSON@ENERTIADESIGNS.NET SOILS ENGINEER PGSOILS INC. PAUL GRISHABER 901 ROSE COURT BURLINGAME, CA 94010 T. 650.347.3934

AREA CALCULATIONS (GROSS)

E: PGSOILS.INC@GMAIL.COM

			•	,
	BUILDING	EXISTING	PROPOSED	ADDITION
	FIRST FLRw/o GARAGE	600 SF	985 SF	385 SF
	SECOND FLR	1,646 SF	1,646 SF	0 SF
	THIRD FLR	1,616 SF	1,616 SF	0 SF
	TOTAL	√3,862 ₄ SF∕	4,247 SF-/	385.8F
	GARAGE	925 SF	572 SF	-353 SF
Λ	MECH	0 SF	79 SF	79 SF
У				
1	> DWELLING UNIT	EXISTING	PROPOSED	ADDITION
	UNIT 1 (FLOOR 01)	0 SF	828 SF	828 SF
	UNIT 2 (FLOOR 01,02,03) 3,262 SF	3,419 SF	157 SF
	TOTAL	3,262 SF	4,247 SF	, 985 SF√
		L~/	\sim	

PROJECT DESCRIPTION
REMODELING OF AN EXISTING FIRE DAMAGED 3-STORY WOOD FRAME WITH DISCONTINUED RESIDENTIAL CARE FACILITY (RCF) AT 2ND FLOOR AND A SINGLE FAMILY RESIDENCE AT THE 3RD FLOOR TO BECOME 2-RESIDENTIAL DWELLING UNITS: 1 FLOOR 01:

PROJECT DATA

- A. MAINTAIN SPACE FOR A 1-CAR GARAGE.
 B. PROVIDE 1-BEDROOM, 1 BATHROOM DWELLING UNIT WITH EXTERIOR PATIO AND DIRECT ACCESS TO REAR YARD
- 2 FLOOR 02/03: A. PROVIDE 4-BEDROOM, 3 ½ BATHROOM DWELLING UNIT WITH EXTERIOR DECK AND ACCESS TO REAR YARD
- 3. GENERAL INTERIOR REMODELING: A. REMODEL EXISTING FIRE DAMAGED INTERIORS AT 3 FLOORS. B. NEW FINISHES TO REPLACE EXISTING FINISHES THROUGHOUT.
- C. PROVIDE SECOND DWELLING UNIT AT FLOOR 01 4. FOUNDATIONS & SEISMIC UPGRADE: A. UNDERPIN EXISTING FOUNDATIONS WHERE REQUIRED AND PROVIDE NEW FOUNDATIONS AT EXTERIOR DECK AND EXISTING
- NON-COMPLIANT FOLINDATIONS B. SEISMIC UPGRADE TO COMPLY WITH CBC CH. 34 FOR EXISTING
- BUILDINGS C. EXCAVATE AT FIRST FLOOR TO INCREASE CEILING HEIGHT TO
- 5. NEW REAR YARD DECK

A NEW REAR YARD DECKLESS THAN 10-FEET ABOVE GRADE (NO FIREWALL REQUIRED FOR REAR YARD DECK, NO NEIGHBORHOOD NOTIFICATION REQUIRED BY ZA BULLETIN #4)

PLANNING DEPARTMENT DATA

A. PROPERTY BLOCK: 3611 LOT: 03 B. ZONING: RH-3 (HOUSE, THREE-FAMILY) C. MAXIMUM HEIGHT: 40'-0' D. DWELLING UNITS: EXISTING: 1 PROPOSED: 2

BUILDING DEPARTMENT DATA
EXISTING CONSTRUCTION GROUP VB (NO CHANGE) OCCUPANCY TYPE R3 (NO CHANGE) BUILDING HEIGHT 42'-3" 42'-3" (NO CHANGE) BUILDING STORIES 3 (NO CHANGE) DWELLING UNITS YES (13R) SPRINKLER SYSTEM GOVERNING CODES

ALL WORK SHALL BE IN COMPLIANCE WITH ALL STATE AND

LOCAL CODES, INCLUDING THE FOLLOWING 2016 CALIFORNIA RESIDENTIAL CODE

2016 CALIFORNIA BUILDING CODE (W/ LOCAL AMENDMENTS) 2016 CALIFORNIA MECHANICAL CODE (W/ LOCAL AMENDMENTS) 2016 CALIFORNIA PLUMBING CODE (W/ LOCAL AMENDMENTS) 2016 CALIFORNIA ELECTRICAL CODE (W/ LOCAL AMENDMENTS) 2016 CALIFORNIA ENERGY CODE (W/ LOCAL AMENDMENTS) 2016 CALIFORNIA FIRE CODE (W/ LOCAL AMENDMENTS)

DRAWING INDEX

ARCHITECTURAL DRAWINGS

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EXISTING & PROPOSED FLOOR 01 A1 1 A1.2 EXISTING & PROPOSED FLOOR 02 EXISTING & PROPOSED FLOOR 03 A13

EXISTING & PROPOSED EAST ELEVATION A2.1 EXISTING & PROPOSED WEST ELEVATION A2.2 A2 3 EXISTING & PROPOSED NORTH ELEVATION

A2 4 EXISTING & PROPOSED SOUTH FLEVATION A3.1 BUILDING SECTION A5.1 ARCHITECTURAL DETAILS

A5.2 DRAINAGE PLAN & DETAILS A6.1 DOOR & WINDOW SCHEDULES A6.2 GREEN BUILDING COMPLIANCE

A6.3 TITLE 24 A6.4 TITLE 24 ELECTRICAL PLAN

ELECTRICAL PLAN E1.2 LIGHTING PLAN E2.2 LIGHTING PLAN

STRUCTURAL DRAWINGS

TITLE SHEET S1.1A-S1.1B TYPICAL WOOD DETAILS S1.2A TYPICAL CONCRETE DETAILS SECOND FLOOR FRAMING. THIRD FLOOR FRAMING PLAN

STRUCTURAL DETAILS





628 SHOTWELL STREET LLC

INTERIOR **ALTERATION**

628 SHOTWELL STREET SAN FRANCISCO, CA 94110 BLOCK:3611 LOT:036

ISSUE:	DATE:
PROJECT REVIEW	09.09.19
ISSUE FOR PERMIT	11.13.19
PLAN CHECK #1	03.13.20
REVISION 01	07.10.20


DATE:

COVER SHEET

SHEET NUMBER:

SHEET TITLE:

DATE:

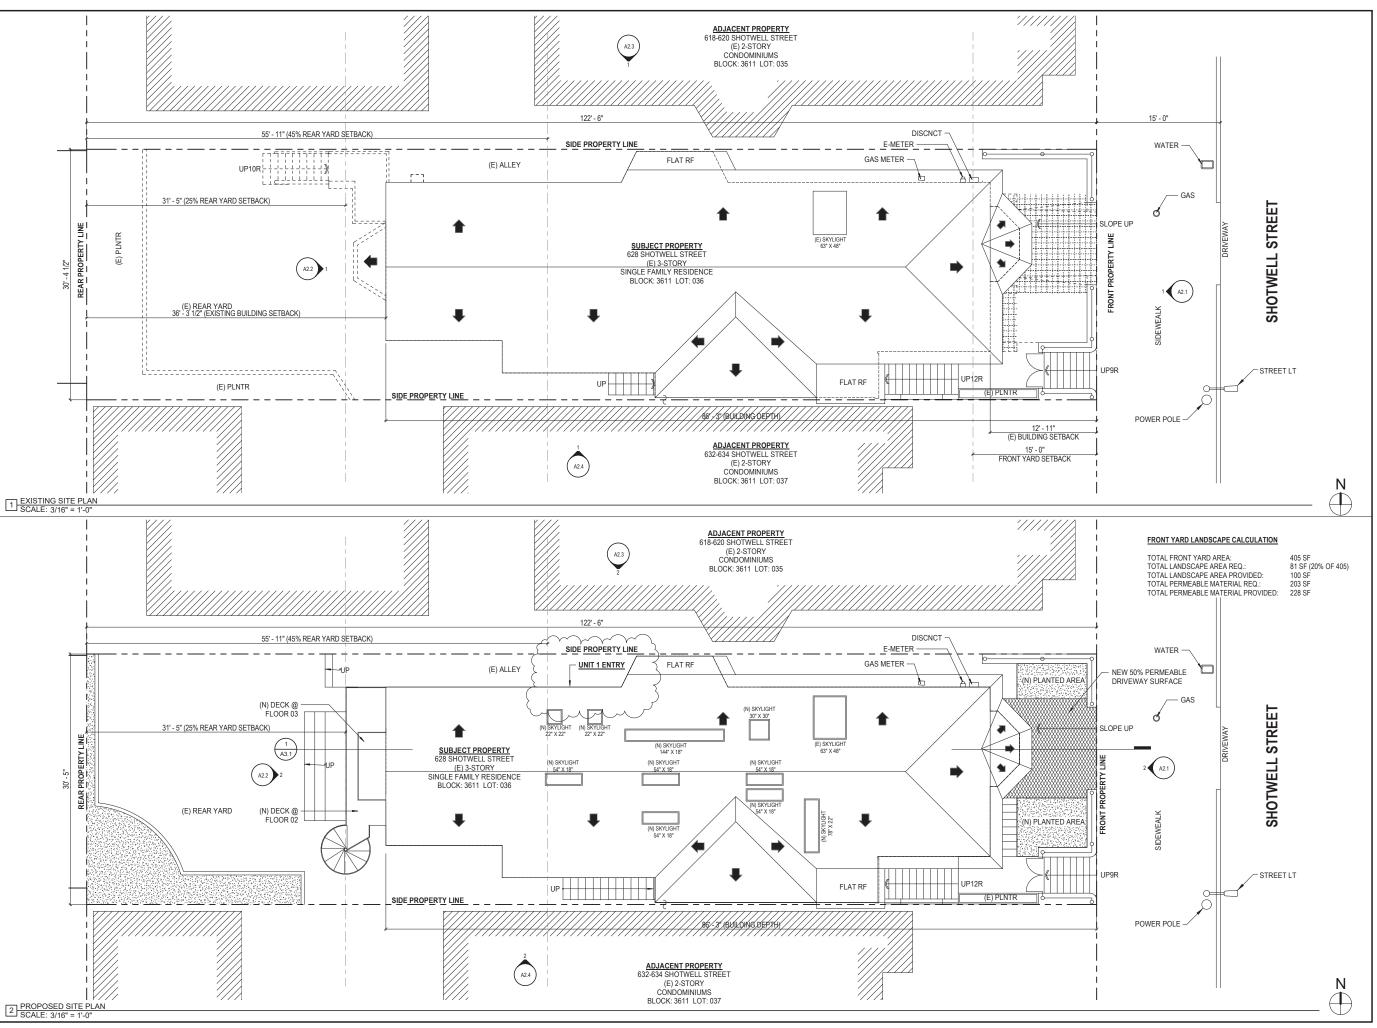





628 SHOTWELL STREET LLC

INTERIOR ALTERATION

628 SHOTWELL STREET SAN FRANCISCO, CA 94110 BLOCK:3611 LOT:036


ISSUE:	DATE:
PROJECT REVIEW	09.09.19
ISSUE FOR PERMIT	11.13.19
PLAN CHECK #1	03.13.20
REVISION 01	07.10.20
DRAWN BY:	
DRAWN BY: DATE:	07.10.20

EXISTING & PROPOSED SITE PLAN

SHEET NUMBER:

A0.1

PEV #· DATE-

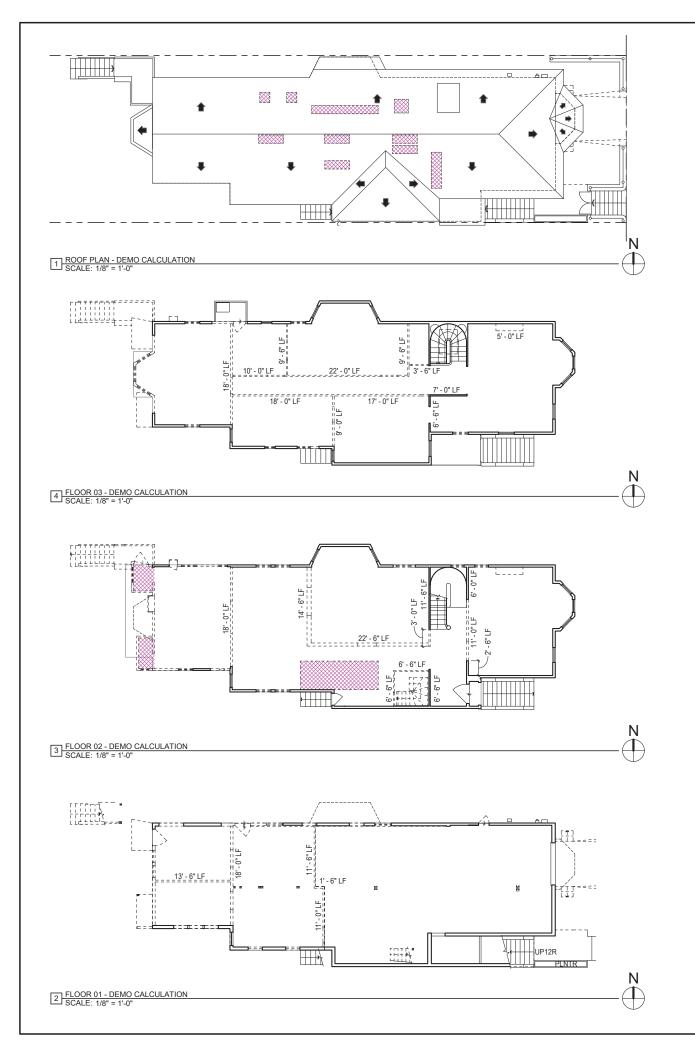

SECTION 317

WALL DEMOLITION CALCULATION (LINEAR FOOTAGE MEASUREMENT) SEC. 317(b)(2)(B)						
ELEMENTS	(E) LENGTH (LF)	WALL REMOVED (LF) (MEASURED AT FOUNDATION LEVEL)	% REMOVED	MAX PERMITTED	MEET CODE?	
EAST (FRONT) FACADE	26' - 2" LF	0' - 0" LF	0 %			
WEST (REAR) FACADE)	26' - 2" LF	19' - 3" LF	74 %			
TOTALS (EAST & WEST)	52' - 4" LF	19' - 3" LF	37 %	50 %	YES	
TOTAL NORTH & SOUTH ELEMENTS RE	MOVED = 37 %					
SOUTH FACADE	73' - 4" LF	0' - 0" LF	0 %			
NORTH FACADE	73' - 4" LF	0' - 0" LF	0 %			
TOTALS (SOUTH & NORTH)	146' - 8" LF	0' - 0" LF	0 %			
TOTAL ALL SIDES	199' - 0" LF	38' - 6" LF	19 %	65 %	YES	
TOTAL ALL SIDES ELEMENTS TO BE RE	MOVED = 19 %					

WALL DEMOLITION CALCULATION (AREA MEASUREMENT) SEC. 317(b)(2)(C)						
VERTICAL ELEMENTS AREA (SF) AREA REMOVED (SF) % REMOVED MAX PERMITTED MEET COD						
EAST (FRONT) FACADE	960 SF	68 SF	7 %			
WEST (REAR) FACADE)	985 SF	419 SF	43 %			
SOUTH FACADE	2,512 SF	356 SF	14 %			
NORTH FACADE	2,699 SF	551 SF	20 %			
TOTALS	7,156 SF	1,394 SF	19 %	50 %	YES	
TOTAL VERTICAL ELEMENTS TO BE	REMOVED = 15%			-		

FLOOR DEMOLITION CALCULATION (AREA MEASUREMENT) SEC. 317(b)(2)(C)						
HORIZONTAL ELEMENTS	AREA (SF)	AREA REMOVED (SF)	% REMOVED	MAX PERMITTED	MEET CODE?	
FLOOR 01 (ON GRADE)	N/A					
FLOOR 02	1,648 SF	108 SF	7 %			
FLOOR 03	1,586 SF	0 SF	0 %			
ROOF	1,875 SF	76 SF	4 %			
TOTALS	5,109 SF	184 SF	4 %	50 %	YES	
TOTAL HORIZONTAL ELEMENTS TO	OTAL HORIZONTAL ELEMENTS TO BE REMOVED = 15%					

THIS PROJECT IS NOT CONSIDERED AS DEMOLITION PER SAN FRANCISCO PLANNING CODE SEC. 317 (2) (B)&(C)

SECTION 1005

WALL REMOVAL >25% OF THE SURFACE OF ALL EXTERNAL WALLS FACING A PUBLIC STREET(S) SEC. 1005(f)1						
VERTICAL ELEMENTS AREA (SF) AREA REMOVED (SF) % REMOVED MAX PERMITTED MEET CODE?						
EAST (FRONT) FACADE	960 SF	17 SF	2 %			
TOTALS	960 SF	17 SF	2 %	25 %	YES	
TOTAL SURFACE OF EXTERNAL WALLS FACING STREET TO BE REMOVED = 2 %						

VERTICAL ELEMENTS	AREA (SF)	AREA REMOVED (SF)	% REMOVED	MAX PERMITTED	MEET CODE
EAST (FRONT) FACADE	960 SF	68 SF	7 %		
WEST (REAR) FACADE)	985 SF	419 SF	43 %		
SOUTH FACADE	2,512 SF	356 SF	14 %		
NORTH FACADE	2,699 SF	551 SF	20 %		
TOTALS	7,156 SF	1,394 SF	19 %	50 %	YES

REMOVAL OF MORE THAN 25% OF EXTERNAL WALLS FROM FUNCTION AS EITHER EXTERNAL OR INTERNAL WALLS SEC.1005(f)3						
VERTICAL ELEMENTS AREA (SF) AREA REMOVED (SF) % REMOVED MAX PERMITTED MEET CO						
EAST (FRONT) FACADE	960 SF	68 SF	7 %			
WEST (REAR) FACADE)	985 SF	419 SF	43 %			
SOUTH FACADE	2,512 SF	356 SF	14 %			
NORTH FACADE	2,699 SF	551 SF	20 %			
TOTALS	7,156 SF	1,394 SF	19 %	25 %	YES	
TOTAL HORIZONTAL ELEMENTS TO	BE REMOVED = 15%	•				

REMOVAL OF MORE T	HAN 75% OF ALL INTERN	AL STRUCTURAL FRAMEW	ORK OR FLOOF	R PLATES SEC.100	5(f)4
STRUCTURAL WALL	AREA (SF)	AREA REMOVED (SF)	% REMOVED	MAX PERMITTED	MEET CODE
FLOOR 01	500 SF	500 SF	100 %		
FLOOR 02	1,302 SF	984 SF	76 %		
FLOOR 03	1,485 SF	1337 SF	90 %		
TOTALS	3,287 SF	2,821 SF	86 %		
FLOOR AREA	AREA (SF)	AREA REMOVED (SF)	% REMOVED		
FLOOR 01 (ON GRADE)	N/A				
FLOOR 02	1,648 SF	108 SF	7 %	1	
FLOOR 03	1,586 SF	0 SF	0 %	1	
ROOF	1,875 SF	76 SF	4 %	1	
TOTALS	5,109 SF	184 SF	4 %	1	
TOTALS ALL STRUCTURAL FRAM	EWORK/FLOOR PLATES TO	BE REMOVED = 45%		75 %	YES

THIS PROJECT IS NOT CONSIDERED AS DEMOLITION PER SAN FRANCISCO PLANNING CODE SEC. 1005(f)(1)(2)(3)(4)

DEMOLITION NOTES





628 SHOTWELL STREET LLC

INTERIOR ALTERATION

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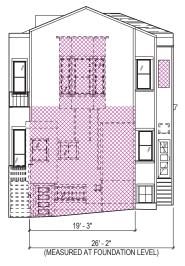
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DEMOLITION CALCULATION PLANS


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ALL DEMOLITION WORK TO COMPLY WITH SFBC CH13B - CONSTRUCTION AND DEBRIS RECOVERY PROGRAM.
 DEMOLITION OTHER THAN THAT EXPLICITLY STATED AND SHOWN ON THE ARCHITECTURAL DEMO PLANS IS ILLEGAL UNDER P.C. 317 AND ANY MODIFICATIONS REQUIRE A PERMIT REVISION AND APPROVAL FROM THE SF PLANNING DEPARTMENT.






EXISTING WEST ELEVATION (REAR) - DEMO CALC SCALE: 1/8" = 1'-0"

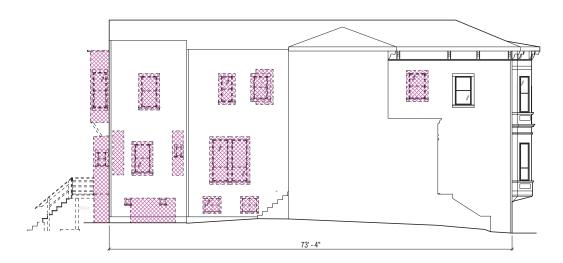

EXISTING SOUTH ELEVATION (SIDE) - DEMO CALC SCALE: 1/8" = 1'-0"

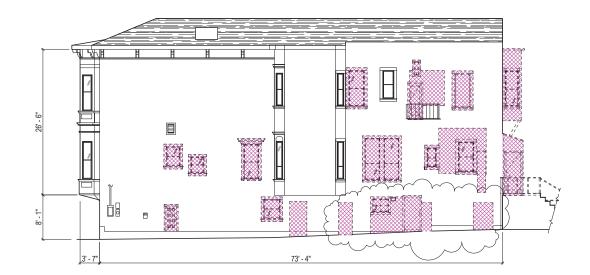

EXISTING NORTH ELEVATION (SIDE) - DEMO CALC SCALE: 1/8" = 1'-0"

SECTION 317

ELEMENTS	(E) LENGTH (LF)	WALL REMOVED (LF) (MEASURED AT FOUNDATION LEVEL)	% REMOVED	MAX PERMITTED	MEET CODE?
EAST (FRONT) FACADE	26' - 2" LF	0' - 0" LF	0 %		
WEST (REAR) FACADE)	26' - 2" LF	19' - 3" LF	74 %		
TOTALS (EAST & WEST)	52' - 4" LF	19' - 3" LF	37 %	50 %	YES
TOTAL NORTH & SOUTH ELEMENTS RE	MOVED = 37 %				
SOUTH FACADE	73' - 4" LF	0' - 0" LF	0 %		
NORTH FACADE	73' - 4" LF	0' - 0" LF	0 %		
TOTALS (SOUTH & NORTH)	146' - 8" LF	0' - 0" LF	0 %		
TOTAL ALL SIDES	199' - 0" LF	38' - 6" LF	19 %	65 %	YES
TOTAL ALL SIDES ELEMENTS TO BE RE	MOVED = 19 %				

WALL DEMOLITION CALCULATION (AREA MEASUREMENT) SEC. 317(b)(2)(C)						
VERTICAL ELEMENTS	AREA (SF)	AREA REMOVED (SF)	% REMOVED	MAX PERMITTED	MEET CODE?	
EAST (FRONT) FACADE	960 SF	68 SF	7 %			
WEST (REAR) FACADE)	985 SF	419 SF	43 %			
SOUTH FACADE	2,512 SF	_356 SF \	~~14%\			
NORTH FACADE	2,699 SF	551 SF	20 % }			
TOTALS	7,156 SF) 1,394 SF	19%	50 %	YES	
TOTAL VERTICAL ELEMENTS TO BE RE	MOVED = 15%	1				

FLOOR	DEMOLITION CALCULA	TION (AREA MEASUREMEN	T) SEC. 317(b)(2)(C)	
HORIZONTAL ELEMENTS	AREA (SF)	AREA REMOVED (SF)	% REMOVED	MAX PERMITTED	MEET CODE?
FLOOR 01 (ON GRADE)	N/A				
FLOOR 02	1,648 SF	108 SF	7 %		
FLOOR 03	1,586 SF	0 SF	0 %		
ROOF	1,875 SF	76 SF	4 %		
TOTALS	5,109 SF	184 SF	4 %	50 %	YES
TOTAL HORIZONTAL ELEMENTS TO	D BE REMOVED = 15%		'		

THIS PROJECT IS NOT CONSIDERED AS DEMOLITION PER SAN FRANCISCO PLANNING CODE SEC. 317 (2) (B)&(C)

SECTION 1005

WALL REMOVAL >25% OF THE SURFACE OF ALL EXTERNAL WALLS FACING A PUBLIC STREET(S) SEC. 1005(f)1					
VERTICAL ELEMENTS	AREA (SF)	AREA REMOVED (SF)	% REMOVED	MAX PERMITTED	MEET CODE
EAST (FRONT) FACADE	960 SF	17 SF	2 %		
TOTALS	960 SF	17 SF	2 %	25 %	YES

REMOVAL OF MORE THAN 50% OF ALL EXTERNAL WALLS FROM THEIR FUNCTIONS AS ALL EXTERNAL WALLS 1005(f)2					
VERTICAL ELEMENTS	AREA (SF)	AREA REMOVED (SF)	% REMOVED	MAX PERMITTED	MEET CODE?
EAST (FRONT) FACADE	960 SF	68 SF	7 %		
WEST (REAR) FACADE)	985 SF	419 SF	43 %		
SOUTH FACADE	2,512 SF	~3565F	W14%		
NORTH FACADE	2,699 SF	551 SF	20 % }		
TOTALS	7,156 SF	1,394 SF	19-%	50 %	YES
TOTAL VERTICAL ELEMENTS TO BE RE	MOVED = 15%				

REMOVAL OF MORE THAN 25% OF EXTERNAL WALLS FROM FUNCTION AS EITHER EXTERNAL OR INTERNAL WALLS SEC.1005(f)3					
VERTICAL ELEMENTS	AREA (SF)	AREA REMOVED (SF)	% REMOVED	MAX PERMITTED	MEET CODE
EAST (FRONT) FACADE	960 SF	68 SF	7 %		
WEST (REAR) FACADE)	985 SF	419 SF	43 %	1	
SOUTH FACADE	2,512 SF	366 SF	114%		
NORTH FACADE	2,699 SF	551 SF	20 % }		
TOTALS	7,156 SF	1,394 SF		25 %	YES
TOTAL HORIZONTAL ELEMENTS TO	BE REMOVED = 15%				•

REMOVAL OF MORE THAN 75% OF ALL INTERNAL STRUCTURAL FRAMEWORK OR FLOOR PLATES SEC.1005(f)4					
STRUCTURAL WALL	AREA (SF)	AREA REMOVED (SF)	% REMOVED	MAX PERMITTED	MEET CODE?
FLOOR 01	500 SF	500 SF	100 %		
FLOOR 02	1,302 SF	984 SF	76 %		
FLOOR 03	1,485 SF	1337 SF	90 %		
TOTALS	3,287 SF	2,821 SF	86 %		
		1			
FLOOR AREA	AREA (SF)	AREA REMOVED (SF)	% REMOVED		
FLOOR 01 (ON GRADE)	N/A				
FLOOR 02	1,648 SF	108 SF	7 %		
FLOOR 03	1,586 SF	0 SF	0 %		
ROOF	1,875 SF	76 SF	4 %		
TOTALS	5,109 SF	184 SF	4 %		
TOTALS ALL STRUCTURAL FRAMEWOR	K/FLOOR PLATES TO	BE REMOVED = 45%		75 %	YES

THIS PROJECT IS NOT CONSIDERED AS DEMOLITION PER SAN FRANCISCO PLANNING CODE SEC. 1005(f)(1)(2)(3)(4)

DEMOLITION NOTES

- ALL DEMOLITION WORK TO COMPLY WITH SFBC CH13B CONSTRUCTION AND DEBRIS RECOVERY PROGRAM.
 DEMOLITION OTHER THAN THAT EXPLICITLY STATED AND SHOWN ON THE ARCHITECTURAL DEMO PLANS IS ILLEGAL UNDER P.C. 317 AND ANY MODIFICATIONS REQUIRE A PERMIT REVISION AND APPROVAL FROM THE SF





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INTERIOR ALTERATION


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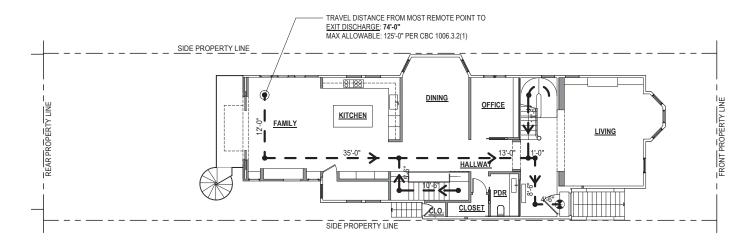
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DEMOLITION CALCULATION ELEVATIONS


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3 FLOOR 03 - EXITING PLAN SCALE: 1/8" = 1'-0"



FLOOR 02 - EXITING PLAN

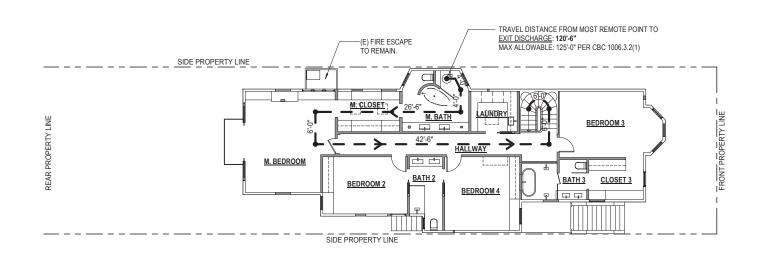

OCCUPANCY CALCULATION					
ROOM#	ROOM NAME	SF	FACTOR	OCCs	
1	GARAGE	533 SF	0 SF		
2	STOR.	45 SF	300 SF		
3	MECH	66 SF	300 SF		
4	UNIT 1 BATH	69 SF	0 SF		
5	UNIT 1 BEDROOM	149 SF	200 SF		
6	FAMILY ENTRY	70 SF	200 SF		
7	UNIT 1 LIVING	496 SF	200 SF		
8	M. BEDROOM	283 SF	200 SF		
9	FAMILY	245 SF	200 SF		
10	KITCHEN	255 SF	200 SF		
11	DINING	176 SF	200 SF		
12	OFFICE	94 SF	200 SF		
13	CLO.	10 SF	300 SF		
14	CLOSET	24 SF	300 SF		
15	PDR	40 SF	0 SF		
16	HALLWAY	251 SF	200 SF		
17	LIVING	312 SF	200 SF		
18	M. BATH	125 SF	0 SF		
19	M. CLOSET	83 SF	300 SF		
20	BEDROOM 3	208 SF	200 SF		
21	CLOSET 3	73 SF	300 SF		
22	BATH 3	82 SF	0 SF		
23	HALLWAY	206 SF	200 SF		
24	LAUNDRY	62 SF	300 SF		
25	BEDROOM 4	182 SF	200 SF		
26	BEDROOM 2	160 SF	200 SF		
27	BATH 2	72 SF	0 SF		
28	LAUNDRY	8 SF	300 SF		
29	UNIT 1 CLOSET	7 SF	300 SF		

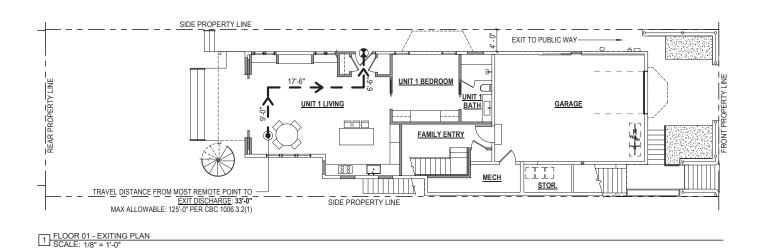4384 SF

GRAND TOTAL

EXITING ANALYSIS

EXITING SYMBOL LEGEND





EXIT TRAVEL PATH IN DIRECTION INDICATED BY ARROV

FIRE RESISTANCE RATING FOR BUILDING ELEMENTS

(PER CBC TABLE 601) FIRE-RESISTANCE RATING FOR BUILDING ELEMENTS (hours)

BUILDING ELEMENT	TYPE VA (see note d)
PRIMARY STRUCTURAL FRAME	1 HR PROTECTED
BEARING WALLS	
EXTERIOR (note f,g)	1 HR PROTECTED PER CBC 602
INTERIOR	NONRATED WHEN SPRINKLERED
NONBEARING PARTITIONS	
EXTERIOR	1 HR PROTECTED PER CBC 602
INTERIOR (note e)	NONRATED WHEN SPRINKLERED
FLOOR CONSTRUCTION	NONRATED WHEN SPRINKLERED
ROOF CONSTRUCTION	1 HR PROTECTED PER CBC

NOTES:

a. An approved automatic sprinkler system in accordance with Section 903.3.1.1 shall be allowed to be substituted for 1-hour fire-resistance-rated construction, provided such system is not otherwise required by other provisions of the code or used for an allowable area increase in accordance with Section 506.3 or an allowable height increase in accordance with Section 504.2. The 1-hour substitution for the fire resistance of exterior walls shall not be permitted.

b. Not less than the fire-resistance rating based on fire separation distance (see Table 602).

c. Not less than the fire-resistance rating as referenced in Section 704.10

PER CBC TABLE 602)
FIRE-RESISTANCE RATING REQUIREMENTS FOR EXTERIOR WALLS
BASED ON FIRE SEPARATION DISTANCE (see notes a, e)

FIRE SEPARATION	CONSTRUCTION	OCCUPANCY
DISTANCE	TYPE	GROUP R
X<5'-0"	ALL	1 HR PROTECTED



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628 SHOTWELL STREET LLC

INTERIOR ALTERATION

628 SHOTWELL STREET SAN FRANCISCO, CA 94110 BLOCK:3611 LOT:036

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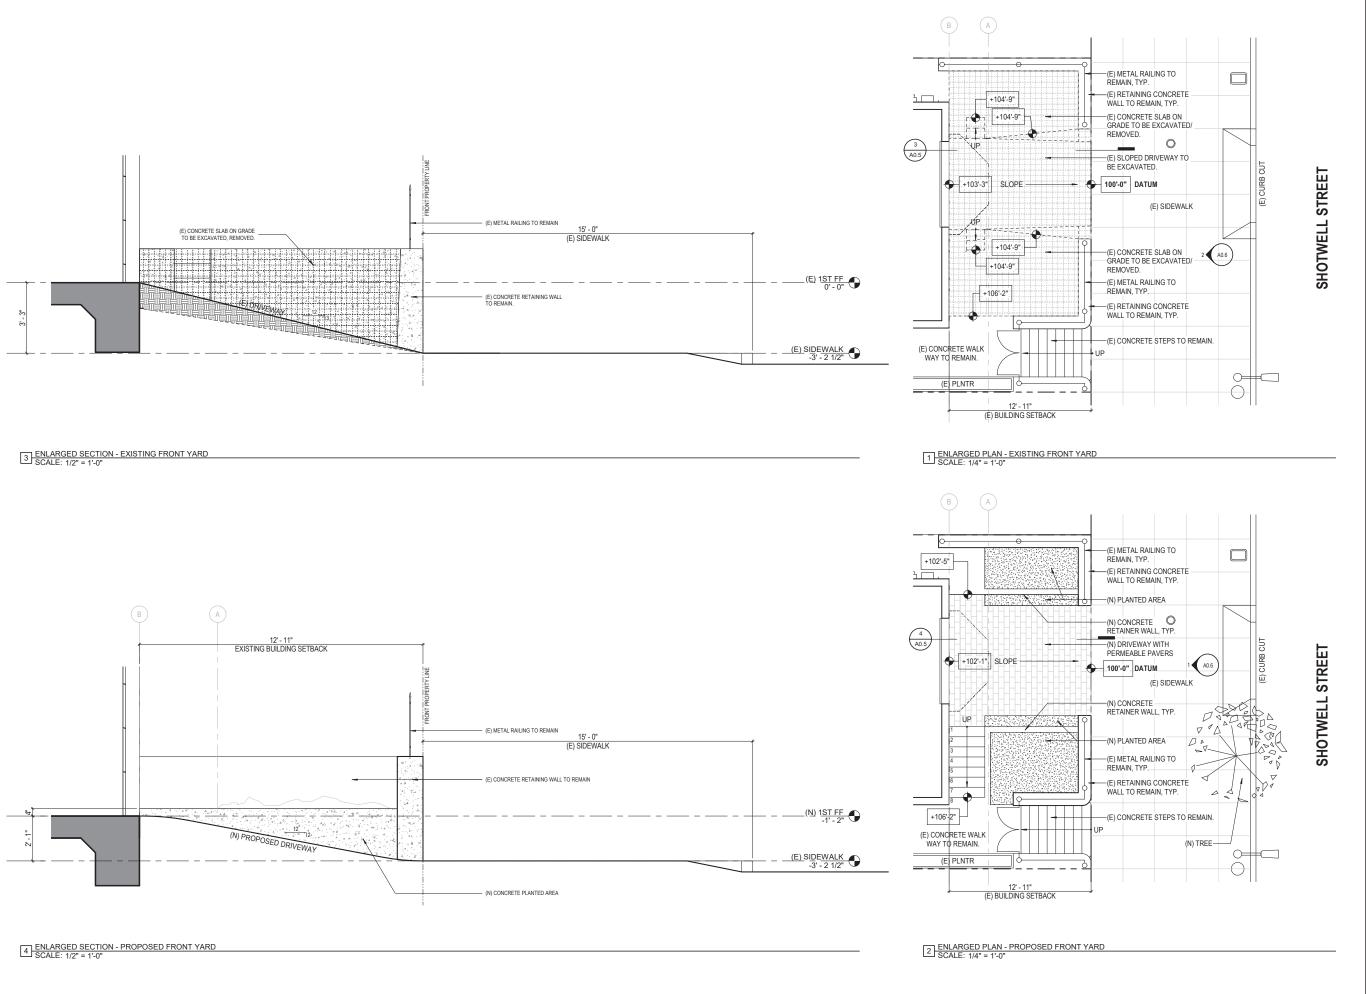
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EXITING ANALYSIS

SHEET NUMBER:

A0.4

		LIGHT / AIR REQUIRED BY CBC SEC 1205.2 & 1203.5.1								
	UNIT 1 UNIT 2									
	LIVING	BEDROOM	LIVING	OFFICE	DINING	FAMILY ROOM	M. BEDROOM	BEDROOM 2	BEDROOM 3	BEDROOM 4
AREA (SF)	496 SF	149 SF	312 SF	94 SF	192 SF	245 SF	283 SF	160 SF	208 SF	182 SF
LIGHT 8%	40 SF	12 SF	25 SF	8 SF	15 SF	20 SF	23 SF	13 SF	17 SF	15 SF
LIGHT PROV.	94 SF	32 SF	68 SF	SF	35 SF	80 SF	SF	29 SF	47 SF	17 SF
AIR 4%	20 SF	6 SF	12 SF	4 SF	8 SF	10 SF	12 SF	6 SF	8 SF	7 SF
AIR PROV.	47 SF	16 SF	34 SF	SF	18 SF	40 SF	SF	15 SF	24 SF	7 SF







628 SHOTWELL STREET LLC

INTERIOR ALTERATION

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ENLARGED FRONT YARD PLANS

SHEET NUMBER:

A0.5





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628 SHOTWELL STREET LLC

INTERIOR ALTERATION

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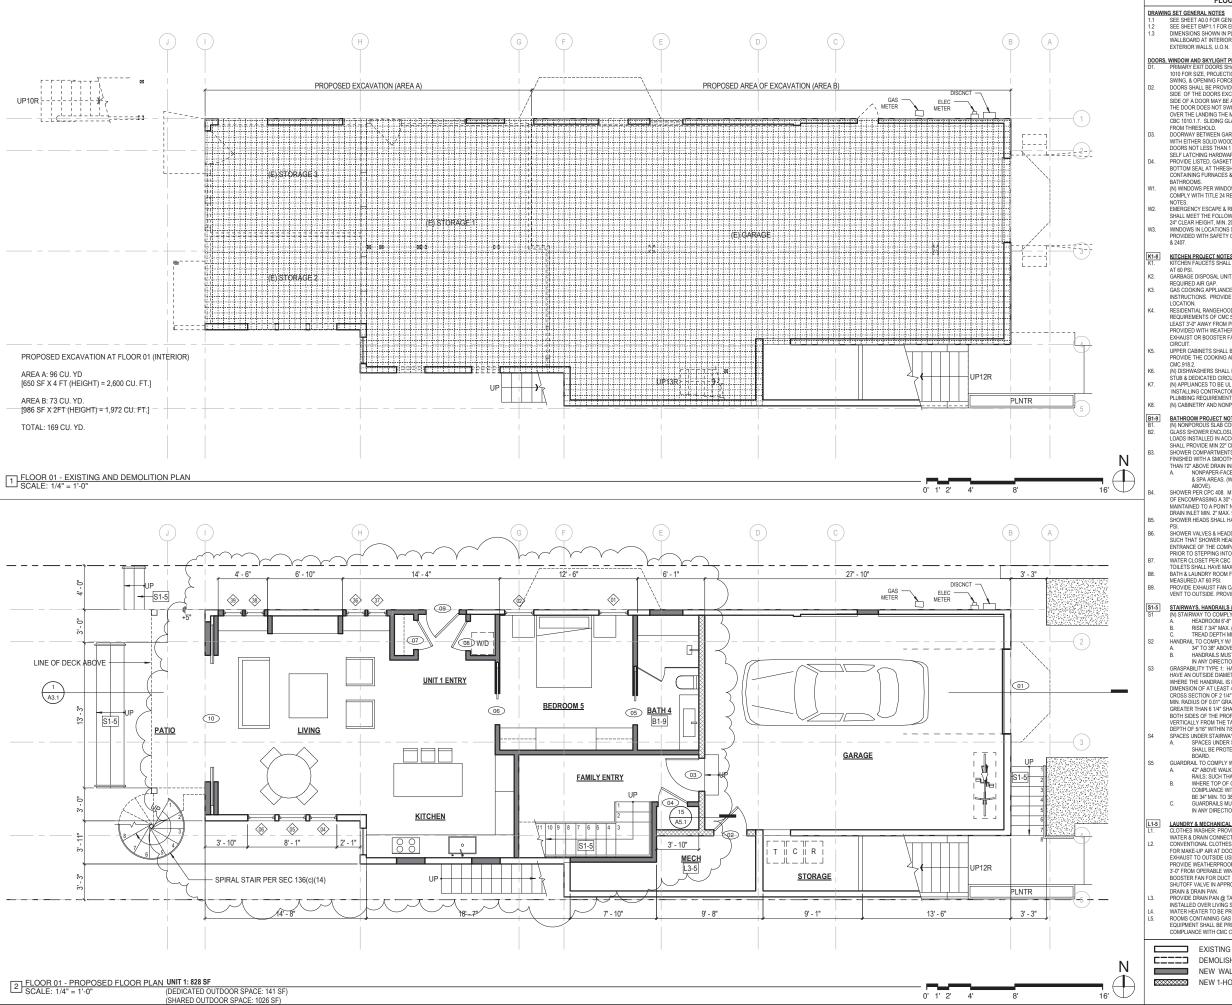
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 07.10.2

 SHEET TITLE:

EXISTING & PROPOSED STREET ELEVATION

SHEET NUMBER:

A0.6



FLOOR PLAN KEYNOTES

DORS, WINDOW AND SKYLIGHT PROJECT NOTES

D1. PRIMARY EXIT DOORS SHALL MEET THE REQUIREMENTS OF CBC SECTION 1010 FOR SIZE, PROJECTIONS INTO CLEAR WIDTH OF EGRESS PATH, DOOR SWING, A OPENING FORCE.

D2. DOORS SHALL BE PROVIDED WITH A MIN 36° X 36° LEVEL LANDING ON EACH SIDE OF THE DOORS EXCEPT AS FOLLOWS: LANDINGS AT THE EXTERIOR SIDE OF A DOOR MAY BE A MAX. OF 73 WHE ELAWN THE RESHOLD PROVIDED THE DOOR DOES NOT SWING OVER THE LANDING FOR DOORS THAT SWING OVER THE LANDING THE BEHOLD THE THE FERNING FOR DOORS THE MAX. DISTANCE BELOW THE THERSHOLD IS TOPE CRECITION 15. SUDING GLASS DOORS SHALL HAVE A MAX. 1/2" LEVEL CHANGE FROM THERSHOUND FOR THE SENIOR OF THE SENIOR SE FROM THRESHOLD.
DOORWAY BETWEEN GARAGES & HABITABLE SPACE SHALL BE PROVIDED

DOURWAY BE INEEN GARAGES & HABITABLE SYACE SHALL BE PROVIDED WITH EITHER SOLD WOOD DOORS OR SOLD OF HONEYCOME CORE STEEL DOORS NOT LESS THAN 136" THICK & PROVIDED WITH SELF CLOSING AND SELF LATCHING HARDWARE.
PROVIDE LISTED, GASKETED DOORS W LISTED SELF CLOSING DEVICE & BOTTOM SEAL AT THEESHOLD PER CMC 904.1 WHERE COMPARTMENTS CONTAINING FURNACES & BOILERS ARE INSTALLED IN BEDROOMS OR BATHROOMS.

(A) WINDOWS PER WINDOW SCHEDULE INCLUDED IN THIS DRAWING SET SHALL

COMPLY WITH TITLE 24 REQUIREMENTS. SEE SCHEDULE FOR ADDITIONAL NOTES. EMERGENCY ESCAPE & RESCUE WINDOWS REQUIRED AT SLEEPING AREAS

EMERICAENT SEASOF & RESCUE WINDOWS REQUIRED AT SLEEPING AREAS SHALL MEET THE FOLLOWING BOUNDERNETS: MIN S.7 CEAR OPENING, MIN. 24° CLEAR HEIGHT, MIN. 26° CLEAR WIDTH, SILL HEIGHT MAX. 44° AFF. WINDOWS IN LOCATIONS SUBJECT TO HUMAN IMPACT LOADS SHALL BE PROVIDED WITH SAFETY GLAZING INSTALLED IN ACCORDANCE WITH CBC 2406 & 2407.

KITCHEN PROJECT NOTES. KITCHEN FAUCETS SHALL HAVE A MAX. FLOW RATE OF 1.5 G.P.M MEASURED

REQUIRED AIR GAP.
GAS COOKING APPLIANCES SHALL BE UL LISTED & INSTALLED PER MANUF.

INSTRUCTIONS. PROVIDE GAS SHUT-OFF VALVE IN APPROVED. ACCESSIBLE

LOCATION

RESIDENTIA RANGEHOOD ESHALUST PER CIMC 403.7 SHALL INEET
REQUIREMENTS OF CMC 503.2 EXHALUST TERMINATION SHALL BE LOCATE DAT
REQUIREMENTS OF CMC 503.2 EXHALUST TERMINATION SHALL BE LOCATE DAT
LEAST 3-0" AMAY FROM PROPERTY LINES AND BUILDING OPENINGS & BE
PROVIDED WITH WEATHERPROOF BACKDRAFT DAMPER. WHERE REMOTE
EXHALLST OR BOOSTER FANS ARE REQUIRED, FAN SHALL BE ON DEDICATED
CIRCUIT.
UPPER CABINETS SHALL BE MIN. 30" ABOVE COOKING TOP PER CMC 921.3.2.
PROVIDE THE COOKING APPLIANCE MIN. CLEARANCE TO COMBUSTIBLES PER
CMC 918.2.

CMC.918.2.
(N) DISHWASHERS SHALL BE PROVIDED WITH REQUIRED AIRGAP, HOT WATER

STUB & DEDICATED CIRCUIT. (N) APPLIANCES TO BE UL LISTED AND INSTALLED PER MANUF. INSTRUCTIONS INSTALLING CONTRACTOR SHALL COORDINATE ALL ELECTRICAL AND

PLUMBING REQUIREMENTS WITH MANUF. SPECIFICATIONS.
(N) CABINETRY AND NONPOROUS COUNTERTOPS THROUGHOUT, U.O.N.

BATHROOM PROJECT NOTES
(N) NONPOROUS SLAB COUNTERTOP & SPLASH.

GLASS SHOWER ENCLOSURES SAFTY GLAZING SUBJECT TO HUMAN IMPACT
LOADS INSTALLED IN ACCORDANCE W/ CBC 2406 & 2407. SHOWER DOORS

SHALL PROVIDE MIN 22" CLEAR OPENING WIDTH, PER CPC 408.5.

HOWER COMPARTIMENTS & WAILS ABOVE TUBS W/SHOWERHEADS SHALL BE
FINISHED WITH A SMOOTH NONABSORBENT SURFACE TO A HEIGHT NOT LESS

THAN 72" ABOVE DRAIN INLET. CBC 1210.2.3

A. NONPAPER-FACED BACKER BOARD TO BE USED IN ALL TUB, SHOWER & SPA AREAS. (WATER-RESISTANT TO A HEIGHT AS INDICATED

A SYA ARCAS, (WATEN-RESISTANT TO A HEIGHT AS INDICATED A SHOWER PICE, 408. MIN FLOOR AREA OF 1024 SQUARE INCHES & CAPABLE OF ENCOMPASSING A 30° CIRCLE. THE AREA & DIMENSION SHALL BE MAINTAINED TO A FOINT NOT LESS THAN 70° ABOVE THE SHOWER DRAIN. DBAIN INLET MIX 2° MAX. 9° BELOW THESFALD INTO SHOWER. SHOWER HEADS SHALL HAVE A MAX. FLOW RATE OF 2.0 GPM MEASURED AT 80 PSM.

SHOWER VALVES & HEADS SHALL BE PLACED INSIDE SHOWER COMPARTMENT

SHOWER VALVES & RICAUS STALLE BE PLACED INSIDE SHOWER COMPARTMENT SUCH THAT SHOWER HEAD DOES NOT DISCHARGE DIRECTLY TOWARD THE ENTRANCE OF THE COMPARTMENT AND THE BATHER CAN ADJUST VALVES PRIOR TO STEPPING INTO SHOWER SPRAY. PHIGH IO STEPPING INTO SHOWER SPRAY.

WATER CLOSET PER CBC 2509 CENTERED WITHIN 30" WIDE CLEAR SPACE.

TOILETS SHALL HAVE MAX. 128 GPF WATER CONSUMPTION.

BATH & LAUNDRY ROOM FAUCETS SHALL HAVE A MAX. FLOW RATE OF 1.5 GPM

MEASURPEN AT OR DEL

MEASURED AT 60 PSI.
PROVIDE EXHAUST FAN CAPABLE OF PROVIDING 5 AIR CHANGES PER HOUR.
VENT TO OUTSIDE. PROVIDE BACKDRAFT DAMPER

STAIRWAYS, HANDRAILS & GUARDRAILS PROJECT NOTES (N) STAIRWAY TO COMPLY W/ CBC SECTION 1011: A. HEADROOM 6'-8" MIN. B. RISE 7'34" MAX. (RISER VARIATION 3/8" MAX.)

B. RISE 7 34" MMX, (RISER VARIATION 38" MAX)
C. TREAD DEPTH MIN. 10" MOSE TO MOSE 8 MIDTH: 3-0" MIN.
HANDRAIL TO COMPLY WI CBC SECTION 1014:
A. 34" TO 30" ABOVE TREAD NOSING: 112" MIN. CLEAR FROM WALL
B. HANDRAILS MUST WITHSTAND A LOAD OF AT LEAST 200LBS APPLIED
IN ANY DIRECTION AT ANY POINT ON THE RAIL PER CBC 160" A8. 11.
GRASSPABILITY TYPE: 1. HANDRAILS WITH CIRCULAR CROSS SECTION SHALL
HAVE AN OUTSIDE DIAMPETER OF AT LEAST 1" 14" AND NOT GREATER THAN 2".
WHERE THE HANDRAIL IS NOT CIRCULAR, IT SHALL HAVE A PERIMETER
DIMENSION OF AT LEAST 4" MND NOT GREATER THAN 6" 14" WITH A MAX
CROSS SECTION OF 2 14" & MIN. CROSS SECTION OF 1". EDGES SHALL HAVE A
MIN. RADIUS OF 01" GRASSPABILITY TYPE 2. HANDRAILS WITH A PERIMETER
GREATER THAN 6 14" SHALL PROVIDE A GRASSPABLE FINGER RECESS AREA ON
BOTH SIDES OF THE PROPIETE BEGINNING AD ISTANCE OF 34" MEASURED

GREATER THAN 6 14" SHALL PROVIDE A GRASPABLE FINGER RECESS AREA NO BOTH SIDES OF THE PROFILE BEGINNING A DISTANCE OF 34" MEASURED VERTICALLY PROVIDE A GRASPABLE FINGER RECESS AREA NO BOTH SIDES OF THE PROFILE AND A CHEVES A DEPTH OF 510" WITHIN 18" BELOW THE WIDES' PORTION OF THE PROFILE.

SPACES UNDER STAIRWAYS WITHIN SIDELE FAMILY RESIDENCE SHALL BE PROTECTED TO THE ENCLOSED SIDE WITH MIN. 50" GYP. BOARD.

GUARDRAIL TO COMPLY WI CBC SECTION 1015:

A. 42" ABOVE WALKING SURFACE. MAXIMUM SPACING OF INTERMEDIATE RAILS. SUCH THAT A "SPHERE SHALL NOT PASS BETWEEN RAILS.

B. WHERE TOP OF GUARDRAIL ALSO SERVES AS STARE HANDRAIL IN COMPLIANCE WITH CEE (1014, HEIGHT OF GUARDRAIL PREMITTED TO BE 34" MIN. TO 36" MAX. ABOVE TREAD NOSING.

GUARDRAILS MIST WITHSTAND A LOAD OF AT LEAST 200LBS APPLIED IN ANY DIRECTION AT ANY POINT ON THE RAIL PER CBC 1607.8.1.1.

LAUNDRY & MECHANICAL ROOM PROJECT NOTES
CI OTHES WASHER: PROVIDE FLUSH MOUNT 'GUY BOX' FOR HOT & COLD

LAUDINIT & BELFARILLE ROUM PROTECT NO IES

COTHES WASHER PROVIDE TUSH MOUNT GUY BOX' FOR HOT & COLD

WATER & DRAIN CONNECTIONS.

CONVENTIONAL COTHES DRYFER PROVIDE OPENING OF 100 SQ. INCHES MIN.

FOR MAKE-UP AIR AT DOORS ENLOSING APPLIANCE PER CMC 504.1. DIRECT

PRAUDIT TO UTSIDE USING STEEL, SMOOTH BOKE, 4*MM. DIA. DIVET TIM.

PROVIDE WEATHERPROOF CAP & BACKORAET DAMPER. TERMINATE VENT MIN.

3.7 FROM OPERABLE WINDOWS & DOORS PER CMC 502.2 PROVIDE IN-LIME BOOSTER FAN FOR DUCT RUNS OVER 14'-0" IN LENGTH. PROVIDE GAS SHUTOFF VALVE IN APPROVED LOCATION. CONDENSING DRYERS TO HAVE

DRAIN & DRAIN PAN. PROVIDE DRAIN PAN @ TANK WATER HEATERS AND CLOTHES WASHERS

INSTALLED OVER LIVING SPACE.

WATER HEATER TO BE PROVIDED WITH SEISMIC STRAPPING PER CPC 507.2 ROOMS CONTAINING GAS CONSUMING SPACE AND WATER HEATING COMPLIANT SHALL BE PROVIDED WITH OMBUSTION AIR OPENINGS IN COMPLIANCE WITH HOW CHAPTER 7.

NEW WALL NEW 1-HOUR RATED WALL

EXISTING WALL DEMOLISHED WALL





628 SHOTWELL STREET LLC

INTERIOR **ALTERATION**

628 SHOTWELL STREET SAN FRANCISCO, CA 94110 BLOCK:3611 LOT:036

09.09.19

PROJECT REVIEW


ISSUE FOR PERMIT

PLAN CHECK #1	03.13.20
REVISION 01	07.10.20

RAWN BY:	T
ATE:	07.10.2
HEET TITLE:	

EXISTING & PROPOSED FLOOR 01

SHEET NUMBER:

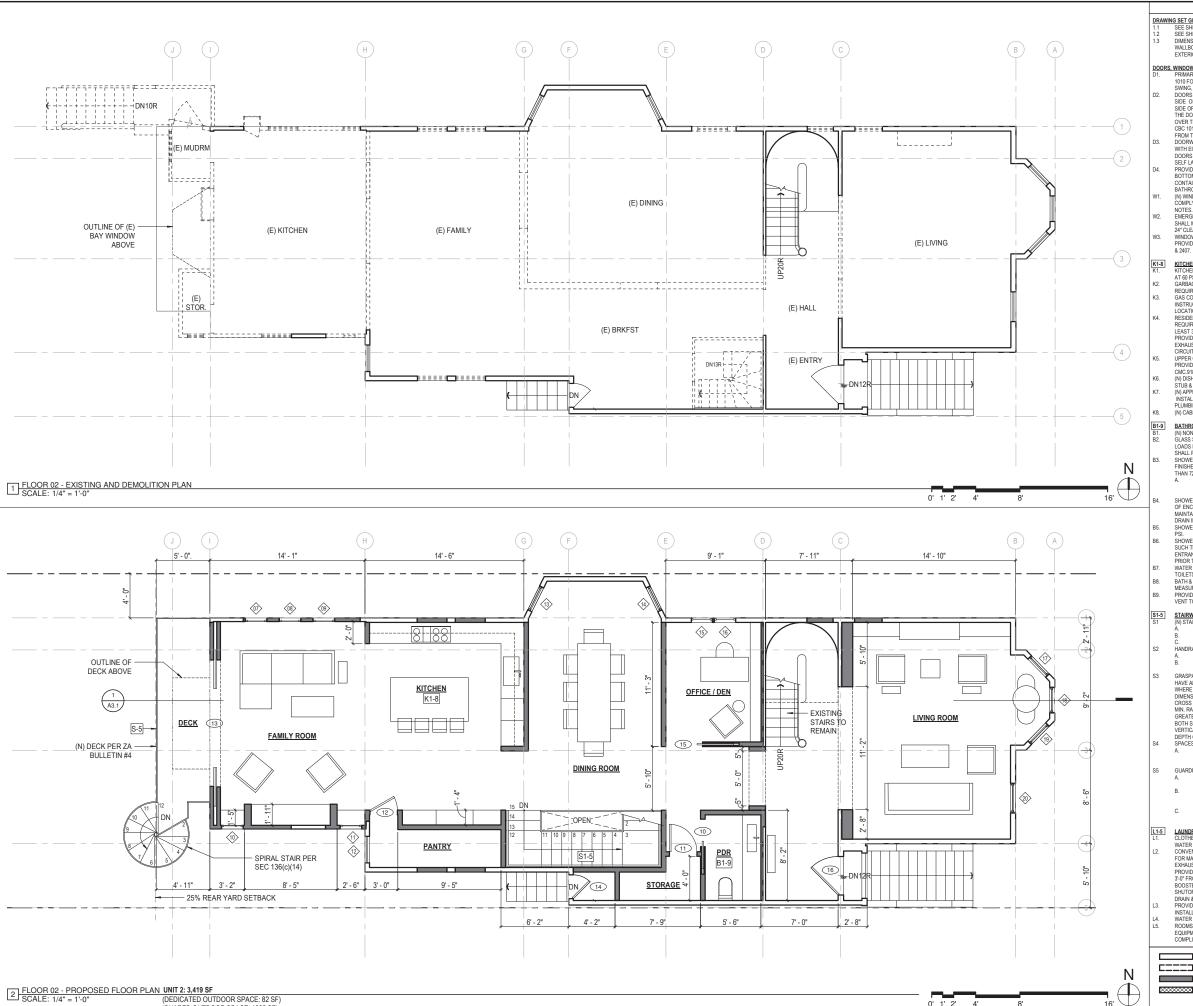

(DEDICATED OUTDOOR SPACE: 82 SF) (SHARED OUTDOOR SPACE: 1026 SF)

FLOOR PLAN KEYNOTES

DRAWING SET GENERAL NOTES
1.1 SEE SHEET AND FOR CENERAL CONSTRUCTION NOTES
1.2 SEE SHEET AND 1-FOR CENERAL CONSTRUCTION NOTES & PLANS
1.3 DIMENSIONS SHOWN IN PLANS AND ELEVATIONS ARE TAKEN FROM FACE OF
WALLBOARD AT INTERFOR WALLS AND FACE OF EXTERIOR FINISH AT

EXTERIOR WALLS, U.O.N.

DORS, WINDOW AND SKYLGHT PROJECT NOTES
D1. PRIMARY EXIT DOORS SHALL MEET THE REQUIREMENTS OF CBC SECTION
1016 FOR SIZE, PROJECTIONS INTO CLEAR WIDTH OF EGRESS PATH, DOOR
SWING, & OPENING FORCE
D2. DOORS SHALL BE PROVIDED WITH A MIN. 36" X 36" LEVEL LANDING ON EACH
SIDE OF THE DOORS EXCEPT AS FOLLOWS. LANDINGS AT THE EXTERIOR
SIDE OF 6 DOORS MAY BE AND. COT 34" BELOW THE THERSHOLD PROVIDED
THE DOOR DOES NOT SWING OVER THE LANDING, FOR DOORS THAT SWING
OVER THE LANDING THE MAX. DISTANCE BELOW THE THRESHOLD ROUNCE
EDON LITERSHOLD.

FROM THRESHOLD.
DOORWAY BETWEEN GARAGES & HABITABLE SPACE SHALL BE PROVIDED DOORWAY BETWEEN GARAGES & HABITABLE SPACE SHALL BE PROVIDED WITH EITHER SOLID WOOD DOORS OR SOLID ON HONEYCOMB CORE STEEL DOORS NOT LESS THAN 1 38" THICK & PROVIDED WITH SELF CLOSING AND SELF LATCHING HARDWARE. PROVIDE LISTED, GASKETED DOORS WI LISTED SELF CLOSING EVEN BOTTOM SEAL AT THRESHOLD PER CNC 904 1 WHERE COMPARTMENT CONTAINING FURNACES & BOILERS ARE INSTALLED IN BEDROOMS OR BATHROOMS.

(N) WINDOWS PER WINDOW SCHEDULE INCLUDED IN THIS DRAWING SET SHAL COMPLY WITH TITLE 24 REQUIREMENTS. SEE SCHEDULE FOR ADDITIONAL EMERGENCY ESCAPE & RESCUE WINDOWS REQUIRED AT SLEEPING AREAS

EMERGENCI SEASOF A RESOLUCION REGUNERA DI ASCEPTION ANNO SPALL MEET THE FOLLOWING SOUDIEMENTS MIN S.7 CLEAR OPENING, MIN 24* CLEAR HEIGHT, MIN. 20* CLEAR WIDTH, SILL HEIGHT MAY. 44* AFF. WINDOWS IN LOCATIONS SUBJECT TO HUMAN IMPACT LOADS SHALL BE PROVIDED WITH SAFETY GLAZING INSTALLED IN ACCORDANCE WITH CBC 2406 & 2407.

KITCHEN PROJECT NOTES KITCHEN FAUCETS SHALL HAVE A MAX. FLOW RATE OF 1.5 G.P.M MEASURED AT 60 PSI.

GARBAGE DISPOSAL UNITS AT KITCHEN SINKS SHALL BE PROVIDED WITH

REQUIRED AIR GAP.
GAS COOKING APPLIANCES SHALL BE UL LISTED & INSTALLED PER MANUF.

INSTRUCTIONS. PROVIDE GAS SHUT-OFF VALVE IN APPROVED, ACCESSIBLE

LOCATION.

RESIDENTIAL RANGEHOOD EXHAUST PER CMA 47. SHALL MEET
REQUIREMENTS OF CMC 504.2 EXHAUST TERMINATION SHALL BE LOCATED A1
LEAST 3-0" AWAY FROM PROPERTY LINES AND BUILDING OPENINGS & BE
PROVIDED WITH WEATHERPROOF BACKDRAFT DOMMER. WHERE REMOTE
EXHAUST OR BOOSTER FANS ARE REQUIRED, FAN SHALL BE ON DEDICATED
CIRCUIT.

UPPER CABINETS SHALL BE MIN. 30" ABOVE COOKING TOP PER CMC 921.3.2. PROVIDE THE COOKING APPLIANCE MIN. CLEARANCE TO COMBUSTIBLES PER

CMC.918.2.
(N) DISHWASHERS SHALL BE PROVIDED WITH REQUIRED AIRGAP, HOT WATER STUB & DEDICATED CIRCUIT.
(N) APPLIANCES TO BE UL LISTED AND INSTALLED PER MANUF. INSTRUCTIONS.

INSTALLING CONTRACTOR SHALL COORDINATE ALL ELECTRICAL AND PLUMBING REQUIREMENTS WITH MANUF. SPECIFICATIONS.
(N) CABINETRY AND NONPOROUS COUNTERTOPS THROUGHOUT, U.O.N.

BATHROOM PROJECT NOTES
(N) NONPOROUS SLAB COUNTERTOP & SPLASH.
GLASS SHOWER RENCLOSURES SAFETY GLAZING SUBJECT TO HUMAN IMPACT
LOADS INSTALLED IN ACCORDANCE W/ GBC 2406 & 2407. SHOWER DOORS
SHALL PROVIDE MIN 27 CLEAR OPENING WIDTH, PER CP C408.5

SHALL PROVIDE INIT 2 CLEAR UPENING WIDTH, PER UP 43.85.

SHOWER COUPARTIMENTS A WALL ABOVE TUSE W SHOWERHEADS SHALL BE FINISHED WITH A SMOOTH NONASORBENT SURFACE TO A HEIGHT NOT LESS THAN 72 ABOVE DRAIN INET. GB (210.23

A. NOMPAPER-FACED BACKER BOAND TO BE USED IN ALL TUB. SHOWER & SOAR AREAS, (WATER RESISTANT TO A HEIGHT AS INDICATED.

A SYPA ARCAS, (WALEN-RESISTANT TO A FIELDH TAS INJUICATED A SAFON ARCAS, (WALEN-CO. 108. MIN FLOOR AREA OF 1024 SOUARE INCHES & CAPABLE OF ENCOMPASSING A 30° CIRCLE. THE AREA & DIMENSION SHALL BE MAINTAINED TO A POINT NOT LESS THAN 70° ABOVE THE SHOWER DRAIN. DETAIN LET MIX 2° MAX. 9° BELOW THES SHOWER DRAIN. SHOWER HEADS SHALL HAVE A MAX. FLOW RATE OF 2.0 GPM MEASURED AT 80 PSI.

. O... SHOWER VALVES & HEADS SHALL BE PLACED INSIDE SHOWER COMPARTMENT

SHOWER VALVES A HEADS SHALL BE PLACED INSIDE SHOWER COMPARTMENT SUCH THAT SHOWER HEAD DOES NOT DISCHARGE DIRECTLY TOWARD THE ENTRANCE OF THE COMPARTMENT AND THE BATHER CAN ADJUST VALVES PRIOR TO STEPPING INTO SHOWER SPRAY.

WATER CLOSET PER CBC 299 CENTERED WITHIN 30" WIDE CLEAR SPACE. TOILETS SHALL HAVE MAX. 1.28 GPF WATER CONSUMPTION. BATH & LAUNDENT ROOM FAUCETS SHALL HAVE MAX. FLOW RATE OF 1.5 GPM MEASURED AT 60 PSI.

PROVIDE EXHAUST FAN CAPABLE OF PROVIDING 5 AIR CHANGES PER HOUR VENT TO OUTSIDE. PROVIDE BACKDRAFT DAMPER.

STAIRWAYS, HANDRAILS & GUARDRAILS PROJECT NOTES (N) STAIRWAY TO COMPLY W/ CBC SECTION 1011:

STARRWATS, HANDRAILS & GUARRORALIS PROJECT NO TES

(N) STARRWAY TO COMPLY WIGE SECTION 1011:

A. HEADROOM 6-8" MIN.
B. RISE 7 34" MAX. (RISER VARIATION 3/8" MAX)
C. TREAD DEPTH MIN. 10" NOSE TO NOSE & WIDTH: 3".0" MIN.
HANDRAIL TO COMPLY WIGE SECTION 1014:
A. 34" TO 38" ABOVE TREAD NOSING. 11/2" MIN. CLEAR FROM WALL
B. HANDRAILS MUST WITHTSTAND A LOAD OF AT LEAST 200. RS APPLIED
IN ANY DIRECTION AT ANY POINT ON THE RAIL PER CBC 1607.8.1.1
GRASPABLITY TYPE: HANDRAILS WITH CREULAR GROSS SECTION 5HALL
HAVE AN OUTSIDE DIAMETER OF AT LEAST 1 1/4" AND NOT GREATER THAN 2".
WHERE THE HANDRAIL IS NOT GREATER THAN 6 14" WITH A MAX.
CROSS SECTION OF AT LEAST 4" AND NOT GREATER THAN 6 14" SHALL HAVE A
MIN. RADIUS OF 0.0" GRASPABLITY IYPE 2: HANDRAILS WITH A PERMITTER
GREATER THAN 6 14" SHALL PROVIDE A GRASPABLE FINGER RECESS AREA ON
BOTH SIDES OF THE PROFILE BEGINNING A DISTANCE OF 34" MEASURED

GREATER THAN 6 11" SYMLL PROVIDE A GRASPABLE FINGER RECESS AREA ON BOTH SIDES OF THE PROFILE BEGINNING A DISTANCE OF 34" MEASURED DETRICALLY FROM THE TALLEST PORTION OF THE PROFILE AND ACHEVES A DEPTH OF 51" STIMM TO BE GLOW THE WIDEST PORTION OF THE PROFILE. SPACES UNDER STAIRWAYS WITHIN SINGLE FAMILY RESIDENCE SHALE PROFILE TO THE FINGE TO STAIRWAYS WITHIN SINGLE FAMILY RESIDENCE SHALE PROFILE TO ON THE FINCE SED SIDE WITH MIN. 50" GYP. BOARD.

GUARDRAL TO COMPLY WI GBC SECTION 1015:
A. 42" ABOVE WALKING SURFACE MAXIMUM SPACING OF INTERMEDIATE RAILS. SUCH THAT A "SPHEKE SHALL NOT PASS BETWEEN RAILS.
B. WHERE TOP OF GUARDRALL ALSO SERVES AS STAIR HANDRALL IN COMPLANCE WITH CASE (14). HE HEIGHT OF GUARDRAL PREMITTED TO BE 3" MIN. TO 38" MAX. ABOVE TREAD NOSING.
G. GUARDRALS MUST WITHSTAND A LOAD OF AT LEAST 200LBS APPLIED IN ANY DIRECTION AT ANY POINT ON THE RAIL PER CBC 1607.8.1.1.

LAUNDRY & MECHANICAL ROOM PROJECT NOTES OF OFFICE MARCHED- PROVIDE FLUSH MOUNT 'GUY BOX' FOR HOT & COLD

CLOTHES WASHER, PROVIDE FLUSH MOUNT GLIY BOX: FOR HOT & COLD WATER & RORM CONNECTIONS WATER & RORM CONNECTIONS. CONVENTIONAL CLOTHES DRIVER, PROVIDE OPENING OF 100 SO, INCHES MIN. FOR MAKE-UP AIR AT DOORS ENCLOSING APPLIANCE PER CMC 504.4.1. DIRECT EXHAUST TO OUTSIDE LISING STEEL, SMOOTH BORE, 4"MIN, DIA DUCT. PROVIDE WEATHERPROOF CAP & BACKDRAFT DAMPER, TERMINATE VEH, 23.4"FROM DEFRABLE WINDOWS & DOORS PER CMC 502.2. PROVIDE IN-LINE BOOSTER FAN FOR DUCT RUNS OVER 14'-0" IN LENGTH. PROVIDE GAS SHUTOFF VALVE IN APPROVED LOCATION. CONDENSING DRYERS TO HAVE

SHI JOFF VALUE IN APPROVED LOCATION. CONDENSING DIFFERS TO HAVE PROVIDE DRAIN PAN (EARLY MATER HEATERS AND CLOTHES WASHESS INSTALLED DVICE LIVING SPACE: WATER HEATERS AND CLOTHES WASHESS WATER HEATER TO BE PROVIDED WITH SEISMIC STRAPPING PER OPC 507.2 ROOMS CONTAINING GAS CONSUMING SPACE AND WATER HEATING EQUIPMENT SHALL BE PROVIDED WITH COMBUSTION AIR OPENINGS IN COMPLIANCE WITH CMC CHAPTER?

EXISTING WALL NEW WALL

DEMOLISHED WALL

NEW 1-HOUR RATED WALL





628 SHOTWELL STREET LLC

INTERIOR **ALTERATION**


628 SHOTWELL STREET SAN FRANCISCO, CA 94110 BLOCK:3611 LOT:036

PROJECT REVIEW	09.09.19
ISSUE FOR PERMIT	11.13.19
PLAN CHECK #1	03.13.20
REVISION 01	07.10.20

DRAWN BY:	TL
DATE:	07.10.20
SHEET TITLE:	

EXISTING & PROPOSED FLOOR 02

SHEET NUMBER:

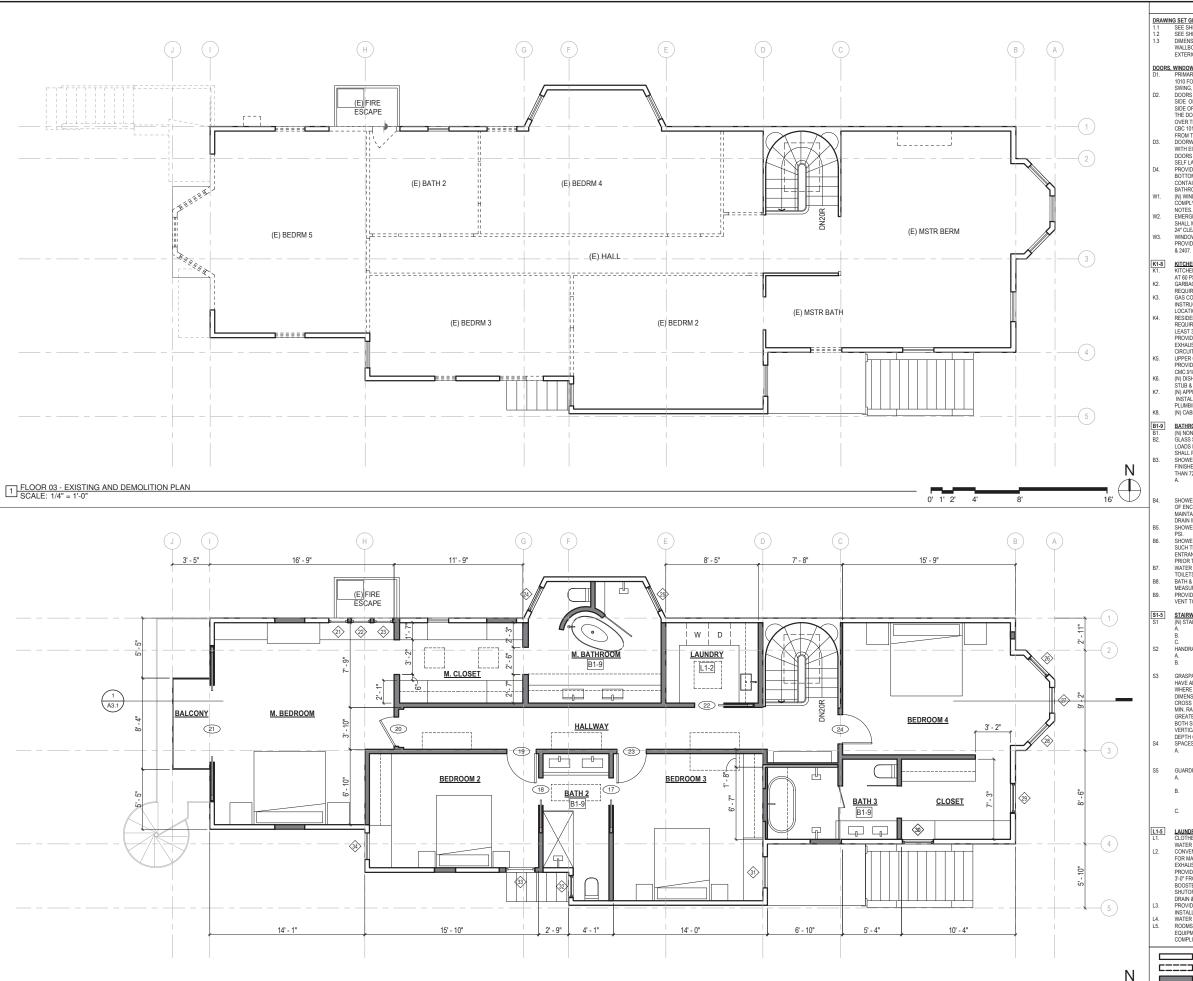

[2] FLOOR 03 - PROPOSED FLOOR PLAN UNIT 2: 3,419 SF SCALE: 1/4" = 1'-0" (DEDICATED OUT

(DEDICATED OUTDOOR SPACE: 28 SF)

FLOOR PLAN KEYNOTES

DRAWING SET GENERAL NOTES

1.1 SEE SHEET A0.0 FOR GENERAL CONSTRUCTION NOTES
1.2 SEE SHEET EMP1.1 FOR ELECTRICAL & MECHANICAL NOTES & PLANS DIMENSIONS SHOWN IN PLANS AND ELEVATIONS ARE TAKEN FROM FACE OF WALLBOARD AT INTERIOR WALLS AND FACE OF EXTERIOR FINISH AT EXTERIOR WALLS, U.O.N.

DORS, WINDOW AND SKYLIGHT PROJECT NOTES
D1. PRIMARY EXIT DOORS SHALL MEET THE REQUIREMENTS OF CBC SECTION 1010 FOR SIZE, PROJECTIONS NTO CLEAR WIDTH OF EGRESS PATH, DOOR SWING, & OPENING FORCE.
D2. DOORS SHALL BE PROVIDED WITH A MIN 36" X 36" LEVEL LANDING ON EACH SIDE OF THE DOORS EXCEPT AS FOLLOWS: LANDINGS AT THE EXTERIOR SIDE OF A DOOR IMAY BE A MAX. OF 7 34" BELOW THE THRESHOLD PROVIDED THE DOOR DOES NOT SWINGO OVER THE LANDING, FOR DOORS THAT SWING OVER THE LANDING THE MAX. DISTANCE BELOW THE THRESHOLD IS 1/2" PER CBC 1010.1.7. SLIDING GLASS DOORS SHALL HAVE A MAX. 1/2" LEVEL CHANGE

CBC 1010.1.7. SLIDING GLASS DOORS SHALL HAVE A MAX. 1/2" LEVEL CHANG FROM THRESHOLD DOORWAY BETWEEN GARAGES & HABITABLE SPACE SHALL BE PROVIDED WITH EITHER SOLID WOOD DOORS OR SOLID OR HONEYCOMB CORE STEEL DOORS NOT LESS THAN 1 38" THICK & PROVIDED WITH SELF CLOSING AND SELF LATCHING HARDWARE.
PROVIDE LISTED, GASKETED DOORS WI LISTED SELF CLOSING DEVICE & BOTTOM SEAL AT THRESHOLD PER CIMO 90.4 TWHERE COMPARTMENTS CONTAINING FURNACES & BOILERS ARE INSTALLED IN BEDROOMS OR BATHROOMS.

(IN) WINDOWS PER WINDOW SCHEDULE INCLUDED IN THIS DRAWING SET SHAL COMPLY WITH TITLE 24 REQUIREMENTS. SEE SCHEDULE FOR ADDITIONAL EMERGENCY ESCAPE & RESCUE WINDOWS REQUIRED AT SLEEPING AREAS

EMERGENE, TESSAFE A RESOUR WINDOWS REQUIRED A SECPRISO ANDES.

24" CLEAR HEIGHT HIE FOLLOWING SEQUIREMENTS MIN S.7" CLEAR OPENING, MIN.

24" CLEAR HEIGHT, MIN. 20" CLEAR WIDTH, SILL HEIGHT MAX. 44" AFF.

WINDOWS IN LOCATIONS SUBJECT TO HUMAN IMPACT LOADS SHALL BE
PROVIDED WITH SAFETY GLAZING INSTALLED IN ACCORDANCE WITH CBC 2406

& 2407.

KITCHEN PROJECT NOTES KITCHEN FAUCETS SHALL HAVE A MAX. FLOW RATE OF 1.5 G.P.M MEASURED

AT 60 PSI.

GARBAGE DISPOSAL UNITS AT KITCHEN SINKS SHALL BE PROVIDED WITH REQUIRED AIR GAP.
GAS COOKING APPLIANCES SHALL BE ULLISTED & INSTALLED PER MANUF.

INSTRUCTIONS. PROVIDE GAS SHUT-OFF VALVE IN APPROVED, ACCESSIBLE

LOCATION.

RESIDENTIAL RANGEHOOD. EXHAUST PER CMC 403.7. SHALL MEET
REQUIREMENTS OF CMC 504.2 EXHAUST TERMINATION SHALL BE LOCATED AT
LEAST 3:0° AWAY FROM PROPERTY LINES AND BUILDING OPENINGS & BE
PROVIDED WITH WEATHER/PROOF BACKDRAFT DAMPER. WHERE REMOTE
EXHAUST OR BOOSTER FANS ARE REQUIRED, FAN SHALL BE ON DEDICATED
CIRCUIT. UPPER CABINETS SHALL BE MIN. 30" ABOVE COOKING TOP PER CMC 921.3.2.
PROVIDE THE COOKING APPLIANCE MIN. CLEARANCE TO COMBUSTIBLES PER

CMC.918.2.
(N) DISHWASHERS SHALL BE PROVIDED WITH REQUIRED AIRGAP, HOT WATER

STUB & DEDICATED CIRCUIT.
(N) APPLIANCES TO BE UL LISTED AND INSTALLED PER MANUF. INSTRUCTIONS. INSTALLING CONTRACTOR SHALL COORDINATE ALL ELECTRICAL AND PLUMBING REQUIREMENTS WITH MANUF. SPECIFICATIONS.
(N) CABINETRY AND NONPOROUS COUNTERTOPS THROUGHOUT, U.O.N.

BATHROOM PROJECT NOTES
(N) NONPOROUS SLAB COUNTERTOP & SPLASH.
GLASS SHOWER RENCLOSURES SAFETY GLAZING SUBJECT TO HUMAN IMPACT
LOADS INSTALLED IN ACCORDANCE W/ GBC 2406 & 2407. SHOWER DOORS
SHALL PROVIDE MIN 22" CLEAR OPENING WIDTH, PER CPC 408. 5 SHALL PROVINE MIN ZZ ULEAN UPENING WIDH I, PEN CH-3 48.5. SHOWER COMPARTIMENTS & WALLS ABOUT EURS WS SHOWERHEADS SHALL BE FINISHED WITH A SMOOTH NONASSORBENT SURFACE TO A HEIGHT NOT LESS THAN 7Z ABOUT DRAIN INLET. GOO CT1012.3

A MOMPAPER-ACED BACKER BOARD TO BE USED IN ALL TUB. SHOWER & SARAES, (WINTER-RESISTANT TO A HEIGHT AS INDICATED.

& SYM AWCHS, (WAITEN-RESISTANT TO A REIGHT AS INJUGATED ASAMEDA, ABOVE).

ABOVE).

ABOVE).

OF ENCOMPASSING A 30° CIRCLE. THE AREA & DIMENSION SHALL BE MAINTAINED TO A POINT NOT LESS THAN 70° ABOVE THE SHOWER DRAIN. DRAIN INLET MIX "ZHMX," SHE DUT WHESFEND INTO SHOWER.

SHOWER HEADS SHALL HAVE A MAX. FLOW RATE OF 2.0 GPM MEASURED AT 80 PSI.

SHOWER VALVES & HEADS SHALL BE PLACED INSIDE SHOWER COMPARTMENT

SHOWER VALVES & HEADS SHALL BE PLACED INSIDE SHOWER COMPARTMENT SUCH THAT SHOWER HEAD DOES NOT DISCHARGE DIRECTLY TOWARD THE ENTRANCE OF THE COMPARTMENT AND THE BATHER CAN ADJUST VALVES PRIOR TO STEPPING INTO SHOWER SPRAY.

WATER CLOSET PER GBC 2690 CENTERED WITHIN 30' WIDE CLEAR SPACE. TOILETS SHALL HAVE MAX. 1.28 GPF WATER CONSUMPTION. BATH & LAUNDRY ROOM FAUCTES SHALL HAVE A MAX. FLOW RATE OF 1.5 GPM. MEASURED AT 60 PSI.

PROVIDE EXHAUST FAN CAPABLE OF PROVIDING 5 AIR CHANGES PER HOUR. VENT TO OUTSIDE. PROVIDE BACKDRAFT DAMPER

STAIRWAYS, HANDRAILS & GUARDRAILS PROJECT NOTES (N) STAIRWAY TO COMPLY W/ CBC SECTION 1011:

STAIRWAYS, HANDRAILS & GUARDRAILS PROJECT NOTES

(N) STAIRWAY TO COMPLY W GEG SECTION 1011:

A. HEADROOM 6-8" MIN.

B. RISE 7 34" MAX, (RISER VARIATION 38" MAX)

C. TREAD DEPTH MIN. 19" NOSE TO NOSE & WIDTH: 3-0" MIN.

HANDRAILT DO COMPLY W GEG SECTION 1014:

A. 34" TO 38" ABOVE TREAD NOSING: 112" MIN. CLEAR FROM WALL

B. HANDRAILS MUST WITHSTAND A LOAD OF AT LEAST 200LBS APPLIED

IN ANY DIRECTION AT ANY POINT ON THE RAIL PER GIG 1607 8.11.

GRASPABILITY TYPE: I HANDRAILS WITH CIRCULAR CROSS SECTION SHALL

HAVE AN OUTSIDE DIAMETER OF AT LEAST 1" AND NOT GREATER THAN 2.

WHERE THE HANDRAIL IS NOT CIRCULAR, IT SHALL HAVE A PERIMETER

DIMENSION OF AT LEAST 4" AND NOT GREATER THAN 514" WITH A MAX.

CROSS SECTION OF 2.14" & MIN. CROSS SECTION OF 1". EDGES SHALL HAVE A

MIN. RADIUS OF 0.01" GRASPABILITY TYPE 2. HANDRAILS WITH A PERIMETER

GREATER THAN 6 14" SHALL PROVIDE A GRASPABLE FINGER RECESS AREA ON

BOTH SIDES OF THE PROFILE BEGINNING A DISTANCE OF 34" MEASURED

GREATER THAN 6 1/8" SYALL PROVIDE A GRASPABLE FINGER RECESS AREA ON BOTH SIDES OF THE PROFILE BEGINNING A DISTANCE OF 34" MEASURE VIEW OF THE PROFILE BEGINNING A DISTANCE OF 34" MEASURE AND ACHEVES A DEPTH OF 51°S WITHIN 78" BELOW THE WIDEST PORTION OF THE PROFILE. SPACES LINDER STAIRWAYS WITHIN SINGLE FAMILY RESIDENCE SHALE PROFILE DO THE ENCOSED SIDE WITH MIN. 58" GYP. BOARD.

GUARDRAIL TO COMPLY WI GBC SECTION 1015:
A 42" ABOVE WALKING SURFACE MAXIMUM SPACING OF INTERMEDIATE RAILS. SUCH THAT A "SPHEKE SHALL NOT PASS BETWEEN RAILS.
B. WHERE TOP OF GUARDRAIL ALSO SERVES AS STAIR HANDRAIL IN COMPLANCE WITH GEO. 1014, HEIGHT OF GUARDRAIL PREMITTED TO BE 34" MIN. TO 38" MAX. ABOVE TREAD NOSING.
C. GUARDRAIL SINGT WITHISTAND A LOAD OF AT LEAST 200LBS APPLIED IN ANY DIRECTION AT ANY POINT ON THE RAIL PER CBC 1607.8.1.1.

LAUNDRY & MECHANICAL ROOM PROJECT NOTES

CLOTHES WASHER, PROVIDE FLUSH MOUNT GUY BOX: FOR HOT & COLD WATER & DRAIN CONNECTION. WATER & DRAIN CONNECTION. CONNECTION. CONNECTION. CONNECTION. CONNECTION. CONTROL CLOTHES BRYEN. PROVIDE OPENING OF 100 SQ. INCHES MIN. FOR MAKEL-IP ART DOORS ENCLOSING APPLIANCE PER CMC 504.4.1 DIRECT EXHAUST TO OUTSIDE USING STEEL SMOOTH BORE, 4" MIN. DIA. DUCT. PROVIDE WEATHERPROOF CAR'S & BACKGRAFT DAMPER. TERMINATE VENT MIN. 3"OF PROVIDE METHER WINDOWS & DOORS PER CMC 802.2. PROVIDE IN-LINE

BOOSTER FAN FOR DUCT RUNS OVER 14'-0" IN LENGTH. PROVIDE GAS SHUTOFF VALVE IN APPROVED LOCATION. CONDENSING DRYERS TO HAVE

SHI JOPF VALUE IN APPROVED LOCATION. CONDENSING DRIVES TO HAVE PRAIN & DRAIN PAN (EARN WATER HEATERS AND CLOTHES WASHESS WATER HEALTER TO BE PROVIDED WITH SESSING STRAPPING PER OPC 507.2 ROOMS CONTAINING GAS CONSUMING SPACE AND WATER HEATING EQUIPMENT SHALL BE PROVIDED WITH COMBUSTION AIR OPENINGS IN COMPLIANCE WITH CIM CHAPTER 7.

$\qquad \qquad \square$	EXISTING WALL
	DEMOLISHED WALL
	NEW WALL
***********	NEW 1-HOUR RATED WALL

ISTING WALL MOLISHED WALL W WALL





628 SHOTWELL STREET LLC

INTERIOR **ALTERATION**


628 SHOTWELL STREET SAN FRANCISCO, CA 94110 BLOCK:3611 LOT:036


PROJECT REVIEW	09.09.19
ISSUE FOR PERMIT	11.13.19
PLAN CHECK #1	03.13.20
REVISION 01	07.10.20

DRAWN BY:	TL
DATE:	07.10.20
SHEET TITLE:	

EXISTING & PROPOSED FLOOR 03

SHEET NUMBER:

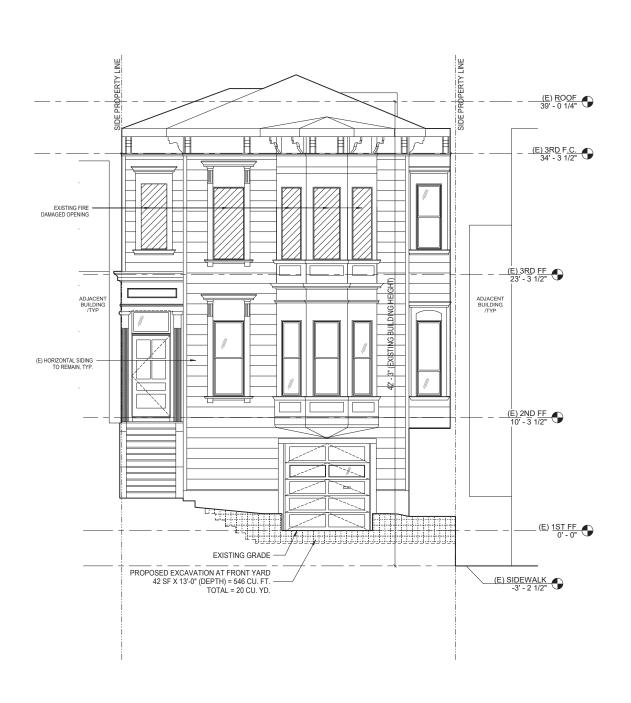

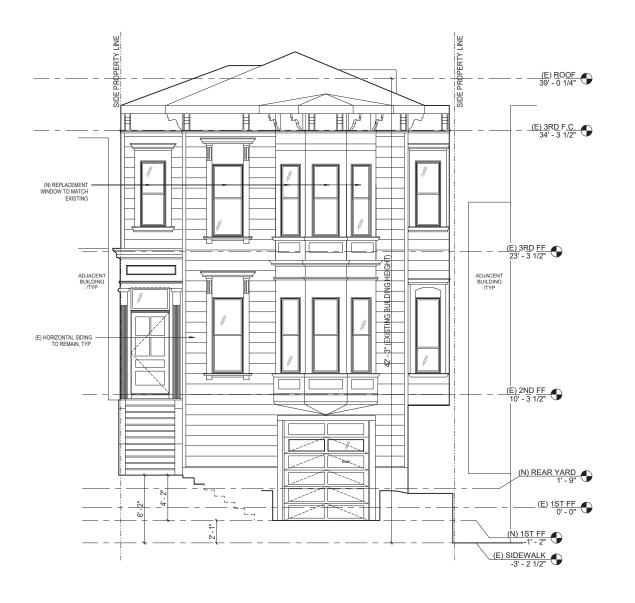



40 SPEAR STREET SAN FRANCISCO, CALIFORI P:(415)543-5005 F:(415)495-3336



628 SHOTWELL STREET LLC

INTERIOR ALTERATION

628 SHOTWELL STREET SAN FRANCISCO, CA 94110 BLOCK:3611 LOT:036

ISSUE:	DATE:
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REVISION 01	07.10.20

DATE: 07.10
SHEET TITLE:

EXISTING &
PROPOSED

EAST

ELEVATION

SHEET NUMBER:

A2.1


REV #: DATE


PROPOSED EAST EXTERIOR ELEVATION (FRONT)
SCALE: 1/4" = 1'-0"

SCALE:

EXISTING EAST EXTERIOR ELEVATION (FRONT)

SCALE: 1/4" = 1'-0"

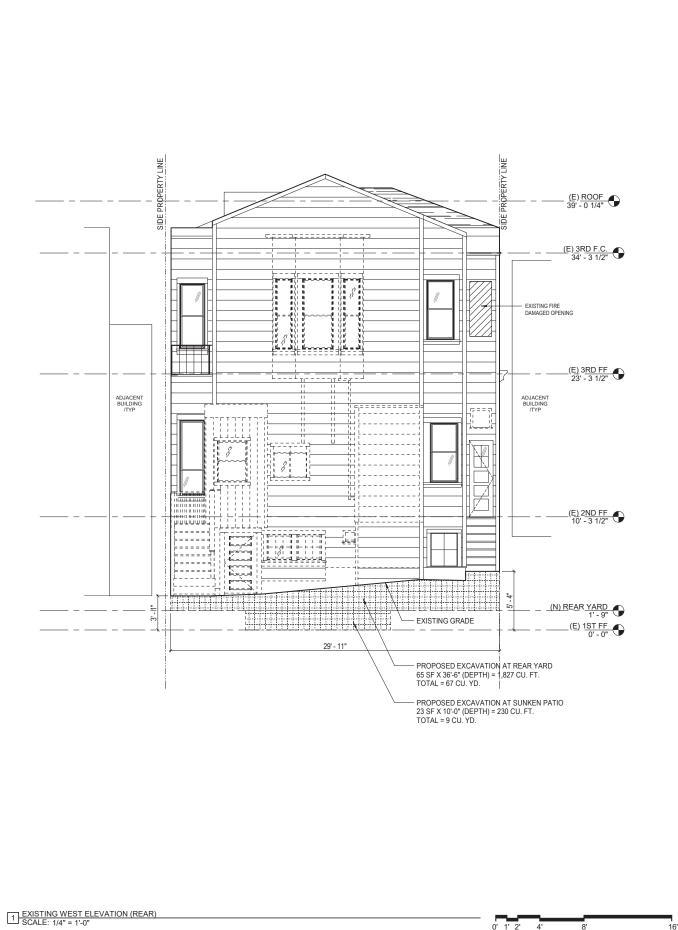

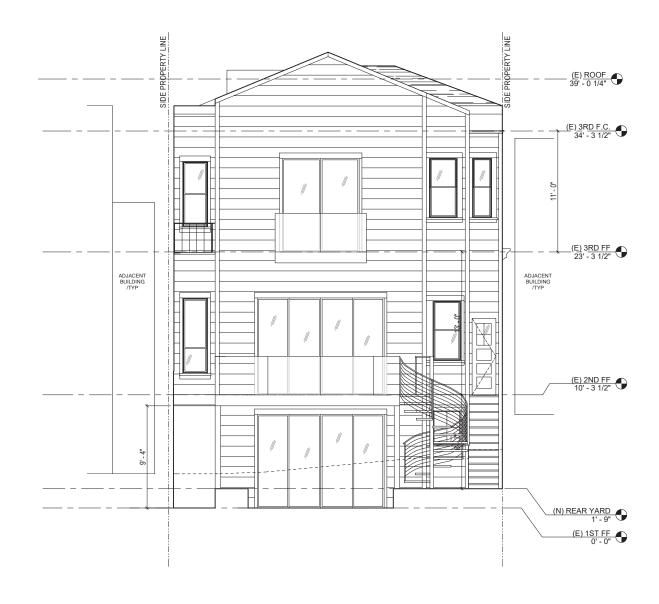





628 SHOTWELL STREET LLC

INTERIOR ALTERATION

628 SHOTWELL STREET SAN FRANCISCO, CA 94110 BLOCK:3611 LOT:036

ISSUE:	DATE:
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DATE:	07.10.20
SHEET TITLE:	

EXISTING & PROPOSED WEST ELEVATION

SHEET NUMBER:

REV #:

PROPOSED WEST ELEVATION (REAR)
SCALE: 1/4" = 1'-0"







628 SHOTWELL STREET LLC

INTERIOR ALTERATION

628 SHOTWELL STREET SAN FRANCISCO, CA 94110 BLOCK:3611 LOT:036

ISSUE:	DATE:
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EXISTING & PROPOSED NORTH ELEVATION

SHEET NUMBER:

SHEET TITLE:

A2.3









628 SHOTWELL STREET LLC

INTERIOR ALTERATION


628 SHOTWELL STREET SAN FRANCISCO, CA 94110 BLOCK:3611 LOT:036

ISSUE:	DATE
PROJECT REVIEW	09.09.19
ISSUE FOR PERMIT	11.13.19
PLAN CHECK #1	03.13.20
REVISION 01	07.10.20
DRAWN BY:	T
DATE:	07.10.2
SHEET TITLE:	,

EXISTING & PROPOSED SOUTH ELEVATION

SHEET NUMBER:

REV #:

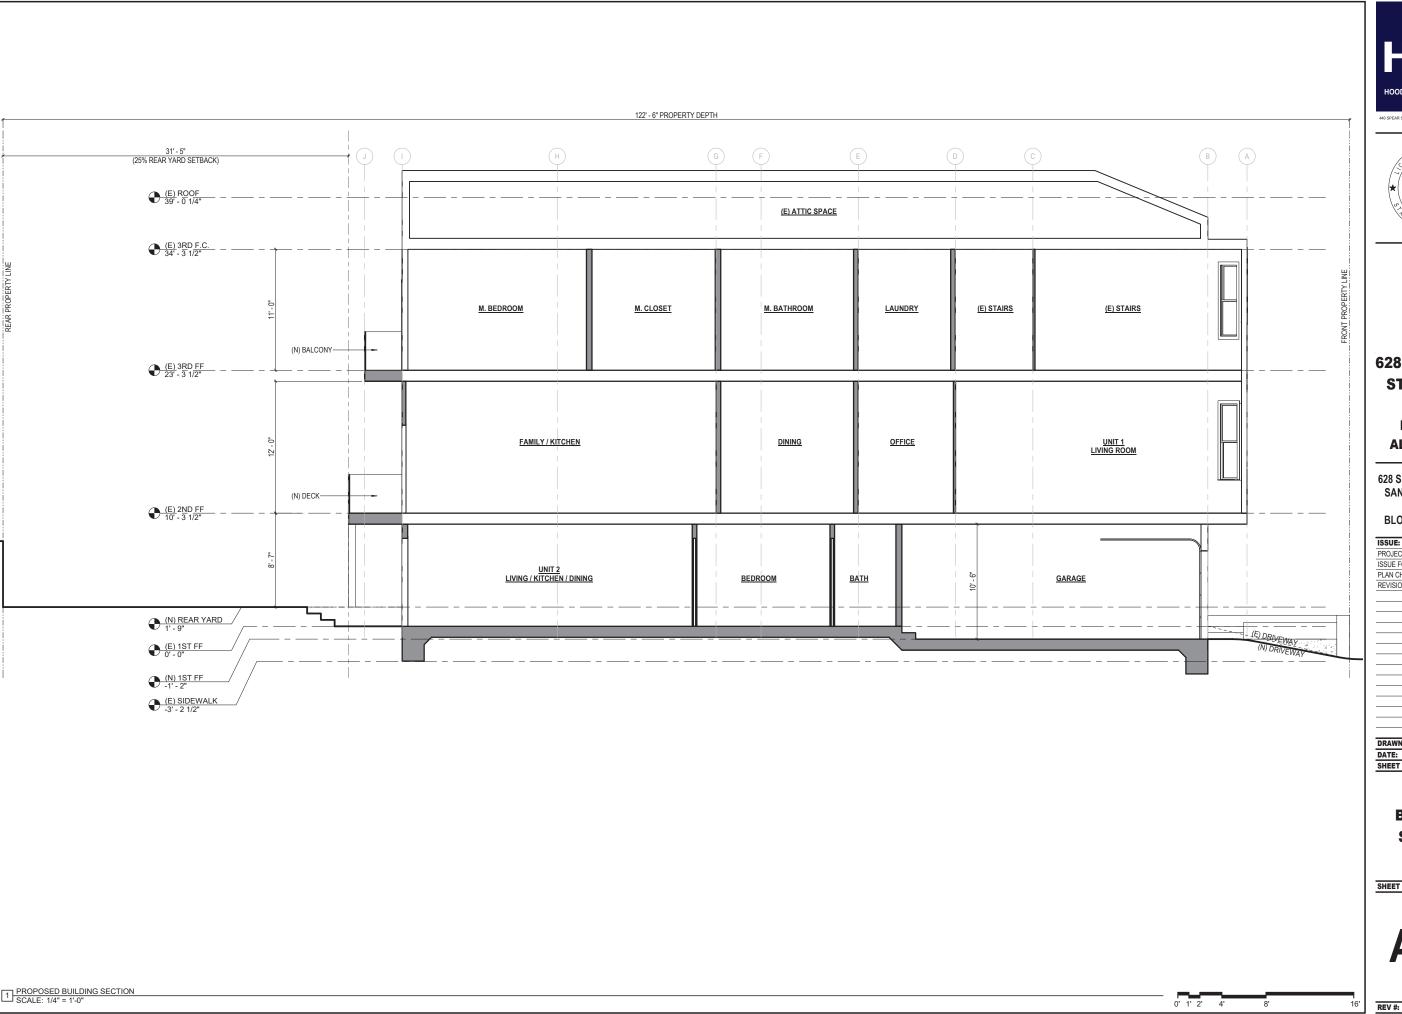



440 SPEAR STREET SAN FRANCISCO, CALIF P:(415)543-5005 F:(415)495-3336 WWW HOODTHOMAS COM



628 SHOTWELL STREET LLC

INTERIOR ALTERATION

628 SHOTWELL STREET SAN FRANCISCO, CA 94110 BLOCK:3611 LOT:036

ISSUE:	DATE:
PROJECT REVIEW	09.09.19
SSUE FOR PERMIT	11.13.19
PLAN CHECK #1	03.13.20
REVISION 01	07.10.20


DRAWN BY:	T
DATE:	07.10.2
SHEET TITLE:	

BUILDING SECTION

SHEET NUMBER:

A3.

REV #: DATE:

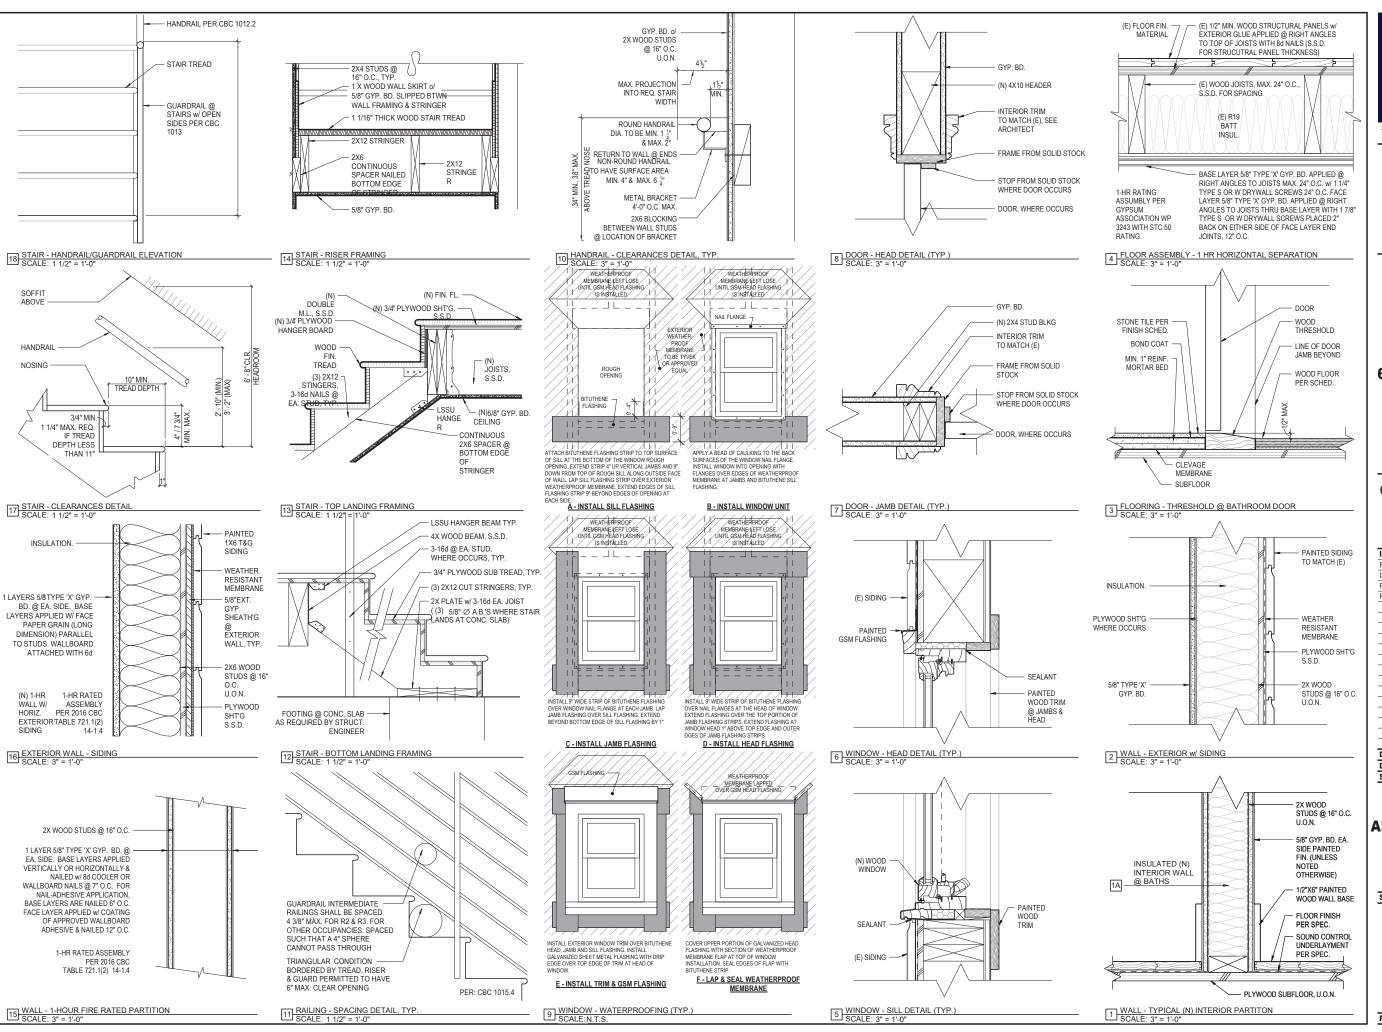



0 SPEAR STREET SAN FRANCISCO, CALIFOR P:(415)543-5005 F:(415)495-3336 WWW.HOODTHOMAS.COM



628 SHOTWELL STREET LLC

INTERIOR ALTERATION

628 SHOTWELL STREET SAN FRANCISCO, CA 94110 BLOCK:3611 LOT:036

1000=1	PAIL
PROJECT REVIEW	09.09.19
ISSUE FOR PERMIT	11.13.19
PLAN CHECK #1	03.13.20
REVISION 01	07.10.20


DRAWN BY:	TL
DATE:	07.10.20
SHEET TITLE:	

ARCHITECTURAL DETAILS

SHEET NUMBER:

A5.1

REV #: DATE:

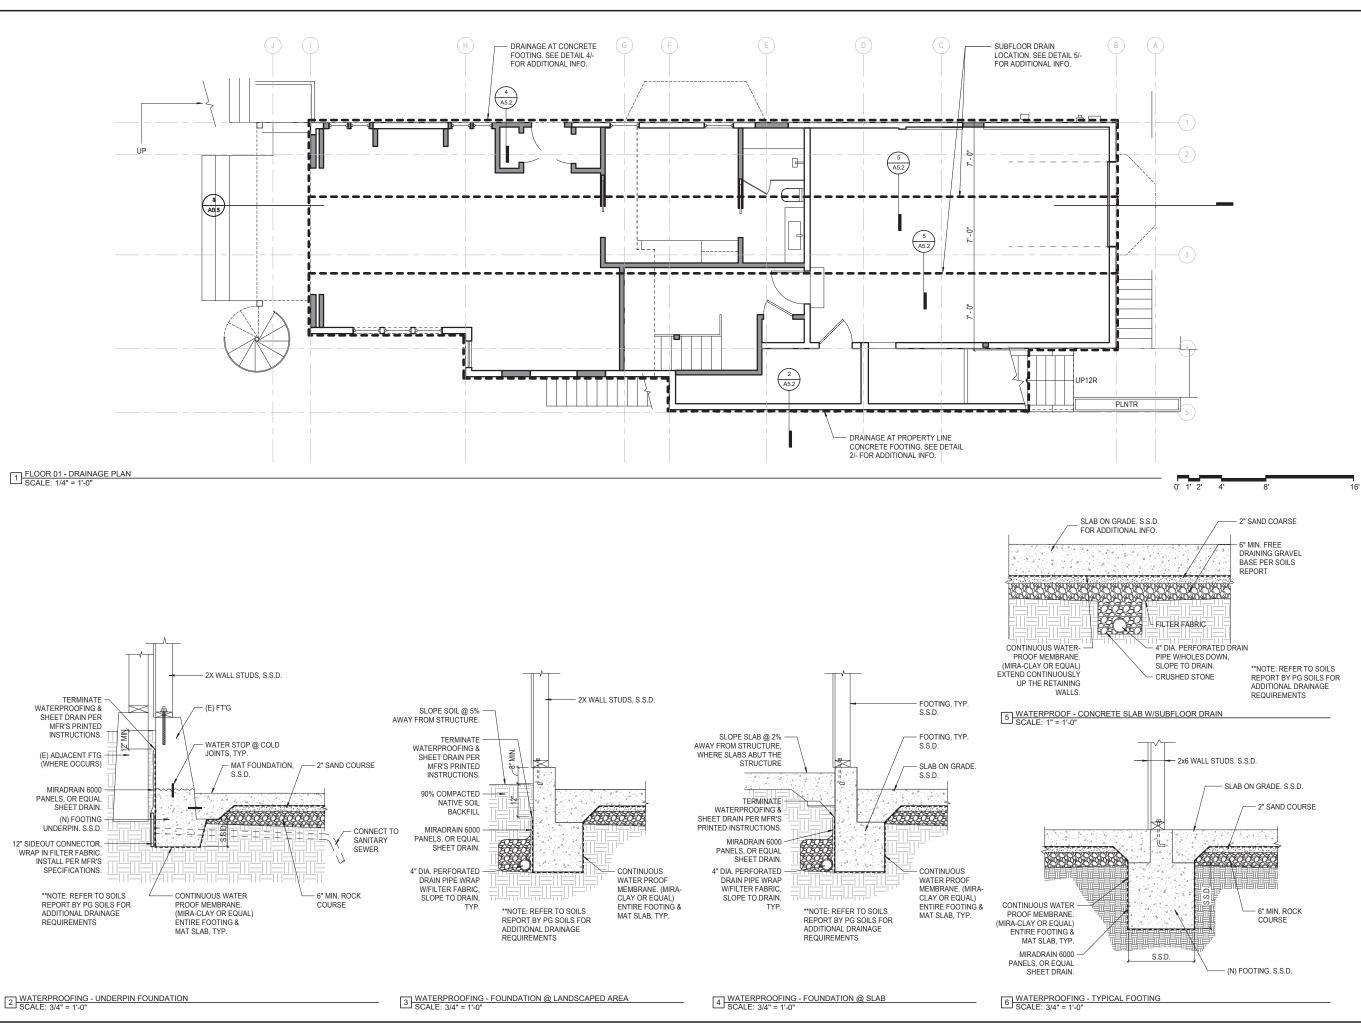





628 SHOTWELL STREET LLC

INTERIOR **ALTERATION**

628 SHOTWELL STREET SAN FRANCISCO, CA 94110 BLOCK:3611 LOT:036

ISSUE:	DATE:
PROJECT REVIEW	09.09.19
ISSUE FOR PERMIT	11.13.19
PLAN CHECK #1	03.13.20
REVISION 01	07.10.20

DRAWN BY:

DATE:

SHEET TITLE:

DRAINAGE PLAN & **DETAILS**

SHEET NUMBER:

DATE:

WINDOW SCHEDULE

WINDOW SCIEDULE									
MARK	TYPE	WIDTH	HEIGHT	HEAD HT	MATERIAL	FINISH	TEMPER	NOTES	
01	1	2' - 8"	6' - 0"	8' - 0"	WOOD CLAD	BY MFR >			
02	1	2' - 8"	6' - 0"	8' - 0"	WOOD CLAD	BY MFR >			
04	1	2' - 6"	6' - 0"	9' - 0"	WOOD CLAD	BY MFR >			
05	1	2' - 6"	6' - 0"	9' - 0"	WOOD CLAD	BY MFR >			
06	1	2' - 6"	6' - 0"	9' - 0"	WOOD CLAD	BY MFR >			
07	1	2' - 0"	8' - 0"	11' - 0"	WOOD CLAD	BY MFR >			
08	1	2' - 0"	8' - 0"	11' - 0"	WOOD CLAD	BY MFR >			
09	1	2' - 0"	8' - 0"	11' - 0"	WOOD CLAD	BY MFR >			
10	1	2' - 0"	8' - 0"	11' - 0"	WOOD CLAD	BY MFR >			
11	1	2' - 0"	8' - 0"	11' - 0"	WOOD CLAD	BY MFR >			
12	1	2' - 6"	5' - 0"	11' - 0"	WOOD CLAD	BY MFR >			
13	1	2' - 6"	7' - 0"	11' - 0"	WOOD CLAD	BY MFR >			
14	1	2' - 6"	7' - 0"	11' - 0"	WOOD CLAD	BY MFR >			
15	1	2' - 0"	6' - 6"	10' - 0"	WOOD CLAD	BY MFR. >			
16	1	2' - 0"	6' - 6"	10' - 0"	WOOD CLAD	BY MFR >			
17	1	2' - 4"	7' - 0"	10' - 0"	WOOD CLAD	BY MFR >			
18	1	2' - 4"	7' - 0"	11' - 0"	WOOD	PAINT >		EXISTING, SINGLE GLAZED	
19	1	2' - 4"	7' - 0"	11' - 0"	WOOD	PAINT />		EXISTING, SINGLE GLAZED	
20	1	2' - 8"	7' - 0"	11' - 0"	WOOD	PAINT >		EXISTING, SINGLE GLAZED	
21	1	1' - 9"	6' - 0"	9' - 0"	WOOD	PAINT >		EXISTING, SINGLE GLAZED	
22	1	1' - 9"	6' - 0"	9' - 0"	WOOD CLAD	BY MFR >			
23	1	1' - 9"	6' - 0"	9' - 0"	WOOD CLAD	BY MFR >			
24	1	2' - 6"	6' - 0"	10' - 0"	WOOD CLAD	BY MFR >			
25	1	2' - 6"	6' - 0"	10' - 0"	WOOD CLAD	BY MFR >			
26	1	2' - 4"	6' - 8"	9' - 8"	WOOD CLAD	BY MFR >			
27	1	2' - 4"	6' - 8"	11' - 0"	WOOD >	PAINT >		SINGLE GLAZED, TO MATCH EXISTING	
28	1	2' - 4"	6' - 8"	11' - 0"	WOOD >	PAINT >		SINGLE GLAZED, TO MATCH EXISTING	
29	1	2' - 8"	6' - 8"	9' - 8"	WOOD >	PAINT >		SINGLE GLAZED, TO MATCH EXISTING	
30	1	2' - 10"	5' - 0"	7' - 8 3/4"	WOOD ·	PAINT >		SINGLE GLAZED, TO MATCH EXISTING	
31	1	2' - 10"	6' - 8"	11' - 0"	WOOD CLAD	BY MFR >			
32	1	2' - 0"	8' - 0"	10' - 0"	WOOD >	BY MFR >		SINGLE GLAZED, TO MATCH EXISTING	
33	1	2' - 8"	6' - 0"	9' - 0"	WOOD CLAD	BY MFR >			
34	1	2' - 5"	6' - 0"	11' - 0"	WOOD CLAD	BY MFR >			

WINDOW GENERAL NOTES

- NEW WINDOW OPENINGS TO BE ENERGY EFFICIENT.
 WINDOW DIMENSIONS INDICATED ABOVE ARE APPROXIMATE FRAME DIMENSIONS. GENERAL CONTRACTOR TO FIELD VERIFY TRUE WINDOW SIZE REQUIREMENTS PRIOR TO ORDERING
- WINDOWS.

 3. ALL WINDOWS ARE TO BE DOUBLE GLAZED, UNLESS NOTED OTHERWISE.

 4. WINDOW SYMBOLS SHOW VIEW FROM EXTERIOR.




DOOR SCHEDULE

MARK	LOCATION	TYPE	WIDTH	HEIGHT	MATERIAL	FINISH	RATING	NOTES
01	GARAGE	F	7' - 8"	8' - 0"	WOOD	PAINT		
02	GARAGE	В	3' - 0"	8' - 0"	WOOD	PAINT	20 MIN.	
03	FAMILY ENTRY	В	3' - 0"	8' - 0"	WOOD	PAINT		
04	FAMILY ENTRY	В	2' - 8"	8' - 0"	WOOD	PAINT		
05	UNIT 1 BEDROOM	С	2' - 8"	8' - 0"	WOOD	PAINT		
06	UNIT 1 BEDROOM	D	6' - '0"	8' - 0"	WOOD	PAINT		
07	UNIT 1 LIVING	В	2' - 8"	8' - 0"	ALUM/GL	CLR		
08	UNIT 1 LIVING	В	2' - 8"	8' - 0"	WOOD	PAINT		
09	UNIT 1 LIVING	В	3' - 0"	8' - 0"	WOOD	PAINT		
10	PDR	С	2' - 6"	8' - 0"	WOOD	PAINT		
10	UNIT 1 LIVING	A	11' - 6"	8' - 0"	WOOD	PAINT		
11	HALLWAY	В	2' - 6"	8' - 0"	WOOD	PAINT		
12	KITCHEN	В	2' - 6"	8' - 0"	ALUM/GL	CLR		
13	FAMILY	A	11' - 6"	8' - 0"	WOOD	PAINT		
14	CLO.	E	2' - 2"	8' - 0"	WOOD	PAINT		
15	HALLWAY	С	3' - 4"	8' - 0"	WOOD	PAINT		
16	HALLWAY	E	3' - 6"	8' - 0"	WOOD	PAINT		
17	BATH 2	С	2' - 6"	8' - 0"	WOOD	PAINT		
18	BATH 2	С	2' - 6"	8' - 0"	WOOD	PAINT		
19	BEDROOM 2	В	2' - 8"	8' - 0"	WOOD	PAINT		
20	HALLWAY	В	7' - 0"	8' - 0"	ALUM/GL	CLR		
21	M. BEDROOM	A	3' - 6"	8' - 0"	WOOD	PAINT		
22	LAUNDRY	С	2' - 8"	8' - 0"				

DOOR GENERAL NOTES

- DIMENSIONS INDICATED ARE OF APPROXIMATE LEAF SIZE OR IN SOME INSTANCES, FINISHED OPENING SIZE.
 STANDARD DOOR THICKNESS TO BE 1-3/4" UNLESS NOTED OTHERWISE.
 ALL FIRE-RATED DOORS SHALL HAVE SMOKE-TIGHT GASKETS AND SELF-CLOSING DEVICES.

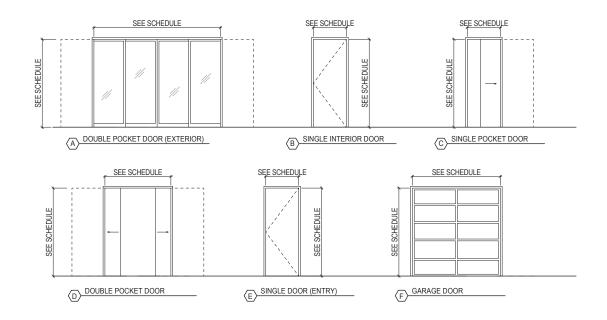





628 SHOTWELL STREET LLC

INTERIOR **ALTERATION**

628 SHOTWELL STREET SAN FRANCISCO, CA 94110 BLOCK:3611 LOT:036

ISSUE:	DATE:
PROJECT REVIEW	09.09.19
ISSUE FOR PERMIT	11.13.19
PLAN CHECK #1	03.13.20
REVISION 01	07.10.20

DRAWN BY:	T
DATE:	07.10.2
SHEET TITLE:	

DOOR & **WINDOW SCHEDULES**

SHEET NUMBER:

REV #:

GS5: San Francisco Green Building Submittal Form for Residential Alteration + Addition Projects

This form is for pern		box at the right.			OTHER RESIDENTIAL ALTERATIONS +	VERIFICATION			
	e a minimum of 11" x 17". ermit applications submitted Ja	anuary 2017 through December 2019. The prior ver	rsion		ADDITIONS	Indicate below who is responsible for ensuring gre building requirements are met. Projects that increa			
	until January 1, 2018.	SOURCE OF			adds any amount of conditioned	total conditioned floor area by ≥1,000 sq. ft. are requi to have a Green Building Compliance Professional			
	TITLE	REQUIREMENT	DESCRIPTION OF	REQUIREMENT	area, volume, or size	Record as described in Administrative Bulletin 93.			
GRAD	DING & PAVING	CALGreen 4.106.3 Show how surfa	ace drainage (grading, swales, drains, retention are	eas) will keep surface water from entering the building.	if applicable	projects that increase total conditioned floor area <1,000 sq. ft., the applicant or design professional n			
	ENT PROOFING	CALGreen 4.406.1 Seal around pip	pe, cable, conduit, and other openings in exterior w	alls with cement mortar or DBI-approved similar method.	•	sign below, and no license or special qualifications required. FINAL COMPLIANCE VERIFICATION form			
FIR	REPLACES & OODSTOVES	CALGreen 4.503.1 Install only dire	ect-vent or sealed-combustion, EPA Phase II-compli	ant appliances.		will be required prior to Certificate of Completion			
CAPIL	ILLARY BREAK,		foundation requiring vapor retarder also requires a	capillary break such as: 4 inches of base 1/2-inch aggregate under retarder; slab design specified by licensed		628 SHOTWELL STREET LLC			
	AB ON GRADE STURE CONTENT	professional.	9% moisture content before enclosure.			PROJECT NAME 3611 / 036			
	ROOM EXHAUST			d its humidistat shall be capable of adjusting between <50% to >80% (humidistat may be separate component).		BLOCK/LOT			
DATTIN	NOOW EXTIAOST	CALGICEIT 4.300.1 Widst be LIVELY	13 TAIX compliant, ducted to building exterior, an	u its humidistat shall be capable of adjusting between 500% to 500% (humidistat may be separate component).		628 SHOTWELL STREET, SAN FRANCISCO, CA 94110 ADDRESS			
LOW-EMIT	MITTING MATERIALS		hat comply with the emission limit requirements of 4 g (80% of area), and composite wood products.	4.504.2.1-5, 5.504.4.1-6 for adhesives, sealants, paints, coatings, carpet systems including cushions and adhesives,	•	R3 PRIMARY OCCUPANCY 4,787 SF			
	OOR WATER USE REDUCTION	CALGreen 4.303.1, SF Housing Code sec.12A10 SF Housing Co	•	GROSS BUILDING AREA 293 SF INCREASE IN CONDITIONED FLOOR AREA					
	TER-EFFICIENT IRRIGATION	Administrative Code If modified land	dscape area is ≥1,000 sq.ft., use low water use plar	nts or climate appropriate plants, restrict turf areas and comply with Model Water Efficient Landscape Ordinance area for projects with ≤2,500 sq.ft. of landscape area.	•	I have been retained by the project sponsor to verify approved construction documents and construction the requirements of San Francisco Green Building Coc			
ENERG	RGY EFFICIENCY	CA Energy Code Comply with all	I provisions of the CA Energy Code.	•	is my professional opinion that the requirements of the s Francisco Green Building Code will be met. I will notify Department of Building Inspection if the project will, for reason, not substantially comply with these requirement				
BICY	YCLE PARKING	Planning Code sec.155.1-2	and long-term bike parking to meet requirements of	f SF Planning Code sec.155.1-2.	if applicable	I am no longer the Green Building Compliance Professi of Record for the project, or if I am otherwise no lo responsible for assuring the compliance of the project the San Francisco Green Building Code.			
RECYCLIN	ING BY OCCUPANTS	SF Building Code AB-088 Provide adequa	ate space and equal access for storage, collection,	and loading of compostable, recyclable and landfill materials.	•	LICENSED PROFESSIONAL (sign & date)			
≥ DEMC	NSTRUCTION & MOLITION (C&D) TE MANAGEMENT	SFGBC 4.103.2.3 For 100% of mi	ixed C&D debris use registered transporters and re	gistered processing facilities with a minimum of 65% diversion rate.	•	May be signed by applicant when <1,000 sq. ft. is add AFFIX STAMP BELOW:			
HVAC IN	NSTALLER QUALS	CALGreen 4.702.1 Installers must	be trained in best practices.						
	VAC DESIGN	CALGreen 4.507.2 HVAC shall be	designed to ACCA Manual J, D, and S.		•				
BIRD-S.	SAFE BUILDINGS	Planning Code sec.139 Glass facades a	and bird hazards facing and/or near Urban Bird Re	fuges may need to treat their glass for opacity.	•				
TOBACCO	O SMOKE CONTROL	Health Code art.19F Prohibit smokin	ng within 10 feet of building entries, air intakes, and	operable windows and enclosed common areas.	•				
STC CON	TORMWATER DNTROL PLAN		oing ≥5,000 sq.ft. in combined or separate sewer ar water Management Requirements.	reas, or replacing ≥2,500 impervious sq.ft. in separate sewer area, must implement a Stormwater Control Plan meeting	if project extends outside envelope	Projects that increase total conditioned floor at by ≥1,000 sq.ft.: Green Building Compliance Profess of Record will verify compliance.			
	STRUCTION SITE RUNOFF	Public Works Code art.4.2 sec.146	truction site Stormwater Pollution Prevention Plan	and implement SFPUC Best Management Practices.	if project extends outside envelope	of Record will verify compliance. MARK THOMAS (415) 543-5005			
	R FILTRATION DNSTRUCTION)	CALGreen 4.504.1 Seal permanen	nt HVAC ducts/equipment stored onsite before insta	illation.		GREEN BUILDING COMPLIANCE PROFESSIONAL (name & contact phone #) HOOD THOMAS ARCHITECTS FIRM			
		ater Efficiency		Water Efficiency of Existing Non-Compliant Fixtures	-0	X I am a LEED Accredited Professional			
FIXTURE TY	TYPE I	CALGreen 4.303 maximum flow rates: MAXIMUM FIXTURE FLOW RATE	NOTES:	All fixtures that are not compliant with the San Francisco Commercial Water Conservation Ordinance that serve or are located within the project area must be replaced with fixtures					
Showerhead		2 gpm @ 80 psi	For dual flush toilets, effective flush volume is defined as the composite, average flush	or fittings meeting the maximum flow rates and standards referenced above. For more		I am a GreenPoint Rater			
Lavatory Fai		1.2 gpm @ 60 psi	volume of two reduced flushes and one full flush. The referenced standard is ASME	information, see the Commercial Water Conservation Program Brochure, available at SFDBI. org.		I am an ICC Certified CALGreen Inspector			
Kitchen Faux		1.8 gpm @ 60 psi default	A112.19.14 and USEPA WaterSense Tank-	NON-COMPLIANT PLUMBING FIXTURES INCLUDE:					
Wash Founta		1.8 gpm / 20 [rim space (inches) @ 60 psi]	Type High Efficiency Toilet Specification – 1.28 gal (4.8L)	Any toilet manufactured to use more than 1.6 gallons/flush		GREEN BUILDING COMPLIANCE PROFESSIONA			
Tank-type w		.20 gallons per cycle 1.28 gallons / flush ¹ and EPA WaterSense Certified	The combined flow rate of all showerheads in one shower stall shall not exceed the	Any urinal manufactured to use more than 1 gallon/flush Any showerhead manufactured to have a flow capacity of more than 2.5 gpm		(sign & date)			
Flushometer		1.28 gallons / flush ¹	maximum flow rate for one showerhead, or	4. Any interior faucet that emits more than 2.2 gpm		Signature by a professional holding at least on the above certifications is required. If the Lice			
Tank-type was Flushometer Urinals		Wall mount: 0.125 gallons / flush Floor mount: 0.5 gallons / flush	the shower shall be designed to allow only one showerhead to be in operation at a time (CALGreen 5.303.2.1)	Exceptions to this requirement are limited to situations where replacement of fixture(s) would detract from the historic integrity of the building, as determined by the Department of Building Inspection pursuant to San Francisco Building Code Chapter 13A.		Professional does not hold a certification for g design and/or inspection, this section may be comp by another party who will verify applicable green bui			



440 SPEAR STREET SAN FRANCISCO, CALIFOR P:(415)543-5005 F:(415)495-3336



628 SHOTWELL STREET LLC

INTERIOR ALTERATION

628 SHOTWELL STREET SAN FRANCISCO, CA 94110 BLOCK:3611 LOT:036

PROJECT REVIEW	09.09.
ISSUE FOR PERMIT	11.13.
PLAN CHECK #1	03.13.2
REVISION 01	07.10.2
DRAWN BY:	

GREEN BUILDING COMPLIANCE

SHEET NUMBER:

A6.2

PEV #- DATE-

CERTIFICATE OF COMPLIANCE - RESIDENTIAL PERFORMANCE COMPLIANCE METHOD
Project Name: 628 Shockwell St.

Calculation Date/Time: 69.21, Mon, Nov 11, 2019 Page 2 of 1
Calculation Description: Tile 24 Analysis Input File Name: 628 Shockwell ribot 16x

HERS FEATURE SUMMARY
The following is a summary of the features that must be field-verified by a certified HERS Rater as a condition for meeting the modeled energy performance for this computer analysis. Additional detail in provided in the building components labeles below.

Butting—Servel Verifications:
Cooling System Verifications:
- Under Sealing
Domestic Not Water System Verifications:
- Under Sealing
Domestic Not Water System Verifications:
- Under Sealing
- During Sealing System Verifications:
- Under Sealing System Verifications:
- Under Sealing Seali

CERTIFICATE OF COMPLIANCE - RESIDENTIAL PERFORMANCE COMPLIANCE METHOD
Project Name: 628 Shotwell St
Calculation Description: Title 24 Analysis
Input File Name: 628 Shotwell ribd16x

FENESTRATION / GLAZING										
01	02	03	04	05	06	07	08	09	10	11
Name	Surface (Orientation-Azimuth)	Width (ft)	Height (ft)	Multiplier	Area (ft ²)	U-factor	SHGC	Exterior Shading	Status	Verified Existing Condition
Window	North Wall (Front-0)			1	31.5	0.45	0.50	Insect Screen (default)	Altered	n/a
Window 2	East Wall (Left-90)			- 1	33.3	1.04	0.76	Insect Screen (default)	Altered	n/a
Window 3	East Wall (Left-90)			- 1	18.8	0.45	0.50	Insect Screen (default)	Altered	n/a
Window 4	NE Wall (- specify45)			- 1	15.0	0.45	0.50	Insect Screen (default)	Altered	n/a
Window 5	NE Wall (- specify45)			1	15.5	1.04	0.76	Insect Screen (default)	Altered	n/a
Window 6	South Wall (Back-180)			. 1	14.0	0.45	0.50	Insect Screen (default)	Altered	n/a
Window 7	South Wall (Back-180)			1	16.0	0.45	0.50	Insect Screen (default)	Altered	n/a
Window 8	West Wall (Right-270)		₽	1	16.0	0.45	0.50	Insect Screen (default)	Altered	n/a
Door 21	West Wall (Right-270)		H	. >-1	56.0	0.45	0.50	Insect Screen (default)	Altered	n/a
Window 9	NW Wall (- specify315)		N n	1	15.0	0.45	0.50	Insect Screen (default)	Altered	n/a
Window 10	SE Wall (- specify135)			/1	15.5	1.04	0.76	Insect Screen (default)	Altered	n/a
Window 11	North Wall 2 (Front-0)			1	74.0	0.45	0.50	Insect Screen (default)	Altered	n/a
Window 12	East Wall 2 (Left-90)			1	35.0	1.04	0.76	Insect Screen (default)	Existing	No
Window 13	NE Wall 2 (- specify45)	0	1900	_1_	17.5	0.45	0.50	Insect Screen (default)	Altered	n/a
Window 14	NE Wall 2 (- specify45)	U#F	1	E1 K	16.3	1.04	0.76	Insect Screen (default)	Altered	n/a
Window 15	South Wall 2 (Back-180)			- 1	16.0	0.45	0.50	Insect Screen (default)	Altered	n/a
Window 16	South Wall 2 (Back-180)			- 1	16.0	0.45	0.50	Insect Screen (default)	Altered	n/a
Window 17	West Wall 2 (Right-270)			1	12.5	0.45	0.50	Insect Screen (default)	Altered	n/a
Door 13	West Wall 2 (Right-270)			1	92.0	0.45	0.50	Insect Screen (default)	Altered	n/a
Window 18	NW Wall 2 (- specify315)			1	17.5	0.45	0.50	Insect Screen (default)	Altered	n/a
Window 19	SE Wall 2 (- specify135)			1	16.3	1.04	0.76	Insect Screen (default)	Altered	n/a
Skylight EX	Roof (Front-0)			1	21.0	0.71	0.73	None	Existing	No
Skylight New	Roof (Front-0)			- 1	76.0	0.50	0.29	None	New	n/a
Window 20	North Wall 3 (Front-0)			1	46.0	0.45	0.50	Insect Screen (default)	New	n/a
Window 21	South Wall 3 (Back-180)			1	45.0	0.45	0.50	Insect Screen (default)	New	n/a
Door 07	West Wall 3 (Right-270)			1	92.0	0.45	0.50	Insect Screen (default)	New	n/a
Window 22	West Wall 3 (Right-270)			1	7.5	0.45	0.50	Insect Screen (default)	New	n/a

gistration Number: 419-P010124008A-000-000-0000000-00000 Registration Date/Time: 11/11/2019 08:29 HERS Provider: CHEERS

Building Energy Efficiency Standards - 2016 Residential Compiliance Report Version - CF1R-06232018-1149 Report Generated at: 2019-11-11 08:22:19

Calculation Date/Time; 08:21, Mon. Nov 11, 2019

CERTIFICATE OF COMPLIANCE - RESIDENTIAL PERFORMANCE COMPLIANCE METHOD

Calculation Description: Title 24 Analysis						Input File	Name:	628 Sh	otwell.r	bd16x				
HVAC - COOLING UN	IT TYPES													
01			02	03		04	05	,		06		07		08
Name		Sys	System Type		Number of Units		Efficiency EER SEER		Zonally Controlled		Comp	ressor Type	HERS	S Verification
Cooling Compone	ent 1	No	Cooling	1		n/a	n/a	3		n/a		n/a		n/a
HVAC - DISTRIBUTIO	ON SYSTEMS	3												
01		02	03	04		05	-	06	Т	07	08	0	9	10
Name	T	ype	Duct Leakage	Insulation R-value		pply Duct ocation		n Duct ation	Вура	ss Duct	Status	Verified Cond	Existing dition	HERS Verification
Air Distribution (Ventila		s located in attic fentilated and Sealed and tester Inventilated)		6.0	Attic		А	ttic	ic None		Altered	N	Air Distribut System 1-hers-dis	
HVAC DISTRIBUTION	- HERS VE	RIFICATION			1									
01			02	03		04		05			6	07	\top	08
			t Leakage erification	Duct Leakage Target (%)						ried cts	Deeply Buried Ducts		.ow-leakage Air Handler	
Air Distribution Syste	m 1-hers-dis	t I	Required	5.0		Not Require	lot Required Not Required		quired Not Required		Not Required r		n/a	
HVAC - FAN SYSTEN	AS & HERS V	/ERIFICATION												
	01			02	FFP		RI	5	03				04	
Name			Type			-	Fan Power (Watts/CFM)			HERS Verification				
HVAC Fan 1		Sin	gle Speed PSC Fu	ımace	Fan		0.58							
IAQ (Indoor Air Quali	tv) FANS													
01	,,		02			03		04			05		06	
Dwelling Un	nit		IAQ CFM		IAQ W	fatts/CFM			AQ Fan	Туре		Recovery veness(%)	HERS	Verification
SFam IAQVent	tRpt		0		0.25			Default			0		Not	t Required

CERTIFICATE OF COMPLIANCE - RESIDENTIAL PERFORMANCE COMPLIANCE METHOD
Project Name: 628 Shotwell St
Calculation Description: Title 24 Analysis
Input File Name: 628 Shotwell rbd16x

PAQUE SURFACES										
01	02	03	04	05	06	07	08	09	10	11
Name	Zone	Construction	Azimuth	Orientation	Gross Area (ft ²)	Window & Door Area (ft ²)	Tilt (deg)	Wall Exception	Status	Verified Existing Condition
North Wall	Existing Area	Default Wall Prior to 197	0	Front	765.6	31.5	90	n/a	Existing	No
East Wall	Existing Area	Default Wall Prior to 197	90	Left	223.7	52.1	90	n/a	Existing	No
NE Wall	Existing Area	Default Wall Prior to 197	45	45	154	30.5	90	n/a	Existing	No
South Wall	Existing Area	Default Wall Prior to 197	180	Back	803	30	90	n/a	Existing	No
West Wall	Existing Area	Default Wall Prior to 197	270	Right	286	72	90	n/a	Existing	No
NW Wall	Existing Area	Default Wall Prior to 197	315	315	44	15	90	n/a	Existing	No
SE Wall	Existing Area	Default Wall Prior to 197	135	135	38.5	15.5	90	n/a	Existing	No
North Wall 2	Existing Area	Default Wall Prior to 197	0	Front	904.8	74	90	n/a	Existing	No
East Wall 2	Existing Area	Default Wall Prior to 197	90	Left	264	63	90	n/a	Existing	No
NE Wall 2	Existing Area	Default Wall Prior to 197	45	45	182	33.8	90	n/a	Existing	No
South Wall 2	Existing Area	Default Wall Prior to 197	180	Back	949	32	90	n/a	Existing	No
West Wall 2	Existing Area	Default Wall Prior to 197	270	Right	338	104.5	90	n/a	Existing	No
NW Wall 2	Existing Area	Default Wall Prior to 197	315	315	52	17.5	90	n/a	Existing	No
SE Wall 2	Existing Area	Default Wall Prior to 197	135	135	45.5	16.3	90	n/a	Existing	No
Roof 2	Existing Area	Default Roof Prior to 197		K.	3 1519			n/a	Existing	No
Interior Surface	Existing Area>>Garage	Default Floor No Crawispa			609			n/a	Existing	No
Interior Surface 2	Existing Area>>Addition Zone	R-0 Floor No Crawispace			893			n/a	New	n/a
North Wall 3	Addition Zone	R-19 Wall	0	Front	455	46	90	Ex. w/ Siding	New	n/a
South Wall 3	Addition Zone	R-19 Wall	180	Back	327	45	90	Ex. w/ Siding	New	n/a
West Wall 3	Addition Zone	R-19 Wall	270	Right	230	99.5	90	Ex. w/ Siding	New	n/a
Wall to Garage	Addition Zone>>Garage	R-13 Wall			230	0		n/a	New	n/a
North Wall 4	Garage	Default Wall Prior to 197	0	Front	280	0	90	n/a	Existing	No
East Wall 3	Garage	Default Wall Prior to 197	90	Left	200	61	90	n/a	Existing	No
South Wall 4	Garage	Default Wall Prior to 197	180	Back	400	0	90	n/a	Existing	No

A Building Energy Efficiency Standards - 2016 Residential Compliance Report Version - CF1R-06232018-1149 Report Generated at: 2019-11-11 08:22:19

CERTIFICATE OF COMPLIANCE - RESIDENTIAL PERFORMANCE COMPLIANCE METHOD
Project Name: 628 Shotwell St
Calculation Description: Title 24 Analysis
Input File Name: 628 Shotwell ribd16x

Calculation Description: Title 24 Analysis

OPAQUE DOORS											
01			02			03		4	05		06
Name			Side of Building				U-fa	factor		atus	Verified Existing Condition
Door			East Wall 2		28.0		0.	50	New		No
OPAQUE SURFACE CONSTRU	ICTIONS										
01	02	2	03	04		05		06			07
Construction Name	Surface	туре	Construction Type	Framing			Cavity Winter Design			Assembly Layers	
Default Wall Prior to 197	Default Wall Prior to 197 Exterior Walls		Wood Framed Wall	2x4 @ 16 in. O.C.		n	none 0.36			Inside Finish: Gypsum Board Cavity / Frame: no insul. / 2x4 Exterior Finish: 3 Coat Stucco	
Attic RoofExisting Area Attic Ro		Roofs	Wood Framed Ceiling	2x4 @ 24 in, O.C.		n	none 0.644			Cavity / Frame: no insul. / 2x4 Roof Deck: Wood Siding/sheathing/dec Roofing: Light Roof (Asphalt Shingle)	
		(below c)	Wood Framed Ceiling	2x4 @ 16 in.	o.c.	F	R 11	0.083		Inside Finish: Gypsum Board Cavity / Frame: R-9.1 / 2x4 Over Ceiling Joists: R-1.9 insul.	
Default Roof Prior to 1971 Cather		Ceilings	Wood Framed Ceiling	2x4 @ 16 in.	o.c.	F	₹ 11	0.088		 Cavity Roof D 	Finish: Gypsum Board / Frame: R-11 / 2x4 leck: Wood Siding/sheathing/decking g: Light Roof (Asphalt Shingle)
Default Floor No Crawispa Interior F		Floors	Wood Framed Floor	2x12 @ 16 in	= R	5	ione	0.196		 Floor I Cavity 	Surface: Carpeted Deck: Wood Siding/sheathing/decking / Frame: no insul. / 2x12 Below Finish: Gypsum Board
R-0 Floor No Crawfspace Interior Fl		Floors	Wood Framed Floor	2x12 @ 16 in	. O.C.	n	ione	0.196		 Floor E Cavity 	Surface: Carpeted Seck: Wood Siding/sheathing/decking / Frame: no insul. / 2x12 Below Finish: Gypsum Board
R-19 Wall Exterior Wall		Walls	Wood Framed Wall	2x6 @ 16 in.	O.C.		n 5-1/2 in. y (R-18)	0.074		 Cavity 	Finish: Gypsum Board / Frame: R-19 in 5-1/2 in. (R-18) / 2x6 ir Finish: 3 Coat Stucco
R-13 Wall	Interior	Walls	Wood Framed Wall	2x4 @ 16 in.	O.C.	F	₹ 13	0.092		 Cavity 	Finish: Gypsum Board / Frame: R-13 / 2x4 Side Finish: Gypsum Board

CERTIFICATE OF COMPLIANCE - RESIDENTIAL PERFORMANCE COMPLIANCE METHOD

CF1R-PRF
Project Name: 628 Shotwell St

Calculation DaterTime: 08.21, Mon, Nov 11, 2019

Page 9 c

Calculation Description: Title 24 Analysis

Input File Name: 628 Shotwell ribd16x

DOCUMENTATION AUTHOR'S DECLARATION STATEMENT	
I certify that this Certificate of Compliance documentation is accurate and complete.	
Documentation Author Name: Hayley Monahan	Documentation Author Signature: Hayley Monahan
Company: EnergySoft	Signature Date: 11/11/2019
Address: 1025 5th Street	CEA/HERS Certification Identification (If applicable):
City/State/Zip: Novato, CA 94947	Phone: 415-897-6400
RESPONSIBLE PERSON'S DECLARATION STATEMENT	
Regulations.	of Compliance conform to the requirements of Title 24, Part 1 and Part 6 of the California Code of liance are consistent with the information provided on other applicable compliance documents,
Responsible Designer Name: Hayley Monahan	Responsible Designer Signature: Hayley Monahan
Company: EnergySoft CHE	Date Signed: 11/11/2019
Address: 1025 5th Street	License:

Digitally signed by CHEERS™. This digital signature is provided in order to secure the content of this registered document, and in no way implies Registration Provider responsibility for the accuracy of the information.

tration Number: 419-P010124008A-000-000-0000000-0000 Registration Date/Time: 11/11/2019 08: ultding Energy Efficiency Standards - 2016 Residential Compilance Report Version - CF1R-08232018-1149

Date/Time: 11/11/2019 08:29 HERS Provider: CHE sion - CF1R-06232018-1149 Report Generated at:



NO. C19445

628 SHOTWELL STREET LLC

INTERIOR ALTERATION

628 SHOTWELL STREET SAN FRANCISCO, CA 94110 BLOCK:3611 LOT:036

ISSUE:	DATE
PROJECT REVIEW	09.09.1
ISSUE FOR PERMIT	11.13.1
PLAN CHECK #1	03.13.2
REVISION 01	07.10.2

 DRAWN BY:
 1

 DATE:
 07.10.2

 SHEET TITLE:

TITLE 24

SHEET NUMBER:

A6.3

REV #: DATE:



	2016 Low-Rise Residential Mandatory Measures Summary
§ 150.0(m)13:	Duct System Sizing and Air Filter Grille Sizing. Space conditioning systems that use forced air ducts to supply cooling to an occupiable space must have a hole for the placement of a static pressure probe (HSPP) in the supply plenum. The space conditioning system must also demonstrate airflow ≥ 350 CFM per ton of nominal cooling capacity frough the return grilles, and an air-handling unit fan efficacy ≤ 0.58 W/CFM as confirmed by field verification and diagnostic testing, in accordance with Reference Residential Appendix RA3.3. This applies to both single zone central forced air systems and every zone for zonally controlled central forced air systems.
§150.0(o):	Ventilation for Indoor Air Quality, All dwelling units must meet the requirements of ASHRAE Standard 82.2. Neither window operation nor continuous operation of central forced air system air handlers used in central fan integrated ventilation systems are permissible methods of providing whole-building ventilation.
§ 150.0(o)1A:	Field Verification and Diagnostic Testing. Whole-building ventilation airflow must be confirmed through field verification and diagnostic testing, in accordance with Reference Residential Appendix RA3.7.
Pool and Spa Sys	stems and Equipment Measures:
§ 110.4(a):	Certification by Manufacturers. Any pool or spa heating system or equipment must be certified to have all of the following: a thermal efficiency that complies with the Appliance Efficiency Regulations; an on-off switch mounted outside of the heater that allows shutting off the heater without adjusting the thermostat setting; a permanent weatherproof plate or card with operating instructions; and must not use electric resistance heating.
§ 110.4(b)1:	Piping. Any pool or spa heating equipment must be installed with at least 36 inches of pipe between the filter and the heater, or dedicated suction and return lines, or built-in or built-up connections to allow for future solar heating.
§ 110.4(b)2:	Covers. Outdoor pools or spas that have a heat pump or gas heater must have a cover.
§ 110.4(b)3:	Directional inlets and time switches for pools. Pools must have directional inlets that adequately mix the pool water, and a time switch that will allow all pumps to be set or programmed to run only during off-peak electric demand periods.
§ 110.5:	Pilot Light. Natural gas pool and spa heaters must not have a continuously burning pilot light.
§ 150.0(p):	Pool Systems and Equipment Installation. Residential pool systems or equipment must meet the specified requirements for pump sizing, flow rate, piping, filters, and valves."
Lighting Measure	es:
§ 110.9:	Lighting Controls and Components. All lighting control devices and systems, ballasts, and luminaires must meet the applicable requirements of § 110.9.
§ 110.9(e):	JA8 High Efficacy Light Sources. To qualify as a JA8 high efficacy light source for compliance with § 150.0(k), a residential light source must be certified to the Energy Commission according to Reference Joint Appendix JA8.
§ 150.0(k)1A:	Luminaire Efficacy, All installed luminaires must be high efficacy in accordance with TABLE 150.0-A.
§ 150.0(k)1B:	Blank Electrical Boxes. The number of electrical boxes that are more than 5 feet above the finished floor and do not contain a luminaire or other device must be no greater than the number of bedrooms. These electrical boxes must be served by a dimmer, vacancy sensor control, or fan speed control.
§ 150.0(k)1C:	Recessed Downlight Luminaires in Ceilings. Luminaires recessed into ceilings must meet all of the requirements for insulation contact (IC) labeling, air leakage; sealing; maintenance; and socket and light source as described in § 150 (Ik) IC. A JA8-2016-E light source rated for elevated temperature must be installed by final inspection in all recessed downlight luminaires in ceilings.
§ 150.0(k)1D:	Electronic Ballasts. Ballasts for fluorescent lamps rated 13 watts or greater must be electronic and must have an output frequency no less than 20 kHz.
§ 150.0(k)1E:	Night Lights. Permanently installed night lights and night lights integral to installed luminaires or exhaust fans must be rated to consume no more than 5 watts of power per luminaire or exhaust fan as determined in accordance with § 130.0(c). Night lights do not need to be controlled by vacancy sensors.
§ 150.0(k)1F:	Lighting Integral to Exhaust Fans. Lighting integral to exhaust fans (except when installed by the manufacturer in kitchen exhaust hoods) must meet the applicable requirements of § 150.0(k)."
§ 150.0(k)1G:	Screw based luminaires. Screw based luminaires must not be recessed downlight luminaires in ceilings and must contain lamps that comply with Reference Joint Appendix JA8. Installed lamps must be marked with "JA8-2016" or "JA8-2016-E" as specified in Reference Joint Appendix JA8."
§ 150.0(k)1H:	Enclosed Luminaires. Light sources installed in enclosed luminaires must be JA8 compliant and must be marked with "JA8-2016-E."
§ 150.0(k)2A:	Interior Switches and Controls. All forward phase cut dimmers used with LED light sources must comply with NEMA SSL 7A.

Interior Switches and Controls. Luminaires must be switched with readily accessible controls that permit the luminaires to be manually switched ON and OFF.

Interior Switches and Controls. No control must bypass a dimmer or vacancy sensor function if the control is installed to comply with

Interior Switches and Controls. No control must bypass a dimmer or vacancy sensor function if the control is installed to comply with § 150.0(k).

Interior Switches and Controls. Lighting controls must comply with the applicable requirements of § 110.9.

Interior Switches and Controls. An energy management control system (EMCS) may be used to comply with dimmer requirements if it: functions as a dimmer according to § 110.9, meets the Installation Certificate requirements of § 130.4, meets the EMCS requirements of § 130.5(f), and meets all other requirements in § 150.0(k).

Interior Switches and Controls. An EMCS may be used to comply with vacancy sensor requirements in § 150.0(k) if it meets all of the following: It functions as a vacancy sensor according to § 110.9, the Installation Certificate requirements of § 130.4, the EMCS requirements of § 130.5(f), and all other requirements in § 150.0(k).

Interior Switches and Controls. A multiscene programmable controller may be used to comply with dimmer requirements in § 150.0(k).

Interior Switches and Controls. A multiscene programmable controller may be used to comply with dimmer requirements in § 150.0(k).

Interior Switches and Controls. Controls and equipment must be installed in accordance with manufacturer's instructions.

provides the functionality of a dimmer according to § 110.9, and complies with all other applicable requirements in § 150.0(k)2.

§ 150.0(k)2B: Interior Switches and Controls. Exhaust fans must be switched separately from lighting systems.*



§ 150.0(k)2I:

§ 150.0(k)2C:

§ 150.0(k)2D:

§ 150.0(k)2E:

§ 150.0(k)2F:

	Interior Switches and Controls. In bathrooms, garages, laundry rooms, and utility rooms, at least one luminaire in each of these spaces must
§ 150.0(k)2J:	be controlled by a vacancy sensor.
§ 150.0(k)2K:	Interior Switches and Controls. Dimmers or vacancy sensors must control all luminaires required to have light sources compliant with Reference Joint Appendix JAB, except luminaires in closets less than 70 square feet and luminaires in hallways."
§ 150.0(k)2L:	Interior Switches and Controls. Undercabinet lighting must be switched separately from other lighting systems.
§ 150.0(k)3A:	Residential Outdoor Lighting. For single-family residential buildings, outdoor lighting permanently mounted to a residential building, or to other buildings on the same lot, must meet the requirement in item § 150.0(k)3Aii (DN and OFF switch) and the requirements in either item § 150.0(k)3Aii (photocell and motion sensor) or item § 150.0(k)3Aii (photo control and automatic time switch control, astronomical time clock, or EMCS).
§ 150.0(k)3B:	Residential Outdoor Lighting, For low-rise multifamily residential buildings, outdoor lighting for private patios, entrances, balconies, and porches; and outdoor lighting for residential parking lots and residential carports with less than eight vehicles per site must comply with either § 150 (b)(3) Ar with the applicable requirements in §§ 1109, 1300, 1302, 1304, 140.7 and 141.0.
§ 150.0(k)3C:	Residential Outdoor Lighting. For low-rise residential buildings with four or more dwelling units, outdoor lighting not regulated by § 150.0(k)3B or § 150.0(k)3D must comply with the applicable requirements in §§ 110.9, 130.0, 130.2, 130.4, 140.7 and 141.0.
§ 150.0(k)3D:	Residential Outdoor Lighting. Outdoor lighting for residential parking lots and residential carports with a total of eight or more vehicles per site must comply with the applicable requirements in §§ 110.9, 130.0, 130.2, 130.4, 140.7, and 141.0.
§ 150.0(k)4:	Internally illuminated address signs. Internally illuminated address signs must comply with § 140.8; or must consume no more than 5 watts of power as determined according to § 130.0(c).
§ 150.0(k)5:	Residential Garages for Eight or More Vehicles. Lighting for residential parking garages for eight or more vehicles must comply with the applicable requirements for nonresidential garages in §§ 110.9, 130.0, 130.1, 130.4, 140.6, and 141.0.
§ 150.0(k)6A:	Interior Common Areas of Low-rise Multi-Family Residential Buildings. In a low-rise multifamily residential building where the total interior common area in a single building equals 20 percent or less of the floor area, permanently installed lighting for the interior common areas in that building must be high efficacy furniaries and controlled by an occupant sensor.
§ 150.0(k)6B:	Interior Common Áreas of Low-rise Multi-Family Residential Buildings. In a low-rise multifamily residential building where the total interior common area in a single building equals more than 2 operation of the floor area, permanenly installed lighting in that building must: i. Comply with the applicable requirements in §§ 110.9, 130.0, 130.1, 140.6 and 141.0, and ii. Lighting installed in corridors and stainveils must be controlled by occupant sensors that reduce the lighting power in each space by at least 50 percent. The occupant sensors must be capable for furning the light fluy on and off from all designed paths of ingress and egress.
Solar Ready Bui	ldings:
§ 110.10(a)1:	Single Family Residences. Single family residences located in subdivisions with ten or more single family residences and where the application for a tentative subdivision map for the residences has been deemed complete by the enforcement agency must comply with the requirements of \$1.10.10(b) through \$1.10.10(c).
§ 110.10(a)2:	Low-rise Multi-family Buildings. Low-rise multi-family buildings must comply with the requirements of § 110.10(b) through § 110.10(d).
§ 110.10(b)1:	Minimum Area. The solar zone must have a minimum total area as described below. The solar zone must comply with access, pathway, smoke ventilation, and spacing requirements as specified in Title 24, Part 9 or other Parts of Title 24 or in any requirements adopted by a local jurisdiction. The solar zone total area must be comprised of areas that have no dimension less than 15 read are no less than 80 square feet each for buildings with roof areas less than or equal to 10,000 square feet each for buildings with or of areas greater than 10,000 square feet. For single family residences the solar zone must be located on the roof or overhang of the building and have a total area no less than 250 square feet. For on-rise multi-family buildings the solar zone must be located on the roof or overhang of the building, or on the roof or overhang of the building, or on the roof or overhang of the building, or on the roof or overhang of the building, or on the roof or overhang of the building, or on the roof or overhang of the building, or on the roof or overhang of the building project, and have a total area no less than 15 percent of the total roof area of the building excluding any skylight area.
§ 110.10(b)2:	Orientation. All sections of the solar zone located on steep-sloped roofs must be oriented between 110 degrees and 270 degrees of true north.
§ 110.10(b)3A:	Shading. The solar zone must not contain any obstructions, including but not limited to: vents, chimneys, architectural features, and roof mounted equipment."
§ 110.10(b)3B:	Shading. Any obstruction located on the roof or any other part of the building that projects above a solar zone must be located at least twice the distance, measured in the horizontal plane, of the height difference between the highest point of the obstruction and the horizontal projection of the nearest point of the solar zone, measured in the vertical plane.
§ 110.10(b)4:	Structural Design Loads on Construction Documents. For areas of the roof designated as solar zone, the structural design loads for roof dead load and roof live load must be clearly indicated on the construction documents.
§ 110.10(c):	Interconnection Pathways. The construction documents must indicate: a location for inverters and metering equipment and a pathway for routing of conduit from the solar zone to the point of interconnection with the electrical service (for single family residences the point of interconnection will be the main service panel); and a pathway for routing of plumbing from the solar zone to the water-healing system.
§ 110.10(d):	Documentation. A copy of the construction documents or a comparable document indicating the information from § 110.10(b) through § 110.10(c) must be provided to the occupant.
§ 110.10(e)1:	Main Electrical Service Panel. The main electrical service panel must have a minimum busbar rating of 200 amps.
§ 110.10(e)2:	Main Electrical Service Panel. The main electrical service panel must have a reserved space to allow for the installation of a double pole circui breaker for a future solar electric installation. The reserved space must be; positioned at the opposite (load) end from the input feeder location or



2016 Low-Rise Residential Mandatory Measures Summary

NOTE: Low-rise residential buildings subject to the Energy Standards must comply with all applicable mandatory measures, regardless of the compliance approach used. Review the respective section for more information. "Exceptions may apply.

(Original 08/201	6)
Building Envel	ope Measures:
§ 110.6(a)1:	Air Leakage. Manufactured fenestration, exterior doors, and exterior pet doors must limit air leakage to 0.3 cfm/ff or less when tested per NFRC-400 or ASTM E283 or AAMA/WDMA/CSA 101/I.S.2/A440-2011.*
§ 110.6(a)5:	Labeling. Fenestration products must have a label meeting the requirements of § 10-111(a).
§ 110.6(b):	Field fabricated exterior doors and fenestration products must use U-factors and solar heat gain coefficient (SHGC) values from TABLES 110.6-A and 110.6-B for compliance and must be caulked and/or weatherstripped."
§ 110.7:	Air Leakage. All joints, penetrations, and other openings in the building envelope that are potential sources of air leakage must be caulked, gasketed, or weather stripped.
§ 110.8(a):	Insulation Certification by Manufacturers. Insulation specified or installed must meet Standards for Insulating Material.
§ 110.8(g):	Insulation Requirements for Heated Slab Floors. Heated slab floors must be insulated per the requirements of § 110.8(g).
§ 110.8(i):	Roofing Products Solar Reflectance and Thermal Emittance. The thermal emittance and aged solar reflectance values of the roofing material must meet the requirements of § 110.8(i) when the installation of a cool roof is specified on the CF1R.
§ 110.8(j):	Radiant Barrier. A radiant barrier must have an emittance of 0.05 or less and be certified to the Department of Consumer Affairs.
§ 150.0(a):	Ceiling and Rafter Roof Insulation. Minimum R-22 insulation in wood-frame ceiling, or the weighted average U-factor must not exceed 0.043. Minimum R-19 or weighted average U-factor of 0.054 or less in a rafter roof alteration. Aftic access doors must have permanently attracted insulation using adhesive or mechanical fasteners. The aftic access must be gaskedet to prevent air leakage, insulation must be installed in direct contact with a continuous roof or ceiling which is sealed to limit infiltration and extilitration as specified in § 110.7, including but not limited to placing insulation either above or below the roof deck or on top of a drywall ceiling.
§ 150.0(b):	Loose-fill Insulation. Loose fill insulation must meet the manufacturer's required density for the labeled R-value.
§ 150.0(c):	Wall Insulation. Minimum R-13 insulation in 2x4 inch wood framing wall or have a U-factor of 0.102 or less (R-19 in 2x6 or U-factor of 0.074 or less). Opaque non-framed assemblies must have an overall assembly U-factor not exceeding 0.102, equivalent to an installed value of R-13 in a wood framed assembly."
§ 150.0(d):	Raised-floor Insulation. Minimum R-19 insulation in raised wood framed floor or 0.037 maximum U-factor.*
§ 150.0(f):	Slab Edge Insulation. Slab edge insulation must meet all of the following; have a water absorption rate, for the insulation material alone without facings, no greater han 0.3%; have a water vapor permeance no greater han 2.0 permitnich; be protected from physical damage and UV light deterioration; and when installed as part of a heated slab floor, meet the requirements of \$110.8(q).
§ 150.0(g)1:	Vapor Retarder. In Climate Zones 1-16, the earth floor of unvented crawl space must be covered with a Class I or Class II vapor retarder. This requirement also applies to controlled ventilation crawl space for buildings complying with the exception to § 150.0(d).
§ 150.0(g)2:	Vapor Retarder. In Climate Zones 14 and 16, a Class I or Class II vapor retarder must be installed on the conditioned space side of all insulation in all exterior walls, vented attics, and unvented attics with air-permeable insulation.
§ 150.0(q):	Fenestration Products. Fenestration, including skylights, separating conditioned space from unconditioned space or outdoors must have a maximum U-factor of 0.58; or the weighted average U-factor of all fenestration must not exceed 0.58.
Fireplaces, Dec	corative Gas Appliances, and Gas Log Measures:

§ 150.0(e)1A:	Closable Doors. Masonry or factory-built fireplaces must have a closable metal or glass door covering the entire opening of the firebox.
§ 150.0(e)1B:	Combustion Intake. Masonry or factory-built fireplaces must have a combustion outside air intake, which is at least six square inches in area and is equipped with a readily accessible, operable, and tight-fitting damper or combustion-air control device."
§ 150.0(e)1C:	Flue Damper. Masonry or factory-built fireplaces must have a flue damper with a readily accessible control.*
§ 150.0(e)2:	Pilot Light. Continuous burning pilot lights and the use of indoor air for cooling a firebox jacket, when that indoor air is vented to the outside of the building, are prohibited.
Space Conditioni	ng, Water Heating, and Plumbing System Measures:
§ 110.0-§ 110.3:	Certification. Heating, ventilation and air conditioning (HVAC) equipment, water heaters, showerheads, faucets, and all other regulated appliances must be certified by the manufacturer to the Energy Commission.
§ 110.2(a):	HVAC Efficiency. Equipment must meet the applicable efficiency requirements in TABLE 110.2-A through TABLE 110.2-K."
§ 110.2(b):	Controls for Heat Pumps with Supplementary Electric Resistance Heaters. Heat pumps with supplementary electric resistance heaters must have controls that prevent supplementary heater operation when the heating load can be met by the heat pump alone; and in which the cut-on temperature for compression heating is higher than the cut-on temperature for supplementary heating, and the cut-off temperature for compression heating is higher than the cut-off temperature for supplementary heating.
§ 110.2(c):	Thermostats. All unitary heating or cooling systems not controlled by a central energy management control system (EMCS) must have a setback thermostat."

selback thermostat.*

Water Heating Recirculation Loops Serving Multiple Dwelling Units. Water heating recirculation loops serving multiple dwelling units must meet the air release valve, backflow prevention, pump priming, pump isolation valve, and recirculation loop connection requirements of § 110.3(c)S.

Isolation Valves. Instantaneous water heaters with an input rating greater than 6.8 kBTU/hr (2 kW) must have isolation valves with hose bibbs or other fittings on both cold water and hot water lines of water heating systems to allow for water tank flushing when the valves are closed. Pilot Lights. Continuously burning plot lights are prohibited for natural gas: flan-type entral flumness: household cooking applicances without an electrical supply voltage connection with pilot lights that consume less than 150 Btu/hr are exempt); and pool and spa heaters.*

Building Cooling and Heating Loads. Heating and/or cooling loads are calculated in accordance with ASHRAE Handbook, Equipment Volume, Applications Volume, and Fundamentials Volume; SMACNA Residential Comfort System Installation Standards Menual; or ACCA Manual J using design conditions specified in § 150.0(h)2. § 110.3(c)5: § 110.3(c)7: § 110.5:



2016 Low-Rise Residential Mandatory Measures Summary

	2016 Low-Rise Residential Mandatory Measures Summary
0.450.00.104	Clearances, Installed air conditioner and heat pump outdoor condensing units must have a clearance of at least 5 feet from the outlet of any
§ 150.0(h)3A:	dryer vent.
§ 150.0(h)3B:	Liquid Line Drier. Installed air conditioner and heat pump systems must be equipped with liquid line filter driers if required, as specified by manufacturer's instructions.
§ 150.0(j)1:	Storage Tank Insulation. Unfired hot water tanks, such as storage tanks and backup storage tanks for solar water-heating systems, must have R-12 external insulation or R-16 internal insulation where the internal insulation R-value is indicated on the exterior of the tank.
§ 150.0(j)2A:	Water piping and cooling system line insulation. For domestic hot water system piping, whether burned or unburned, all of the following must be insulated according to the requirements of TABLE 120.3-4. the first 5 feet of hot and cold water pipes from the storage tank; all piping with a nominal diameter of 3/4 inch or larger; all piping associated with a domestic hot water recirculation system regardless of the pipe diameter; piping from the heating source to storage tank or between tanks; piping buried below grade; and all hot water pipes from the heating source to kitchen fixtures.
§ 150.0(j)2B:	Water piping and cooling system line insulation. All domestic hot water pipes that are buried below grade must be installed in a water proof and non-crushable casing or sleeve."
§ 150.0(j)2C:	Water piping and cooling system line insulation. Pipe for cooling system lines must be insulated as specified in § 150.0(j)2A. Distribution piping for steam and hydronic heating systems or hot water systems must meet the requirements in TABLE 120.3-A.*
§ 150.0(j)3:	Insulation Protection. Insulation must be protected from damage, including that due to sunlight, moisture, equipment maintenance, and wind.
§ 150.0(j)3A:	Insulation Protection. Insulation exposed to weather must be installed with a cover suitable for outdoor service. For example, protected by aluminum, sheet metal, painted canvas, or plastic cover. The cover must be water retardant and provide shielding from solar radiation that can cause degradation of the materials.
§ 150.0(j)3B:	Insulation Protection. Insulation covering chilled water piping and refrigerant suction piping located outside the conditioned space must have a Class I or Class II vapor retarder.
§ 150.0(n)1:	Gas or Propane Systems. Systems using gas or propane water heaters to serve individual dwelling units must include all of the following: a 120V electrical receptate within 3 feet of the water heater; a Category III or I Vent. or 3 Type B vent with straight pipe between the uside termination and the space where the water heater is installed; a condensate drain that is no more than 2 inches higher than the base of the water heater; and allows natural draining without pumps assistance; and a gas supply line with a capacity of at feast 200,000 B Stuft."
§ 150.0(n)2:	Recirculating Loops. Recirculating loops serving multiple dwelling units must meet the requirements of § 110.3(c)5.
§ 150.0(n)3:	Solar Water-heating Systems. Solar water-heating systems and collectors must be certified and rated by the Solar Rating and Certification Corporation (SRCC) or by a listing agency that is approved by the Executive Director.
Ducts and Fans	Measures:
§ 110.8(d)3:	Ducts. Insulation installed on an existing space-conditioning duct must comply with § 604.0 of the California Mechanical Code (CMC). If a contractor installs the insulation, the contractor must certify to the customer, in writing, that the insulation meets this requirement.
§ 150.0(m)1:	CMC Compliance. All air-distribution system ducts and plenums must be installed, sealed, and insulated to meet the requirements of CMC §8 610., 60.20, 60.30, 60.40, 60.50 and ANSIISMACNA-00.6-2000 HAVE DUC construction Standards Metal and Flexible 3rd Edition. Portion of supply-air and return-air ducts and plenums must be insulated to a minimum installed level of R-6.0 or higher if required by CMC § 605.0) or a minimum installed level of R-4.2 when entirely in conditioned space as confirmed through field verification and diagnostic testing (RA3.14.38). Connections of metal ducts and inner orcor of flexible ducts must be mechanically fastened, Openings must be sealed with mastic, tape, or other duct-closure system that meets the applicable requirements of UL 181, UL 1814, or UL 1819 or serosol sealant that meets the requirements of UL 1723. If mastic or tape is used to seal openings greater than V, inch, the combination of mastic and either meets the applicable requirements of UL 181, UL 1814, or UL 1819 or serosol sealant that apper must be used. Building cavities, support platforms for air handlers, and plenums designed or constructed with materials other than sealed sheet metal, duct board or flexible duct must not be used for conveying conditioned air. Building cavities and support platforms must not be compressed to cause reductions in the cross-sectional area of the ducts.
§ 150.0(m)2:	Factory-Fabricated Duct Systems. Factory-fabricated duct systems must comply with applicable requirements for duct construction, connections, and closures; joints and series of duct systems and their components must not be sealed with cloth back rubber adhesive duct tapes unless such tape is used in combination with mastic and draw bands.
§ 150.0(m)3:	Field-Fabricated Duct Systems. Field-fabricated duct systems must comply with applicable requirements for: pressure-sensitive tapes, mastics, sealants, and other requirements specified for duct construction.
§ 150.0(m)7:	Backdraft Dampers. All fan systems that exchange air between the conditioned space and the outside of the building must have backdraft or automatic dampers.
§ 150.0(m)8:	Gravity Ventilation Dampers. Gravity ventilating systems serving conditioned space must have either automatic or readily accessible, manually operated dampers in all openings to the outside, except combustion inlet and outlet air openings and elevator shaft vents.
§ 150.0(m)9:	Protection of Insulation. Insulation must be protected from damage, including that due to sunlight, moisture, equipment maintenance, and wind. Insulation exposed to weather must be suitable for outdoor service. For example, protected by aluminum, sheet metal, painted cannas, or plastic cover. Cellular foam insulation must be protected as above or painted with a coating that is water retardant and provides shielding from

§ 150.0(m)10: Porous Inner Core Flex Duct. Porous inner core flex duct must have a non-porous layer between the inner core and outer vapor barrier.

Perous inner Core Fiex Duct: Procus mer core liex duct must nave a non-procus layer between the inner core and out evapor barner. Duct System Sealing and Leaker Fest. When space conditioning systems use forced air duct systems to supply conditioned air to an occupiable space, the ducts must be sealed and duct leakage tested, as confirmed through field verification and diagnostic testing, in accordance with § 150.0(m)/1 and Reference Residential Appendix Rs. Rs.

Air Filtration. Mechanical systems that supply air to an occupiable space through ductwork exceeding 10 feet in length and through a thermal conditioning component, except evaporative coolers, must be provided with air filter devices that meet the design, installation, efficiency, pressure drop, and labeling requirements of § 150.0(m)/12.





628 SHOTWELL STREET LLC

INTERIOR **ALTERATION**

628 SHOTWELL STREET SAN FRANCISCO, CA 94110 BLOCK:3611 LOT:036

ISSUE:	DATE:
PROJECT REVIEW	09.09.19
ISSUE FOR PERMIT	11.13.19
PLAN CHECK #1	03.13.20
REVISION 01	07.10.20


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1	DRAWN BY:	
ı	DATE:	07.10
П	SHEET TITLE:	

TITLE 24

SHEET NUMBER:

A6.4

DATE:

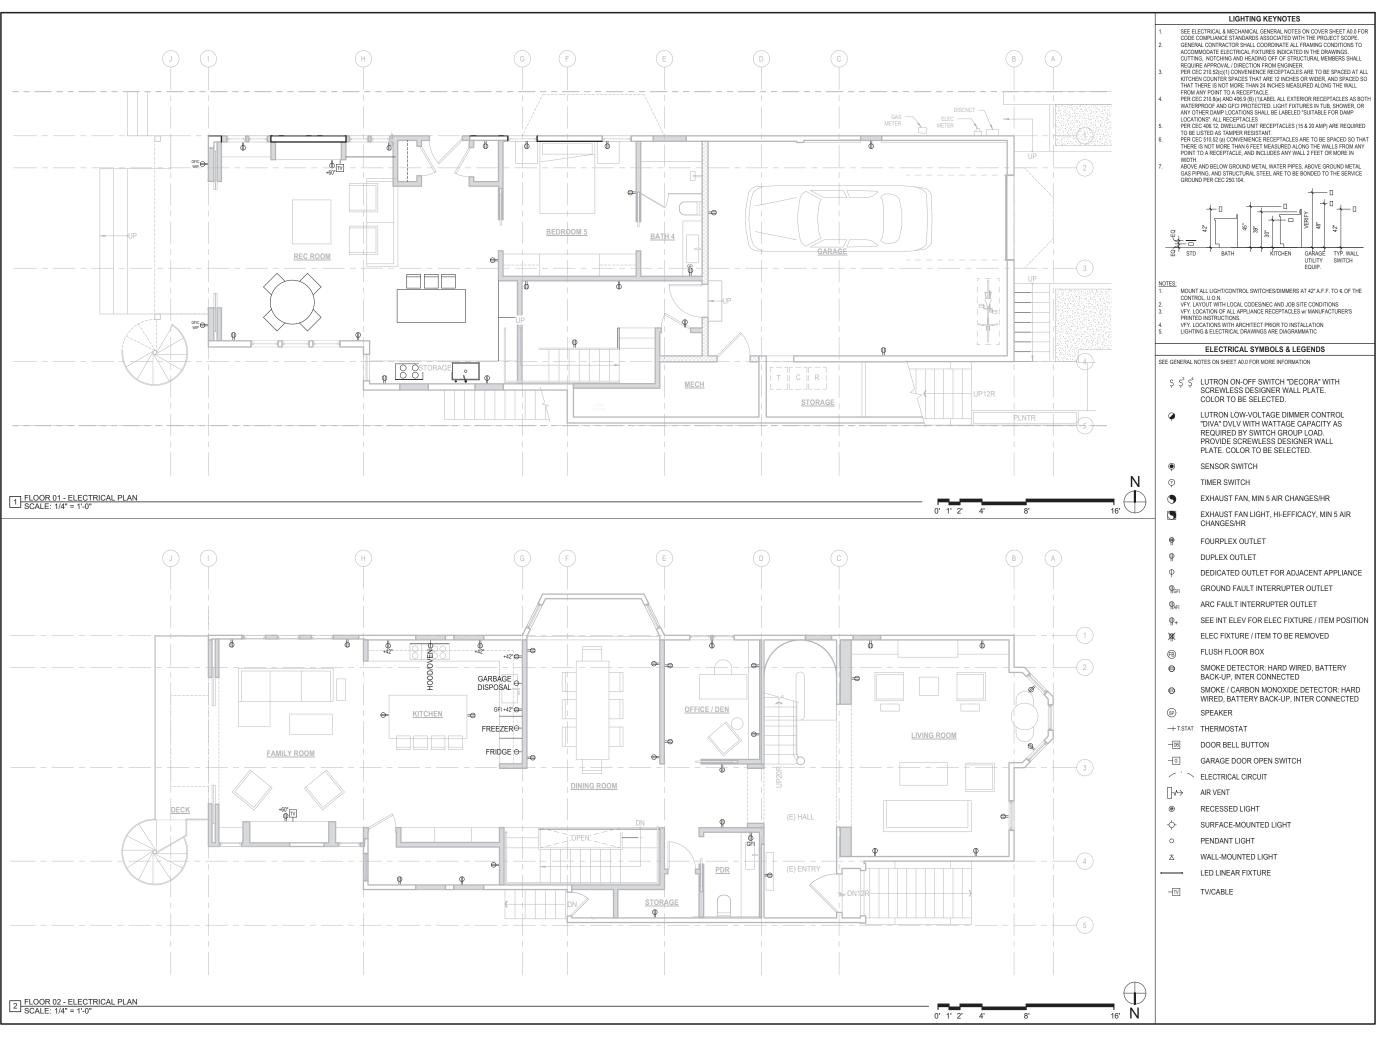



PEAR STREET SAN FRANCISCO, CALIFORNIA P:(415)543-5005 F:(415)495-3338



628 SHOTWELL STREET LLC

INTERIOR ALTERATION

628 SHOTWELL STREET SAN FRANCISCO, CA 94110 BLOCK:3611 LOT:036

PROJECT REVIEW

DATE:

09.09.19

SUE FOR PERMIT	11.13.19


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DATE:	07.10.20
SHEET TITLE:	

ELECTRICAL PLAN

SHEET NUMBER:

E1.1

REV #: DATE:

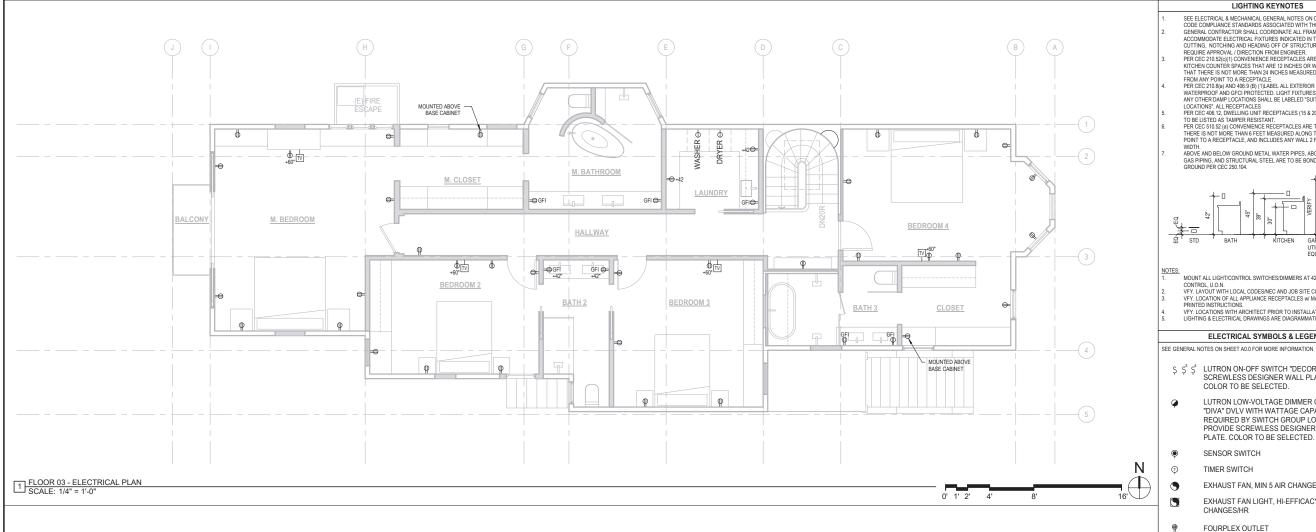


LIGHTING KEYNOTES

- SEE ELECTRICAL & MECHANICAL GENERAL NOTES ON COVER SHEET A0.0 FOR CODE COMPLIANCE STANDARDS ASSOCIATED WITH THE PROJECT SCOPE. CODE COMPLIANCE STANDARDS ASSOCIATED WITH THE PROJECT SCOPE.

 GENERAL CONTRACTOR SHALL COORDINATE ALL FRAMING CONDITIONS TO ACCOMMODATE ELECTRICAL FIXTURES INDICATED IN THE DRAWINGS. CUTTING, NOTCHING AND HEADING OFF OF STRUCTURAL MEMBERS SHALL
- CUITING, NOTCHING AND HEADING OFF OF STRUCTURAL MEMBERS SHALL REQUIRE APPROVAL DIRECTION FROM ENDIRECT PROPERTIES. THE RECEIVED AND STRUCTURE OF THE STRUCTURE OF THE STRUCTURE OF THE RECEIVED AND STRUCTURE OF THE STRUCTURE OF THE

- WIDTH: ABOVE AND BELOW GROUND METAL WATER PIPES, ABOVE GROUND METAL GAS PIPING, AND STRUCTURAL STEEL ARE TO BE BONDED TO THE SERVICE GROUND PER CEC 250.104.

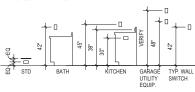

- MOUNT ALL LIGHT/CONTROL SWITCHES/DIMMERS AT 42" A.F.F. TO € OF THE
- WOUNT ALL LIGHTNOOTH AND CONTROL LYON.
 VFY. LAYOUT WITH LOCAL CODESINEC AND JOB SITE CONDITIONS
 VFY. LOCATION OF ALL APPLIANCE RECEPTACLES W MANUFACTURERS

ELECTRICAL SYMBOLS & LEGENDS

- \$ \$\$ \$4 LUTRON ON-OFF SWITCH "DECORA" WITH SCREWLESS DESIGNER WALL PLATE. COLOR TO BE SELECTED.
- LUTRON LOW-VOLTAGE DIMMER CONTROL "DIVA" DVLV WITH WATTAGE CAPACITY AS REQUIRED BY SWITCH GROUP LOAD. PROVIDE SCREWLESS DESIGNER WALL PLATE. COLOR TO BE SELECTED.
- SENSOR SWITCH
- TIMER SWITCH
- EXHAUST FAN, MIN 5 AIR CHANGES/HR
- EXHAUST FAN LIGHT, HI-EFFICACY, MIN 5 AIR CHANGES/HR
- FOURPLEX OUTLET
- DEDICATED OUTLET FOR ADJACENT APPLIANCE
- Φ_{GFI} GROUND FAULT INTERRUPTER OUTLET
- Φ_{AFI} ARC FAULT INTERRUPTER OUTLET
- SEE INT ELEV FOR ELEC FIXTURE / ITEM POSITION
- ELEC FIXTURE / ITEM TO BE REMOVED 漱
- FLUSH FLOOR BOX €B
- SMOKE DETECTOR: HARD WIRED, BATTERY 0 BACK-UP, INTER CONNECTED
- SMOKE / CARBON MONOXIDE DETECTOR: HARD WIRED, BATTERY BACK-UP, INTER CONNECTED
- (SP) SPEAKER

+T.STAT THERMOSTAT

—DB DOOR BELL BUTTON

-G GARAGE DOOR OPEN SWITCH

 \nearrow ELECTRICAL CIRCUIT

AIR VENT

RECESSED LIGHT

ф-SURFACE-MOUNTED LIGHT

PENDANT LIGHT

WALL-MOUNTED LIGHT

LED LINEAR FIXTURE

-TV TV/CABLE





628 SHOTWELL STREET LLC

INTERIOR **ALTERATION**

628 SHOTWELL STREET SAN FRANCISCO, CA 94110 BLOCK:3611 LOT:036

09.09.19

PROJECT REVIEW

ISSUE FOR PERMIT

DRAWN BY:	TL
DATE:	07.10.20
SHEET TITLE:	
	,

ELECTRICAL PLAN

SHEET NUMBER:

REV #:



HTA!
HOOD THOMAS ARCHITECTS

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628 SHOTWELL STREET LLC

INTERIOR ALTERATION

628 SHOTWELL STREET SAN FRANCISCO, CA 94110 BLOCK:3611 LOT:036

DATE:

PROJECT REVIEW	09.09.19
ISSUE FOR PERMIT	11.13.19

 DRAWN BY:
 TL

 DATE:
 07.10.20


 SHEET TITLE:

LIGHTING PLAN

SHEET NUMBER:

E2.1

EV #: DATE:

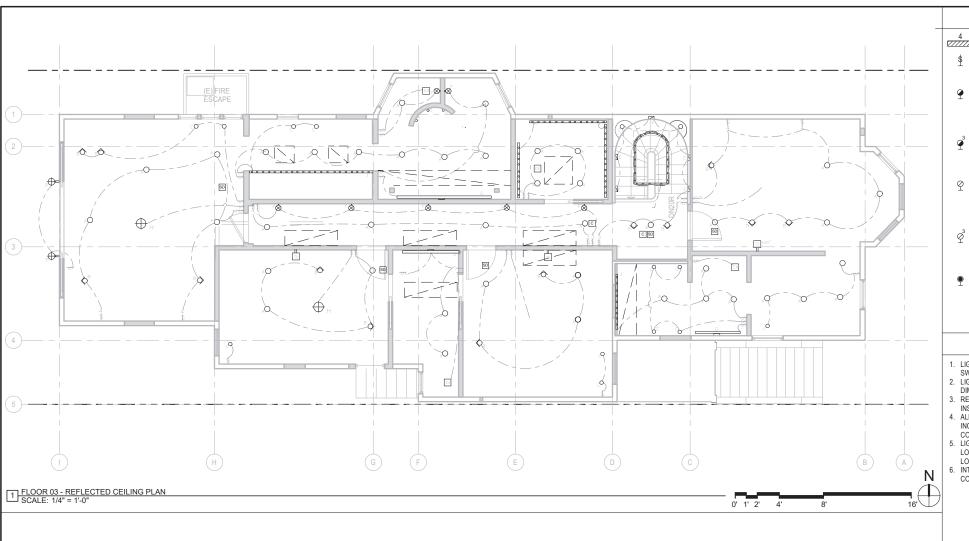

LIGHTING SYMBOL LEGEND

LUTRON ON-OFF SWITCH "DECORA" WITH SCREWLESS DESIGNER WALL PLATE. COLOR TO BE SELECTED.

LUTRON LOW-VOLTAGE DIMMER CONTROL "DIVA" DVLV WITH WATTAGE CAPACITY AS REQUIRED BY SWITCH GROUP LOAD.
PROVIDE SCREWLESS DESIGNER WALL

DENOTES DIMING CONTROL PANEL NUMBER

3 WAY LOW VOLTAGE DIMMER, LUTRON, "DIVA" WATTAGE CAPACITY AS REQ'D BY SWITCH GROUP LOAD PROVIDE SCREWLESS WALLPLATE COLOR TO BE SELECTED.

PLATE. COLOR TO BE SELECTED.

LUTRON "DIVA" DV LINE VOLTAGE DIMMER CONTROL WITH WATTAGE CAPACITY AS REQUIRED BY SWITCH GROUP LOAD. PROVIDE SCREWLESS DESIGNER WALL PLATE. COLOR TO BE SELECTED

3 WAY LOW VOLTAGE DIMMER, LUTRON, "DIVA" DV w/ WATTAGE CAPACITY AS REQ'D BY SWITCH GROUP LOAD PROVIDE SCREWLESS WALLPLATE COLOR TO BE SELECTED.

LUTRON LINE/LOW VOLTAGE OCCUPANCY SENSOR SWITCH (MUST MEET CURRENT CCR T-24 STANDARDS), PROVIDE SCREWLESS DESIGNER WALL PLATE. COLOR TO BE SELECTED.

© SPEAKER

CEILING MOUNTED SUPPLY DIFFUSER FOR WHOLE HOUSE AIR CIRCULATION

✓ * ✓ ELECTRICAL CIRCUIT

SWITCHING GROUP

30 MINUTE TIMER SWITCH

EXHAUST FAN, MIN 5 AIR CHANGES/HR

SMOKE DETECTOR, 110V. INTERCONNECTED W/ BATTERY BACK UP

CARBON MONOXIDE / SMOKE DETECTOR, 110V, INTERCONNECTED W/ BATTERY BACK UP

CONTROL FOR SPEAKERS

DECKHEATER ABOVE LINE VOLTAGE OUTDOOR HEATER





SHEET NOTES **DIVISION 16 - ELECTRICAL**

LIGHT IN BATHS, STORAGE AND UTILITY ROOMS TO BE SWITCHED WITH OCCUPANCY SENSORS. LIGHT IN ALL AREAS, OTHER THAN ABOVE TO HAVE

DIMMERS. RECESSED FIXTURES TO BE "ZERO CLEARANCE

INSULATION COVER IC' APPROVED AT INSULATED AREAS ALL CLOTHES CLOSET LAMPS SHALL BE ENCLOSED IF INCANDESCENT TYPE. LIGHT FIXTURE CLEARANCES SHALL

CONFORM TO CEC 410-8

5. LIGHT FIXTURES IN TUB. SHOWER, OR ANY OTHER DAMP LOCATIONS SHALL BE LABELED "SUITABLE FOR DAMP LOCATIONS"

INTERIOR NON-HIGH EFFICACY LIGHT FIXTURES TO BE CONTROLLED BY DIMMER SWITCHES, TYP

16.1 PROVIDE APPROVED SMOKE DETECTORS LOCATED

IN CORRIDORS AND HALLWAYS GIVING ACCESS TO BEDROOMS AND IN EACH BEDROOM. ALL FLOORS INCLUDING BASEMENTS MUST HAVE SMOKE DETECTORS PER UBC 310.9. 16.2 PRIMARY LIGHTING IN BATHROOM SHALL BE

CONNECTED TO A DIMMER SWITCH WITH AN OCCUPANT SENSOR DETECTOR PER CCR TITLE 24. PROVIDE (N) DOORBELL IN (N) LOCATION TO (2) CHIMES AS INDICATED ON PLAN.

16.4 BATHROOM FLOOR RADIANT HEAT SHALL BE ELECTRIC RESISTANCE TYPE ELECTRIC COILS EMBEDDED IN TILE SETTING BED. PROVIDE THERMOSTATIC CONTROLS IN AN ACCESSIBLE

LOCATION.

16.5 (N) INTERCOMPHONE TO FRONT DESK. PROVIDE ALL POWER/LOW VOLTAGE AS REQUIRED TO COORDINATE WITH (E) SYSTEM.

16.6 NEW LIGHTING FIXTURES IN ELEVATOR VESTIBULE TO BE INTERCONNECTED TO BLDG (HOUSE ELEC. REQUIRED AND GIVE NOTICE TO UNIT BELOW AND UNIT ABOVE PRIOR TO CONVENING WORK.

628 SHOTWELL STREET LLC

INTERIOR **ALTERATION**

628 SHOTWELL STREET SAN FRANCISCO, CA 94110 BLOCK:3611 LOT:036

ISSUE:

PROJECT REVIEW

11.13.19

DATE: SHEET TITLE:

PLAN

LIGHTING

SHEET NUMBER:

	LIGHTING SCHEDULE		
OA	RECESSED LED ADJUSTABLE DOWNLIGHT FIXTURE. 4" TRIM/HOUSING		
ОВ	RECESSED LED WALL WASH FIXITURE - 4" TRIM/HOUSING		
Oc	RECESSED LENSED LED FIXTURE. 2" TRIM/HOUSING -WET LOCATIONS		
OD	RECESSED LENSED LED FIXTURE. 1" TRIM/HOUSING -WET LOCATIONS		
□ E	RECESSED WALL MOUNTED LED FIXTURE.		
-∰F	WALL MOUNTED LED SCONCE FIXTURE		
— G	WALL MOUNTED LED VANITY FIXTURE		
Фн	CEILING MOUNTED LED PENDANT FIXTURE		
10 0 0 0 J	LED STRIP FIXTURE IN RECESSED COVE		
10 0 0 0 K	LED STRIP FIXTURE - UNDER CABINET		
⊕ L	CEILING MOUNTED STRIP FLUORESCENT FIXTURE		
М	CEILING MOUNTED LED FIXTURE		
N N	TRACK AND TRACK FIXTURES		
⊕ P	LED WALL MOUNTED LIGHTS		
O R	LED RECESSED LIGHTS - WET LOCATION		
⊠s	LED RECESSED STEP LIGHTS - WET LOCATION		
÷ L1	LOW VOLTAGE LANDSCAPE LIGHTS		
ф L2	LOW VOLTAGE LANDSCAPE LIGHTS		
ф L3	LOW VOLTAGE LANDSCAPE LIGHTS		

LICHTING COLIEDING



49 South Van Ness Avenue, Suite 1400 San Francisco, CA 94103 628.652.7600 www.sfplanning.org

CEQA Categorical Exemption Determination

PROPERTY INFORMATION/PROJECT DESCRIPTION

Project Address			Block/Lot(s)	
628 SHOTWELL ST			3611036	
Case No.			Permit No.	
2019-022661PRJ			201911197709	
	ldition/ teration	Demolition (requires HRE for Category B Building)	New Construction	
Project description for Planning Department approval. Interior alteration to remodel existing fire damaged single family home. Proposed scope includes new foundation and excavation to increase ceiling height and seismic upgrade. Addition of a new rear deck.				
The p	CEQA).	etermined to be categorically exempt under the		
The p	project has been d CEQA).			
The p	oroject has been d CEQA). Class 1 - Existin Class 3 - New Co	g Facilities. Interior and exterior alterations; addit onstruction. Up to three new single-family resider reial/office structures; utility extensions; change of	ions under 10,000 sq. ft.	
The p	Class 1 - Existin Class 3 - New Combuilding; commented or with Class 32 - In-Fill 10,000 sq. ft. and (a) The project is policies as well at (b) The proposed substantially surrous (c) The project set (d) Approval of the water quality. (e) The site can	g Facilities. Interior and exterior alterations; addit onstruction. Up to three new single-family resider reial/office structures; utility extensions; change of	ions under 10,000 sq. ft. Inces or six dwelling units in one Tuse under 10,000 sq. ft. if principally Inces or six dwelling units in one Tuse under 10,000 sq. ft. if principally Ince units or additions greater than Ination and all applicable general plan Incompose the site of no more than 5 acres Ince the site of no more than 5 acres	

STEP 2: CEQA IMPACTS

TO BE COMPLETED BY PROJECT PLANNER

	Air Quality: Would the project add new sensitive receptors (specifically, schools, day care facilities, hospitals, residential dwellings, and senior-care facilities within an Air Pollution Exposure Zone? Does the project have the potential to emit substantial pollutant concentrations (e.g., backup diesel generators, heavy industry, diesel trucks, etc.)? (refer to EP_ArcMap > CEQA Catex Determination Layers > Air Pollution Exposure Zone)
	Hazardous Materials: If the project site is located on the Maher map or is suspected of containing hazardous materials (based on a previous use such as gas station, auto repair, dry cleaners, or heavy manufacturing, or a site with underground storage tanks): Would the project involve 50 cubic yards or more of soil disturbance - or a change of use from industrial to residential? Note that a categorical exemption shall not be issued for a project located on the Cortese List if the applicant presents documentation of enrollment in the San Francisco Department of Public Health (DPH) Maher program, a DPH waiver from the Maher program, or other documentation from Environmental Planning staff that hazardous material effects would be less than significant (refer to EP_ArcMap > Maher layer).
	Transportation: Does the project involve a child care facility or school with 30 or more students, or a location 1,500 sq. ft. or greater? Does the project have the potential to adversely affect transit, pedestrian and/or bicycle safety (hazards) or the adequacy of nearby transit, pedestrian and/or bicycle facilities?
	Archeological Resources: Would the project result in soil disturbance/modification greater than two (2) feet below grade in an archeological sensitive area or eight (8) feet in a non-archeological sensitive area? If yes, archeo review is required (refer to EP_ArcMap > CEQA Catex Determination Layers > Archeological Sensitive Area)
	Subdivision/Lot Line Adjustment: Does the project site involve a subdivision or lot line adjustment on a lot with a slope average of 20% or more? (refer to EP_ArcMap > CEQA Catex Determination Layers > Topography). If yes, Environmental Planning must issue the exemption.
	Slope = or > 25%: Does the project involve any of the following: (1) square footage expansion greater than 500 sq. ft. outside of the existing building footprint, (2) excavation of 50 cubic yards or more of soil, (3) new construction? (refer to EP_ArcMap > CEQA Catex Determination Layers > Topography) If box is checked, a geotechnical report is required and Environmental Planning must issue the exemption.
	Seismic: Landslide Zone: Does the project involve any of the following: (1) square footage expansion greater than 500 sq. ft. outside of the existing building footprint, (2) excavation of 50 cubic yards or more of soil, (3) new construction? (refer to EP_ArcMap > CEQA Catex Determination Layers > Seismic Hazard Zones) If box is checked, a geotechnical report is required and Environmental Planning must issue the exemption.
	Seismic: Liquefaction Zone: Does the project involve any of the following: (1) square footage expansion greater than 500 sq. ft. outside of the existing building footprint, (2) excavation of 50 cubic yards or more of soil, (3) new construction? (refer to EP_ArcMap > CEQA Catex Determination Layers > Seismic Hazard Zones) If box is checked, a geotechnical report will likely be required and Environmental Planning must issue the exemption.
Com	ments and Planner Signature (optional): Monica Giacomucci

STEP 3: PROPERTY STATUS - HISTORIC RESOURCE TO BE COMPLETED BY PROJECT PLANNER			
PROP	PROPERTY IS ONE OF THE FOLLOWING: (refer to Property Information Map)		
	Category A: Known Historical Resource. GO TO STEP 5.		
	Category B: Potential Historical Resource (over 45 years of age). GO TO STEP 4.		
	Category C: Not a Historical Resource or Not Age Eligible (under 45 years of age). GO TO STEP 6.		
STE	P 4: PROPOSED WORK CHECKLIST		
	E COMPLETED BY PROJECT PLANNER		
Check	all that apply to the project.		
	Change of use and new construction. Tenant improvements not included.		
	2. Regular maintenance or repair to correct or repair deterioration, decay, or damage to building.		
	3. Window replacement that meets the Department's <i>Window Replacement Standards</i> . Does not include storefront window alterations.		
	4. Garage work. A new opening that meets the <i>Guidelines for Adding Garages and Curb Cuts</i> , and/or replacement of a garage door in an existing opening that meets the Residential Design Guidelines.		
	5. Deck, terrace construction, or fences not visible from any immediately adjacent public right-of-way.		
	6. Mechanical equipment installation that is not visible from any immediately adjacent public right-of-way.		
	7. Dormer installation that meets the requirements for exemption from public notification under <i>Zoning Administrator Bulletin No. 3: Dormer Windows</i> .		
•	8. Addition(s) that are not visible from any immediately adjacent public right-of-way for 150 feet in each direction; does not extend vertically beyond the floor level of the top story of the structure or is only a single story in height; does not have a footprint that is more than 50% larger than that of the original building; and does not cause the removal of architectural significant roofing features.		
Note:	Project Planner must check box below before proceeding.		
	Project is not listed. GO TO STEP 5.		
	Project does not conform to the scopes of work. GO TO STEP 5.		
	Project involves four or more work descriptions. GO TO STEP 5.		
	Project involves less than four work descriptions. GO TO STEP 6.		
	STEP 5: CEQA IMPACTS - ADVANCED HISTORICAL REVIEW TO BE COMPLETED BY PROJECT PLANNER		
Chec	Check all that apply to the project.		
	 Project involves a known historical resource (CEQA Category A) as determined by Step 3 and conforms entirely to proposed work checklist in Step 4. 		
	2. Interior alterations to publicly accessible spaces.		
	3. Window replacement of original/historic windows that are not "in-kind" but are consistent with existing historic character.		
	4. Façade/storefront alterations that do not remove, alter, or obscure character-defining features.		
	5. Raising the building in a manner that does not remove, alter, or obscure character-defining		

6. Restoration based upon documented evidence of a building's historic condition, such as historic

7. Addition(s), including mechanical equipment that are minimally visible from a public right-of-way

photographs, plans, physical evidence, or similar buildings.

and meet the Secretary of the Interior's Standards for Rehabilitation.

features.

	8. Other work consistent with the Secretary of the Interior Stand Properties (specify or add comments):	ards for the Treatment of Historic	
	Other work that would not materially impair a historic district (s	specify or add comments):	
	(Requires approval by Senior Preservation Planner/Preservation	Coordinator)	
	10. Reclassification of property status . (Requires approval by S Planner/Preservation	Senior Preservation	
	Reclassify to Category A	Reclassify to Category C	
	a. Per HRER or PTR dated	(attach HRER or PTR)	
	b. Other <i>(specify)</i> :		
	Note: If ANY box in STEP 5 above is checked, a Preser	vation Planner MUST sign below.	
	Project can proceed with categorical exemption review. The project has been reviewed by the Preservation Planner and can proceed with categorical exemption review. GO TO STEP 6.		
Comm	ents (optional):		
Preser	vation Planner Signature: Monica Giacomucci		
STE	EP 6: CATEGORICAL EXEMPTION DETERMINATION		
	BE COMPLETED BY PROJECT PLANNER		
	No further environmental review is required. The project is cat		
	There are no unusual circumstances that would result in a reasonable possibility of a significant		
	effect. Project Approval Action: Signature:		
	Building Permit	Monica Giacomucci	
	If Discretionary Review before the Planning Commission is requested, the Discretionary Review hearing is the Approval Action for the project.	10/28/2020	
	Once signed or stamped and dated, this document constitutes a categorical exemption pursuant to CEQA Guidelines and Chapter 31 of the Administrative Code. In accordance with Chapter 31 of the San Francisco Administrative Code, an appeal of an exemption determination can only be filed within 30 days of the project receiving the approval action. Please note that other approval actions may be required for the project. Please contact the assigned planner for these approvals.		

STEP 7: MODIFICATION OF A CEQA EXEMPT PROJECT

TO BE COMPLETED BY PROJECT PLANNER

In accordance with Chapter 31 of the San Francisco Administrative Code, when a California Environmental Quality Act (CEQA) exempt project changes after the Approval Action and requires a subsequent approval, the Environmental Review Officer (or his or her designee) must determine whether the proposed change constitutes a substantial modification of that project. This checklist shall be used to determine whether the proposed changes to the approved project would constitute a "substantial modification" and, therefore, be subject to additional environmental review pursuant to CEQA.

MODIFIED PROJECT DESCRIPTION

Modified Project Description:				
DET	ERMINATION IF PROJECT (CONSTITUTES SUBSTANTIAL MODIFICATION		
Com	pared to the approved project, w	ould the modified project:		
	Result in expansion of the build	ding envelope, as defined in the Planning Code;		
	Result in the change of use that would require public notice under Planning Code Sections 311 or 312;			
	Result in demolition as defined under Planning Code Section 317 or 19005(f)?			
	Is any information being presented that was not known and could not have been known at the time of the original determination, that shows the originally approved project may no longer qualify for the exemption?			
If at I	If at least one of the above boxes is checked, further environmental review is required.			
DET	ERMINATION OF NO SUBSTAI	NTIAL MODIFICATION		
	The proposed modification would not result in any of the above changes.			
If this box is checked, the proposed modifications are categorically exempt under CEQA, in accordance with prior project approval and no additional environmental review is required. This determination shall be posted on the Planning Department website and office and mailed to the applicant, City approving entities, and anyone requesting written notice. In accordance with Chapter 31, Sec 31.08j of the San Francisco Administrative Code, an appeal of this determination can be filed within 10 days of posting of this determination.				
Plani	ner Name:	Date:		

Land Use Information

PROJECT ADDRESS: 628 SHOTWELL STREET RECORD NO.: 2019-022661CUA

	EXISTING	PROPOSED	NET NEW	
	GROSS SQUARE FOO	TAGE (GSF)		
Parking (accessory) GSF	925	609	-316	
Residential GSF	3,862	4,155	293	
Laboratory GSF	0	0	0	
Office GSF	0	0	0	
Industrial/PDR GSF Production, Distribution, & Repair	0	0	0	
Medical GSF	0	0	0	
Visitor GSF	0	0	0	
CIE GSF	0	0	0	
Usable Open Space	1,501	1,501	0	
Public Open Space	0	0	0	
Other (Retail Sales and Services)	0	0	0	
TOTAL GSF	20,400	20,400	0	
	EXISTING	NET NEW	TOTALS	
	PROJECT FEATURES (Un	its or Amounts)		
Dwelling Units - Affordable	1	1	2	
Dwelling Units - Market Rate	0	0	0	
Dwelling Units - Total	0	0	0	
Hotel Rooms	0	0	0	
Number of Buildings	1	0	0	
Number of Stories	3	0	0	
Parking Spaces	1	0	0	
Loading Spaces	0	0	0	
Bicycle Spaces	0	2	2	
Car Share Spaces	0	0	0	
Other ()	NA	NA	NA	


1650 Mission St. Suite 400 San Francisco, CA 94103-2479

Reception: **415.558.6378**

Fax: **415.558.6409**


Planning Information: **415.558.6377**

Parcel Map

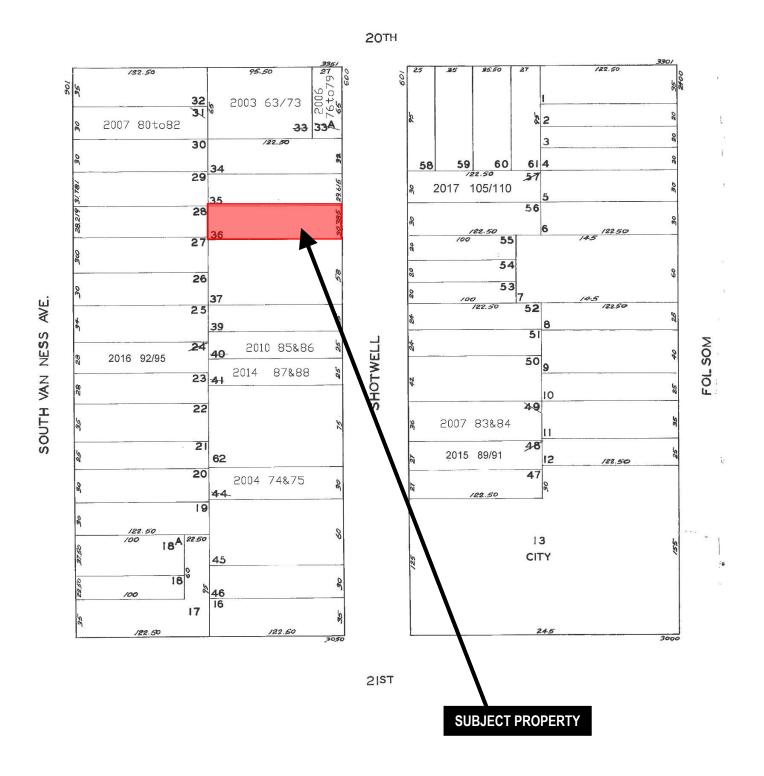




Sanborn Map*

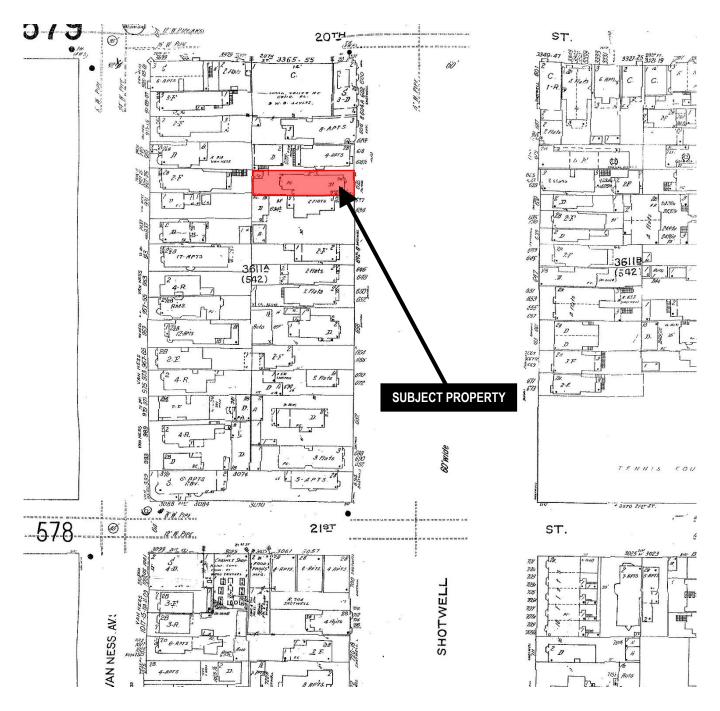

^{*}The Sanborn Maps in San Francisco have not been updated since 1998, and this map may not accurately reflect existing conditions.





Aerial Photo - View 1

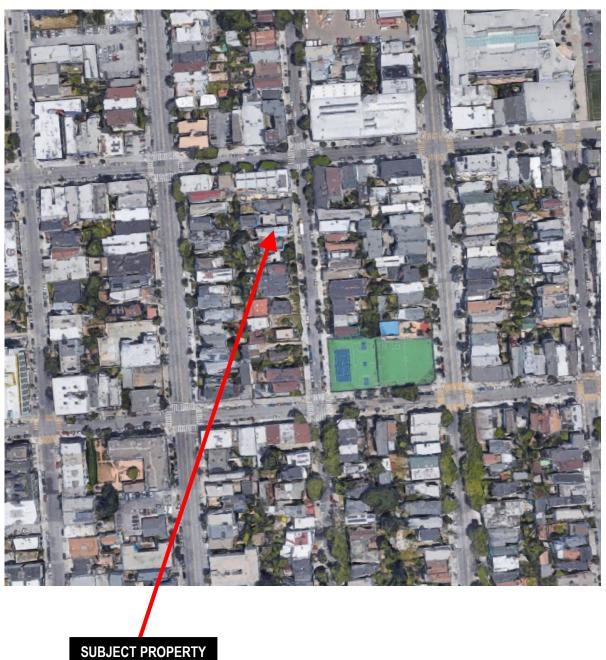




Zoning Map

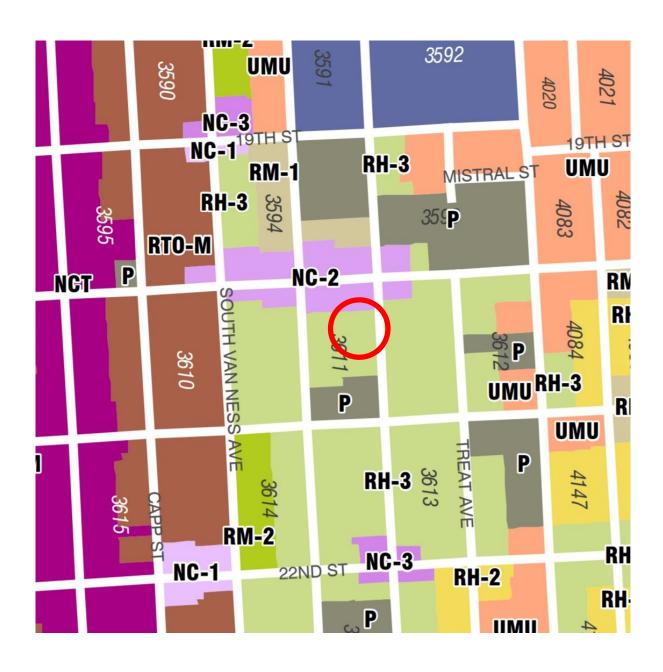

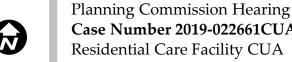

Site Photo

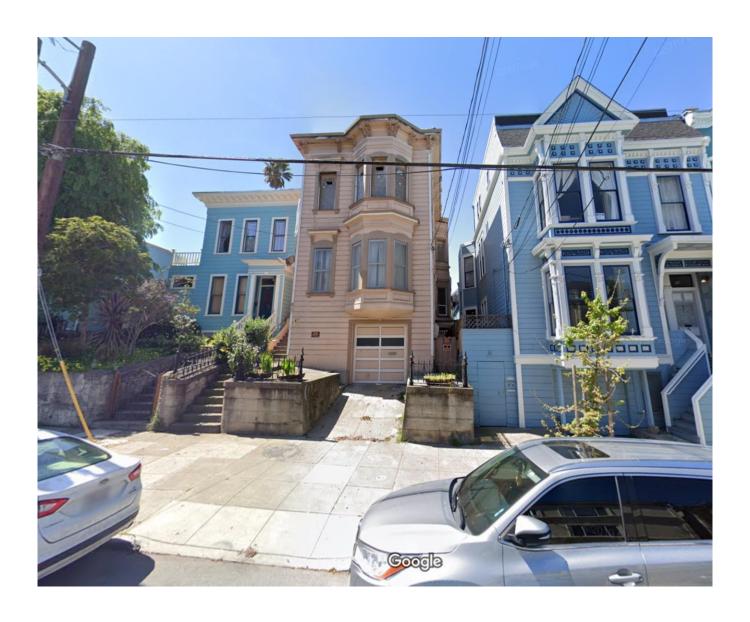

PROJECT DESCRIPTION FOR: 628 SHOTWELL STREET

BY:

HOOD THOMAS ARCHITECTS

440 SPEAR STREET

SAN FRANCISCO, CA 94114

(415) 543-5005 X 2

mark@hoodthomas.com

19 November 2020

PROJECT DESCRIPTION FOR:

THE REMODELING AND CHANGE OF USE AT 628 SHOTWELL STREET:

1. History: 628 Shotwell Street was constructed in 1885 as a 2-story over basement single family residence. According to the Spring Valley Water Company water tap application, water service was established in 1885 and the application listed 628 Shotwell as a onefamily residence with no boarders or lodgers. (See Exhibit 1). The first Sanborn map illustrating the 600 block of Shotwell Street was published in 1889; it shows the subject building as a 2-story single family dwelling. Succeeding Sanborn maps document the building as a single-family residence through the 1950s. (See Exhibit 2). Throughout the later 1950s and 1960s, some building permits listed the subject property as "apartments" and the property was subject to abatement issues during that time period. (It's not clear if this is because the building was being operated as a rooming house or because it had been converted to apartments without permits). In 1984, building permit #8310798 indicates the number of dwelling units as "1-family with 4 guest rooms. The 3R report indicates the single- family home was partially converted to a residential care facility on the "main" (first) floor only. (See Exhibit 3). The "upper" (second) floor continued to be used as a single-family home, occupied by the family who operated the residential care facility. In 2015, a fire destroyed the interior of the building, along with some of the roof and some of the exterior elements of the building and the residential care facility was abandoned with all residents being relocated to other facilities, and the property has been vacant since that time. The family who operated the Lorne House dissolved its corporate entity (Lorne House, Inc.) in 2017 and sold the property in 2019. The new owners filed a permit application in 2019 to convert single-family residence with residential care to a 2-family residence, by remodeling the existing interior of the building to become 2-units with a one-car garage (BPA # 2019-1119-7709).

The proposed remodeling at 628 Shotwell Street is as follows:

- 2. **Purpose:** The purpose for remodeling the building is to provide 2-dwelling units in an existing residential neighborhood.
- 3. **Scope:** Convert the existing unoccupied, fire damaged building (with the last permitted use being a (now abandoned) residential care facility with a single family residence above it) to become a 2-family residence with private and shared exterior open space:

TABLE OF PROPOSED UNIT SIZES AND OPEN SPACE

	Unit Square Footage	Dedicated Outdoor Space	Shared Outdoor Space
UNIT 1:	828 SF	141 SF	1,026 SF
1 BED, 1 1/2 BATH			
UNIT 2:	3,419 SF	110 SF	1,026 SF
4 BED, 3 1/2 BATH			

Although interior remodeling and seismic upgrading will be substantial, all existing character defining features at the front façade will remain without alterations

- 4. **Entitlements:** The proposed work complies with current building and planning codes. No variances are required for the project.
 - a. <u>Conditional Use:</u> A conditional use authorization is requested under the Interim Controls adopted by the board of supervisors in October of 2019 as well as findings per Planning Code Section 303, Conditional Use Findings.

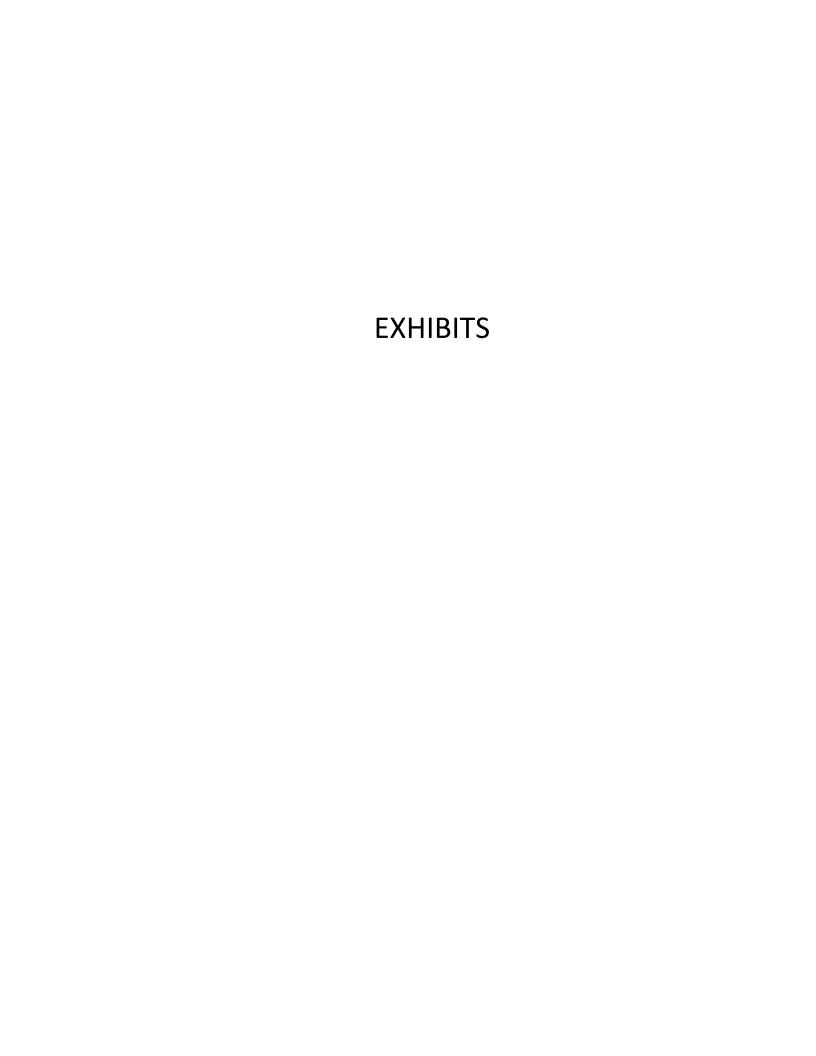


EXHIBIT 1:

SPRING VALLEY WATER COMPANY, WATER TAP APPLICATION, 1885

SPRING VALLEY WATER COMPANY TAP APPLICATION

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EXHIBIT 2:

HISTORIC SANBORN MAPS

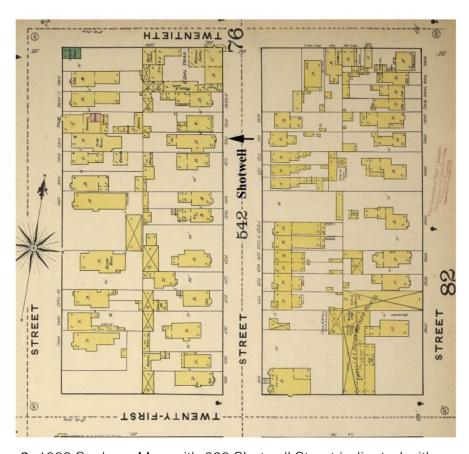


Figure 2: 1889 Sanborn Map with 628 Shotwell Street indicated with an arrow.

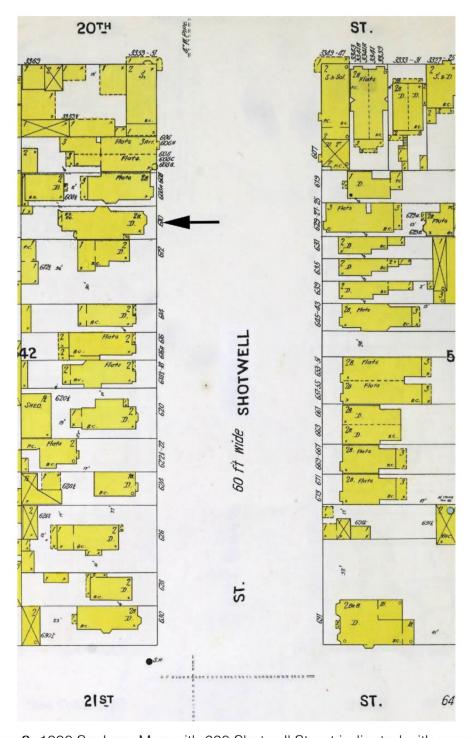


Figure 3: 1900 Sanborn Map with 628 Shotwell Street indicated with an arrow.

EXHIBIT 3:

City and County of San Francisco Department of Building Inspection



London N. Breed, Mayor Tom C. Hui, S.E., C.B.O., Director

Report of Residential Building Record (3R) (Housing Code Section 351(a))

BEWARE: This report describes the current legal use of this property as compiled from records of City Departments. There has been no physical examination of the property itself. This record contains no history of any plumbing or electrical permits. The report makes no representation that the property is in compliance with the law. Any occupancy or use of the property other than that listed as authorized in this report may be illegal and subject to removal or abatement, and should be reviewed with the Planning Department and the Department of Building Inspection. Errors or omissions in this report shall not bind or stop the City from enforcing any and all building and zoning codes against the seller, buyer and any subsequent owner. The preparation or delivery of this report shall not impose any liability on the City for any errors or omissions contained in said report, nor shall the City bear any liability not otherwise imposed by law.

Address of Building 628 SHOTWELL ST

Block 3611

Lot 036

Other Addresses

- 1. A. Present authorized Occupancy or use: ONE FAMILY DWELLING & FOUR GUEST ROOMS
 - B. Is this building classified as a residential condominium?

s No ✔

5. Is this building blassified as a residential condomination.

C. Does this building contain any Residential Hotel Guest Rooms as defined in Chap. 41, S.F. Admin. Code?

Yes No ✓

2. Zoning district in which located: RH-3

3. Building Code Occupancy Classification: R3

4. Do Records of the Planning Department reveal an expiration date for any non-conforming use of this property? Yes No ✓
If Yes, what date? The zoning for this property may have changed. Call Planning Department, (415) 558-6377, for the current status.

- 5. Building Construction Date (Completed Date): UNKNOWN
- 6. Original Occupancy or Use: UNKNOWN
- 7. Construction, conversion or alteration permits issued, if any:

Application #	Permit #	Issue Date	Type of Work Done	Status
152535	152535	Jul 23, 1926	INSTALL CLOSETS WINDOWS & NEW FRONT STEPS	N
289885	259097	Oct 23, 1963	REPAIR FIRE DAMAGE	C
312698	302135	Jan 17, 1967	COMPLY WITH DEPARTMENT OF PUBLIC HEALTH NOTICE (3-11-65)	X
338696	307465	Mar 31, 1967	COMPLY WITH BOARD OF PERMIT APPEALS DECISION 4630. DELETE STIPULATION #71 FROM APPLICATION 312698	X
383473	345887	Jul 06, 1970	COMPLY WITH DEVISION OF APARTMENT AND HOTEL REQUIREMENTS 5/15/70. RENEWAL OF APPLICATION #338696.	X
8310798	513558	Mar 30, 1984	INTALL SHEETROCK IN BASEMENT STORAGE ROOM. NEW STAIR ENCLOSES DOOR. CONVERT DWELLING TO RESIDENTIAL CARE USE ON FIRST FLOOR ONLY. COMPLIANCE WITH ABATEMENT FILE #14143 - CFC 1FD & 4GR	С
9207416	697156	May 06, 1992	KITCHEN REMODELING -NEW CABINETS, LINOLEUM FLOOR, ETC.	\mathbf{x}
9305407	718709	Apr 05, 1993	REMODEL KITCHEN: NEW CABINETSS/LINOLEOM FLOOR/CERAMIC TILE. RENEWAL OF APPLICATION #9207416	X
9406366	745274	Apr 22, 1994	RENEWAL APPLICATION #9305407	C
200506276164	1059437	Jun 27, 2005	INSTALL 20 REPLACEMENT WINDOWS. 8 VISABLE FROM STREET TO BE WOOD IN KIND.	C
200510064889	1068761	Oct 05, 2005	INSTALL 18 REPLACEMENT WINDOWS. 4 WOOD VISIBLE FROM STREET.	I

RECEIVED & ACKNOWLEDGED

SIGN & DATE

SIGN & DATE

Records Management Division ES.

THRU

1660 Mission Street - San Francisco CA 94103 Office (415) 558-6080 - FAX (415) 558-6402 - www.sfdbi.org Department of Building Inspection 1660 Mission Street - San Francisco CA 94103 - (415) 558-6080 Report of Residential Record (3R) Page 2

Address of Building 628 SHOTWELL ST Block 3611 Lot 036

Other Addresses

8. A. Is there an active Franchise Tax Board Referral on file?

B. Is this property currently under abatement proceedings for code violations?

Yes

No ✓

Yes

9. Number of residential structures on property? 1

10. A. Has an energy inspection been completed? Yes No ✓ B. If yes, has a proof of compliance been issued? Yes No ✓

11. A. Is the building in the Mandatory Earthquake Retrofit of Wood-Frame Building Program? Yes No

B. If yes, has the required upgrade work been completed? Yes No

Date of Issuance: 20 DEC 2018

Date of Expiration: 20 DEC 2019

By: JINGJING LU

Report No: 201812129214

Patty Herrera, Manager

Records Management Division

THIS REPORT IS VALID FOR ONE YEAR ONLY.

The law requires that, prior to the consummation of the sale or exchange of this property, the seller must deliver this report to the buyer and the buyer must sign it

(For Explanation of terminology, see attached)