

# **EXECUTIVE SUMMARY CONDITIONAL USE**

**HEARING DATE: September 2, 2021** 

Record No.: 2019-015440CUA **Project Address:** 472 Greenwich Street

**Zoning:** RH-3 (Residential-House, Three Family) Zoning District

40-X Height and Bulk District

Telegraph Hill-North Beach Residential Special Use District

Block/Lot: 0078/022 **Project Sponsor:** Dawn Ma

4243 25th Street

San Francisco, CA 94114

**Property Owner:** David & Vivian Matsuo

472 Greenwich Street, San Francisco, CA 94133

**Staff Contact:** Jonathan Vimr - (628) 652-7319

Jonathan.Vimr@sfgov.org

**Recommendation:** Approval with Conditions

# **Project Description**

The Project proposes the creation of a one car garage as part of a remodel of the existing residential building. The project also includes a horizontal and one-story vertical addition to the existing three story, two-unit 2,310 square foot building as well as substantial interior and exterior alterations. The remodeled building would total 4,179 square feet spread between the two units and unconditioned spaces. Roof decks are proposed on the fourth and third floors.

# **Required Commission Action**

In order for the Project to proceed the Commission must grant a Conditional Use Authorization, pursuant to Planning Code Sections 249.49 and 303, to allow the creation of a one-car garage within the Telegraph Hill-North Beach Residential Special Use District ("SUD").

# **Issues and Other Considerations**

- Conditional Use Authorization: Pursuant to Planning Code Section 249.49, Conditional Use Authorization is required for the provision of up to one off street residential parking space per dwelling unit within the subject SUD. When a garage is added to a residential building of two or more units it also mandates that the Planning Commission make various findings alongside those required by Section 303. As detailed in the draft motion, all these additional findings have been met as no ground floor commercial space would be reduced or eliminated, dwelling units will only be increased rather than decreased in size, the building has had no evictions within the last ten years, Greenwich Street is not an alley or right-of-way narrower than 41 feet, and the proposed garage is consistent with Section 101.1 of the Planning Code.
- **Design Review Comments:** Since the original submittal of the Project to the Department, significant changes to the design include (but are not limited to): reducing the vertical addition from two stories to one; incorporating a meaningfully recessed entry; changing the bay window from an angled, asymmetrical design to a typical rectilinear configuration; altering the number and placement of windows in general to better fit the neighborhood context; and incorporating a simple cornice

### Public Comment & Outreach.

- o **Support/Opposition:** The Department has received three (3) letters in support of the project from various individuals and one (1) letter in opposition from the Telegraph Hill Dwellers ("THD").
  - Supporters stated that the remodel of the building would be a significant improvement to the
    neighborhood, that the garage will assist in getting another car off the street, and that the
    project will allow for the multi-generational family residing at the property to age in place.
  - THD expressed concerns regarding the compatibility of the project with the surrounding area and the pending California Register-eligible expanded North Beach Historic District. This included concerns regarding the configuration and size of the windows, the primary cladding material, the design of the double entryway, and the rooftop penthouse. The neighborhood group also expressed opposition to installation of the proposed garage.
- o Outreach: The Sponsor hosted a pre-application meeting on December 21, 2018.

## **Environmental Review**

The Project is exempt from the California Environmental Quality Act ("CEQA") as a Class 1 categorical exemption.

## **Basis for Recommendation**

The Department finds that the Project is, on balance, consistent with the Objectives and Policies of the General Plan. The existing building is a two-unit residential structure and the addition of a single off-street parking space to the ground level will not negatively affect traffic, nor will it convert or remove affordable housing. The Department also finds the project to be necessary, desirable, and compatible with the surrounding neighborhood, and not to be detrimental to persons or adjacent properties in the vicinity.



# **Attachments:**

Draft Motion – Conditional Use Authorization with Conditions of Approval

Exhibit B – Plans and Renderings

Exhibit C – Environmental Determination

Exhibit D – Land Use Data

Exhibit E – Maps and Context Photos

Exhibit F – Project Sponsor Affidavit for Garage Addition

Exhibit G – Eviction History Documentation



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# PLANNING COMMISSION DRAFT MOTION

**HEARING DATE: SEPTEMBER 2, 2021** 

Record No.: 2019-015440CUA Project Address: 472 Greenwich Street

Zoning: RH-3 (Residential-House, Three Family) Zoning District

40-X Height and Bulk District

Telegraph Hill-North Beach Residential Special Use District

Block/Lot: 0078/022 Project Sponsor: Dawn Ma

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**Staff Contact:** Jonathan Vimr - (628) 652-7319

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ADOPTING FINDINGS TO APPROVE A CONDITIONAL USE AUTHORIZATION PURSUANT TO PLANNING CODE SECTIONS 249.49 AND 303 TO ESTABLISH ONE OFF-STREET PARKING SPACE AT THE EXISTING TWO-UNIT BUILDING LOCATED AT 472 GREENWICH STREET, LOT 022 IN ASSESSOR'S BLOCK 0078, WITHIN A RH-3 (RESIDENITAL-HOUSE, THREE FAMILY) ZONING DISTRICT, TELEGRAPH HILL-NORTH BEACH RESIDENTIAL SPECIAL USE DISTRICT, AND 40-X HEIGHT AND BULK DISTRICT, AND ADOPTING FINDINGS UNDER THE CALIFORNIA **ENVIRONMENTAL QUALITY ACT.** 

## **PREAMBLE**

On August 2, 2019, Dawn Ma of Q-Architecture (hereinafter "Project Sponsor") filed Application No. 2019-015440CUA (hereinafter "Application") with the Planning Department (hereinafter "Department") for a Conditional Use Authorization to install one off-street parking space and complete a substantial interior and exterior remodel of a two-unit residential building (hereinafter "Project") at 472 Greenwich Street, Block 0078 Lot 022 (hereinafter "Project Site").

The Project is exempt from the California Environmental Quality Act ("CEQA") as a Class 1 categorical exemption.

On September 2, 2021, the San Francisco Planning Commission (hereinafter "Commission") conducted a duly noticed public hearing at a regularly scheduled meeting on Conditional Use Authorization Application No. 2019-015440CUA.

The Commission has heard and considered the testimony presented to it at the public hearing and has further considered written materials and oral testimony presented on behalf of the applicant, Department staff, and other interested parties

The Planning Department Commission Secretary is the Custodian of Records; the File for Record No. 2019-015440CUA is located at 49 South Van Ness Avenue, Suite 1400, San Francisco, California.

**MOVED,** that the Commission hereby authorizes the Conditional Use Authorization as requested in Application No. 2019-015440CUA, subject to the conditions contained in "EXHIBIT A" of this motion, based on the following findings:



## **FINDINGS**

Having reviewed the materials identified in the preamble above, and having heard all testimony and arguments, this Commission finds, concludes, and determines as follows:

- 1. The above recitals are accurate and constitute findings of this Commission.
- 2. **Project Description.** The Project proposes the creation of a one car garage as part of a remodel of the existing residential building. The project also includes a horizontal and one-story vertical addition to the existing three-story, two-unit 2,310 square foot building as well as substantial interior and exterior alterations. The remodeled building would total 4,179 square feet spread between the two units and unconditioned spaces. Roof decks are proposed on the fourth and third floors.
- 3. Site Description and Present Use. The Project is located on a single lot on the north side of Greenwich Street between Grant Ave and Child Street. It contains a single two-unit residential building that is composed of three stories and measures 28' in height. One of thirty-six buildings designed by architecture firm Righetti and Kuhl during the 1906-1915 reconstruction of North Beach, it is contributory to a pending California Register-eligible expanded North Beach Historic District.
- **4. Surrounding Properties and Neighborhood.** The Project Site is located within the RH-3 Zoning District, 40-X Height and Bulk District, and the Telegraph Hill-North Beach Residential Special Use District. Both the subject and surrounding blocks are residential in nature, with a mix of duplexes, flats, and multi-unit apartment buildings that are typically three or four stories in height. Garages are a common feature of on this stretch of Greenwich Street, particularly on the north side where they are found on every building east of the subject property up to the street's boundary with Telegraph Hill. Other zoning districts in the vicinity of the project site include: P (Public), RM-1 (Residential-Mixed), and the North Beach NCD (Neighborhood Commercial District). Telegraph Hill and Coit Tower are located east and southeast of the subject site
- **5. Public Outreach and Comments.** The Department has received three (3) letters in support of the project from various individuals and one (1) in opposition from the Telegraph Hill Dwellers ("THD"). Supporters stated that the remodel of the building would be a significant improvement to the neighborhood, that the garage will assist in getting another car off the street, and that the Project will allow for the multigenerational family residing at the property to age in place. THD expressed concerns regarding the compatibility of the project with the surrounding area and pending eligible historic district. This included opposition to the configuration and size of the windows, the primary cladding material, the design of the double entryway, and the rooftop penthouse. THD also stated opposition to installation of the proposed garage.
- **6. Planning Code Compliance.** The Commission finds that the Project is consistent with the relevant provisions of the Planning Code in the following manner:
  - A. Use. The existing two-unit building is principally permitted within the RH-3 Zoning District.

The RH-3 Zoning District is characterized by structure with three units in addition to one-family and two-family houses on 25-foot-wide lots, and with a fine or moderate scale. Building styles tend to be varied but complementary to one another. Outdoor space is available at ground level, and also on decks and



balconies. The Project maintains and enhances a principally permitted use by making the interior more useable for the large family that resides there and maintains the predominant form and scale of the Zoning District while completing a remodel of the exterior.

B. Residential Design Guidelines. Planning Code Section 209.1 requires compliance with the Residential Design Guidelines, which necessitate that the design and placement of garage entrances and doors are compatible with the building and surrounding area.

The project complies with the Residential Design Guidelines in that the garage has been placed on the southern façade in line with the fenestration above and a well recessed, raised stair entry has been retained. The design mirrors the adjacent structure to the east, creating a "book ends" effect that is compatible with and complements the immediately surrounding area.

C. Protected Pedestrian-, Cycling-, and Transit-Oriented Street Frontages. Planning Code Section 155(r) prohibits new curb cuts on certain street frontages and all alleys within the Telegraph Hill-North Beach Residential Special Use District.

Greenwich Street is wide and as such is not defined as an alley, therefore the site is not located in an area where curb cuts are prohibited.

- D. Residential Parking. Planning Code Section 249.49 requires Conditional Use Authorization for up to one off-street residential parking space per dwelling unit in the Telegraph Hill-North Beach Residential Special Use District. It also requires that when a garage is added to a residential building of two or more units the Planning Commission shall find that:
  - 1) the proposed garage opening/addition of off-street parking will not cause the elimination or reduction of ground-story retail or commercial space;
  - 2) the proposed garage opening/addition of off-street parking will not eliminate or decrease the square footage of any dwelling unit;
  - 3) the building has not had two or more evictions within the past 10 years, with each eviction associated with a separate unit(s);
  - 4) the garage would not front on an Alley pursuant to Section 155(r)(2) of the Planning Code or on a public right-of-way narrower than 41 feet; and
  - 5) the proposed garage or addition of off-street parking is consistent with the Priority Policies of Section 101.1 of the Planning Code.

The project proposes a new residential parking space and as such Conditional Use Authorization is required; see Item 7 below for Conditional Use analysis. The Planning Department has also independently verified that the Project would result in no reduction or elimination of ground floor retail or commercial space, that the proposed garage will not eliminate or decrease the size of any dwelling unit, and that the building has not had two or more evictions within the past 10 years. The Project sponsor has provided a signed affidavit attesting to this as well. Greenwich Street is 68'9" wide and therefore is not an alley or a public right-of-way narrower than 41 feet. Finally, the proposed garage is consistent with Priority Policies of Section 101.1 of the Planning Code as detailed in Item 9 below.



- 7. **Conditional Use Findings.** Planning Code Section 303 establishes criteria for the Planning Commission to consider when reviewing applications for Conditional Use authorization. On balance, the project complies with said criteria in that:
  - A. The proposed new uses and building, at the size and intensity contemplated and at the proposed location, will provide a development that is necessary or desirable, and compatible with, the neighborhood or the community.
    - The existing two-unit use is principally permitted in the RH-3 Zoning District, which anticipates a mix of one-, two, and three-family dwellings at a fine or moderate scale. The purpose of the Telegraph Hill-North Beach Residential Special Use District is to regulate the amount of off-street parking and limit the installation of garages in residential structures in order to minimize automobile traffic and pollution and removal of on-street parking, and to prevent conversion of existing affordable units into parking. The existing residential building contains two units and the addition of a single off-street parking space to the ground level will not negatively affect traffic, nor does it convert or remove affordable housing. The large majority of residential structures on the block have off-street parking in a private garage and locating the garage entrance to the western portion of the front (south) façade maximizes the distance between curb cuts. While there is a reduction in parking available for a standard motor vehicle, the additional space may provide parking for motorcycles, scooters and other alternative vehicles that are less impactful on the environment.
  - B. The proposed project will not be detrimental to the health, safety, convenience or general welfare of persons residing or working in the vicinity. There are no features of the project that could be detrimental to the health, safety or convenience of those residing or working the area, in that:
    - (1) Nature of proposed site, including its size and shape, and the proposed size, shape and arrangement of structures;
      - The lot will retain its existing dimensions, with the remodeled building occupying a similar footprint with a horizontal addition toward the rear and a one-story vertical addition.
    - (2) The accessibility and traffic patterns for persons and vehicles, the type and volume of such traffic, and the adequacy of proposed off-street parking and loading;
      - The Planning Code does not require parking for residential uses and allows a limited amount. Locating the garage entrance to the western portion of the front (south) façade maximizes the distance between curb cuts and while there is a reduction in parking available for a standard motor vehicle, the additional space may provide parking for motorcycles, scooters and other alternative vehicles that are less impactful on the environment.
    - (3) The safeguards afforded to prevent noxious or offensive emissions such as noise, glare, dust and odor;

The use of the site will remain strictly residential in nature, with two units remaining at the



- currently existing two-unit site. No excessive noise, glare, dust, or odor is anticipated.
- (4) Treatment given, as appropriate, to such aspects as landscaping, screening, open spaces, parking and loading areas, service areas, lighting and signs;
  - The new off street parking space is in a garage and will be fully screened, with landscaping also provided at the exterior of the garage via planters.
- C. That the use as proposed will comply with the applicable provisions of the Planning Code and will not adversely affect the General Plan.
  - The Project complies with all relevant requirements and standards of the Planning Code and is consistent with objectives and policies of the General Plan as detailed below.
- D. That use or feature as proposed will provide development that is in conformity with the stated purpose of the applicable Use District.
  - On balance, the proposed project is consistent with the stated purpose of the applicable use districts. The existing two-unit use is principally permitted in the RH-3 Zoning District, which anticipates a mix of one-, two, and three-family dwellings at a fine or moderate scale. The purpose of the Telegraph Hill-North Beach Residential Special Use District is to regulate the amount of off-street parking and limit the installation of garages in residential structures in order to minimize automobile traffic and pollution and removal of on-street parking, and to prevent conversion of existing affordable units into parking. The existing residential building contains two units and the addition of a single off-street parking space to the ground level will not negatively affect traffic, nor does it convert or remove affordable housing.
- **8. Accessory Residential Parking.** In addition to Conditional Use Authorization, Planning Code Section 249.49(c)(1) requires that the criteria established in Section 151.1(f) be met in order to establish a residential parking space in the Telegraph Hill-North Beach Residential Special Use District.
  - A. Vehicle movement on or around the project does not unduly impact pedestrian spaces or movement, transit service, bicycle movement, or the overall traffic movement in the district;
  - B. Accommodating excess accessory parking does not degrade the overall urban design quality of the project proposal;
  - C. All above-grade parking is architecturally screed and lined with active use according to the standards of Section 145.1, and the project sponsor is not requesting any exceptions or variance requiring such treatments elsewhere in this Code; and
  - D. Excess accessory parking does not diminish the quality and viability of existing or planned streetscape enhancements.
    - i. Parking is not accessed from any protected Transit or Pedestrian Street described in Section 155(r), and
    - ii. Where more than 10 spaces are proposed at least half of them, rounded down to the nearest



whole number, are stored and accessed by mechanical stackers or lifts, valet, or other space-efficient means that reduces space used for parking and maneuvering, and maximizes other uses.

The project site is not located in an area identified as a Protected Pedestrian-, Cycling-, and Transit-Oriented Street Frontage. The location and design of the garage entrance will mirror the adjacent structure to the east and create a more interesting street façade. The off-street parking will be screened by a garage door and only a single space is proposed.

**9. General Plan Compliance.** The Project is, on balance, consistent with the following Objectives and Policies of the General Plan:

### **HOUSING ELEMENT**

Objectives and Policies

### **OBJECTIVE 4**

FOSTER A HOUSING STOCK THAT MEETS THE NEEDS OF ALL RESIDENTS ACROSS LIFECYCLES.

### Policy 4.1

Develop new housing, and encourage the remodeling of existing housing, for families with children.

### **OBJECTIVE 11**

SUPPORT AND RESPECT THE DIVERSE AND DISTINCT CHARACTER OF SAN FRANCISCO'S NEIGHBORHOODS.

# Policy 11.1

Promote the construction and rehabilitation of well-designed housing that emphasizes beauty, flexibility, and innovative design, and respects existing neighborhood character.

### Policy 11.2

Ensure implementation of accepted design standards in project approvals.

### Policy 11.3

Ensure growth is accommodated without substantially and adversely impacting existing residential neighborhood character.

### Policy 11.4

Continue to utilize zoning districts which conform to a generalized residential land use and density plan and the General Plan.

### **URBAN DESIGN ELEMENT**

Objectives and Policies

# **OBJECTIVE 1**



EMPHASIS OF THE CHARACTERISTIC PATTERN WHICH GIVES TO THE CITY AND ITS NEIGHBORHOODS AN IMAGE, A SENSE OF PURPOSE, AND A MEANS OF ORIENTATION.

### Policy 1.3

Recognize that buildings, when seen together, produce a total effect that characterizes the city and its districts.

Enlarging each of the two existing units provides opportunities for family-sized, multi-generational housing, such as the family currently occupying the building. The addition of the garage will also create storage space for bicycles, a family-friendly amenity. The placement of the garage at the front façade and retention of a well recessed, raised entry mirrors the adjacent structure to the east, thereby creating a "book ends" effect that compatible with and complements the immediately surrounding area.

- **10. Planning Code Section 101.1(b)** establishes eight priority-planning policies and requires review of permits for consistency with said policies. On balance, the project complies with said policies in that:
  - A. That existing neighborhood-serving retail uses be preserved and enhanced and future opportunities for resident employment in and ownership of such businesses be enhanced.
    - The project site does not possess any neighborhood-serving retail uses.
  - B. That existing housing and neighborhood character be conserved and protected in order to preserve the cultural and economic diversity of our neighborhoods.
    - The project retains existing housing as the two-unit building will enlarge and maintain each of the dwelling units. The Project meets the Residential Design Guidelines and will be compatible with the character of the surrounding neighborhood.
  - C. That the City's supply of affordable housing be preserved and enhanced,
    - The Project does not currently possess any existing affordable housing. Though existing rental units must continue to comply with all applicable rent control regulations.
  - D. That commuter traffic not impede MUNI transit service or overburden our streets or neighborhood parking.
    - The Project Site is served by nearby public transportation options. The Project also provides offstreet parking at an amount permitted by Conditional Use Authorization and provides bicycle parking for residents in conformance with Planning Code requirements.
  - E. That a diverse economic base be maintained by protecting our industrial and service sectors from displacement due to commercial office development, and that future opportunities for resident employment and ownership in these sectors be enhanced.
    - The Project is a residential remodel and would have no effects on industrial or service sectors.



F. That the City achieve the greatest possible preparedness to protect against injury and loss of life in an earthquake.

The Project will be designed and constructed to conform to the structural and seismic safety requirements of the Building Code. As such, this Project will improve the property's ability to withstand an earthquake.

G. That landmarks and historic buildings be preserved.

The Project represents removal of a contributory property to a pending California Register-eligible expanded North Beach Historic District. As the existing building is only one of hundreds of likely contributors and the Project is generally compatible with the potential district, it could not result in an adverse impact causing material impairment to the potential district. See the Historic Resource Evaluation Response Part 2 for additional analysis and information.

H. That our parks and open space and their access to sunlight and vistas be protected from development.

The project would have no effect on parks or open spaces.

- 11. The Project is consistent with and would promote the general and specific purposes of the Code provided under Section 101.1(b) in that, as designed, the Project would contribute to the character and stability of the neighborhood and would constitute a beneficial development.
- **12.** The Commission hereby finds that approval of the Conditional Use Authorization would promote the health, safety and welfare of the City.



## **DECISION**

That based upon the Record, the submissions by the Applicant, the staff of the Department and other interested parties, the oral testimony presented to this Commission at the public hearings, and all other written materials submitted by all parties, the Commission hereby **APPROVES Conditional Use Authorization Application No. 2019-015440CUA** subject to the following conditions attached hereto as "EXHIBIT A" in general conformance with plans on file, dated August 6, 2021 and stamped "EXHIBIT B", which is incorporated herein by reference as though fully set forth.

**APPEAL AND EFFECTIVE DATE OF MOTION:** Any aggrieved person may appeal this Conditional Use Authorization to the Board of Supervisors within thirty (30) days after the date of this Motion. The effective date of this Motion shall be the date of this Motion if not appealed (after the 30-day period has expired) OR the date of the decision of the Board of Supervisors if appealed to the Board of Supervisors. For further information, please contact the Board of Supervisors at (415) 554-5184, City Hall, Room 244, 1 Dr. Carlton B. Goodlett Place, San Francisco, CA 94102.

Protest of Fee or Exaction: You may protest any fee or exaction subject to Government Code Section 66000 that is imposed as a condition of approval by following the procedures set forth in Government Code Section 66020. The protest must satisfy the requirements of Government Code Section 66020(a) and must be filed within 90 days of the date of the first approval or conditional approval of the development referencing the challenged fee or exaction. For purposes of Government Code Section 66020, the date of imposition of the fee shall be the date of the earliest discretionary approval by the City of the subject development.

If the City has not previously given Notice of an earlier discretionary approval of the project, the Planning Commission's adoption of this Motion, Resolution, Discretionary Review Action or the Zoning Administrator's Variance Decision Letter constitutes the approval or conditional approval of the development and the City hereby gives **NOTICE** that the 90-day protest period under Government Code Section 66020 has begun. If the City has already given Notice that the 90-day approval period has begun for the subject development, then this document does not re-commence the 90-day approval period.

I hereby certify that the Planning Commission ADOPTED the foregoing Motion on September 2, 2021

Commission Secretary

AYES:

NAYS:

ABSENT:

RECUSE:

ADOPTED: September 2, 2021



Jonas P. Ionin

# **EXHIBIT A**

### **Authorization**

This authorization is for a conditional use to allow one off-street residential parking space within the subject building located at 472 Greenwich Street, Block 0078, Lot 022 pursuant to Planning Code Section(s) 249.49 and 303 within the RH-3 Zoning District and a 40-X Height and Bulk District; in general conformance with plans, dated August 6, 2021, and stamped "EXHIBIT B" included in the docket for Record No. 2019-015440CUA and subject to conditions of approval reviewed and approved by the Commission on September 2, 2021 under Motion No XXXXXX. This authorization and the conditions contained herein run with the property and not with a particular Project Sponsor, business, or operator.

# **Recordation of Conditions Of Approval**

Prior to the issuance of the building permit or commencement of use for the Project the Zoning Administrator shall approve and order the recordation of a Notice in the Official Records of the Recorder of the City and County of San Francisco for the subject property. This Notice shall state that the project is subject to the conditions of approval contained herein and reviewed and approved by the Planning Commission on September 2, 2021 under Motion No XXXXXX.

# **Printing of Conditions of Approval on Plans**

The conditions of approval under the 'Exhibit A' of this Planning Commission Motion No. XXXXXX shall be reproduced on the Index Sheet of construction plans submitted with the site or building permit application for the Project. The Index Sheet of the construction plans shall reference to the Conditional Use authorization and any subsequent amendments or modifications.

### **Severability**

The Project shall comply with all applicable City codes and requirements. If any clause, sentence, section or any part of these conditions of approval is for any reason held to be invalid, such invalidity shall not affect or impair other remaining clauses, sentences, or sections of these conditions. This decision conveys no right to construct, or to receive a building permit. "Project Sponsor" shall include any subsequent responsible party.

# **Changes and Modifications**

Changes to the approved plans may be approved administratively by the Zoning Administrator. Significant changes and modifications of conditions shall require Planning Commission approval of a new Conditional Use authorization.



# CONDITIONS OF APPROVAL, COMPLIANCE, MONITORING, AND REPORTING

# **Performance**

1. Validity. The authorization and right vested by virtue of this action is valid for three (3) years from the effective date of the Motion. The Department of Building Inspection shall have issued a Building Permit or Site Permit to construct the project and/or commence the approved use within this three-year period.

For information about compliance, contact Code Enforcement, Planning Department at 628.652.7463, <a href="https://www.sfplanning.org">www.sfplanning.org</a>

2. Expiration and Renewal. Should a Building or Site Permit be sought after the three (3) year period has lapsed, the project sponsor must seek a renewal of this Authorization by filing an application for an amendment to the original Authorization or a new application for Authorization. Should the project sponsor decline to so file, and decline to withdraw the permit application, the Commission shall conduct a public hearing in order to consider the revocation of the Authorization. Should the Commission not revoke the Authorization following the closure of the public hearing, the Commission shall determine the extension of time for the continued validity of the Authorization.

For information about compliance, contact Code Enforcement, Planning Department at 628.652.7463, <a href="https://www.sfplanning.org">www.sfplanning.org</a>

3. Diligent Pursuit. Once a site or Building Permit has been issued, construction must commence within the timeframe required by the Department of Building Inspection and be continued diligently to completion. Failure to do so shall be grounds for the Commission to consider revoking the approval if more than three (3) years have passed since this Authorization was approved.

For information about compliance, contact Code Enforcement, Planning Department at 628.652.7463, <a href="https://www.sfplanning.org">www.sfplanning.org</a>

**4. Extension.** All time limits in the preceding three paragraphs may be extended at the discretion of the Zoning Administrator where implementation of the project is delayed by a public agency, an appeal or a legal challenge and only by the length of time for which such public agency, appeal or challenge has caused delay.

For information about compliance, contact Code Enforcement, Planning Department at 628.652.7463, <a href="https://www.sfplanning.org">www.sfplanning.org</a>

**5. Conformity with Current Law.** No application for Building Permit, Site Permit, or other entitlement shall be approved unless it complies with all applicable provisions of City Codes in effect at the time of such approval.

For information about compliance, contact Code Enforcement, Planning Department at 628.652.7463,



www.sfplanning.org

# **Design - Compliance at Plan Stage**

**6. Final Materials.** The Project Sponsor shall continue to work with Planning Department on the building design. Final materials, glazing, color, texture, landscaping, and detailing shall be subject to Department staff review and approval. The architectural addenda shall be reviewed and approved by the Planning Department prior to issuance.

For information about compliance, contact the Case Planner, Planning Department at 628.652.7319, <a href="https://www.sfplanning.org">www.sfplanning.org</a>

# **Parking and Traffic**

**7. Bicycle Parking.** The Project shall provide no fewer than two Class 1 bicycle parking spaces as required by Planning Code Sections 155.1 and 155.2. No racks are required as part of the provision of these spaces.

For information about compliance, contact Code Enforcement, Planning Department at 628.652.7463, <a href="https://www.sfplanning.org">www.sfplanning.org</a>

**8. Parking Maximum.** Pursuant to Planning Code Sections 151.1 and 249.49 and this Conditional Use Authorization, the Project shall provide no more than one (1) off-street parking space.

For information about compliance, contact Code Enforcement, Planning Department at 628.652.7463, <a href="https://www.sfplanning.org">www.sfplanning.org</a>

9. Managing Traffic During Construction. The Project Sponsor and construction contractor(s) shall coordinate with the Traffic Engineering and Transit Divisions of the San Francisco Municipal Transportation Agency (SFMTA), the Police Department, the Fire Department, the Planning Department, and other construction contractor(s) for any concurrent nearby Projects to manage traffic congestion and pedestrian circulation effects during construction of the Project.

For information about compliance, contact Code Enforcement, Planning Department at 628.652.7463, <a href="https://www.sfplanning.org">www.sfplanning.org</a>

# **Provisions**

**10. Residential Child Care Impact Fee.** The Project is subject to the Residential Child Care Fee, as applicable, pursuant to Planning Code Section 414A.

For information about compliance, contact the Case Planner, Planning Department at 628.652.7319,



www.sfplanning.org

# **Monitoring - After Entitlement**

11. Enforcement. Violation of any of the Planning Department conditions of approval contained in this Motion or of any other provisions of Planning Code applicable to this Project shall be subject to the enforcement procedures and administrative penalties set forth under Planning Code Section 176 or Section 176.1. The Planning Department may also refer the violation complaints to other city departments and agencies for appropriate enforcement action under their jurisdiction.

For information about compliance, contact Code Enforcement, Planning Department at 628.652.7463, <a href="https://www.sfplanning.org">www.sfplanning.org</a>

12. Revocation due to Violation of Conditions. Should implementation of this Project result in complaints from interested property owners, residents, or commercial lessees which are not resolved by the Project Sponsor and found to be in violation of the Planning Code and/or the specific conditions of approval for the Project as set forth in Exhibit A of this Motion, the Zoning Administrator shall refer such complaints to the Commission, after which it may hold a public hearing on the matter to consider revocation of this authorization.

For information about compliance, contact Code Enforcement, Planning Department at 628.652.7463, <a href="https://www.sfplanning.org">www.sfplanning.org</a>



# ADDITION REMODEL

ABBREV.

PLYWOOD RISER ROOF

ROOF DRAIN REFERENCE

REINFORCED

ROUGH OPENING RAIN WATER LEAD SOLID CORE

SPECIFICATION

SQUARE STANDARD

STRUCTURAL

TYPICAL

TEMPERED GLASS TOP OF CURB TOP OF WALL

UNLESS OTHERWISE NOTED

WATER LEVEL WOOD

WITHOUT WATER PROOF WATER RESISTANT CONTINUOUS

ROOM

SIMILAR

# **472 GREENWICH STREET** SAN FRANCISCO, CA 94133

# **EXHIBIT**

# **GENERAL NOTES** THE CONTRACTOR SHALL FIELD VERIFY ALL CONDITIONS AND DIMENSIONS PRIOR TO ANY WORK AND SHALL BE THE CONTRACTOR SHALL FIELD VERIFY ALL CONDITIONS AND DIMENSIONS PRIOR TO ANY WORK AND SHALL BE RESPONSIBLE FOR ALL WORK AND ASTRALLS INCLUDING THOSE FURNISHED BY THE OWNER. ALL CONSTRUCTION MUST COMPLY WITH ALL LOCAL GOVERNING CODES. THE CONTRACTOR SHALL REPORT TO THE ARCHITECT ANY ERROR OR OMISSION HE MAY DISCOVER IN THE DRAWINGS, OR ANY INCONSISTENCY BETWEEN THE DRAWINGS AND FIELD CONDITIONS, PRIOR TO CONSTRUCTION SO THAT THE ARCHITECT MAY ISSUE WRITTEN CLARIFICATION IN A TIMELY MANNER. DETAILS ARE INTENDED TO SHOW METHOD AND MANNER OF ACCOMPLISHING WORK, MINOR MODIFICATIONS MAY BE REQUIRED TO SUIT THE JOB DIMENSIONS OR CONDITIONS AND WILL BE INCLUDED AS PART OF THE WORK SUBJECT TO ADDRIVAL OF THE PESCHOLOGY. REQUIRED TO SUIT THE JOB DIMENSIONS OR CONDITIONS AND WILL BE INCLUDED AS PARTY OF THE WORK SUBJECT TO APPROVAL OF THE DESIGNER. ALL PLAN DIMENSIONS ARE TO JACE OF FRAMING, CENTERLINE OF OPENING, CENTERLINE OF WALL, CENTERLINE OF FOOTING, OR EDGE OF SLAB UNLESS NOTED OTHERWISE. DIMENSIONS ARE TO JACE OF FRAMING, CENTERLINE OF OPENING, CENTERLINE OF WALL, CENTERLINE OF FOOTING, OR EDGE OF SLAB UNLESS NOTED OTHERWISE. DIMENSIONS SHOWN ON THE VANS WILL TAKE PRECEDENCE TO SCALE, THE CONTRACTOR WILL VERIFY ALL DIMENSIONS AND NOTIFY THE DESIGNER OF ANY DISCREPANCIES OR OMISSIONS. JOHN PRACTICE DESIGNER OF ANY DISCREPANCIES OR OMISSIONS. ON OTHER CHEED BESIGNER OF ANY DISCREPANCIES OR OMISSIONS. ON OTHER CHEED SHOWS THE PORT ALL PERMITS AND FEES. THE CONTRACTOR WILL USE MEANS NECESSARY TO PREVENT DUST FROM BECOMING A NUISANCE TO THE PUBLIC, TO NEIGHBORD, AND TO OTHER WORKS DEED FERFORMED ON OR NEAR THE SITE. CONTRACTOR IS RESPONSIBLE FOR ALL WALL MOUNTED SHEWING AND THE WORKS DESIGNED ON THE STORAGE OF ALL SOFT-GOODS (SMALLWALL MALL MOUNTED SHEW) THE THE PUBLIC SHEW THE SHEW THE REQUIRED LOCATIONS FOR ALL WALL MOUNTED SHEWING THE STORAGE OF ALL SOFT-GOODS (SMALLWARES, ETC.) DURING REGULAR CONSTRUCTION HOUSE. CONTRACTOR IS RESPONSIBLE FOR RECEIVING AND ON-SITE STORAGE OF ALL SOFT-GOODS (SMALLWARES, ETC.) DURING REGULAR CONSTRUCTION HOUSE. CONTRACTOR SHALL CONTROL NOISE PRODUCING ITEMS (STEREOS) AT ALL TIMES. COORDINATION IN ADDITION TO GENERAL COORDINATION: COORDINATE THE INTERFACING OF ALL THE SAME ITEMS ARE LISTED BELOW. A COORDINATION WITH LITTLITY COMPANIES FOR SEPANCE INCLUDING WATER SEWER CAS AND SITE CERTIFICAL COORDINATE THE MIST HE WAS THE LISTED BELOW. WHICH RELATE TO THE DOLLDING AND WHIGH THE CONTROL OF SET WICE INCLUDING WATER, SEWER, GAS AND ELECTRICAL SERVICES. VERIEY POINTS OF CONNECTION IN FIELD. 5. CONTRACTOR WILL PROVIDE TEMPORARY 42° HIGH PROTECTIVE RAILING AT ALL OPENINGS WHERE SUCH OPENINGS ARE MORE THAN 30 INCHES ABOVE GRADE OR FLOOR BELOW, 6. CONTRACTOR SHALL PROVIDE SAMPLES OF ALL NON-BUILDING STANDARD MATERIALS FOR REVIEW BY TENANT REPRESENTATIVE OR ARCHITECT, REFER TO FINISHES PLAN FOR RECUIRED ITEMS. 7. ALL WORK AND MATERIALS USED TO ACCOMPLISH DESIGNATED WORK SHALL BE COORDINATED WITH CONTRACTOR, TENANT REPRESENTATIVE (WHEN APPLICABLE) AND BUILDING OWNER REPRESENTATIVE WITH RESPECT TO DELIVERY AND STORAGE. CONTRACTOR SHALL BE RESPONSIBLE FOR INITIATING, MAINTAINING, AND SUPERVISING ALL SAFETY PRECAUTIONS IN CONNECTION WITH THE WORK, AND SHALL COORDINATE SUCH WITH TENANT REPRESENTATIVE. 19. CONTRACTOR SHALL PERFORM NO PORTION OF THE WORK AT ANY TIME WITHOUT APPROVED CONTRACT DOCUMENTS. 20 CONTRACTOR IS RESPONSIBLE FOR COORDINATING ALL ARCHITECTURAL MECHANICAL TELEPHONE ELECTRICAL (INCLUDING LIGHTING), AND PLUMBING SO TO ENSURE THAT REQUIRED CLEARANCES FOR INSTALLATION AND MAINTENANCE OF ALL EQUIPMENT ARE PROVIDED. DIMENSIONS SHALL NOT BE CHANGED WITHOUT ARCHITECTS WRITTEN APPROVAL CONTRACTOR TO PROTECT EXISTING CONSTRUCTION AND RESTORE ALL FINISH SURFACES TO THEIR ORIGINAL CONDITION WHERE DAMAGED. CONDITION WHERE DAMAGED. 33. CONTRACTOR TO COORDINATE ACTIVITIES WITH BUILDING REPRESENTATIVES AND/OR TENANTS. 24. CONTRACTOR SHALL SUBMIT ALL SAMPLES PER SPECIFICATIONS OR AS REQUESTED BY OWNER. ALL SAMPLE SHALL BE APPROVED AND SIGNED OFF BY DESIGNER PRIOR TO CONSTRUCTION. 25. ALL FASTENERS AND CONNECTORS WITHIN 3' OF GRADE OR EXPOSED TO THE ELEMENTS SHALL BE TRIPLED-DIPPED GALVANIZED OR STAINLESS STEEL 26. THE CONTRACTOR'S ATTENTION IS DIRECTED TO THE FACT THAT THE ADJACENT SPACES IN THE BUILDING ARE OCCUPIED AND OPERATIONAL ALL EFFORTS SHALL BE TAKEN TO MINIMIZE OF THE BUILDING AND TO AVOID ANY UNSCHEDULED SERVICES INTERRUPTION. 27. ANY PART OF THE ADJACENT BUILDING THAT BECOMES SOILDED OR DAMAGED DUE TO THIS WORK DURING ANY PHASE OF CONSTRUCTION SHALL BE CLEANED, REPARED, OR REPLACED BY THE GENERAL CONTRACTOR AT NO EXPENCE TO THE OWNER OR TENANT. 28. WORKS SHALL BE PERFORMED IN AN ORDERLY AND CAREFUL MANNER WITH DUE CONSIDERATION FOR THE SAFETY AND PROTECTION OF ALL PERSONNEL, EXISTING SURFACES, MATERIALS, AND EQUIPTMENT, PROTECTIVE AND DUST-PROTECTIVE DEVICES SHALL BE INSTALLED AND MAINTAINED AS NECESSARY, AND AS REQUIRED BY DUST-PROTECTIVE DEVICES SHALL BE INSTALLED AND MAINTAINED AS NECESSARY, AND AS REQUIRED BY OWNER/CLENT. 29. ALL WORK SHALL BE PERFORMED SO THAT THERE IS MINIMUM INTERFERENCE WITH ADJACENT PROPERTY. 30. ALL MATERIAL SHALL BE REMOVED BY THE APPROPRIATE LECENSED CONTRACTOR, REMOVED UNDER THE STRICT QUIDELINES OF THE MATERIAL. TO BE DISPOSED OF AT APPROPRIATE LEGAL LOCATION AWAY FROM THE SITE PER REGULATING AUTHORITY. 31. DETAILS TO SUPERSEDE LARGER PLANS, SECTIONS, ELEVATIONS, ETC. 32. WHENEVER REQUIRED IN THESE DOCUMENTS, CONTRACTOR S SHALL OBTAIN OWNER/ARCHITECT APPROVAL PRIOR TO PURCHASE, FABRICATION, OR INSTALLATION. 33. THE CONTRACTOR'S COST SHALL INCLIDE THE COST OF PROPER INSURANCE AS REQUIRED BY THE LAWS OF STATE, LOCAL OR BUILDING REGULATIONS OR CODES TO ADEQUATELY PROTECT PERSONS AND LABILITY. 34. THE CONTRACTOR'S RAIL PROVIDE. ENGINEER, MAINTAIN AND BE RESPONSIBLE FOR THE INTEGRITY AND ADEQUACY OF ALL SCAFFOLDING, DUST BARRIERS, BARRICADES, BRACING, SHORMS, STRUCTURAL SYSTEMS AND TEMPORARY CONSTRUCTION REQUIRED FOR THE INSTALLATION OF NEW YORK. 35. SUBSTITUTION REQUIRED FOR THE INSTALLATION OF NEW YORK. 36. SUBSTITUTION REQUIRES FOR THE INSTALLATION OF NEW YORK. 37. SUBSTITUTION REQUIRES FOR THE INSTALLATION OF NEW YORK. 38. SUBSTITUTION REQUIRES FOR THE INSTALLATION OF NEW YORK. 39. SUBSTITUTION REQUIRES FOR THE INSTALLATION OF NEW YORK. 30. SUBSTITUTION REQUIRES FOR THE DESCRIPER PROVOL BY THE DESIGNER, ALL CONTRACTOR'S SUBSTITUTION REQUESTS CONSTITUTE A REFRESENTATION THAT THE CONTRACTOR. 39. ALL SCAFFOLDING PROPOSED PROQUED THE ORDER FOR THE THE STALL THE SECRET OR THE SECRET BY DROUGH AND SHALL RESPECTED PRODUCT. RESPECTS. THE SPECIFIED PRODUCT. B) WILL PROVIDE THE SAME WARRANTY FOR THE SUBSTITUTION AS FOR THE SPECIFIED PRODUCT. WILL COORDINATE INSTALLATION AND MAKE OTHER CHANGES WHICE MAY BE REQUIRED FOR WORK TO BE COMPLETED IN ALL RESPECTS WALL CLAIMS FOR ADDITIONAL COSTS WHICH SUBSEQUENTLY BECOMES APPARENT. WILL PAY COSTS OF CHANGES TO DRAWINGS, DETAILS AND SPECIFICATIONS REQUIRED BY APPROVED SUBSTITUTIONS. REUTD SPECIAL INSPECTIONS SPECIAL INSPECTIONS SPECIAL INSPECTOR SHALL BE A QUALIFIED PERSON WHO SHALL DEMONSTRATE COMPETENCE, TO THE SATISFACTION OF THE BUILDING OFFICIAL. NAMES AND QUALIFICATIONS OF SPECIAL INSPECTIONS) SHALL BE SUBMITTED BY THE CONTRACTOR TO THE BUILDING DEPARTMENT FOR APPROVAL. INSPECTIONS INCLUDE BUT NOT LIMITED TO: STL. STRUC. (T) T.C. T.W. TYP. U.O.N. CONCRETE BOLTS INSTALLED IN CONCRETE, INCLD, EPOXY, CONCRETE MOMENT RESISTING SPACE FRAME REINFORCING STEEL AND RESTRESSING STEEL REINFORCING STEEL AND RESTRESSING STEEL FRAMES ALL STRUCTURAL WELDING INCLUDING REINFORCED STEEL HIGH STRENGTH BOLTING STRUCTURAL MASONRY REINFORCED GYPSUM CONCRETE INSULATING CONCRETE FILL SPRAY APPLIED FIREPROOFING DEEP FOUNDATIONS (PILLING DRILLED PIERS & CLASSONS) SHOTCRETE 11. DEEP FUUNDATIONS (PILLING DYNLLED FILLING & GOLDSON) SHOTORETE 13A. VERIFY THAT FOUNDATION EXCAVATIONS EXTENT TO PROPER DEPTH AND BEARING STRATA 13B. PROVIDE SOIL COMPACTION TEST RESULTS, DEPTH OF FILL, RELATIVE DENSITY, BEARING VALUES, IF ANY 13C. PROVIDE SOIL EXPANSION TEST RESULTS, EXPANSION INDEX, RECOMMENDATIONS FOR FOUNDATIONS, ON GRADE FLOOR SLAB DESIGN FOR EACH BUILDING SITE 14. SPECIAL CASES AS RECO'D. 15. OFF-SITE FABRICATION OF BUILDING COMPONENTS 16. OTHER STRUCTURAL INSPECTION AS REQUIRED BY DESIGNER AND/OR THE BUILDING DEPARTMENT (REFER TO DEPARTMENT'S REQUIRED DOCUMENTS)

REV.	SYMBOL	.S		
ANGLE AT NUMBER	1			
ABOVE FINISH FLOOR APPROXIMATE ALUMINUM ARCHITECTURAL	A	COLUMN OR GRID LINE		UNDISTURBED FILL
BUILDING BOTTOM		- DETAIL NO.		FILL
BOTTOM OF POOL CEILING CLEAR		- SHEET NO.	<b>75</b>	SAND/MORTAR
COLUMN CONCRETE CONTINUOUS CENTER	ROOM NAME 101 C.H. 9'-0" —	- CEILING HT.		BRICK
DIAMETER DIMENSION		ELEV. NO.		CONCRETE
DOWN DRAWING DOUBLE		SHEET NO.		ASPHALT SHINGLE
DETAIL EXISTING EACH	-	SECTION NO. SHEET NO.		STEEL
ELEVAT <b>I</b> ON ELECTR <b>I</b> CAL EQUAL	$\bigcirc$	MATCH LINE		WOOD FINISHED
EQUIPMENT EACH SIDE FLOOR DRAIN	1	PLAN DETAIL		WOOD FRAMING THROUGH MEMBER
FINISH FLOOR FACE ON CONCRETE	$\longrightarrow$	DETAIL		WOOD INTERRUPTE MEMBER
FACE ON FINISH FACE ON JAMB FACE ON STUD	•	WORK POINT, CONTROL		PLYWOOD
FACE ON WALL FINISH GRADE FINISH SURFACE	r	POINT OR DATUM POINT		GLASS
GAUGE GALVANIZED GALVANIZED IRON	(A)	WINDOW TYPE		ACOUSTIC TILE OR BOARD
GYPSUM BOARD HOLLOW METAL HARDWARE	101A	DOOR NUMBER	74.75	GYPSUM BOARD
HIGH POINT HIGHT	<b>•</b>	NORTH ARROW		RIGID INSULATION
JANITOR MAXIMUM MECHANICAL	<u>/2\</u>	REVISION		CERAMIC TILE
MINIMUM METAL MANUFACTURER	A	WALL/PARTITION TYPE	ZZ Z Z Z	PLASTER ON METAL LATH
MISCELLANEOUS NEW		ALIGN SURFACES		FIRE SPRINKLER
NOT IN CONTRACT NOMINAL NOT TO SCALE ON CENTER OR APPROVED		PROPERTY LINE	*	NFPA 13-R COMPLIANT
OLTSIDE DIAMETER OPENING PLASTIC LAMINATE PLYWOOD RISER				

	AUTHORITY: CITY & COUNTY OF SAN FRANCISCO CODES:  2016 CALIFORNIA GREEN BUILDING STANDARDS CODE 2016 CALIFORNIA BUILDING CODE, TITLE 24, PART 2 2016 CALIFORNIA BUILDING CODE, TITLE 24, PART 9 2016 CALIFORNIA ENERGY CODE, TITLE 24, PART 6 2016 CALIFORNIA MECHANICAL & PLUMBING CODE (CMC) 2016 CALIFORNIA ELECTRICAL CODE (CEC)  BUILDING ANALYSIS  BLOCK/LOT: 0078/022  EXISTING NEW ZONING RH-3 NO CHANGE OCCUPANCY R3 NO CHANGE CONSTRUCTION TYPE VB VA UNITS 2 NO CHANGE STORIES 2 3  SETBACK: FRONT 0'0" NO CHANGE FRONT 0'0" NO CHANGE REAR 17'6" NO CHANGE HEIGHT LIMIT 40'0" NO CHANGE  BUILDING AREAS  BUILDING AREAS  EXISTING NEW TOTAL 2,310 SF 4,179 SF CONDITIONED 1,673 SF 3,647 SF UNCONDITIONED 637 SF 532 SF  BASEMENT FLOOR(LOWER UNIT#1)				lυ	RAW	ING INDEX
	AUTHORITY: CITY & COUNTY O	F SAN FR	RANC	CISCO	1	co	PROJECT DATA, DRAWING INDEX, ABBREV. & SYMBOLS
					2	CO2	SITE PHOTOS
					3	CO3	TANTAMOUNT TO DEMOLITION PLAN & DIAGRAM
		Chority: City & County of San Francisco			4	CO4	PROPERTY RECORD
	2016 CALIFORNIA GREEN BUILDING STANDARDS CODE 2016 CALIFORNIA BUILDING CODE, TITLE 24, PART 2 2016 CALIFORNIA BUILDING CODE, TITLE 24, PART 9 2016 CALIFORNIA ENER CODE, TITLE 24, PART 6 2016 CALIFORNIA MECHANICAL & PLUMBING CODE (CMC) 2016 CALIFORNIA ELECTRICAL CODE (CEC)  ULLDING ANALYSIS  DCK/LOT: 0078/022  EXISTING NEW NING RH-3 NO CHANGE CUPANCY R3 NO CHANGE NSTRUCTION TYPE VB VA ITS 2 NO CHANGE DRIES 2 3  TBACK: DNT 0'0" NO CHANGE					A100	(E) & (N) SITE PLANS
					6	A101	(E) & (N) BASEMENT FLOOR PLAN
				,	7	A102	(E) & (N) 1ST FLOOR PLAN
	BUILDING ANALYSIS					A103	(E) & (N) 2ND FLOOR PLAN
_					9	A104	(N) 3RD & ROOF FLOOR PLANS
					10	A105	(N) ROOF PLANS
					11	A301	(E) FRONT ELEVATION
					12	A302	(N) FRONT ELEVATION
					13	A303	(E) REAR ELEVATION
					14	A304	(N) REAR ELEVATION
	o roruzo	-		Ŭ	15	A305	(E) SIDE (EAST) ELEVATION
		01011		NO OUNDE	16	A306	(N) SIDE (EAST) ELEVATION
					17	A307	(E) SIDE (WEST) ELEVATION
					18	A308	(N) SIDE (WEST) ELEVATION
					19	A309	URBAN BIRD REFUGE GLAZING CALCULATION
	BUILDING AREAS	5			20	A401	(E) & (N) TRANSVERSE SECTION
	E	XISTING		NEW	21	A402	(E) LONGITUDINAL SECTION
					22	A403	(N) LONGITUDINAL SECTION
					23	A801	WINDOW SCHEDULE & DETAILS
				002 0.	24	A802	DOOR SCHEDULE & DETAILS
	BASEMENT FLOOR(LOWER UNIT TOTAL		SF	1045 SE	25	T24-1	TITLE 24 ENERGY CALCULATIONS 1
	CONDITIONED	0 8	SF	602 SF			
	UNCONDITIONED	519 5	SF		26	T24-2	TITLE 24 ENERGY CALCULATIONS 2
				(W/GAINAGE 2090I )	27	T24-3	TITLE 24 ENERGY CALCULATIONS 3
	FIRST FLOOR(LOWER UNIT#1)	707 6	<b>.</b> -	4 400 05	28	S1.0	STRUCTURAL GENERAL NOTES
					29	S2.1	STRUCTURAL GENERAL NOTES
	UNCONDITIONED				30	S2.2	FOUNDATION PLAN
	050010 51 000 (10050 11117(0)				31	S2.3	1ST FLOOR FRAMING PLAN & WALLS BELOW
	SECOND FLOOR(UPPER UNIT#2) TOTAL		SF	1,174 SF	32	S2.4	2ND FLOOR FRAMING PLAN & 1ST FLOOR SHEAR
	CONDITIONED	1004 S	SF	1,174 SF			WALLS BELOW  3RD FLOOR FRAMING PLAN & 2ND FLOOR SHEAR
	UNCONDITIONED	0 8	SF	NO CHANGE	33	S2.5	WALLS BELOW
	THIRD FLOOR(UPPER UNIT#2)						4TH FLOOR FRAMING PLAN & 3RD FLOOR SHEAR
	TOTAL		SF	837 SF	34	S2.6	WALLS BELOW ROOF FRAMING PLAN & 3RD FLOOR SHEAR WALLS
	CONDITIONED UNCONDITIONED		SF SF	837 SF NO CHANGE			BELOW
-	CONTACT INFO						
	OWNER:	ARCH	TEC	T/ENGINEER:			
OWN	DAVID & VIVIAN MATSUO			ECTURE			

DRAWING INDEX

# 408-656-6527

PROJECT CODE SUMMARY

472 GREENWICH ST. 4243 25TH STREET SAN FRANCISCO CA 94133 SAN FRANCISCO, CA 94114 415-695-2700 DVMATSUO@YAHOO.COM CONTACT: DAWN MA, PE, AAIA DMA@QUE-ARCH.COM CONTRACTOR:

# PROJECT DESCRIPTION

VERTICAL & HORIZONTAL ADDITION OF (E) 2-UNIT RESIDENTIAL BLDG. ADD 1-CAR GARAGE INTERIOR REMODEL.

### DEFERRED SUBMITTALS:

- WHOLE HOUSE FIRE SPRINKLERS UNDER SEPARATE PERMIT PER SFBC 2015. PROVIDE NFPA-13R FOR (N) UNIT & RATED EGRESS

### - MEP UNDER SEPARATE PERMIT.

- FIRE ALARM UNDER SEPARATE PERMIT PER SFFD PER AB 2.011 OR AB-4.11 (SPRINKLER WATER FLOW MONITORING)

**VICINITY MAP** 



PROJECT SITE

# architecture

### Q-ARCHITECTURE, INC.

4243 25th St. San Francisco, CA 94114 T +1 415 695 2700 F +1 415 695 1308 www.que-arch.com

# **ADDITION** REMODEL

FOR

472 GREENWICH ST SAN FRANCISCO CA 94133

BLOCK/LOT: 0078/022




	RE\	/ISIONS
NO.	DATE	DESCRIPTION
	12/21/18	PRE-APP MEETING
	07/ /19	PERMIT SUBMITTAL
	06/25/19	RESPONSE TO PLANNING PCC
1	07/28/20	RESPONSE TO PLANNING PCC
2	02/17/21	RESPONSE TO PLANNING PCC
3	06/27/21	RESPONSE TO PLANNING PCC

# SHEET TITLE


# PROJECT DATA, DRAWING INDEX ABBREV. & SYMBOLS


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SCALE: N/A	DATE: 08/06/21
DRAWN BY:	YB/SX/DM
FILE:	18144_CO.dwg
DRAWING NO	D: 1 OF
CHEET NO:	


CO

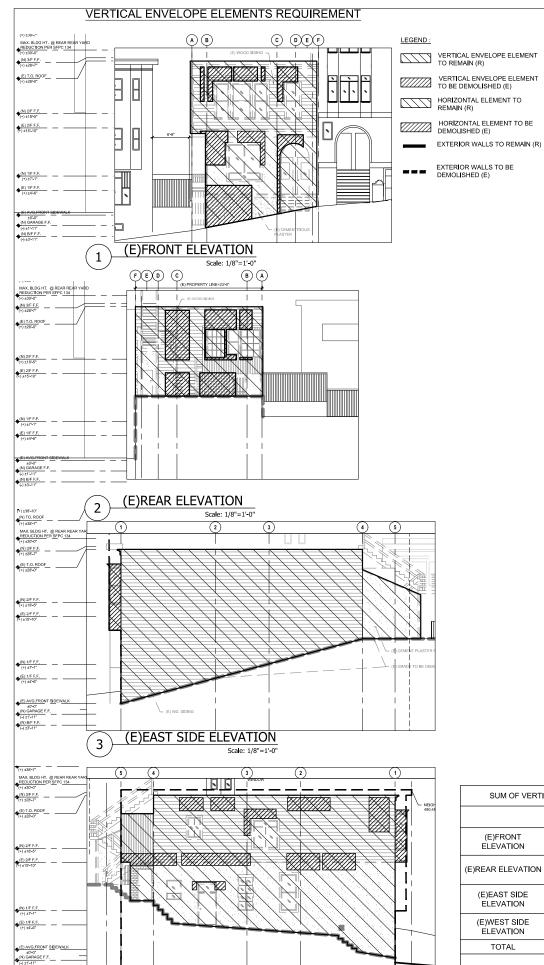

(E)WEST SIDE ELEVATION

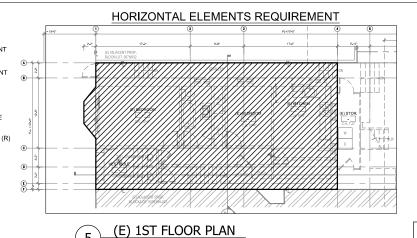

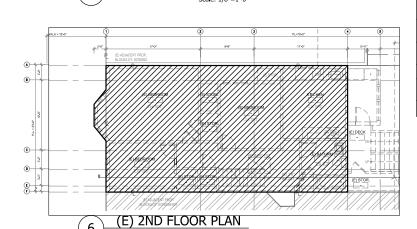

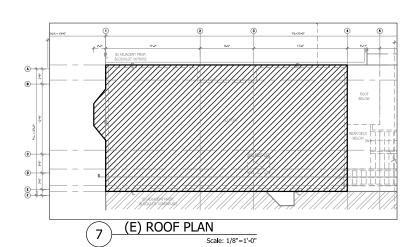

SUM OF VERTICAL ENVELOPE ELEMENTS IN SQ.F.T							
	(E) TOTAL TO REMAIN DEMOLISH						
(E)FRONT ELEVATION	599	445	154				
(E)REAR ELEVATION	376	256	120				
(E)EAST SIDE ELEVATION	1108	1082	26				
(E)WEST SIDE ELEVATION	1204	1020	184				
TOTAL	3287	2803	484				
	100%	86%	14%(<50%)				
	(MAX. DEM	O < 50%)					

6

SUM OI	F HORIZONT	AL ELEMENTS I	N SQ.F.T
	(E) TOTAL		
	(L) ISTAL	TO REMAIN	DEMOLISH
(E)1ST FL PLAN	808	0	808
(E) 2ND FL PLAN	1089	0	1089
(E)ROOF PLAN	1082	0	1082
TOTAL	2979	0	2979
	100%	0	100%(>50%)
	(MAX. D	EMO < 50%)	


# FRONT AND REAR FACADE REQUIREMENT --

FOUNDATION LEVEL

FRONT AND REAR FACADE MEASURED IN LINEAR FEET AT FOUNDATION LEVEL						
LINEAR	FEETATEC	UNDATION LEV	EL			
TO REMAIN DEMOLISH TOTAL						
FRONT ELEVATION	12	8	20			
REAR ELEVATION	_	20	20			
TOTAL	12	28	40			
	30%	70%(>50%)	100%			
(MAX. DEMO < 50%)						

EXTERIOR WALLS MEASURED IN LINEAR FEET AT FOUNDATION LEVEL						
	TO REMAIN DEMOLISH					
FRONT ELEVATION	12	8	20			
REAR ELEVATION	-	20	20			
EAST ELEVAT <b>I</b> ON	44	_	44			
WEST ELEVATION	•	44	44			
TOTAL	52	72	128			
	44%	56%(<65%)	100%			
(MAX. DEMO < 65%)						

### FRONT AND REAR FACADE REQUIREMENT

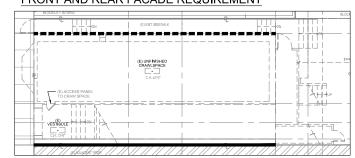

### FOUNDATION LEVEL Scale: 1/8"=1'-0"

### SUMMARY TABLE NON-DEMOLITION DEMONSTRATION

SEC.317-LOSS OF DWELLING UNITS THROUGH MERGER, CONVERSION, AND DEMOLITION				
CODE REQ. (E) BUILDING		REMAINING IN PROPOSED	OUTCOME(CODE)	COMPLIANCE
FRONT+REAR FACADE (LINEAR FT AT FOUNDATION)	FRONT=20 REAR=20 TOTAL=40	FRONT=12 REAR=0 TOTAL=12	30% REMAINING OR 70% DEMO >50% (CODE)	Х
ALL EXTERIOR WALLS (LINEAR FT AT FOUNDATION)	FRONT=20 REAR=20 EAST=44 WEST=44 TOTAL=128	FRONT=12 REAR=0 EAST=44 WEST=0 TOTAL=56	44% REMAINING OR 56% DEMO <65% (CODE)	
VERTICAL ENVELOPE (SF OF SURFACE AREA)	FRONT=599 REAR=376 EAST=1108 WEST=1204 TOTAL=3287	FRONT=445 REAR=256 EAST=1082 WEST=1020 TOTAL=2803	86% REMAINING OR 14% DEMO <50% (CODE)	
HORIZONTAL ELEMENTS (SF OF SURFACE AREA)	1ST=808 2ND=1089 ROOF=1082 TOTAL=2979	1ST=0 2ND=0 ROOF=0 TOTAL=0	0% REMAINING OR 100% DEMO >50% (CODE)	х



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> **ADDITION** REMODEL

> > FOR

472 GREENWICH ST SAN FRANCISCO CA 94133

BLOCK/LOT: 0078/022



	RE\	/ISIONS
NO.	DATE	DESCRIPTION
	12/21/18	PRE-APP MEETING
	07/ /19	PERMIT SUBMITTAL
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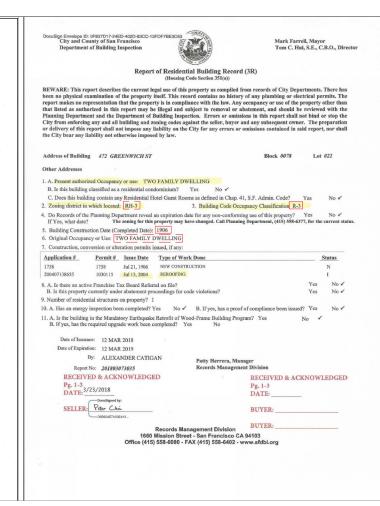
SHEET TITLE


# TANTAMOUNT TO **DEMOLITION PLANS** & DIAGRAM

JOB NO: 18-14	14	
SCALE: N/A	DATE:	08/06/21
DRAWN BY:	YB/SX/DM	
FILE:	18144_CO.dwg	
DRAWING NO:	1b OF	
011555110		

CO<sub>3</sub>

P	
RANCISCO	
1 (1)	
Bd. of Pub. Works	
RTMENTO I	
17 KELITO I TO INCOME MANUAL M	
buildings. Plans and Specifications must be fastened together.	
APPLICATION FOR BUILDING PERMIT	
ALL EIGHTION FOR BUILDING FERMIT.	
FRAME BUILDING	
Application is hereby made to the Board of Public Works of the City and County of San Francisco for permission to	
build a two thry celling on the lot situated worth like breaming the	
near Dupont Strept	
in accordance with the plans and specifications submitted herewith.	4
All provisions of the building laws shall be complied with in the erection of said building, whether specified herein or	
not. Estimated cost of building & A.J.O Building to be occupied as duelling by (No.) Live families.	
Size of Lot 23	
Size of proposed building. 23 - ft. by 46 - ft. Extreme height of building 3.4 - ft	
Height in clear of cellar Height in clear of first story 10'6"	
Height in clear of second story ./O	
Height in clear of fourth story	
Foundation to be of (material) brick (thickness) /3" inches.	
Size footings. 18-24. inches. Greatest height. 5'6"	
Size of studs in basement	
Size of study in first story A Fricks by inches inches on centers.	
Size of studs in second story 2" by 4" inches /6" inches on centers.	
Size of studs in third story	
Size of studs in fourth story	4
Size of studs in fifth story	
Wall covering to be of pedwood	
First floor joists . 4." by . /P." inches . /b. inches on centers. Longest span between supports ft.	
Second floor joists. 22" by 10" inches	
Third floor joists by inches inches on centers. Longest span between supports ft.	
Fourth floor joists	
Fifth floor joists by, inches inches on centers. Longest span between supports ft.	
Rafters. 2."	
Roof covered with asphalting france Steep or Flat? flat.	
Studs in bearing pagitions A" inches inches inches on centers . Bearing partitions	
Chimneys of the lines lined with turns Cotto, plaserted go outside ones.	
Any gas grafes? Mr Any patent flues? Mr Is the building to be heated, and how? Mr	
Any openings to basement in sidewalk? Man	
There are to betwo stairways fit wide, located one my frank and one were	
I hereby agree to save, idemnify and keep harmless the City and County of San Francisco against all	
liabilities, judgments, costs and expenses which may in anywise accrue against said city and county in consequence of	
the granting of this permit, or from the use or occupancy of any sidewalk, street or sub-sidewalk place by virtue thereof, and will in all things strictly comply with the conditions of this Permit.	
COLL STATE OF THE CONTROL OF THE CON	
Name of Architect Alighetty & Kuly	
Address 1946 Part At Owner	
Name of Builder for Marion Address	
Address 1.5 Tage South and dameneld are By Phighette It King	
(Note-The owner's name must be signed by himself, or by his Architect or authorized Agent)	
And owner a name must be argued by minister, or by this Ariquitect or authorized Agent)	



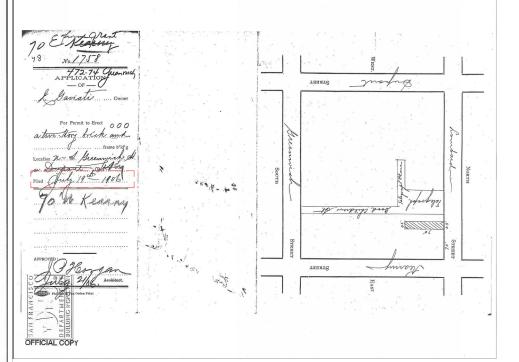



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# ADDITION REMODEL FOR

472 GREENWICH ST SAN FRANCISCO CA 94133

BLOCK/LOT: 0078/022




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		06/25/19	RESPONSE TO PLANNIN PCC	IC
	1	07/28/20	RESPONSE TO PLANNIN PCC	IC
	2	02/17/21	RESPONSE TO PLANNIN PCC	IC
	<u>3</u>	06/27/21	RESPONSE TO PLANNIN PCC	IC
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### SHEET TITLE

# PROPERTY RECORD

JOB NO: 18-1	44
SCALE: N/A	DATE: 08/06/21
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FILE:	18144_CO.dwg
DRAWING NO:	1b OF
SHEET NO:	

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# **ADDITION** REMODEL

FOR

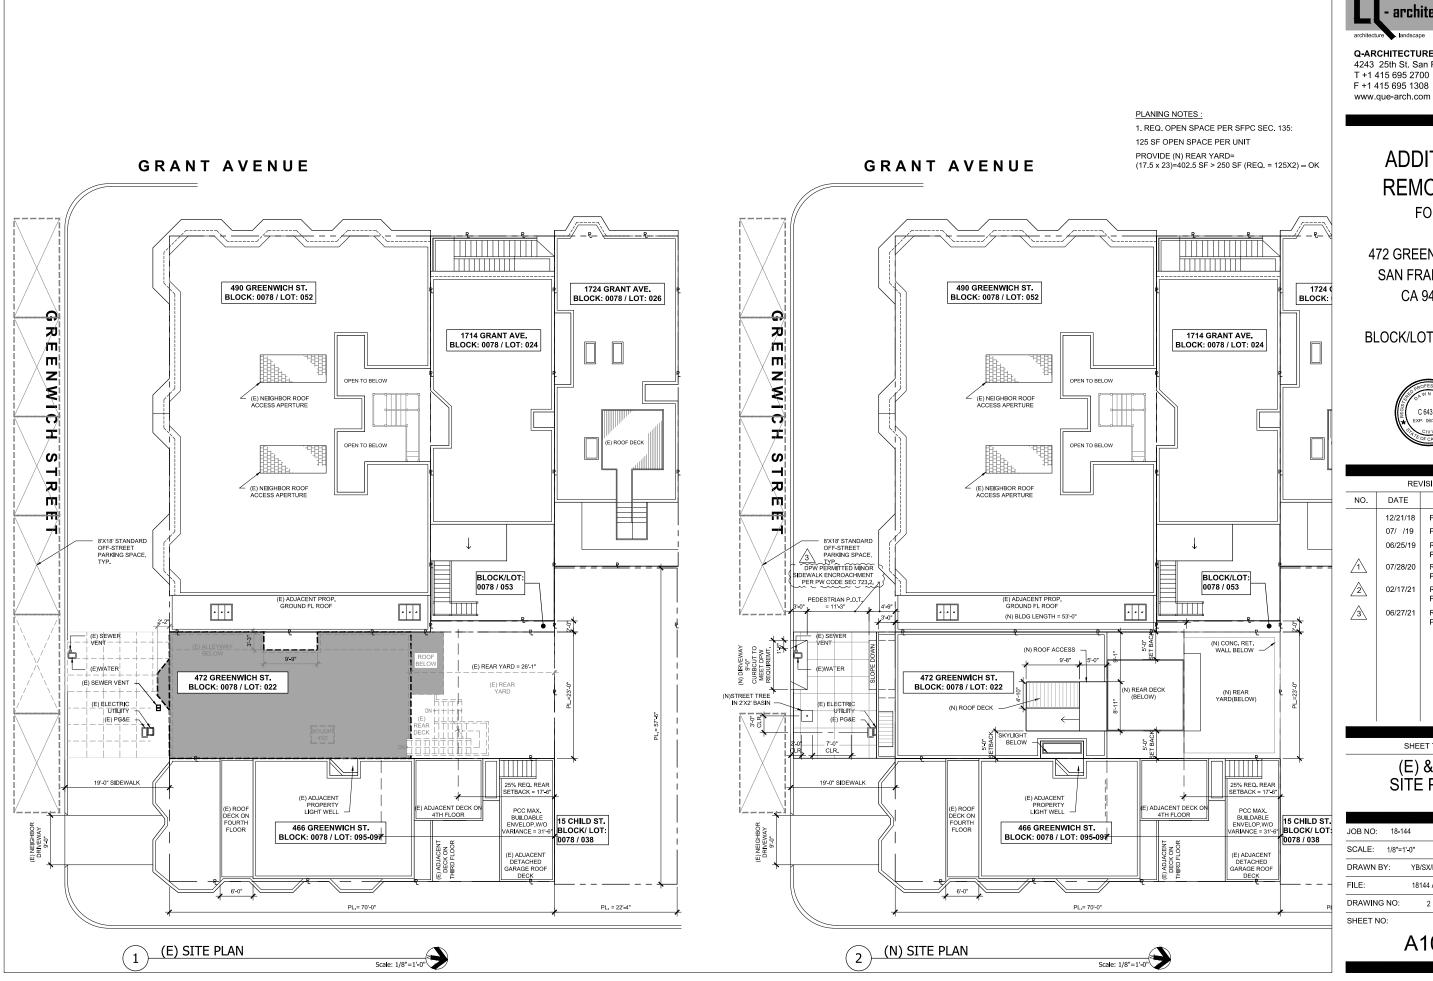472 GREENWICH ST SAN FRANCISCO CA 94133

BLOCK/LOT: 0078/022




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NO.	DATE	DESCRIPTION			
	12/21/18	PRE-APP MEETING			
	07/ /19	PERMIT SUBMITTAL			
•	06/25/19	RESPONSE TO PLANNING PCC			
1	07/28/20	RESPONSE TO PLANNING PCC			
2	02/17/21	RESPONSE TO PLANNING PCC			
3	06/27/21	RESPONSE TO PLANNING PCC			
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# SHEET TITLE (E) & (N)

# SÌTÉ PLÁN

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SHEET NO	<u></u>			

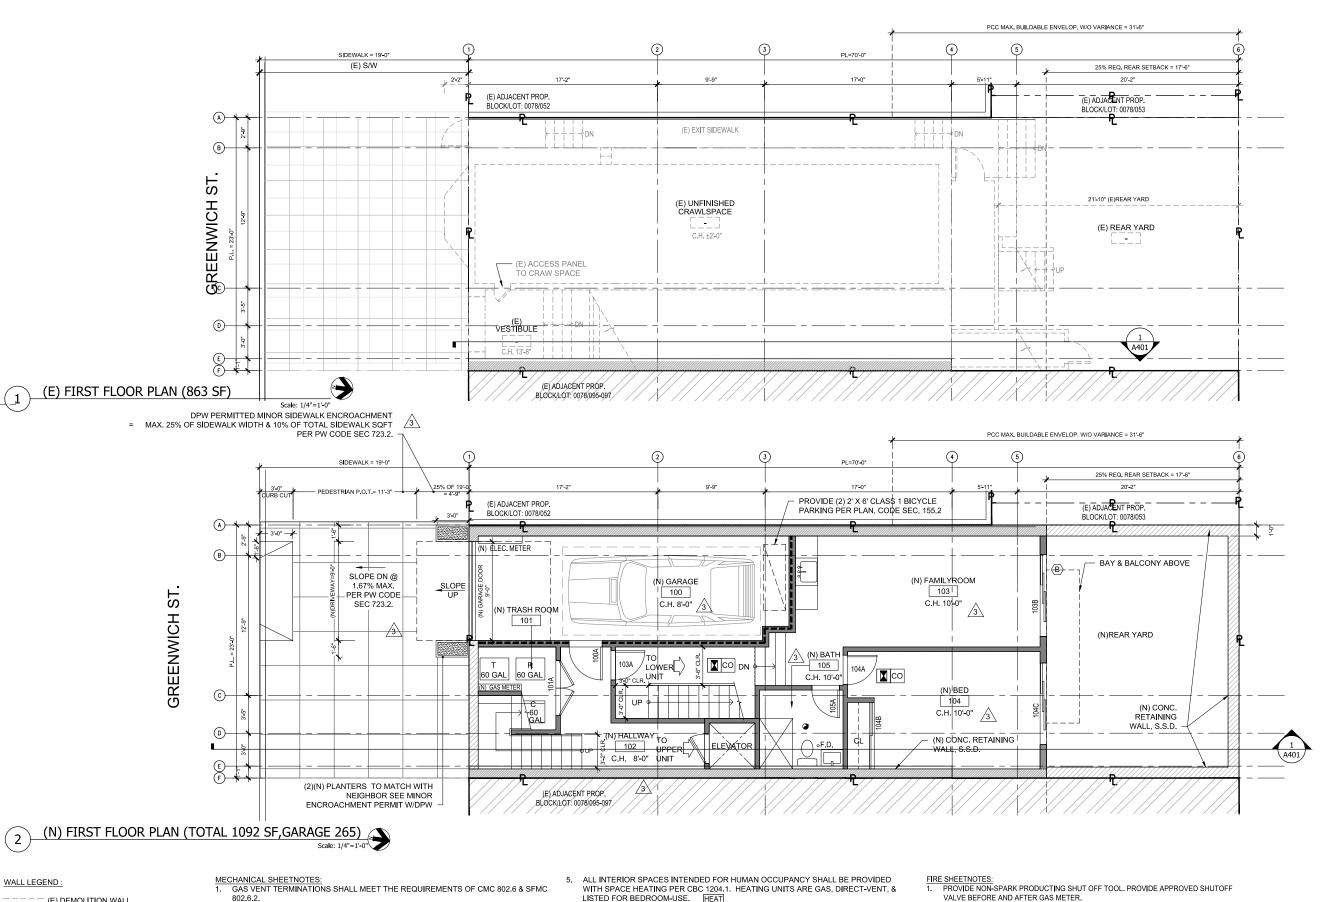

LISTED FOR BEDROOM-USE. HEAT CLOTHES DRYER EXHAUST SHALL BE A MINIMUM 4 INCHES, TERMINATE TO THE

AIR OPENING FOR DOMESTIC DRYERS.

OR EXTERIOR DOORS PER SFBC 406.3.3. 9. PROVIDE FLOOR DRAIN PER CPC. 418.3 oF.D.

LIGHTING PER CEC 150.0(K)

OUTSIDE OF THE BUILDING, SHALL BE EQUIPPED WITH A BACK-DRAFT DAMPER, AND

PROVIDE A MINIMUM 200 SQUARE INCH VENTILATION OUTLET IN THE GARAGE WALLS

MEET THE REQUIREMENTS OF CMC 504.4.2. PROVIDE 100 SQ. INCH MINIMUM MAKE-UP

\_\_\_\_ (E) DEMOLITION WALL

(N) WALL

\_ (E) WALL TO REMAIN

/////// (N) CONC. RET. WALL, S.S.D.

■■■■ (N) FIRE RATED WALL

COMBUSTION AIR SHALL MEET THE REQUIREMENTS OF CMC CHAPTER 7.

WITH BACK-DRAFT DAMPERS PER CMC 504.1.1.

COMPLY WITH CMC TABLE 403.7.

ENVIRONMENTAL AIR DUCTS SHALL TERMINATE 3 FEET FROM THE PROPERTY LINE AND 3 FEET FROM OPENINGS INTO THE BUILDING PER CMC 502.2.1 AND PROVIDE

DOMESTIC RANGE HOOD VENTS SHALL MEET THE REQUIREMENTS OF CMC 504.3 AND 7.

- PROVIDE (N) WALL-MOUNT FIRE EXTINGUISHER ADJ. TO EXIT STAIRS.
- PROVIDE "EXIT" SIGNAGE ON (N) EXIT CORRIDOR DOORS.
  PROVIDE HARDWIRED UL217 COMPLIANT SMOKE ALARMS PER SFBC CH.9 & 34. (NFPA 72, 907.2.10)
- 5. PROVIDE CARBON MONOXIDE ALARMS PER SFBC. CH.4 CO

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**ADDITION** REMODEL FOR

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472 GREENWICH ST SAN FRANCISCO CA 94133

BLOCK/LOT: 0078/022




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	07/ /19	PERMIT SUBMITTAL	
	06/25/19	RESPONSE TO PLANNI PCC	ING
1	07/28/20	RESPONSE TO PLANNI PCC	ING
2	02/17/21	RESPONSE TO PLANNI PCC	ING
3	06/27/21	RESPONSE TO PLANNI PCC	ING

SHEET TITLE

# (E) & (N) FIRST FLOOR & **PLANS**

JOB NO:	18-144		
SCALE:	1/4"=1'-0"	DATE:	08/06/21
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OR EXTERIOR DOORS PER SFBC 406.3.3.

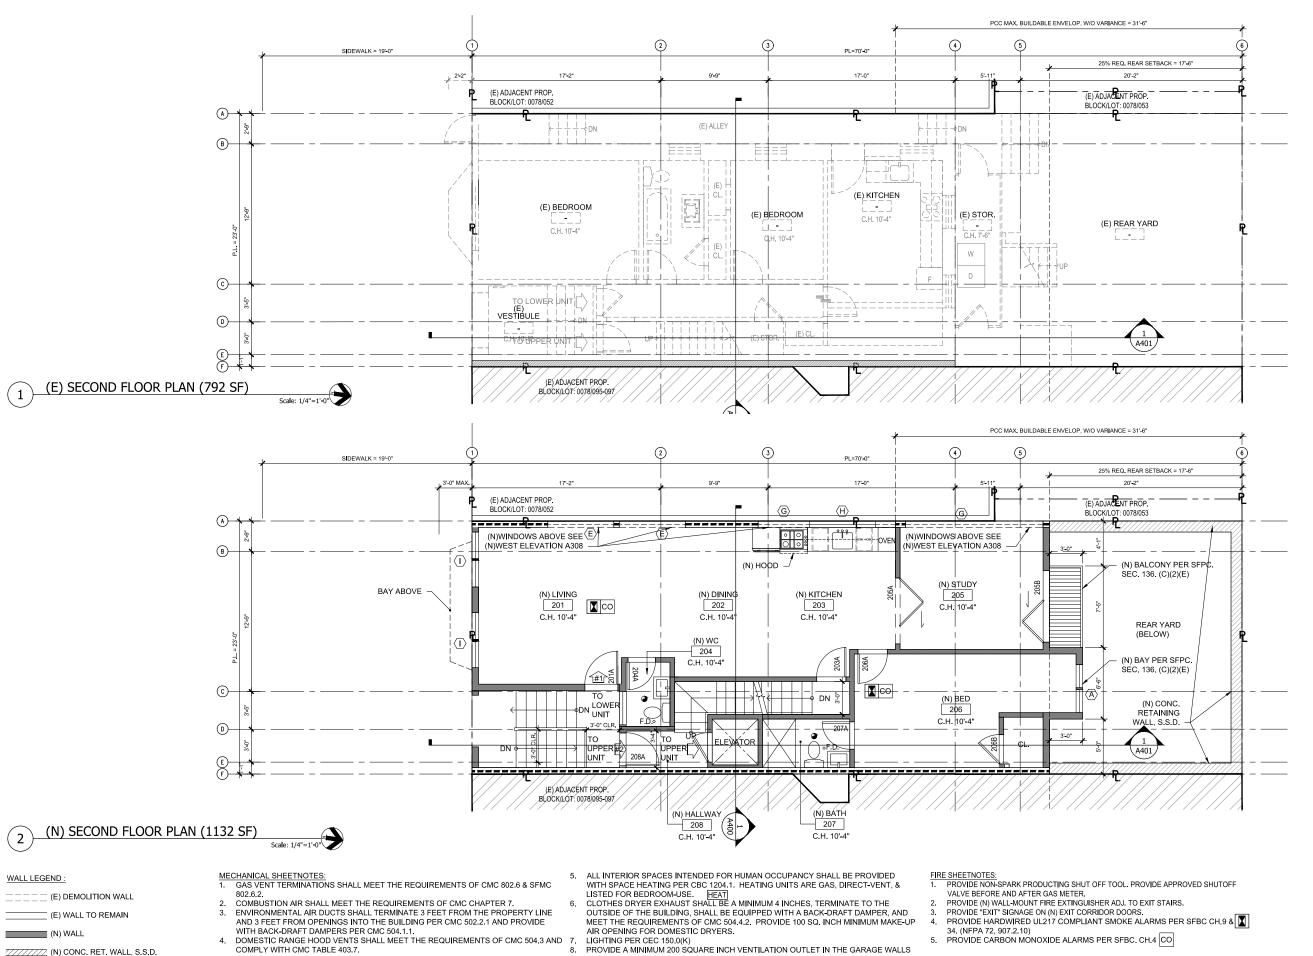9. PROVIDE FLOOR DRAIN PER CPC. 418.3 •F.D.

■■■■ (N) FIRE RATED WALL



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# ADDITION REMODEL FOR

472 GREENWICH ST SAN FRANCISCO CA 94133

BLOCK/LOT: 0078/022




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NO.	DATE	DESCRIPTION
	12/21/18	PRE-APP MEETING
	07/ /19	PERMIT SUBMITTAL
	06/25/19	RESPONSE TO PLANNING PCC
1	07/28/20	RESPONSE TO PLANNING PCC
2	02/17/21	RESPONSE TO PLANNING PCC
3	06/27/21	RESPONSE TO PLANNING PCC

SHEET TITLE

# (E) & (N) SECOND FLOOR PLANS

JOB NO:	18-144				
SCALE:	1/4"=1'-0"		DATE:	08/06/21	
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COMBUSTION AIR SHALL MEET THE REQUIREMENTS OF CMC CHAPTER 7.

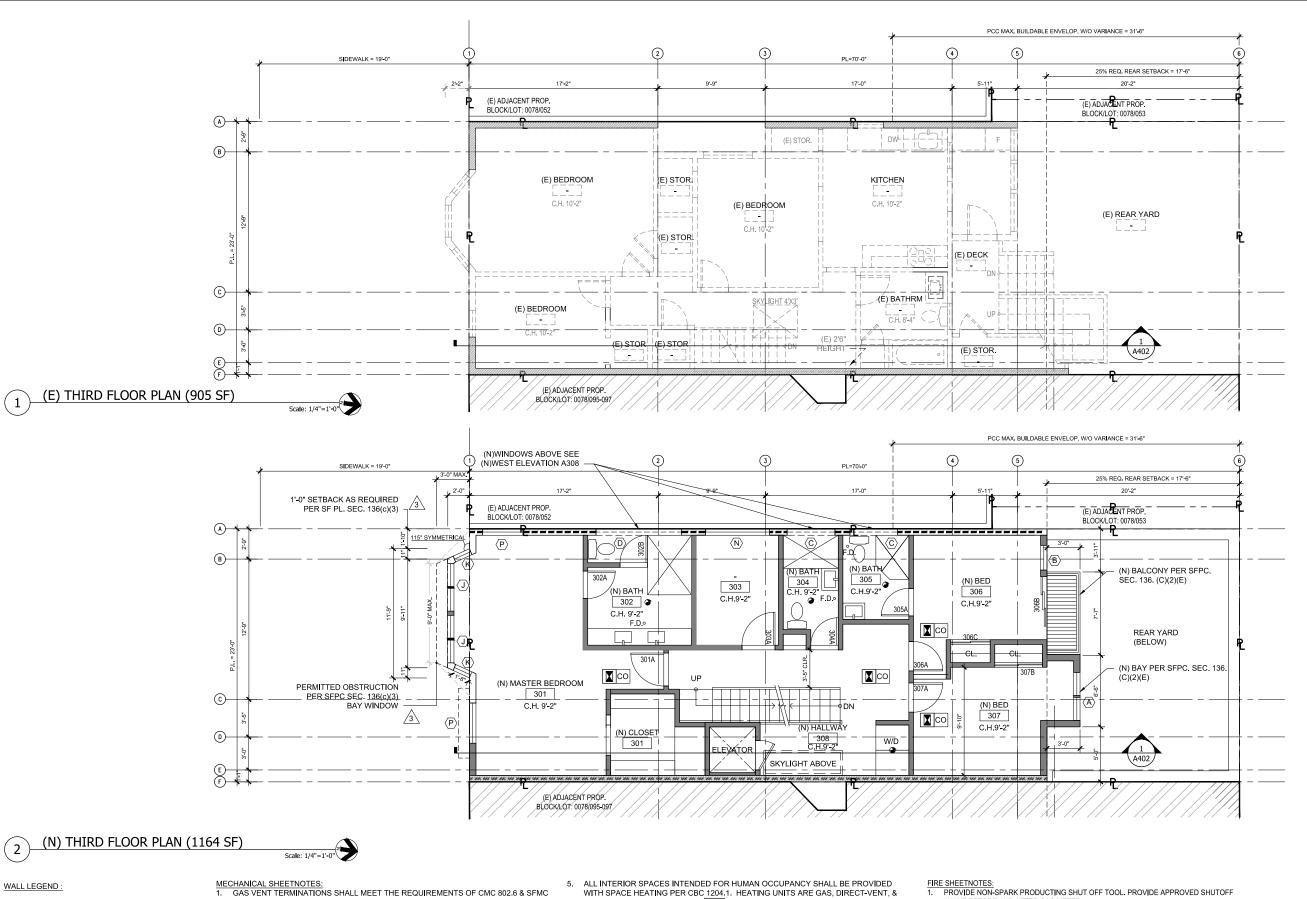\_\_\_\_ (E) DEMOLITION WALL

(N) WALL

(E) WALL TO REMAIN

/////// (N) CONC. RET. WALL, S.S.D.

■■■■ (N) FIRE RATED WALL

- ENVIRONMENTAL AIR DUCTS SHALL TERMINATE 3 FEET FROM THE PROPERTY LINE AND 3 FEET FROM OPENINGS INTO THE BUILDING PER CMC 502.2.1 AND PROVIDE WITH BACK-DRAFT DAMPERS PER CMC 504.1.1.
- 4. DOMESTIC RANGE HOOD VENTS SHALL MEET THE REQUIREMENTS OF CMC 504.3 AND 7. COMPLY WITH CMC TABLE 403.7.
- WITH SPACE HEATING PER CBC 1204.1. HEATING UNITS ARE GAS, DIRECT-VENT, &
- LISTED FOR BEDROOM-USE. HEAT CLOTHES DRYER EXHAUST SHALL BE A MINIMUM 4 INCHES, TERMINATE TO THE OUTSIDE OF THE BUILDING, SHALL BE EQUIPPED WITH A BACK-DRAFT DAMPER, AND MEET THE REQUIREMENTS OF CMC 504.4.2. PROVIDE 100 SQ. INCH MINIMUM MAKE-UP AIR OPENING FOR DOMESTIC DRYERS.
- LIGHTING PER CEC 150.0(K)
  - PROVIDE A MINIMUM 200 SQUARE INCH VENTILATION OUTLET IN THE GARAGE WALLS OR EXTERIOR DOORS PER SFBC 406.3.3.

    9. PROVIDE FLOOR DRAIN PER CPC. 418.3 •F.D.

- VALVE BEFORE AND AFTER GAS METER.
- PROVIDE (N) WALL-MOUNT FIRE EXTINGUISHER ADJ. TO EXIT STAIRS.
- PROVIDE "EXIT" SIGNAGE ON (N) EXIT CORRIDOR DOORS.
  PROVIDE HARDWIRED UL217 COMPLIANT SMOKE ALARMS PER SFBC CH.9 &
- 5. PROVIDE CARBON MONOXIDE ALARMS PER SFBC. CH.4 CO



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# **ADDITION** REMODEL FOR

472 GREENWICH ST SAN FRANCISCO CA 94133

BLOCK/LOT: 0078/022




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	12/21/18	PRE-APP MEETING
	07/ /19	PERMIT SUBMITTAL
•	06/25/19	RESPONSE TO PLANNING PCC
1	07/28/20	RESPONSE TO PLANNING PCC
2	02/17/21	RESPONSE TO PLANNING PCC
3	06/27/21	RESPONSE TO PLANNING PCC
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SHEET TITLE

# (E) & (N) THIRD FLOOR PLANS

JOB NO:	18-144				
SCALE:	1/4"=1'-0"		DATE:	08/06/21	
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SHEET NO	):				

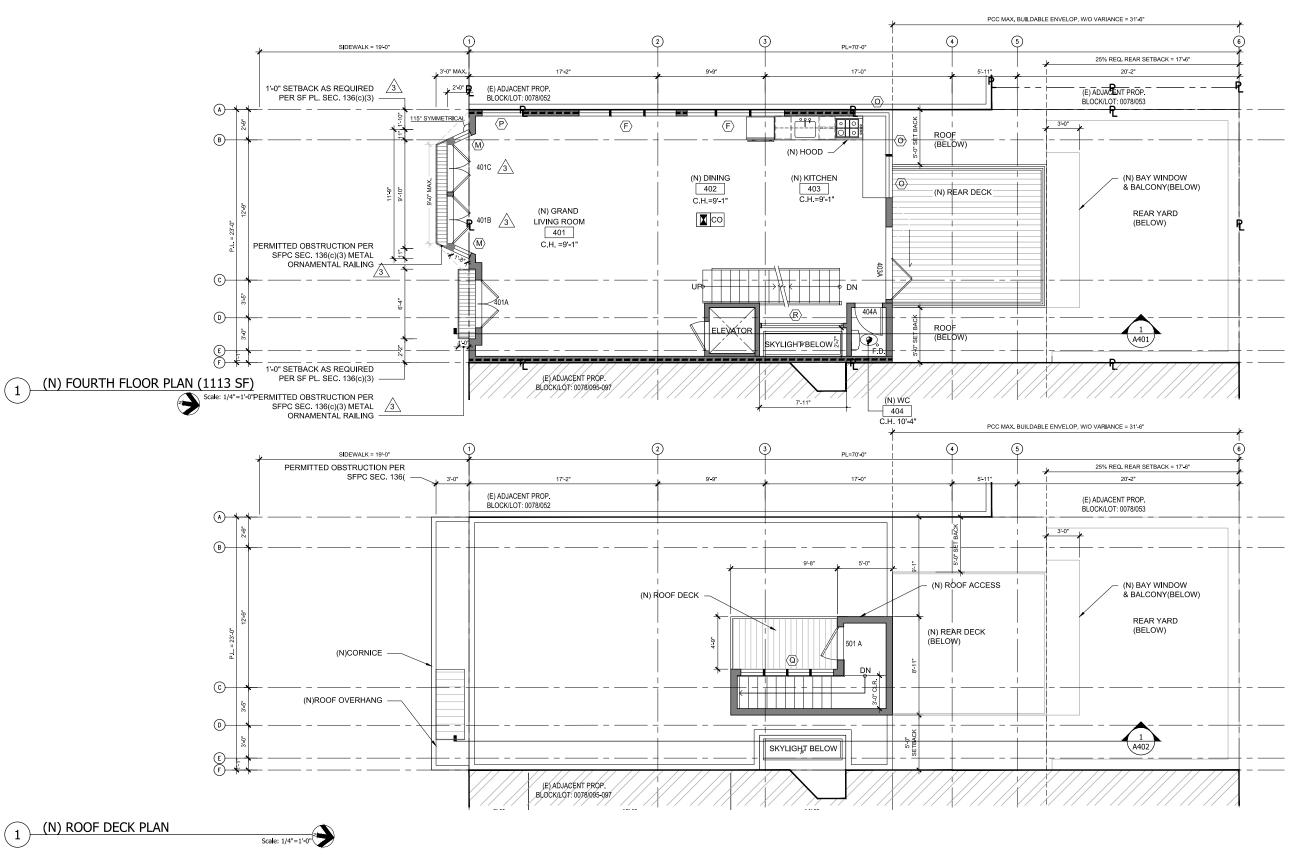

## WALL LEGEND:

\_\_\_\_ (E) DEMOLITION WALL

\_ (E) WALL TO REMAIN

(N) WALL

/////// (N) CONC. RET. WALL, S.S.D.

■■■■ (N) FIRE RATED WALL

- $\frac{\text{MECHANICAL SHEETNOTES:}}{\text{1. GAS VENT TERMINATIONS SHALL MEET THE REQUIREMENTS OF CMC 802.6 \& SFMC}}$
- COMBUSTION AIR SHALL MEET THE REQUIREMENTS OF CMC CHAPTER 7.
- ENVIRONMENTAL AIR DUCTS SHALL TERMINATE 3 FEET FROM THE PROPERTY LINE AND 3 FEET FROM OPENINGS INTO THE BUILDING PER CMC 502.2.1 AND PROVIDE WITH BACK-DRAFT DAMPERS PER CMC 504.1.1.
- 4. DOMESTIC RANGE HOOD VENTS SHALL MEET THE REQUIREMENTS OF CMC 504.3 AND 7. COMPLY WITH CMC TABLE 403.7.
- ALL INTERIOR SPACES INTENDED FOR HUMAN OCCUPANCY SHALL BE PROVIDED WITH SPACE HEATING PER CBC 1204.1. HEATING UNITS ARE GAS, DIRECT-VENT, &
- LISTED FOR BEDROOM-USE. HEAT CLOTHES DRYER EXHAUST SHALL BE A MINIMUM 4 INCHES, TERMINATE TO THE OUTSIDE OF THE BUILDING, SHALL BE EQUIPPED WITH A BACK-DRAFT DAMPER, AND MEET THE REQUIREMENTS OF CMC 504.4.2. PROVIDE 100 SQ. INCH MINIMUM MAKE-UP AIR OPENING FOR DOMESTIC DRYERS.
- LIGHTING PER CEC 150.0(K)
  - PROVIDE A MINIMUM 200 SQUARE INCH VENTILATION OUTLET IN THE GARAGE WALLS OR EXTERIOR DOORS PER SFBC 406.3.3.

    9. PROVIDE FLOOR DRAIN PER CPC. 418.3 •F.D.

- FIRE SHEETNOTES:

  1. PROVIDE NON-SPARK PRODUCTING SHUT OFF TOOL. PROVIDE APPROVED SHUTOFF VALVE BEFORE AND AFTER GAS METER.
- PROVIDE (N) WALL-MOUNT FIRE EXTINGUISHER ADJ. TO EXIT STAIRS.
- PROVIDE "EXIT" SIGNAGE ON (N) EXIT CORRIDOR DOORS.
  PROVIDE HARDWIRED UL217 COMPLIANT SMOKE ALARMS PER SFBC CH.9 &
- 5. PROVIDE CARBON MONOXIDE ALARMS PER SFBC. CH.4 CO



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# **ADDITION** REMODEL FOR

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BLOCK/LOT: 0078/022




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	NO.	DATE	DESCRIPTION
		12/21/18	PRE-APP MEETING
		07/ /19	PERMIT SUBMITTAL
		06/25/19	RESPONSE TO PLANNIN PCC
	1	07/28/20	RESPONSE TO PLANNIN PCC
	2	02/17/21	RESPONSE TO PLANNIN PCC
	3	06/27/21	RESPONSE TO PLANNIN PCC

### SHEET TITLE

# (N) FOURTH FLOOR PLAN &ROOF FLOOR PLAN

JOB NO: 18-1	44	•	
SCALE: 1/4"=1	I' <del>-</del> 0"	DATE:	08/06/21
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(E) UNITS & PROPOSED UNITS SQUARE FOOTAGE DIAGRAM						
	BEDROOM	BATHROOM	TOTAL SQ FT			
(E) UNIT #1	2	1	599			
(N) UNIT #1	2	2	1555			
(E) UNIT #2	3	1	989			
(N) UNIT #2	3	3	1605			
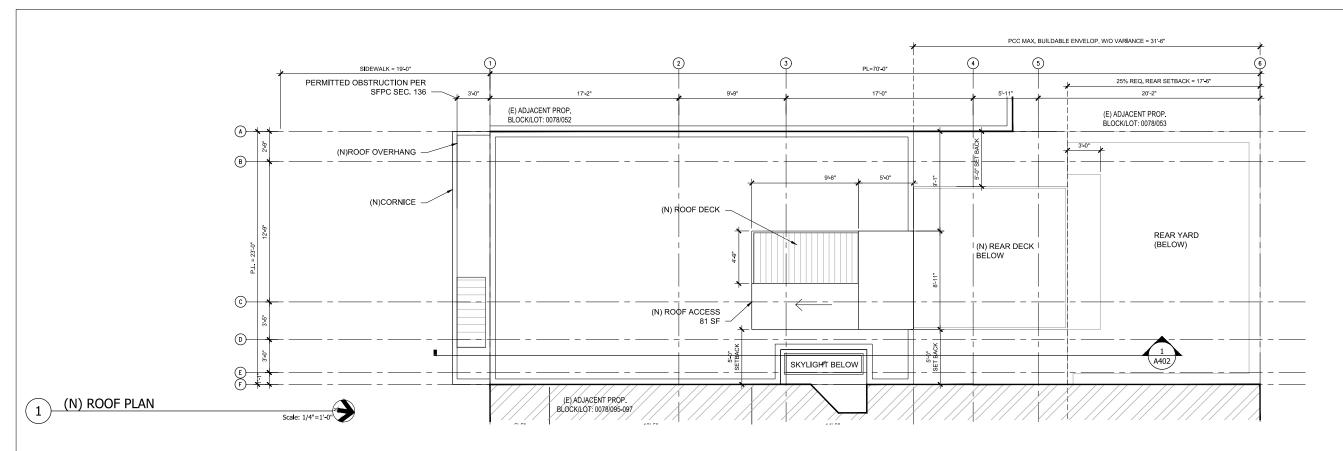
## WALL LEGEND :

\_\_\_\_ (E) DEMOLITION WALL

(E) WALL TO REMAIN

(N) WALL

/////// (N) CONC. RET. WALL, S.S.D.

■■■■ (N) FIRE RATED WALL

- $\frac{\text{MECHANICAL SHEETNOTES:}}{\text{1. GAS VENT TERMINATIONS SHALL MEET THE REQUIREMENTS OF CMC 802.6 \& SFMC}}$ 802.6.2.
- COMBUSTION AIR SHALL MEET THE REQUIREMENTS OF CMC CHAPTER 7.
- ENVIRONMENTAL AIR DUCTS SHALL TERMINATE 3 FEET FROM THE PROPERTY LINE AND 3 FEET FROM OPENINGS INTO THE BUILDING PER CMC 502.2.1 AND PROVIDE WITH BACK-DRAFT DAMPERS PER CMC 504.1.1.
- DOMESTIC RANGE HOOD VENTS SHALL MEET THE REQUIREMENTS OF CMC 504.3 AND 7. COMPLY WITH CMC TABLE 403.7.
   8.
- 5. ALL INTERIOR SPACES INTENDED FOR HUMAN OCCUPANCY SHALL BE PROVIDED WITH SPACE HEATING PER CBC 1204.1. HEATING UNITS ARE GAS, DIRECT-VENT, &
- LISTED FOR BEDROOM-USE. HEAT CLOTHES DRYER EXHAUST SHALL BE A MINIMUM 4 INCHES, TERMINATE TO THE OUTSIDE OF THE BUILDING, SHALL BE EQUIPPED WITH A BACK-DRAFT DAMPER, AND MEET THE REQUIREMENTS OF CMC 504.4.2. PROVIDE 100 SQ. INCH MINIMUM MAKE-UP AIR OPENING FOR DOMESTIC DRYERS.
- - LIGHTING PER CEC 150.0(K)
    PROVIDE A MINIMUM 200 SQUARE INCH VENTILATION OUTLET IN THE GARAGE WALLS OR EXTERIOR DOORS PER SFBC 406.3.3.

    9. PROVIDE FLOOR DRAIN PER CPC. 418.3 •F.D.

- FIRE SHEETNOTES:

  1. PROVIDE NON-SPARK PRODUCTING SHUT OFF TOOL. PROVIDE APPROVED SHUTOFF VALVE BEFORE AND AFTER GAS METER.
- PROVIDE (N) WALL-MOUNT FIRE EXTINGUISHER ADJ. TO EXIT STAIRS.
- PROVIDE "EXIT" SIGNAGE ON (N) EXIT CORRIDOR DOORS.
  PROVIDE HARDWIRED UL217 COMPLIANT SMOKE ALARMS PER SFBC CH.9 &
- 34. (NFPA 72, 907.2.10) 5. PROVIDE CARBON MONOXIDE ALARMS PER SFBC. CH.4 CO



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# **ADDITION** REMODEL FOR

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BLOCK/LOT: 0078/022



REVISIONS					
NO.	DATE	DESCRIPTION			
	12/21/18	PRE-APP MEETING			
	07/ /19	PERMIT SUBMITTAL			
	06/25/19	RESPONSE TO PLANNING PCC			
1	07/28/20	RESPONSE TO PLANNING PCC			
2	02/17/21	RESPONSE TO PLANNING PCC			
3	06/27/21	RESPONSE TO PLANNING PCC			

SHEET TITLE

# (N) ROOF PLAN

JOB NO:	18-144				
SCALE:	1/4"=1'-0	)"	DATE:	08/06/21	
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# **ADDITION** REMODEL

FOR

472 GREENWICH ST SAN FRANCISCO CA 94133

BLOCK/LOT: 0078/022



		RE\	/ISIONS
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# SHEET TITLE

# (E) FRONT ÈLEVATION

JOB NO:	18-14	4		
SCALE:	1/4"=1'-	-0"	DATE:	08/06/21
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# ADDITION REMODEL FOR

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BLOCK/LOT: 0078/022




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	07/ /19	PERMIT SUBMITTAL				
	06/25/19	RESPONSE TO PLANNING PCC				
1	07/28/20	RESPONSE TO PLANNING PCC				
2	02/17/21	RESPONSE TO PLANNING PCC				
3	06/27/21	RESPONSE TO PLANNING PCC				

# SHEET TITLE

# (N) FRONT ELEVATION

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# **ADDITION REMODEL**

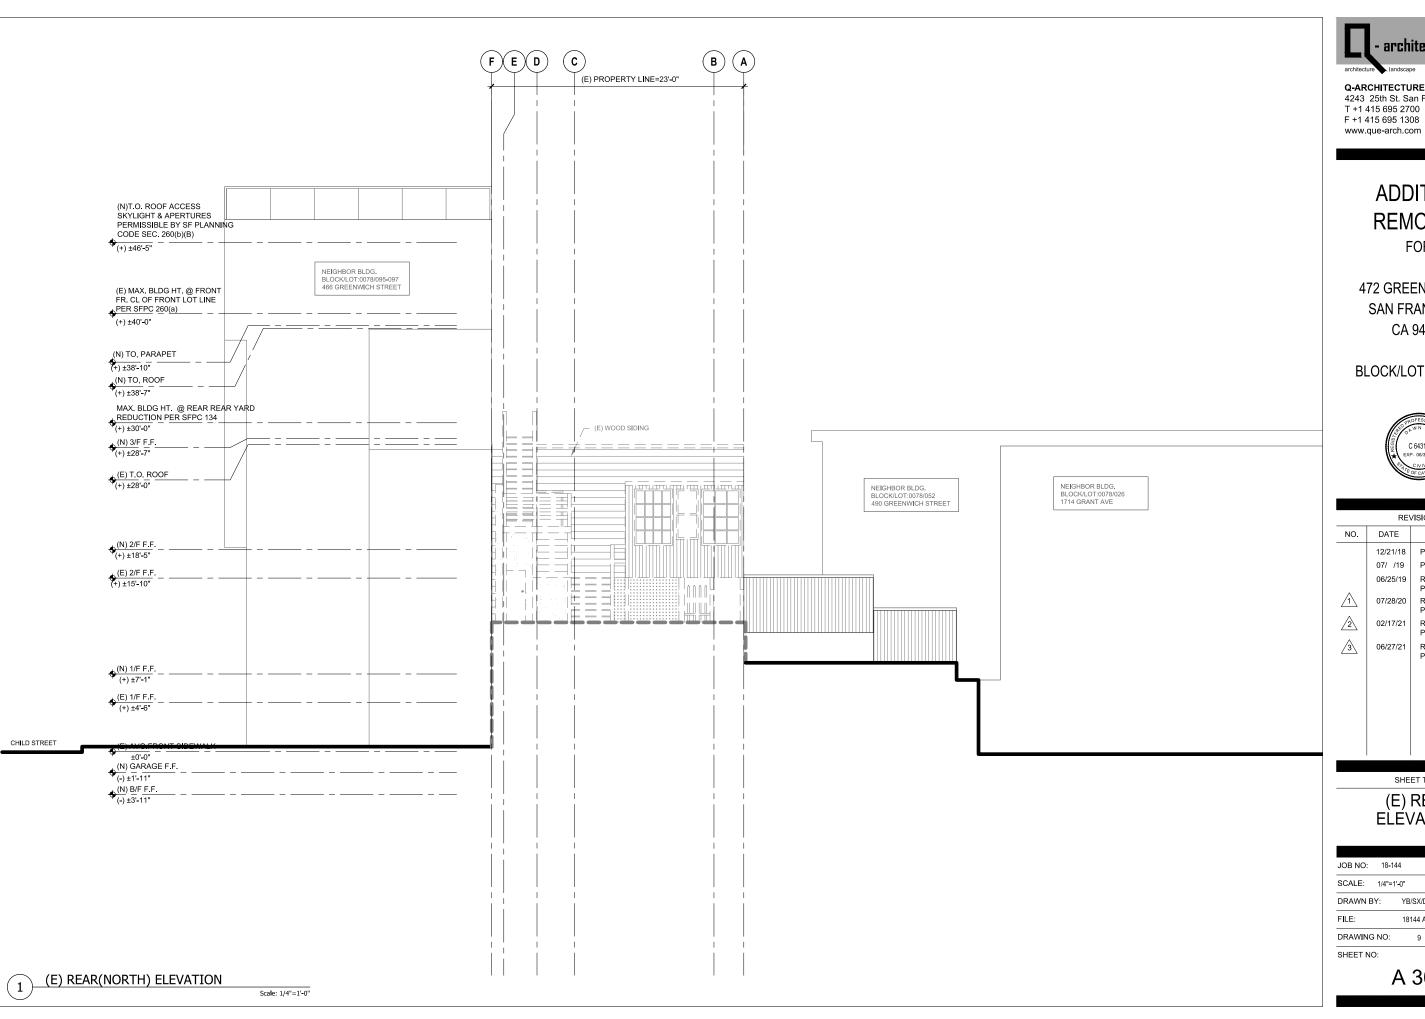FOR

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BLOCK/LOT: 0078/022




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2	02/17/21	RESPONSE TO PLANNIN PCC		
3	06/27/21	RESPONSE TO PLANNIN PCC		

### SHEET TITLE

# (E) REAR ELÉVATION

JOB NO: 18-14	14		
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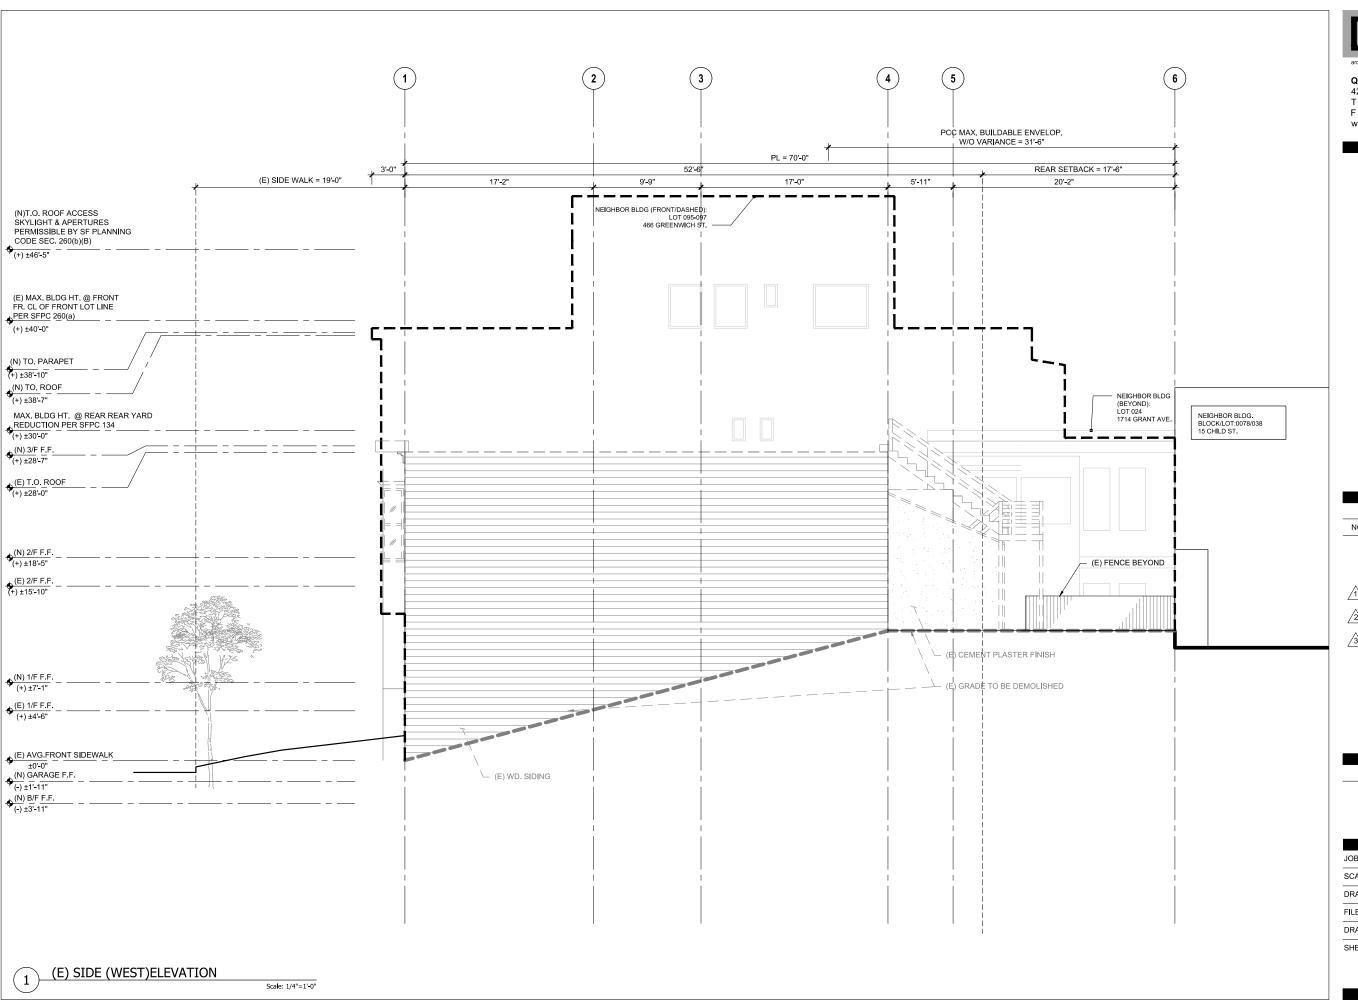

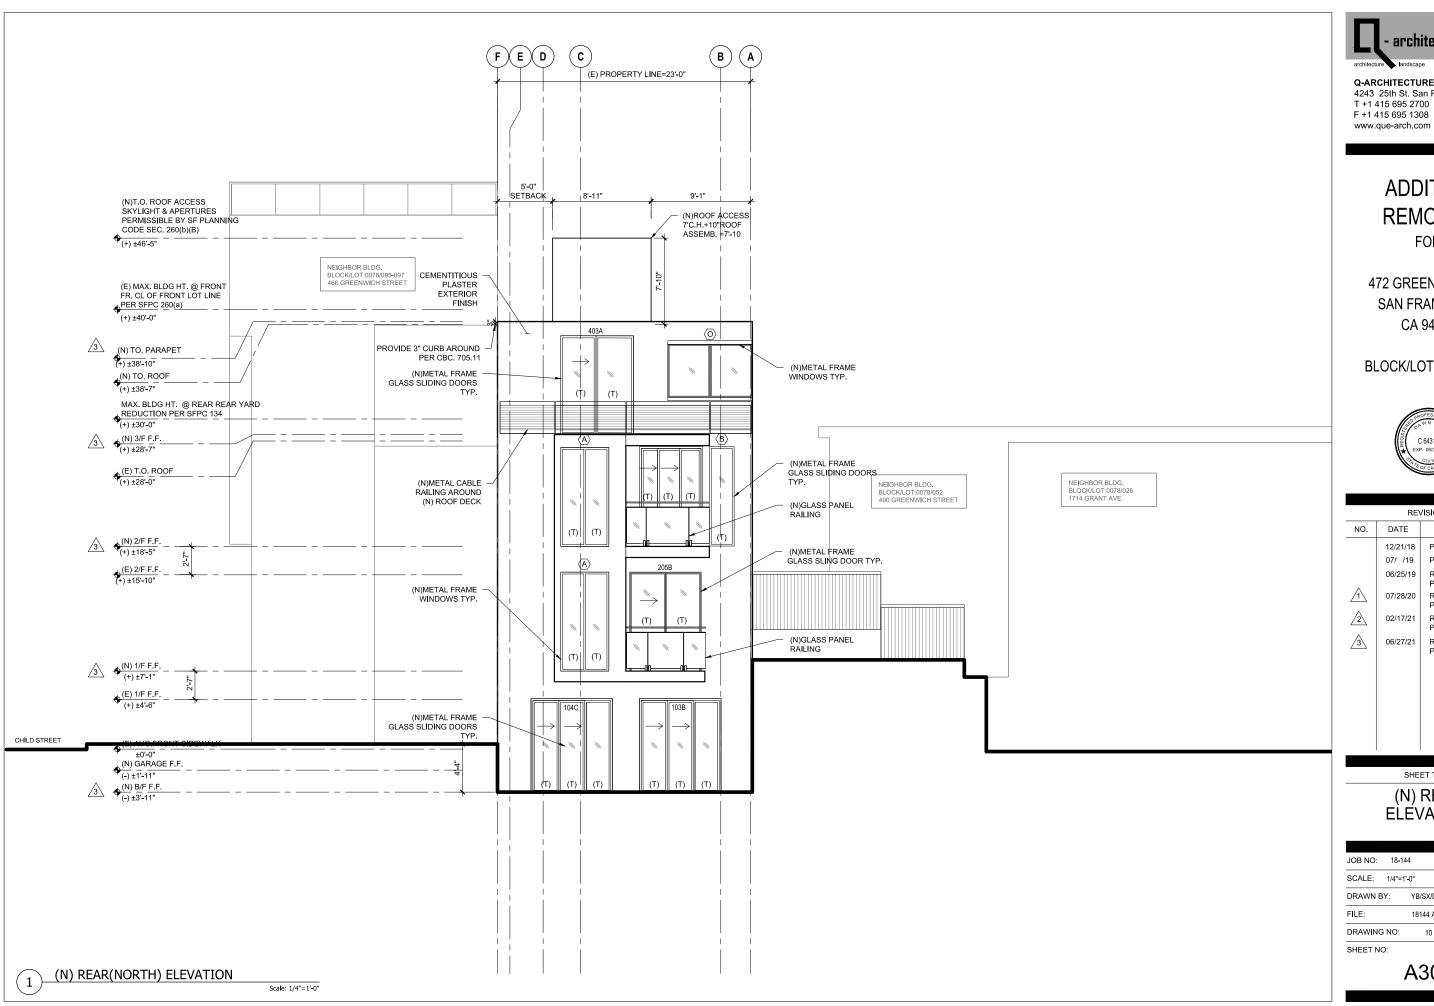
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	07/ /19	PERMIT SUBMITTAL
	06/25/19	RESPONSE TO PLANNING PCC
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3	06/27/21	RESPONSE TO PLANNING PCC

### SHEET TITLE

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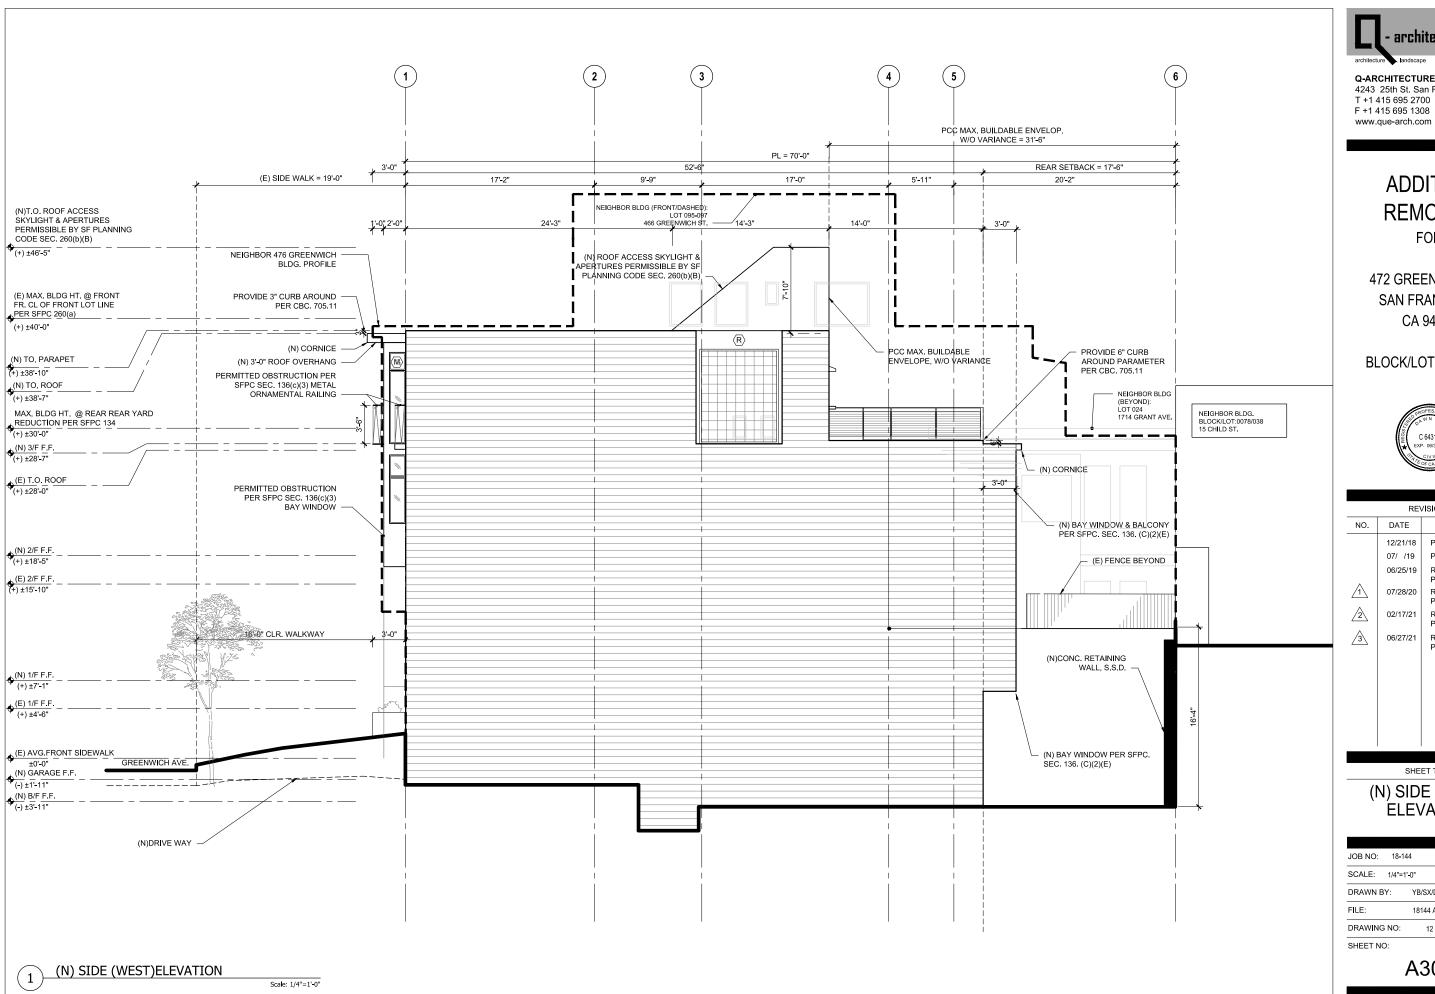


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	06/25/19	RESPONSE TO PLANNING PCC
1	07/28/20	RESPONSE TO PLANNING PCC
2	02/17/21	RESPONSE TO PLANNING PCC
3	06/27/21	RESPONSE TO PLANNING PCC

SHEET TITLE

# (E) SIDE (WEST) ÉLEVATION

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BLOCK/LOT: 0078/022




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	07/ /19	PERMIT SUBMITTAL
	06/25/19	RESPONSE TO PLANNING PCC
1	07/28/20	RESPONSE TO PLANNING PCC
2	02/17/21	RESPONSE TO PLANNING PCC
3	06/27/21	RESPONSE TO PLANNING PCC

SHEET TITLE

# (N) SIDE (WEST) ÉLEVATION

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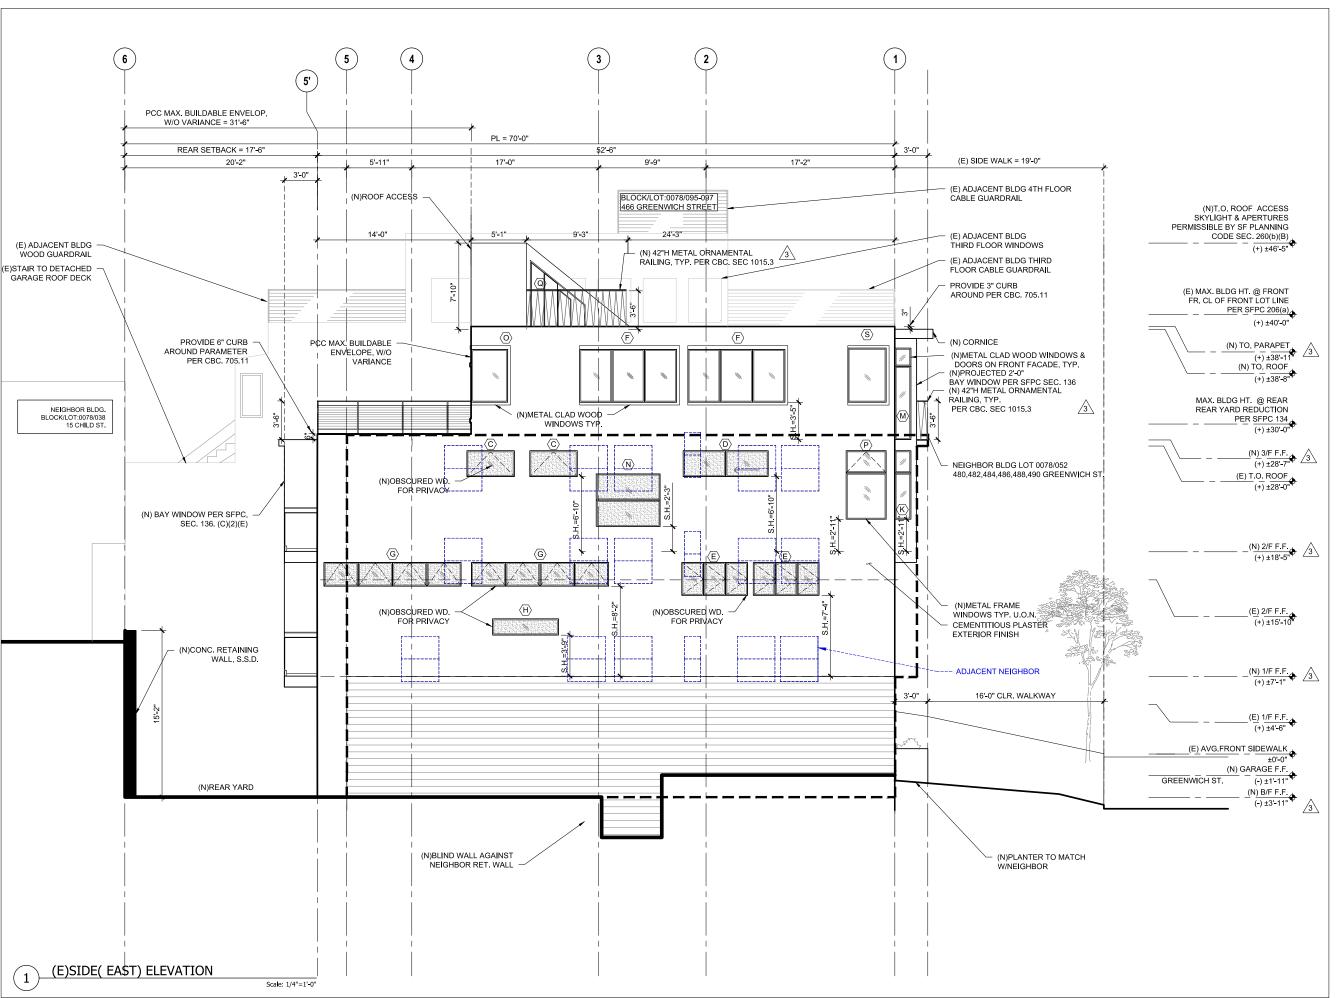

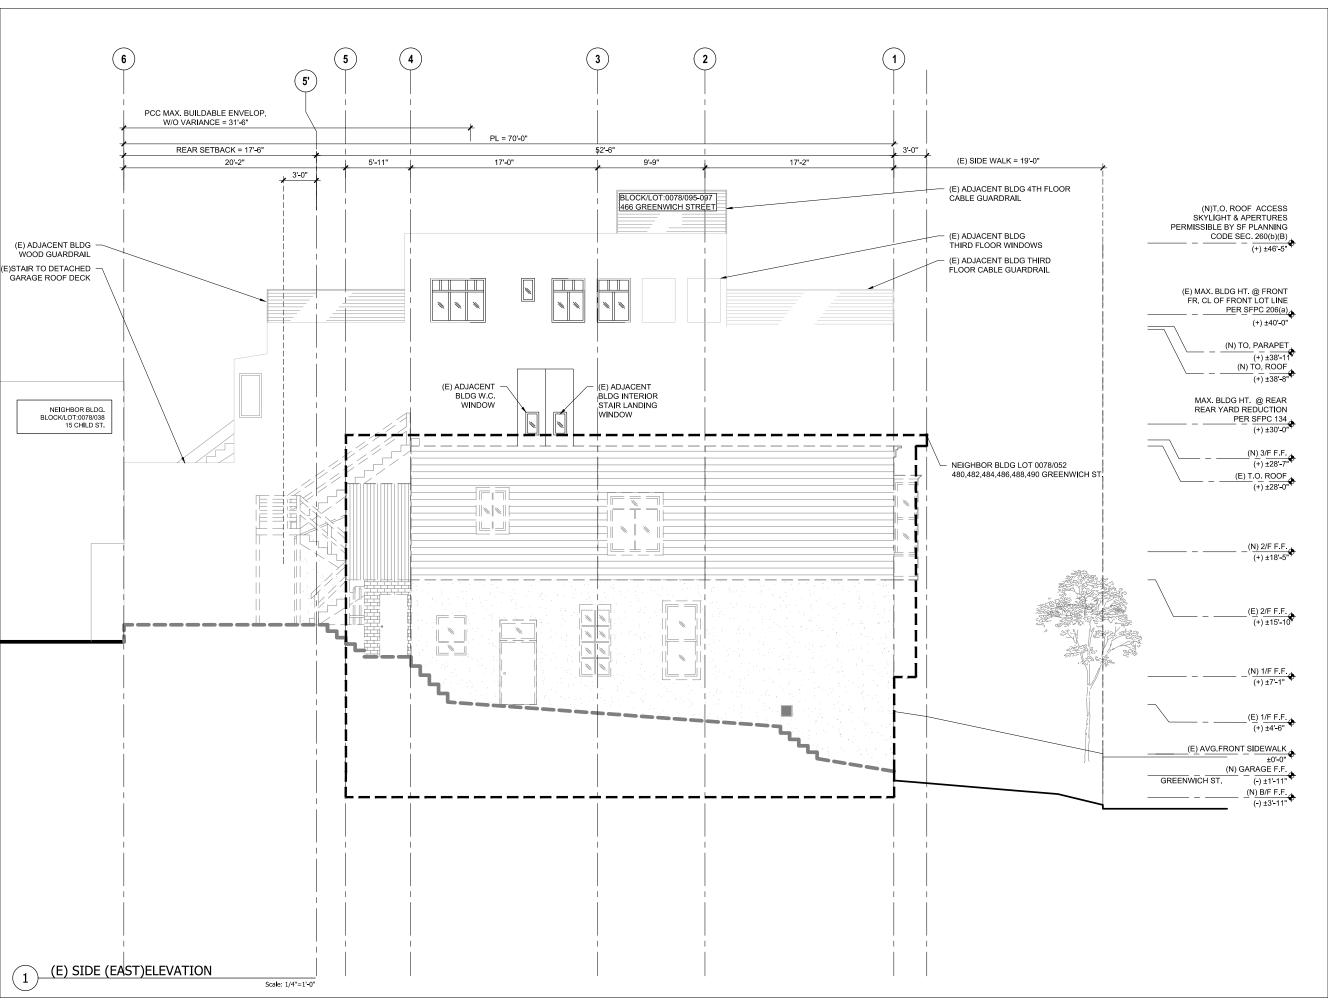
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		06/25/19	RESPONSE TO PLANNING PCC
	1	07/28/20	RESPONSE TO PLANNING PCC
	2	02/17/21	RESPONSE TO PLANNING PCC
	<u>3</u>	06/27/21	RESPONSE TO PLANNING PCC

# SHEET TITLE (E) SIDE (EAST)

# ÉLEVATION

JOB NO: 18-144		
SCALE: 1/4"=1'-0"	DATE:	08/06/21
DRAWN BY:	YB/SX/DM	
FILE: 18	3147 A300.dwg	
DRAWING NO:	13 OF	
SHEET NO:		





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# ADDITION REMODEL

FOR

472 GREENWICH ST SAN FRANCISCO CA 94133

BLOCK/LOT: 0078/022



RE	/ISIONS
DATE	DESCRIPTION
12/21/18	PRE-APP MEETING
07/ /19	PERMIT SUBMITTAL
06/25/19	RESPONSE TO PLANNING PCC
07/28/20	RESPONSE TO PLANNING PCC
02/17/21	RESPONSE TO PLANNING PCC
06/27/21	RESPONSE TO PLANNING PCC
	DATE  12/21/18 07/ /19 06/25/19 07/28/20 02/17/21

# (N) SIDE (EAST) ELEVATION

SHEET TITLE

JOB NO:	18-144		
SCALE:	1/4"=1'-0"	DATE:	08/06/21
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# **ADDITION** REMODEL

FOR

472 GREENWICH ST SAN FRANCISCO CA 94133

BLOCK/LOT: 0078/022




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	07/ /19	PERMIT SUBMITTAL
	06/25/19	RESPONSE TO PLANNING PCC
1	07/28/20	RESPONSE TO PLANNING PCC
2	02/17/21	RESPONSE TO PLANNING PCC
3	06/27/21	RESPONSE TO PLANNING PCC

# SHEET TITLE

# (N) FRONT ELEVATION ÙŔBAN BIRD REFUGE **GLAZING CALCULATION**

JOB NO: 1	8-144			
SCALE: 1/4	1"=1'-0"	DATE	08/06/21	
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# ADDITION REMODEL

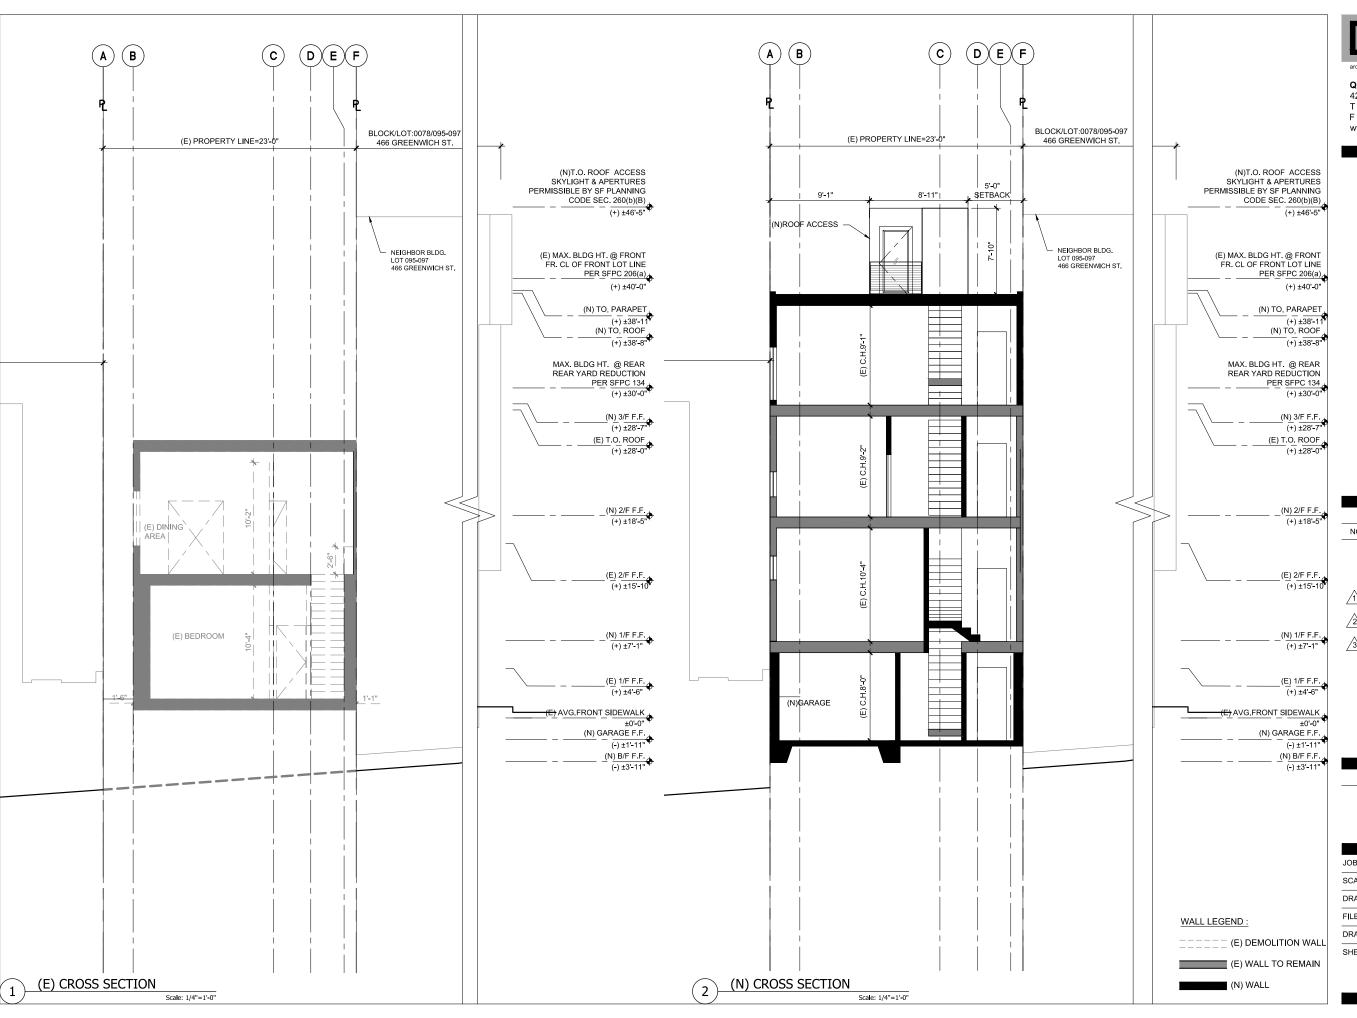FOR

472 GREENWICH ST SAN FRANCISCO CA 94133


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2	02/17/21	RESPONSE TO PLANNIN PCC
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# (E) & (N) CROSS SECTION

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## **ADDITION REMODEL** FOR

472 GREENWICH ST SAN FRANCISCO CA 94133

BLOCK/LOT: 0078/022

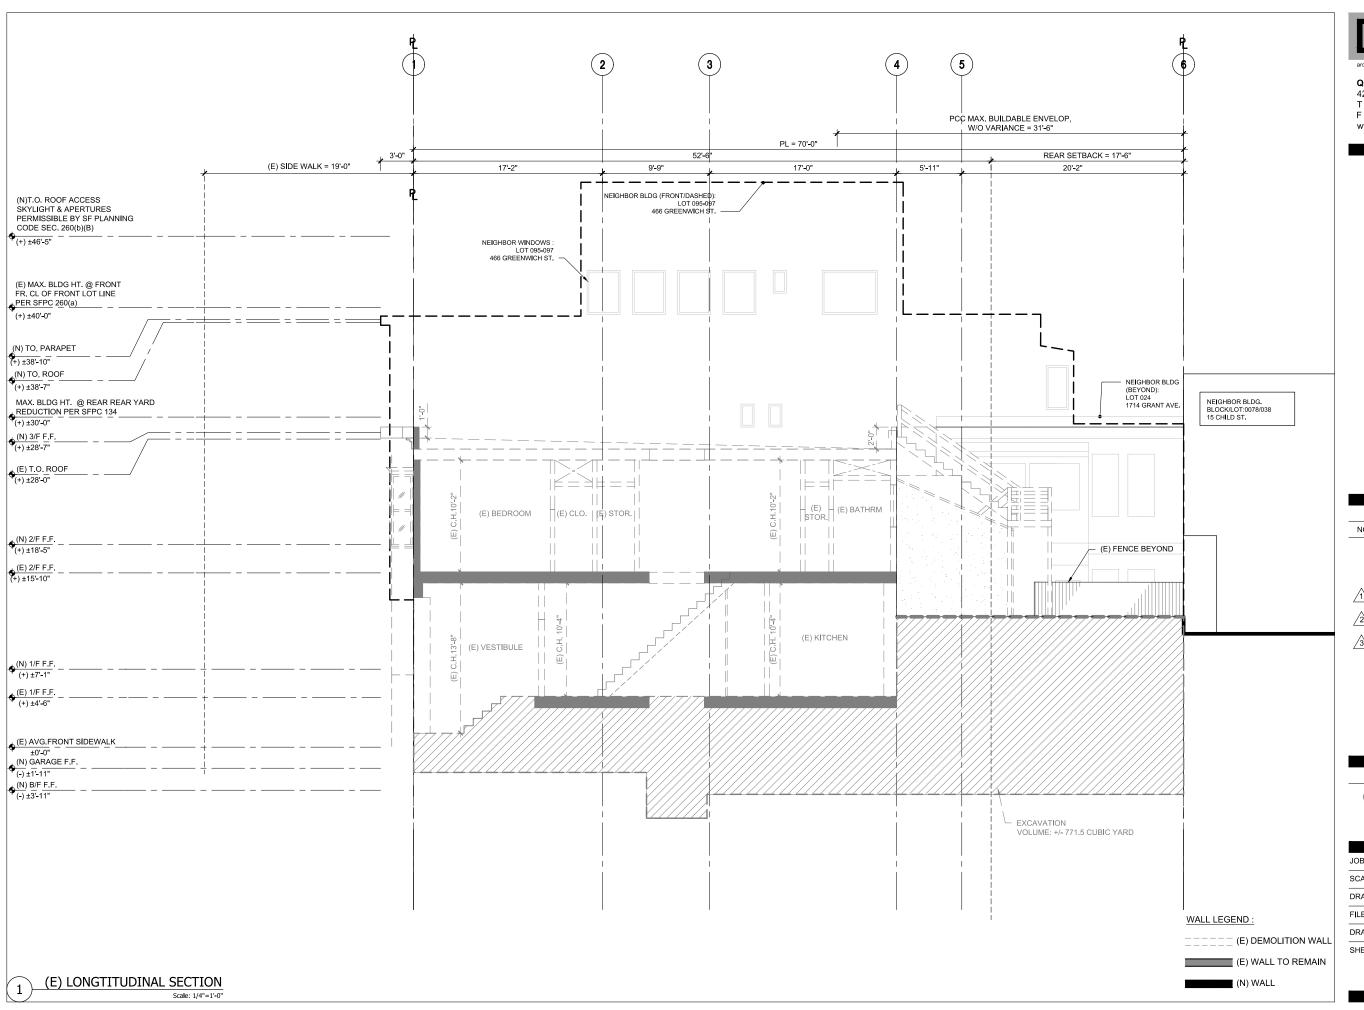


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2	02/17/21	RESPONSE TO PLANNING PCC				
<u>/3</u>	06/27/21	RESPONSE TO PLANNING PCC				

#### SHEET TITLE

### (E) LONGITUDINAL **SECTION**

	JOB NO:	18-144					
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## **ADDITION REMODEL** FOR

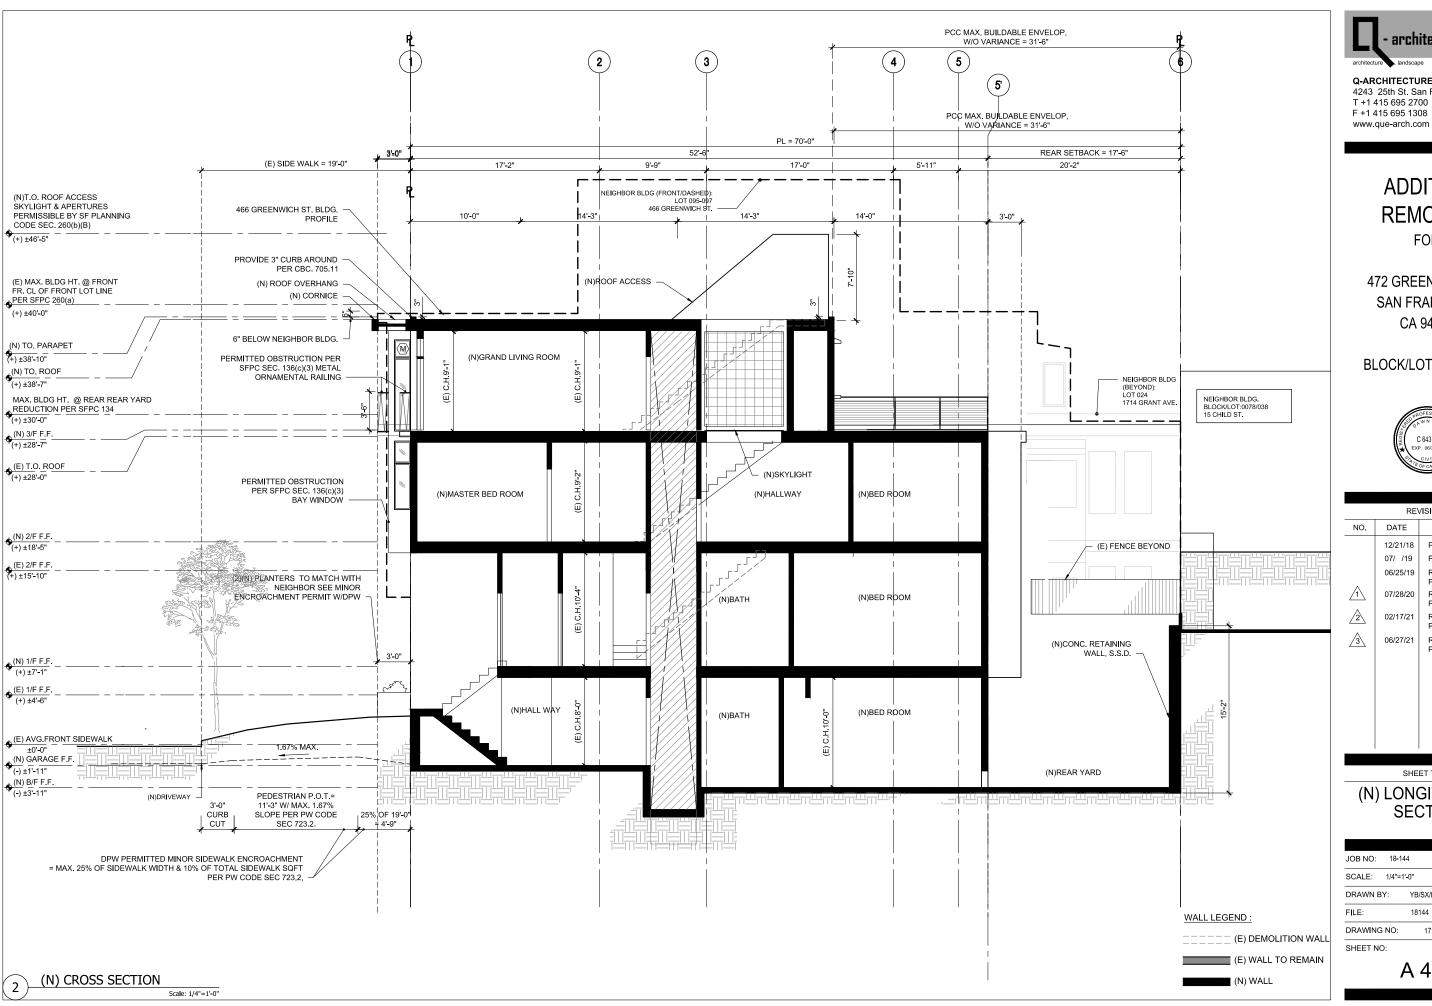472 GREENWICH ST SAN FRANCISCO CA 94133

BLOCK/LOT: 0078/022



	REVISIONS										
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		2	02/17/21	RESPONSE TO PLANNING PCC							
		3	06/27/21	RESPONSE TO PLANNING PCC							

#### SHEET TITLE

### (N) LONGITUDINAL **SECTION**

JOB NO:	18-144		_
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WINDO	w s	CHE	DULE												ı		2 + 1 4 1. WEATHER SHIELD
MARK QTY.	WIDTH	HEIGHT	SILL	HEAD HEIGHT	TYPE	GLASS	CONST.	RAME FINISH	RATING	R VALUE	SHGC		DETAIL #		HDWR.NOTE	REMARKS	2. RAINSCREEN ASSEMBLY, REF. 3/A601 3. TRIM - EXTERIOR TO MATCH (E); INTERIOR
A 2	4'-4"	9'-0"	0'-0"	9'-0"	FIXED	TEMP, INSUL. CLEAR, LOW E	MTL.	BY MANUF.	NR		0.52-0.55	1	1	1	BY MANUF.	MARVIN CONTEMPORARY	SEE SCH. 4. 5/8° GWB 5. WINDOW, SEE SCHEDULE; INSTALL PER
B 1 C 2	2'-3"	9'-0"	0'-0"	9'-0"	FIXED	TEMP, INSUL. CLEAR, LOW E  INSUL. FROSTED, LOW E	MTL.	BY MANUE.	NR RATED	0.32-0.36	0.52-0.55	1	1	1	BY MANUE.	MARVIN CONTEMPORARY  MARVIN CONTEMPORARY	MANUF, INSTRUCTION DAIN 6. SILL FLASHING, SLOPED TO DRAIN 7. POLYURETHANE SEALANT, TYP.
D 1	4'-4" 7'-9"	2'-4"	6'-10" 6'-10"	9'-2"	AWNING SLIDING	INSUL. FROSTED, LOW E	MTL.	BY MANUF.	45MIN RATED	0.32-0.36	0.52-0.55 0.52-0.55	1	1	1	BY MANUF.	MARVIN CONTEMPORARY	
E 2	6'-0"	3'-0"	7'-4"	10'-4"	CASEMENT	INSUL. FROSTED, LOW E	MTL.	BY MANUF.	45MIN RATED	0.32-0.36		1	1	1	BY MANUF.	MARVIN CONTEMPORARY	3"
F 2	8'-10"	4'-10"	3'-5"	8'-3"	FIXED	INSUL. CLEAR, LOW E	MTL.	BY MANUF.	45MIN RATED	0.32-0.36		1	1	1	BY MANUF.	MARVIN CONTEMPORARY	EXTERIOR INTERIOR 0 0 0 0 0 0 0 0 0 0 0 0 0 0 0 0 0 0 0
G 2	12'-6"	2'-2"	8'-2"	10'-4"	AWNING	INSUL. FROSTED, LOW E	MTL.	BY MANUF.	45MIN RATED	0.32-0.36	0.52-0.55	1	1	1	BY MANUF.	MARVIN CONTEMPORARY	
H 1	6'-0"	1'-6"	3'-9"	5'-3"	FIXED	INSUL FROSTED, LOW E	MTL.	BY MANUF.	45MIN RATED 45MIN	0.32-0.36		1	1	1	BY MANUF.	MARVIN CONTEMPORARY	5
I 2	6'-2"	5'-0"	2'-9"	8'-11"	CASEMENT/AWNING	INSUL. CLEAR, LOW E	MTL. CLAD WD.	BY MANUF.	NR	0.32-0.36	0.52-0.55	1	1	1	BY MANUF.	MARVIN CONTEMPORARY	
J 1	4'-4"	6'-3"	2'-11"	9'-2"	CASEMENT	INSUL. CLEAR, LOW E	MTL. CLAD WD.	BY MANUF.	RATED 45MIN	0.32-0.36	0.52-0.55	1	1	1	BY MANUF.	MARVIN CONTEMPORARY	(T) (EXTERIOR)
K 2	1'-7"	6'-3"	2'-11"	9'-2"	CASEMENT	INSUL. CLEAR, LOW E	MTL. CLAD WD.	BY MANUF.	RATED 45MIN	0.32-0.36	0.52-0.55	1	1	1	BY MANUF.	MARVIN CONTEMPORARY	JAMB JAMB
M 2	1'-7"	8'-4"	0'-0"	8'-4"	FIXED	TEMP, INSUL. FROSTED, LOW E	MTL. CLAD WD.	BY MANUF.	NR	0.32-0.36	0.52-0.55	1	1	1	BY MANUF.	MARVIN CONTEMPORARY	6 SILL-HEAD  TYPICAL WINDOW DETAIL
N 1	5'-10"	4'-10"	2'-3"	7'-1"	FIXED	INSUL. FROSTED, LOW E	MTL.	BY MANUF.	RATED 45MIN	0.32-0.36	0.52-0.55	1	1	1	BY MANUF.	MARVIN CONTEMPORARY	Scale: 3"=1"-0"
0 1	7'-8"	4'-10"	3'-5"	8'-3"	FIXED	INSUL. CLEAR, LOW E	MTL.	BY MANUF.	RATED 45MIN	0.32-0.36	0.52-0.55	1	1	1	BY MANUF.	MARVIN CONTEMPORARY	
1	3'-1"	4'-10"	3'-5"	8'-3"	FIXED	INSUL. CLEAR, LOW E	MTL.	BY MANUF.	RATED 45MIN	0.32-0.36	0.52-0.55	1	1	1	BY MANUF.	MARVIN CONTEMPORARY	
P 3	3'-8"	6'-3"	2'-11"	9'-2"	FIXED/AWNING	INSUL. CLEAR, LOW E	MTL.	BY MANUF.	RATED 45MIN	0.32-0.36	0.52-0.55	1	1	1	BY MANUF.	MARVIN CONTEMPORARY	
S 1	3'-8"	5'-5"	2'-11"	8'-4"	FIXED/AWNING	INSUL. CLEAR, LOW E	MTL.	BY MANUF.	RATED 45MIN	0.32-0.36	0.52-0.55	1	1	1	BY MANUF.	MARVIN CONTEMPORARY	_
Q 1 R 1	5'-0" 7'-2"	6'-3" 8'-7"	0'-0"	6'-3" 8'-7"	FIXED GLASS BLOCKS	TEMP, INSUL. CLEAR, LOW E	MTL. BY MANUF.	BY MANUF.	NR RATED 45MIN	0.32-0.36	0.52-0.55 0.52-0.55	1	1	1	BY MANUF.	MARVIN CONTEMPORARY  MARVIN CONTEMPORARY	-
4'-4"	MF METAL FRAME VINYL DOOR RATING: NOT RATE SG SINGLE NR RATED NOT RATE RATED NOT																
(T) (T)			T)   (ED		a AWNING	SLIDING	CASEM	ENT		FIXED		m			AWNING	FIXED	AWNING AWNING CASEMENT
A FIXED WINDOW	'S	<u>® WI</u>	KED NDOWS	. (	C AWNING WINDOWS	D SLIDING E WINDOWS  -1" # 3'-10" 3'-10" #	CASEM WINDO	ws +	3'-8"	FIXED WINDOW	'S3'⊣	8"ر			G AWNING WINDOWS	H FIXED WINDO	-
(1) -4.			5'-1	2'3" 4'-9"		3.5"		/	2:-11"	9-2"	1	2'-11"   5'-5"	8'4"		5'-0"	2-3.	
M FIXED N FIXED WINDOWS P AWNING/FIXED S AWNING/FIXED WINDOWS R WINDOWS R WINDOWS R WINDOWS S WINDOWS R WINDOWS R WINDOWS S WINDOWS S WINDOWS R WINDOWS R WINDOWS R WINDOWS S WINDOWS R WINDOWS R WINDOWS R WINDOWS S WINDOWS S WINDOWS R WINDOWS R WINDOWS S WINDOWS S WINDOWS R WINDOWS R WINDOWS R WINDOWS R WINDOWS R WINDOWS S WINDOWS S WINDOWS R WI																	

WINDOW SCHEDULE



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# **ADDITION** REMODEL

FOR

472 GREENWICH ST SAN FRANCISCO CA 94133

BLOCK/LOT: 0078/022




REVISIONS									
NO.	DATE	DESCRIPTION							
	12/21/18	PRE-APP MEETING							
	07/ /19	PERMIT SUBMITTAL							
	06/25/19	RESPONSE TO PLANNING PCC							
1	07/28/20	RESPONSE TO PLANNING PCC							
2	02/17/21	RESPONSE TO PLANNING PCC							
3	06/27/21	RESPONSE TO PLANNING PCC							

### SHEET TITLE WINDOW

### SCHEDULES & DETAILS

JOB NO:	18-144		
SCALE:	AS SHOWN	DATE:	08/06/21
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FILE:	1814	4-A800.dwg	
DRAWING	3 NO: 1	18 OF	
SHEET N	O:		

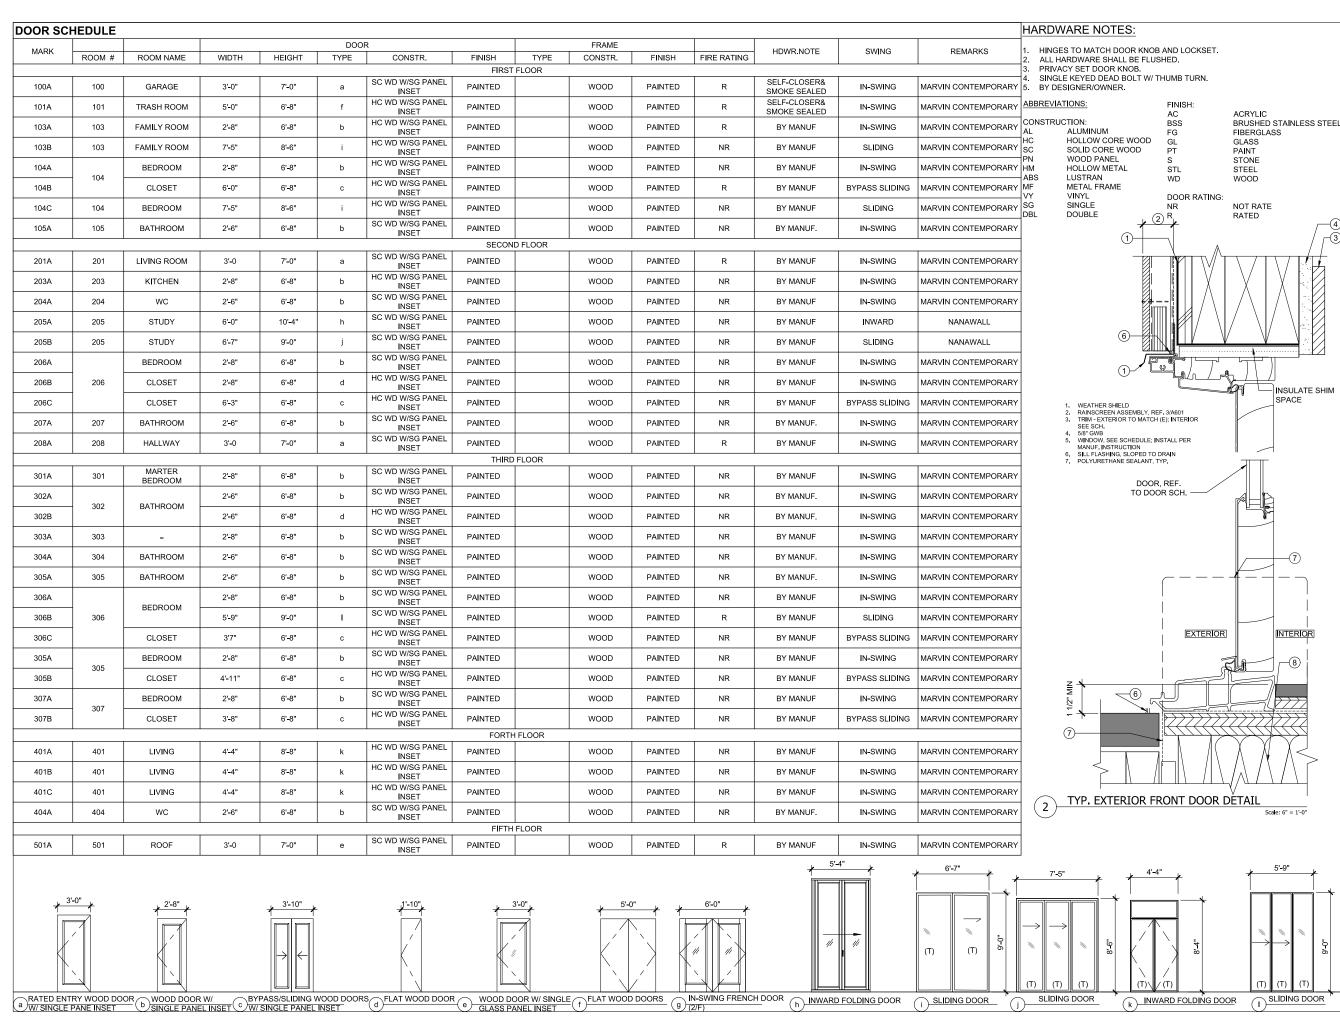



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### ADDITION REMODEL FOR

472 GREENWICH ST SAN FRANCISCO CA 94133

BLOCK/LOT: 0078/022



	REVISIONS									
	NO.	DATE	DESCRIPTION							
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	2	02/17/21	RESPONSE TO PLANNING PCC							
	3	06/27/21	RESPONSE TO PLANNING PCC							

#### SHEET TITLE

#### DOOR SCHEDULES & DETAILS

JOB NO: 18	3-144		
SCALE: AS	SHOWN	DATE:	08/06/21
DRAWN BY:	YB/SX	/DM	
FILE:	17139-	-A800.dwg	
DRAWING NO	): 19	OF	
SHEET NO:			



49 South Van Ness Avenue, Suite 1400 San Francisco, CA 94103 628.652.7600 www.sfplanning.org

# **CEQA Exemption Determination**

EXHIBIT C

#### PROPERTY INFORMATION/PROJECT DESCRIPTION

Proje	ct Address	Block/Lot(s)					
472 G	REENWICH ST	0078022					
Case	No.	Permit No.					
2019-	015440ENV						
Ad	dition/ Demolition (requires HRE for	New					
Alt	eration Category B Building)	Construction					
The preside stories appro While demo	Project description for Planning Department approval.  The project proposes a one-story vertical and horizontal addition to an existing two-story over basement, two-unit residential building that is approximately 2,300 square feet in size. The finished two-unit building would be three stories over basement and 4,179 square feet in size. The project would add one car garage and would require approximately 340 cubic yards of excavation. The project includes façade alterations and interior renovations.  While the project is not defined as demolition pursuant to Section 317 of the Planning Code, it would represent demolition for the purposes of CEQA as the existing building would be fully illegible following the proposed remodel.						
	1: EXEMPTION TYPE						
The p	roject has been determined to be exempt under the California Er	nvironmental Quality Act (CEQA).					
	Class 1 - Existing Facilities. Interior and exterior alterations; addit	tions under 10,000 sq. ft.					
	Class 3 - New Construction. Up to three new single-family reside commercial/office structures; utility extensions; change of use und with a CU.	-					
	Class 32 - In-Fill Development. New Construction of seven or mosq. ft. and meets the conditions described below:  (a) The project is consistent with the applicable general plan design policies as well as with applicable zoning designation and regulating. (b) The proposed development occurs within city limits on a project substantially surrounded by urban uses.  (c) The project site has no value as habitat for endangered rare or (d) Approval of the project would not result in any significant effect water quality.  (e) The site can be adequately served by all required utilities and project and the project would not result in any significant effects water quality.	gnation and all applicable general plan ons. ct site of no more than 5 acres r threatened species. ts relating to traffic, noise, air quality, or					
	Other						
	Common Sense Exemption (CEQA Guidelines section 15061(b there is no possibility of a significant effect on the environment.	)(3)). It can be seen with certainty that					

# STEP 2: ENVIRONMENTAL SCREENING ASSESSMENT TO BE COMPLETED BY PROJECT PLANNER

	Air Quality: Would the project add new sensitive receptors (specifically, schools, day care facilities, hospitals, residential dwellings, and senior-care facilities within an Air Pollution Exposure Zone? Does the project have the potential to emit substantial pollutant concentrations (e.g. use of diesel construction equipment, backup diesel generators, heavy industry, diesel trucks, etc.)? (refer to the Environmental
	Hazardous Materials: Maher or Cortese  Is the project site located within the Maher area or on a site containing potential subsurface soil or groundwater contamination and would it involve ground disturbance of at least 50 cubic yards or a change of use from an industrial use to a residential or institutional use? Is the project site located on a Cortese site or would the project involve work on a site with an existing or former gas station, parking lot, auto repair, dry cleaners, or heavy manufacturing use, or a site with current or former underground storage tanks? if Maher box is checked, note below whether the applicant has enrolled in or received a waiver from the San Francisco Department of Public Health (DPH) Maher program, or if Environmental Planning staff has determined that hazardous material effects would be less than significant.  Note that a categorical exemption shall not be issued for a project located on the Cortese List
	<b>Transportation:</b> Does the project involve a child care facility or school with 30 or more students, or a location 1,500 sq. ft. or greater? Does the project have the potential to adversely affect transit, pedestrian and/or bicycle safety (hazards) or the adequacy of nearby transit, pedestrian and/or bicycle facilities? Would the project involve the intensification of or a substantial increase in vehicle trips at the project site or elsewhere in the region due to autonomous vehicle or for-hire vehicle fleet maintenance, operations or
	Archeological Resources: Would the project result in soil disturbance/modification greater than two (2) feet below grade in an archeological sensitive area or eight (8) feet in a non-archeological sensitive area? If yes, archeology review is required.
	Subdivision/Lot Line Adjustment: Does the project site involve a subdivision or lot line adjustment on a lot with a slope average of 20% or more? (refer to the Environmental Information tab on https://sfplanninggis.org/PIM/) If box is checked, Environmental Planning must issue the exemption.
	Average Slope of Parcel = or > 25%, or site is in Edgehill Slope Protection Area or Northwest Mt.  Sutro Slope Protection Area: Does the project involve any of the following: (1) New building construction, except one-story storage or utility occupancy, (2) horizontal additions, if the footprint area increases more than 50%, or (3) horizontal and vertical additions increase more than 500 square feet of new projected roof area? (refer to the Environmental Information tab on https://sfplanninggis.org/PIM/) If box is checked, a geotechnical report is likely required and Environmental Planning must issue the exemption.
	Seismic Hazard: Landslide or Liquefaction Hazard Zone:  Does the project involve any of the following: (1) New building construction, except one-story storage or utility occupancy, (2) horizontal additions, if the footprint area increases more than 50%, (3) horizontal and vertical additions increase more than 500 square feet of new projected roof area, or (4) grading performed at a site in the landslide hazard zone? (refer to the Environmental Information tab on https://sfplanninggis.org/PIM/)  If box is checked, a geotechnical report is required and Environmental Planning must issue the exemption.
Com	iments and Planner Signature (optional): Don Lewis
Planı	ning department staff archaeologist cleared the project with no effects on 11/18/2019.

### STEP 3: PROPERTY STATUS - HISTORIC RESOURCE TO BE COMPLETED BY PROJECT PLANNER PROPERTY IS ONE OF THE FOLLOWING: (refer to Property Information Map) Category A: Known Historical Resource. GO TO STEP 5. Category B: Potential Historical Resource (over 45 years of age). GO TO STEP 4. Category C: Not a Historical Resource or Not Age Eligible (under 45 years of age). GO TO STEP 6. STEP 4: PROPOSED WORK CHECKLIST TO BE COMPLETED BY PROJECT PLANNER Check all that apply to the project. 1. Change of use and new construction. Tenant improvements not included. 2. Regular maintenance or repair to correct or repair deterioration, decay, or damage to building. 3. Window replacement that meets the Department's Window Replacement Standards. Does not include storefront window alterations. 4. Garage work. A new opening that meets the Guidelines for Adding Garages and Curb Cuts, and/or replacement of a garage door in an existing opening that meets the Residential Design Guidelines. 5. Deck, terrace construction, or fences not visible from any immediately adjacent public right-of-way. 6. Mechanical equipment installation that is not visible from any immediately adjacent public right-of-way. 7. **Dormer installation** that meets the requirements for exemption from public notification under *Zoning* Administrator Bulletin No. 3: Dormer Windows. 8. Addition(s) that are not visible from any immediately adjacent public right-of-way for 150 feet in each direction; does not extend vertically beyond the floor level of the top story of the structure or is only a П single story in height; does not have a footprint that is more than 50% larger than that of the original building: and does not cause the removal of architectural significant roofing features. Note: Project Planner must check box below before proceeding. Project is not listed. GO TO STEP 5. Project does not conform to the scopes of work. GO TO STEP 5. Project involves four or more work descriptions. GO TO STEP 5. Project involves less than four work descriptions. GO TO STEP 6. STEP 5: ADVANCED HISTORICAL REVIEW TO BE COMPLETED BY PRESERVATION PLANNER Check all that apply to the project. 1. Reclassification of property status. (Attach HRER Part I) Reclassify to Category C Reclassify to Category A a. Per HRER 05/04/2020 (No further historic review) b. Other (specify): Reclassified as a contributor to a potential eligible historic district 2. Project involves a known historical resource (CEQA Category A) as determined by Step 3 and conforms entirely to proposed work checklist in Step 4. 3. Interior alterations to publicly accessible spaces that do not remove, alter, or obscure character defining features. 4. Window replacement of original/historic windows that are not "in-kind" but are consistent with existing historic character. 5. Façade/storefront alterations that do not remove, alter, or obscure character-defining features.

	6. <b>Raising the building</b> in a manner that does not remove, alter, or obscure character-defining features.					
	7. <b>Restoration</b> based upon documented evidence of a building's historic condition, such as historic photographs, plans, physical evidence, or similar buildings.					
	8. <b>Work consistent</b> with the Secretary of the Interior Standards for the Treatment of Historic Properties (Analysis required):					
	9. Work compatible with a historic district (Analysis required):					
	See analysis in attached HRER Part II					
	10. Work that would not materially impair a historic resource (Attach HRER Part II).					
	Note: If ANY box in STEP 5 above is checked, a Preservation Planner MUST sign below.					
	Project can proceed with exemption review. The project has been reviewed by the Preservation Planner and can proceed with exemption review. GO TO STEP 6.					
Comments (optional):						
Preserv	Preservation Planner Signature: Jonathan Vimr					
_	STEP 6: EXEMPTION DETERMINATION TO BE COMPLETED BY PROJECT PLANNER					

No further environmental review is required. The project is exempt under CEQA. There are no unusual circumstances that would result in a reasonable possibility of a significant effect.		
Project Approval Action:	Signature:	
Planning Commission Hearing	Jonathan Vimr	
	08/12/2021	
Supporting documents are available for review on the San Francisco Property Information Map, which can be accessed at https://sfplanninggis.org/PIM/. Individual files can be viewed by clicking on the Planning Applications link, clicking the "More Details" link under the project's environmental record number (ENV) and then clicking on the "Related Documents" link. Once signed or stamped and dated, this document constitutes an exemption pursuant to CEQA Guidelines and Chapter 31 Administrative Code.  In accordance with Chapter 31 of the San Francisco Administrative Code, an appeal of an exemption determination to the E of Supervisors can only be filed within 30 days of the project receiving the approval action.		

#### STEP 7: MODIFICATION OF A CEQA EXEMPT PROJECT

#### TO BE COMPLETED BY PROJECT PLANNER

In accordance with Chapter 31 of the San Francisco Administrative Code, when a California Environmental Quality Act (CEQA) exempt project changes after the Approval Action and requires a subsequent approval, the Environmental Review Officer (or his or her designee) must determine whether the proposed change constitutes a substantial modification of that project. This checklist shall be used to determine whether the proposed changes to the approved project would constitute a "substantial modification" and, therefore, be subject to additional

#### **MODIFIED PROJECT DESCRIPTION**

Modi	Modified Project Description:				
DE	TERMINATION IF PROJECT (	CONSTITUTES SUBSTANTIAL MODIFICATION			
Com	pared to the approved project, w	ould the modified project:			
	Result in expansion of the building envelope, as defined in the Planning Code;				
	Result in the change of use that would require public notice under Planning Code Sections 311 or 312;				
	Result in demolition as defined under Planning Code Section 317 or 19005(f)?				
	Is any information being presented that was not known and could not have been known				
	at the time of the original determination, that shows the originally approved project may no longer qualify for the exemption?				
If at I	east one of the above boxes is	checked, further environmental review is required			
DET	ERMINATION OF NO SUBSTAI	NTIAL MODIFICATION			
	The proposed modification would not result in any of the above changes.				
1	If this box is checked, the proposed modifications are exempt under CEQA, in accordance with prior project				
approval and no additional environmental review is required. This determination shall be posted on the Planning Department website and office and mailed to the applicant, City approving entities, and anyone requesting written notice.					
In accordance with Chapter 31, Sec 31.08j of the San Francisco Administrative Code, an appeal of this determination can					
Planner Name:		Date:			



# SAN FRANCISCO PLANNING DEPARTMENT

# **Historic Resource Evaluation Response**

1650 Mission St. Suite 400 San Francisco, CA 94103-2479

CA 94103-2479

Reception: **415.558.6378** 

Fax.

415.558.6409

Planning Information: **415.558.6377** 

Record No.: 2019-015440ENV

Project Address: 472 Greenwich Street

Zoning: RH-3 (Residential-House, Three Family) Zoning District

40-X Height and Bulk District

*Block/Lot:* 0078/022

Staff Contact: Jonathan Vimr – 415.575.9109

Jonathan.vimr@sfgov.org

#### PART I: HISTORIC RESOURCE EVALUATION

#### PROJECT SPONSOR SUBMITTAL:

To assist in the evaluation of the proposed project, the Project Sponsor has submitted a:

☐ Historic Resource Assessment Form (HRA)

Consultant-prepared Historic Resource Evaluation (HRE)

Prepared by: William Kostura, Historic Resource Assessment (May, 2019)

#### **BUILDINGS AND PROPERTY DESCRIPTION:**

- Neighborhood: North Beach
- Date of Construction: 1906
- Construction Type: Wood-Frame
- Architect: Righetti & Kuhl
- **Builder**: Joseph Maciano

- Stories: Two Over Basement
- Roof Form: Flat
- Cladding: Horizontal Wood; Stucco
- **Primary Façade**: Greenwich Street (South)
- Visible Facades: South and West elevations

#### **EXISTING PROPERTY PHOTO / CURRENT CONDITION:**



Sources: Google Maps, 2019

#### PRE-EXISTING HISTORIC RATING / SURVEY

Category A – Known Historic Resource, per:
☐ Category B – Age Eligible/Historic Status Unknown
Category C – Not Age Eligible / No Historic Resource Present, per:

Adjacent or Nearby Historic Resources:	$\square$ No	Xes: Pending North Beach Historic Context
Statement and historic survey (discussed	<u>l below)</u>	

#### CEQA HISTORICAL RESOURCE(S) EVALUATION:

Step A: Significance

Individual Significance		Historic District/Context Significance			
Property is individually eligible for inclusion in a		Property is eligible for inclusion in a California			
California Register under one or	r more of the	Register Historic District/Context under one or			
following Criteria:		more of the following Criteria:			
Criterion 1 - Event:	∃Yes ⊠No	Criterion 1 - Event:	⊠Yes □No		
Criterion 2 – Persons:	□Yes ⊠No	Criterion 2 - Persons:	⊠Yes □No		
<b>Criterion 4</b> - Architecture:	∃Yes ⊠No	Criterion 3 - Architecture:	⊠Yes □No		
Criterion 4 - Info. Potential:	∃Yes ⊠No	Criterion 4 - Info. Potential:	□Yes ⊠No		
Period of Significance:		Period of Significance: 1906-194	11 (under review)		
		🛮 Contributor 🗀 Non-Contr	ributor 🗆 N/A		

#### **Analysis:**

According to the Historic Resource Assessment, documentation contained in the pending North Beach Historic Context Statement ("HCS", currently under review by the Department) and information found in the Planning Department files, the subject property contains a two-story-over-basement, wood-frame, multi-unit residence constructed in 1906. The subject property was part of the post-earthquake and fire reconstruction of North Beach, which most intensively occurred between 1906-1915. Though associated with this development, 472 Greenwich is not individually representative of this period or pattern of history (Criterion 1). None of the owners or occupants have been identified as rising to the level of individual significance. (Criterion 2).

The vernacular style building was designed by the local firm Righetti & Kuhl, who according to the HCS designed 36 structures in North Beach from 1906-1908. Twenty-six of that sum were flats, with Romeo flats being the predominant typology. Most of their designs were multi-story, multi-bay apartment buildings with highly ornamented facades and detailing typical of the period. Relative to these designs and others completed outside of North Beach by Righetti & Kuhl, 472 Greenwich is not a notable example of their work as it is not architecturally distinguished. The building has had its base overclad with stucco and most of its historic windows replaced, additionally, while not confirmed, likely had some degree of trim/millwork that has been removed from the façade. As such the building does not appear to be individually eligible for architecture (Criterion 3). Based upon a review of information in the Department's records, the subject building is not significant under Criterion 4 since this significance criterion typically applies to rare construction types when involving the built environment. The subject building is not an example of a rare construction type. Assessment of archeological sensitivity is undertaken through the Department's Preliminary Archeological Review process and is outside the scope of this review.

The subject property is outside the boundaries of the original North Beach survey conducted in the early 1980s, but is within the general survey area analyzed in the pending HCS. While survey findings, boundaries, themes, and character-defining features have yet to be finalized as part of the review of this

HCS, the Department is confident that such boundaries would include this stretch of Greenwich Street within a broader and yet to be finalized North Beach historic district. Based on the information currently available, such a district would appear to be eligible for listing in the California Register under Criterion 1 (Events) for its association with the nearly wholesale reconstruction of North Beach following the great earthquake and fire, under Criterion 2 for various individuals that have significantly contributed to the history of the neighborhood and San Francisco at large, and under Criterion 3 (Architecture) as a highly cohesive collection of Classical and other Period Revival styles as well as more strictly vernacular residential buildings constructed in the first half of the 1900s.

While the North Beach HCS is currently under review, this analysis assumes that the period of significance (POS) for the historic district is 1906-1941, the POS determined in the 1980s North Beach survey. While the Department acknowledges that the POS will likely be extended, the currently POS includes 1906-1915, the most intensive period of reconstruction following the earthquake and fire and the period in which Righetti & Kuhl designed 36 buildings in North Beach. The subject property is considered to be a contributor to the eligible expanded North Beach Historic District because it fits within the period of significance and exhibits a vernacular architectural style consistent with that found throughout the district from a firm well associated with the early reconstruction of the neighborhood.

#### Step B: Integrity

The subject property has retained or lacks integrity from the period of significance noted in Step A:						
Location:	□ Retains	Lacks	Setting:	⊠ Retains	Lacks	
Association:	$\boxtimes$ Retains	☐ Lacks	Feeling:	$\boxtimes$ Retains	Lacks	
Design:	$\boxtimes$ Retains	☐ Lacks	Materials:	$\boxtimes$ Retains	Lacks	
Workmanship:	□ Retains	☐ Lacks				

#### **Analysis:**

In order to be determined eligible for the CRHR, the subject building must be found to retain sufficient integrity to convey its historic significance as a district contributor under Criteria 1, 2, and 3. Although the building has been subject to a variety of alterations, most notably the application of stucco cladding at the ground floor and replacement of various windows, these do not rise to the level of significant diminishment of its integrity of design, workmanship, setting, or materials. This is aided by the fact that the structure appears to retain its historic, recessed entry, scale and massing, projecting bays, and roof form. Therefore, the subject building retains integrity and is a historic resource contributory to a historic district eligible for the CRHR under Criteria 1, 2, and 3.

#### **Step C: Character Defining Features**

#### The character-defining features of the subject property include the following:

The subject building's character-defining features that retain enough integrity to convey its significance are:

- Two-story over basement massing
- Projecting bay window at front; two projecting bays at visible west elevation
- Recessed entry with mosaic tile landing
- Horizontal wood cladding
- Restrained, proportional fenestration pattern typical of reconstruction-era North Beach buildings
- Simple wood cornice capping the front façade
- Terrazzo-clad stairs (not original but have acquired their own significance)

CEQA	HISTORIC RESOURCE DETERMINATION:		
	dividually-eligible Historical Resource Present		
$\boxtimes$ C	ontributor to an eligible Historical District / Contextual Resource Present		
$\square$ N	on-contributor to an eligible Historic District / Context / Cultural District		
$\square$ N	o Historical Resource Present		
NEXT	STEPS:		
$\boxtimes$ H	RER Part II Review Required		
$\Box$ C	ategorically Exempt, consult:		
	Historic Design Review		
	Design Advisory Team		
	Current Planner		
PAR	I: PRINCIPAL PRESERVATION PLANNER REVIEW		
Signa	ture:	Date:	
	Allison Vanderslice, Principal Preservation Planner		
	CEQA Cultural Resources Team Manager, Environmental Planning Division		
CC:	Samantha Updegrave, Planner		
	Claudine Asbagh, Northeast Team Leader, Current Planning Division		



# HISTORIC RESOURCE EVALUATION RESPONSE

Record No.: 2019-015440ENV
Project Address: 472 GREENWICH ST

Zoning: RH-3 (Residential-House, Three Family) Zoning District

Telegraph Hill - North Beach Residential Special Use District

40-X Height and Bulk District

*Block/Lot:* 0078/022

Staff Contact: Jonathan Vimr - 628-652-7319

Jonathan.Vimr@sfgov.org

### **Part II: Project Evaluation**

Proposed Project:		Per Drawings Dated:	
□ Demolition / New Construction	$\square$ Alteration	August 6, 2021	

#### **PROJECT DESCRIPTION**

- Demolition of the existing 2,840 square-foot, twounit residential building
- Replacement with a 4,179 square-foot, two-unit residential building
- Provision of driveway and one off-street parking space
- Installation of roof deck with penthouse for access
- New structure will be one story taller than the existing, with a horizontal addition at the rear

#### **DISTRICT COMPATIBILTY ANALYSIS**

#### The proposed project's conformance with the District's Character-Defining Features:

The proposed project represents demolition of a single, existing building that is not an individually eligible property but is considered contributory to the potential eligible North Beach Historic District. Please note that as indicated in the HRER Part 1 the North Beach Historic Context Statement (HCS) remains in draft form and has not yet been reviewed, finalized, or adopted by the Historic Preservation Commission nor have its findings—such as district boundaries—been finalized or adopted.

Although differentiated, the replacement structure appears to also be compatible with the traditional characteristics of other contributory buildings throughout the potential district. It is three stories above basement in height with a roofline slightly lower than its upsloping neighbor on a block that does not have a consistent pattern of stepped buildings. The primary entry at the front façade is prominent and well recessed, with a rectilinear opening to subtly differentiate it from the arched entry openings seen in various nearby structures. Masonry cladding is utilized to delineate the base of the building, which is otherwise clad in a cementitious plaster material akin to stucco (the two materials appear effectively identical to one another, with slight distinctions in composition). Though not as

ubiquitous as painted wood, stucco can be seen throughout the potential district and is the second most common cladding material within the expanded as well as 1980s North Beach survey area. Fenestration at the front façade is sufficiently reserved, with proportions similar to those of surrounding buildings and the use of windows mimicking the fenestration and configurations of adjacent buildings and others in the vicinity. These new windows will be composed of aluminum-clad wood, which matches the profiles and appearance of a wood window with a thin layer of painted metal at the exterior of the frame/sash. Finally, the upper levels of the new building's front façade would be defined by an angled bay window, reflecting the presence of such a bay at the front of the existing structure as well as one of the district's most emblematic architectural features. A simple unadorned cornice will provide an architectural cap for the new structure without recreating historic detailing from other buildings or creating a false sense of historical development, as is true throughout the design. A small deck and stair penthouse are proposed for the roof but will be more than 20' setback from the front of the building and will be minimally, if at all, visible from the surrounding streets.

The only other visible elevation is the western side, which can at least partially be seen from the street. While more heavily fenestrated than typical for side elevations within the potential district and lacking any light wells, it is a secondary elevation that nonetheless would incorporate an appropriate cladding material and awning, casement, and fixed windows that are largely consistent with what is found in the vicinity. This is particularly true for the one-over-one windows seen at the front end of the western elevation, which will have the most visibility from the street. The east (side) and north (rear) elevations will have no visibility from the surrounding public right-of-way, with the cementitious plaster cladding being continued throughout and a more modern architectural treatment proposed at the non-visible rear elevation.

See Cumulative Impacts Analysis comments for additional information.

#### **PROJECT DETERMINATION**

Based on the Historic Resource Evaluation in Part I, the project's scope of work:

□ Will cause a significant adverse impact to the individual historic resource as proposed.

□ Will cause a significant adverse impact to a historic district / context as proposed.

□ Will not cause a significant adverse impact to the individual historic resource as proposed.

□ Will not cause a significant adverse impact to a historic district / context as proposed.

#### **PROJECT IMPACT ANALYSIS**

The 1982 North Beach historic and cultural resources survey identified each of the approximately 1,100 buildings located within the survey's boundaries, which emanated out in all directions from its rough center at Washington Square Park. A total of four (4) historic districts were found to be present within these original boundaries: the Upper Grant Avenue, Washington Square and Powell Street Shops historic districts, and then the Jackson Square Historic District Extension. As proposed, the survey area for the draft North Beach HCS would include the entirety of the 1982 survey alongside slight extensions to the west and more substantial expansion to the east, thereby adding hundreds more parcels spread across all or part of approximately 22 additional blocks. While no findings have been made and the draft HCS has yet to be reviewed, finalized, or adopted by the Historic Preservation Commission, the community group sponsoring the HCS has indicated their belief that a new, expanded North Beach Historic District could represent the entirety of this expanded survey area, with almost all properties within it being contributory.



Although the project at 472 Greenwich Street would result in the demolition of a district contributor, given the size of the potential North Beach Historic District (however its final boundaries may be drawn) and its potential period of significance (1906-1965) the district would appear to include at least hundreds of properties, the large majority of which would likely be considered contributors. The removal of one of hundreds of contributing properties would not result in an adverse impact resulting in material impairment to the district. Additionally, the replacement structure is differentiated from but largely compatible with the character of its immediate vicinity and the broader potential district and therefore, the new construction would also not have an impact on the potential district.

#### **CUMULATIVE IMPACTS ANALYSIS**

The geographic scope, or cumulative study area, for cumulative historic resource impacts includes the project site, the 1982 North Beach survey area, and the expanded survey area seen in the draft North Beach HCS.

Staff finds that demolition of 472 Greenwich and construction of the proposed project would not result in a cumulative impact to the potential eligible North Beach Historic District as the overall integrity of the district would not be impacted by demolition of a single contributor among hundreds. This is even more so true given that the new construction will be compatible overall in terms of massing, material and proportions and reflects various character-defining features such as an angled bay window, a cornice (albeit differentiated), and a prominent recessed entry.

While the expanded North Beach survey has yet to finalize findings such as the boundaries of a potential district or said district's period of significance, it is currently anticipated that the boundaries will cover some, if not all of the expanded survey area, and that the period of significance could be 1906-1965. Although district boundaries and contributors and non-contributors have not been finalized, the Department has generally found that projects in the study area subject to historic resource review have conformed with the Standards. Furthermore, since 2010 there has only been two (2) demolitions of what would appear to have been contributory buildings within the expanded survey area. This includes demolition of the North Beach Branch public library at the former, northeasterly intersection of Columbus Avenue and Mason Street as part of the construction of a new library facility and related improvements to the North Beach Playground (aka the Joe DiMaggio Playground) as well as demolition and replacement of the one-story restroom facility at the northwesterly corner of Washington Square Park. The latter demolition required and obtained a Certificate of Appropriateness from the Historic Preservation Commission (HPC Motion No. 0193). Of the active Planning cases within the cumulative study area there are three (3) demolition projects pending or undergoing review, including the subject project, and nine (9) alteration projects undergoing review. At this time all the alteration projects would appear to generally meet the Secretary of the Interior's Standards.

Given the very limited number of demolitions of potentially contributory properties, and that most or all pending alteration projects within the expanded survey area will comply with the Secretary of the Interior's Standards, Planning Department preservation staff did not identify a cumulative impact to the historic district.



### **PART II: Principal Preservation Planner Review**

Signature: August 11, 2021

Allison Vanderslice, *Principal Preservation Planner* CEQA Cultural Resources Team Manager, Environmental Planning Division

#### **HRER PART II ATTACHMENTS:**

✓ Architectural Plans, dated: August 6, 2021
 ✓ HRA / Supplemental, dated: May, 2019
 ✓ HRER Pt.1, finalized date: May 4, 2020







# **LAND USE INFORMATION**

EXHIBIT D

PROJECT ADDRESS: 472 GREENWICH STREET RECORD NO.: 2019-015440CUA


	EXISTING	PROPOSED	NET NEW
	GROSS SQUARE	FOOTAGE (GSF)	
Parking GSF	0	269	269
Residential GSF (conditioned space)	1,673	3,647	1,974
Retail/Commercial GSF	0	0	0
Office GSF	0	0	0
Industrial/PDR GSF  Production, Distribution, & Repair	0	0	0
Medical GSF	0	0	0
Visitor GSF	0	0	0
CIE GSF	0	0	0
Usable Open Space	396	576	180
Public Open Space	0	0	0
Other (unconditioned space)	637	532	-105
TOTAL GSF	2,310	4,179	1,869
	EXISTING	NET NEW	TOTALS
	PROJECT FEATURES	S (Units or Amounts)	T
Dwelling Units - Affordable	0	0	0
Dwelling Units - Market Rate	2	0	2
Dwelling Units - Total	2	0	2
Hotel Rooms	0	0	0
Number of Buildings	1	0	1
Number of Stories	3	1	4
Parking Spaces	0	1	1
Loading Spaces	0	0	0
Bicycle Spaces	0	2	2
Car Share Spaces	0	0	0

	EXISTING	PROPOSED	NET NEW			
	LAND USE - RESIDENTIAL					
Studio Units	0	0	0			
One Bedroom Units	0	0	0			
Two Bedroom Units	1	1	0			
Three Bedroom (or +) Units	1	1	0			
Group Housing - Rooms	0	0	0			
Group Housing - Beds	0	0	0			
SRO Units	0	0	0			
Micro Units	0	0	0			
Accessory Dwelling Units	0	0	0			




# **Parcel Map**


# EXHIBIT E

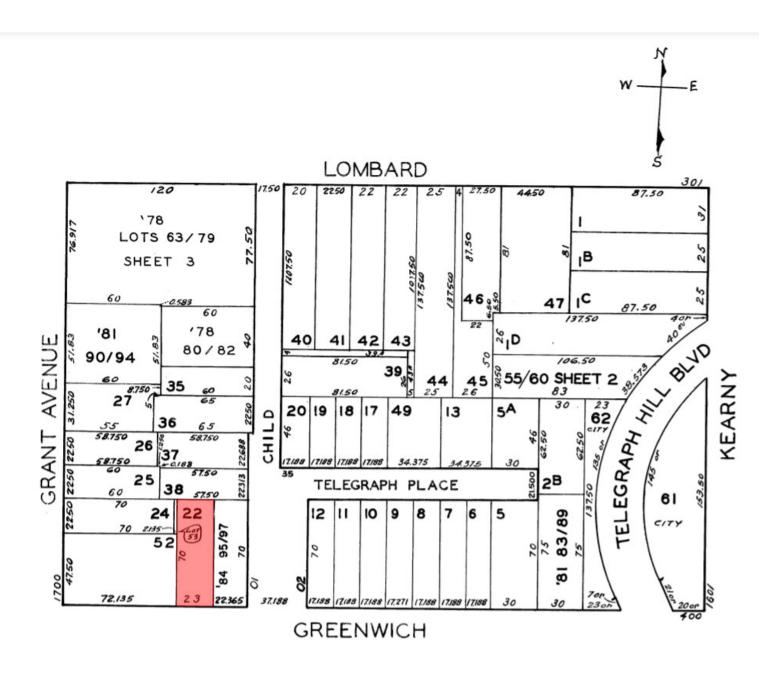




# Sanborn Map\*

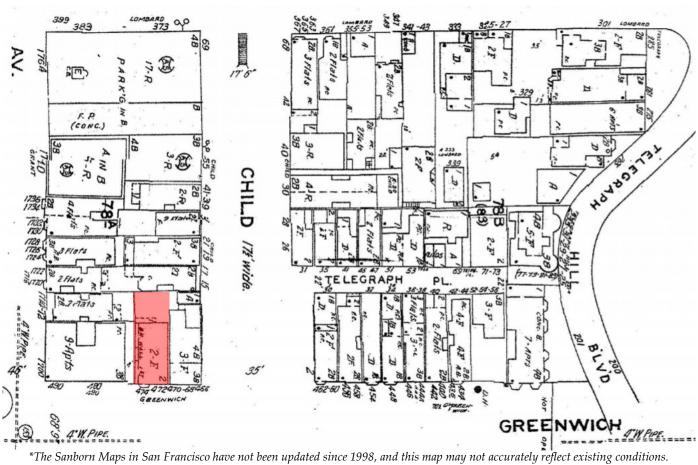

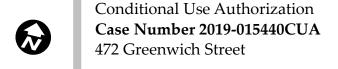



# **Aerial Photo**

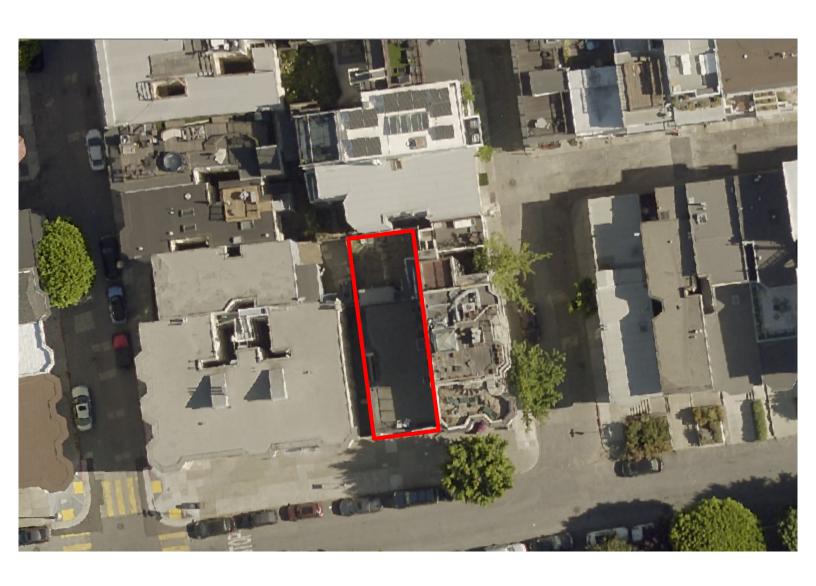




# **Zoning Map**

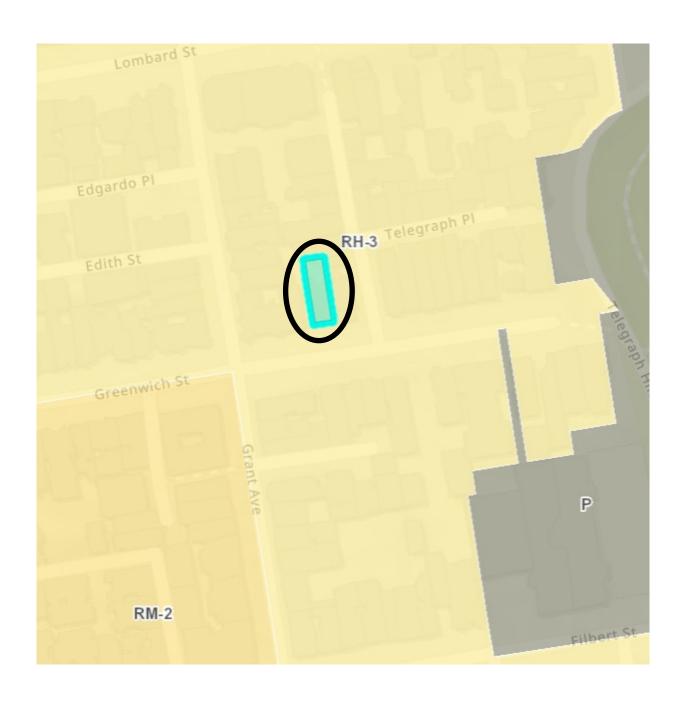

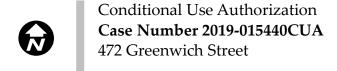

# **Site Photo**

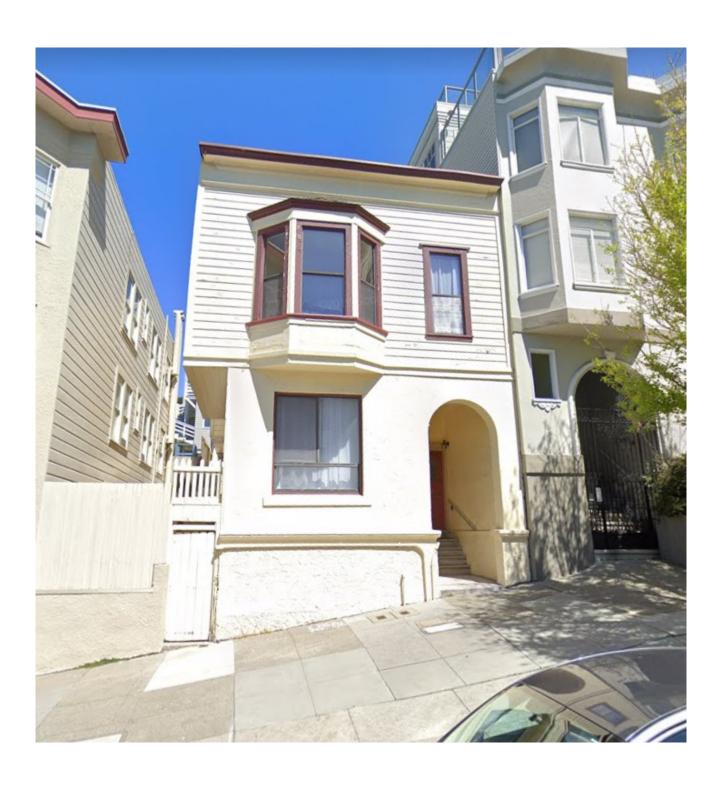

Conditional Use Authorization Case Number 2019-015440CUA 472 Greenwich Street



<u>)</u>

www.que-arch.com info@que-arch.com

 $4243\ 25^{th}$  street / san francisco, ca 94114, usa tel. 415.695.2700 / fax. 415.695.1308

Jonathan Vimr
Senior Planner, Preservation
San Francisco Planning Dept.
49 South Van Ness Avenue, Suite 1400
San Francisco, CA 94103

Direct: 628.652.7319 jonathan.vimr@sfgov.org

Property Address: 472 Greenwich Street

Block/Lot: 0078/022 Building PA #: 201908068024 Planning Record #: 2019-015440PRJ EXHIBIT **F** 

April 23, 2021

#### RE: AFFIDAVIT FOR GARAGE ADDITION

Jonathan,

Pursuant of the San Francisco Planning Code Section 249.49(c)(2), I hereby attest the proposed new garage addition meets the following:

- (1) The proposed garage opening/addition of off-street parking will not cause the elimination or reduction of ground-story retail or commercial space;
  - This block is a entirely residential and the subject property has no retail or commercial space on the ground story.
- (2) the proposed garage opening/addition of off-street parking will not eliminate or decrease the square footage of any dwelling unit;
  - The garage is in place of an existing, inhabitable crawlspace.

Vaisages?

(3) (3) the building has not had two or more evictions within the past 10 years, with each eviction associated with a separate unit(s)

Regards,

Dawn Ma, PE, M.Arch.

Principal

Q-Architecture, Inc.

dma@que-arch.com

415-695-2700

# Rent Board Response to Request from Planning Department for Eviction History Documentation

Re: 472 Greenwich Street

This confirms that the undersigned employee of the San Francisco Rent Board has reviewed its records pertaining to the above-referenced unit(s) to determine whether there is any evidence of evictions on or after the date specified. All searches are based upon the street addresses provided.

•				
	ed eviction notices were filed at the 12/10/13 03/13/14 10 years prior to the following date:		_	
Yes, an	eviction notice was filed at the Rent 12/10/13 03/13/14 10 years prior to the following date:	Board after:	-	
	re no other Rent Board records evid 12/10/13 03/13/14 10 years prior to the following date:	J	ter: -	
Yes, the	ere are other Rent Board records events are other Rent Board records events are of the following date:  o See attached documents.	idencing a an eviction	ı after:	
Jen	Jongkobs nifer Rakowski Board Supervisor		Dated:	8/24/2021
The Re	nt Roard is the originating custodiar	n of these records: th	e applica	ability of these record

The Rent Board is the originating custodian of these records; the applicability of these records to Planning permit decisions resides with the Planning Department.