



3832 18th Street – Planning Commission

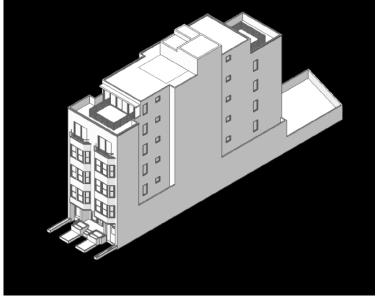

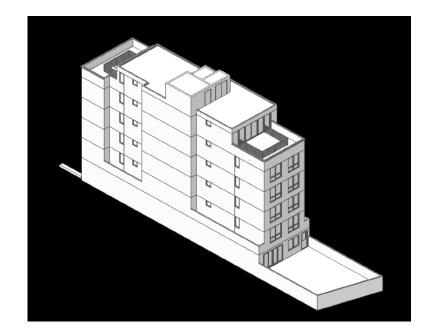

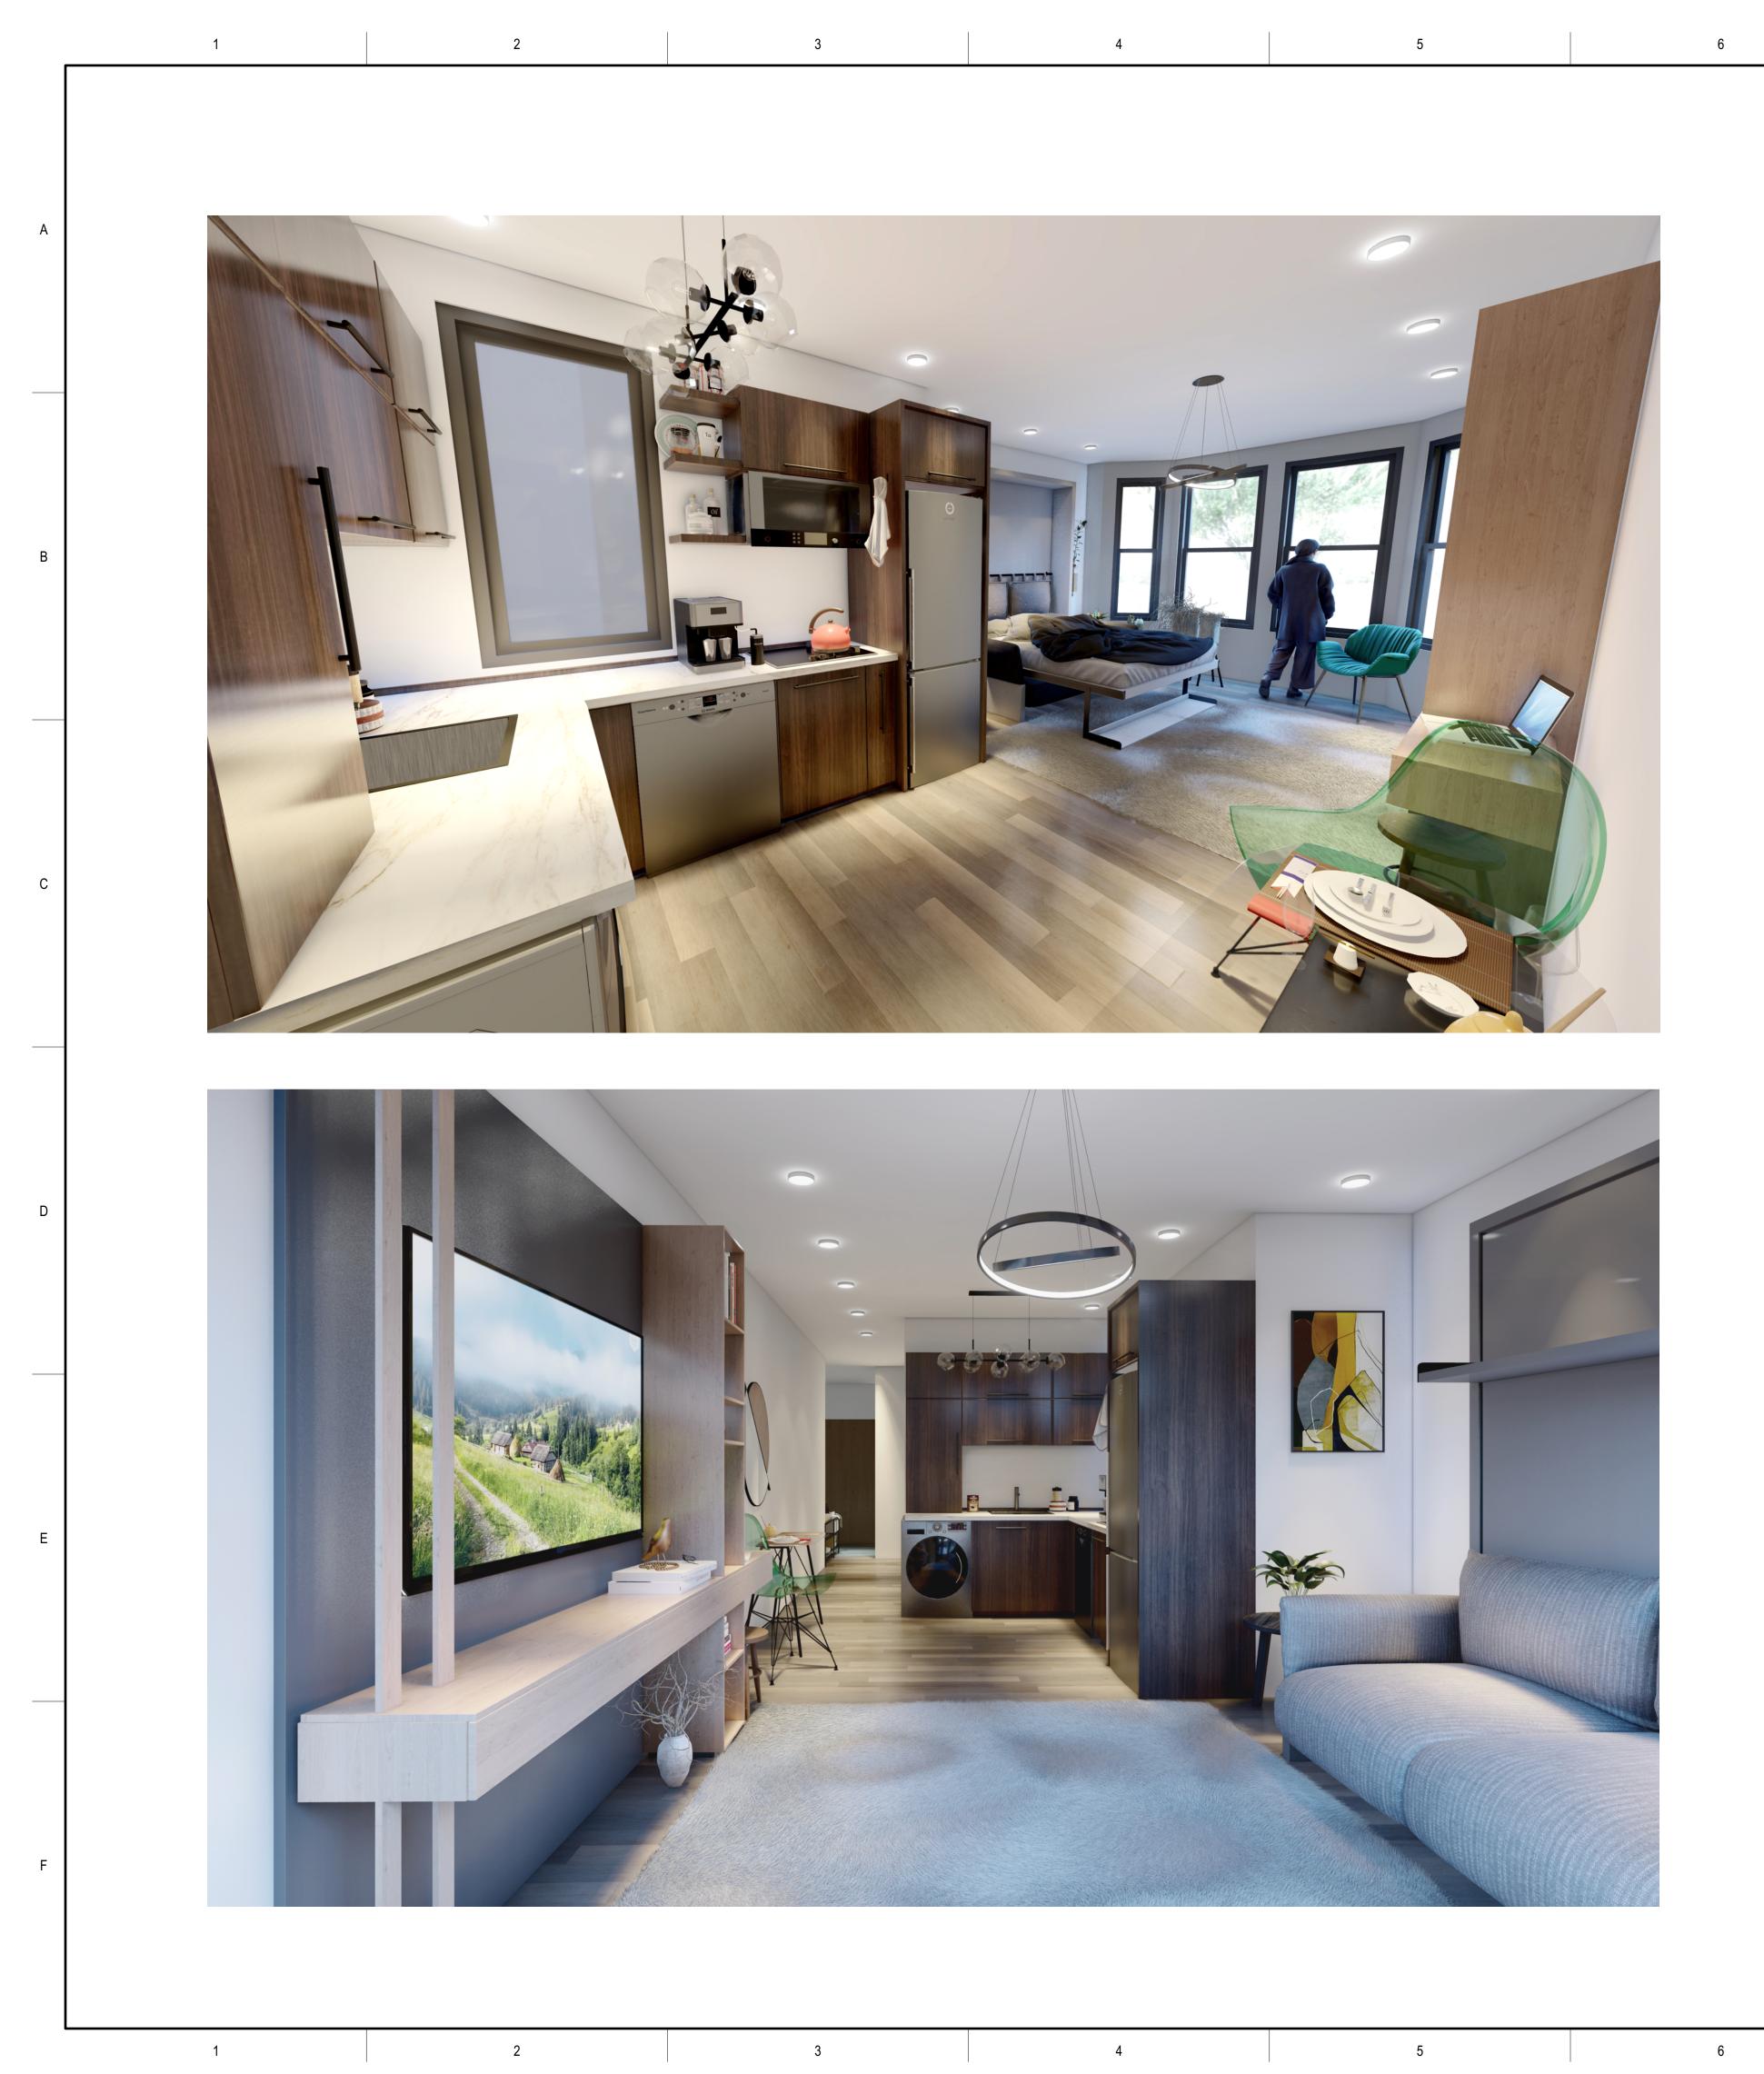

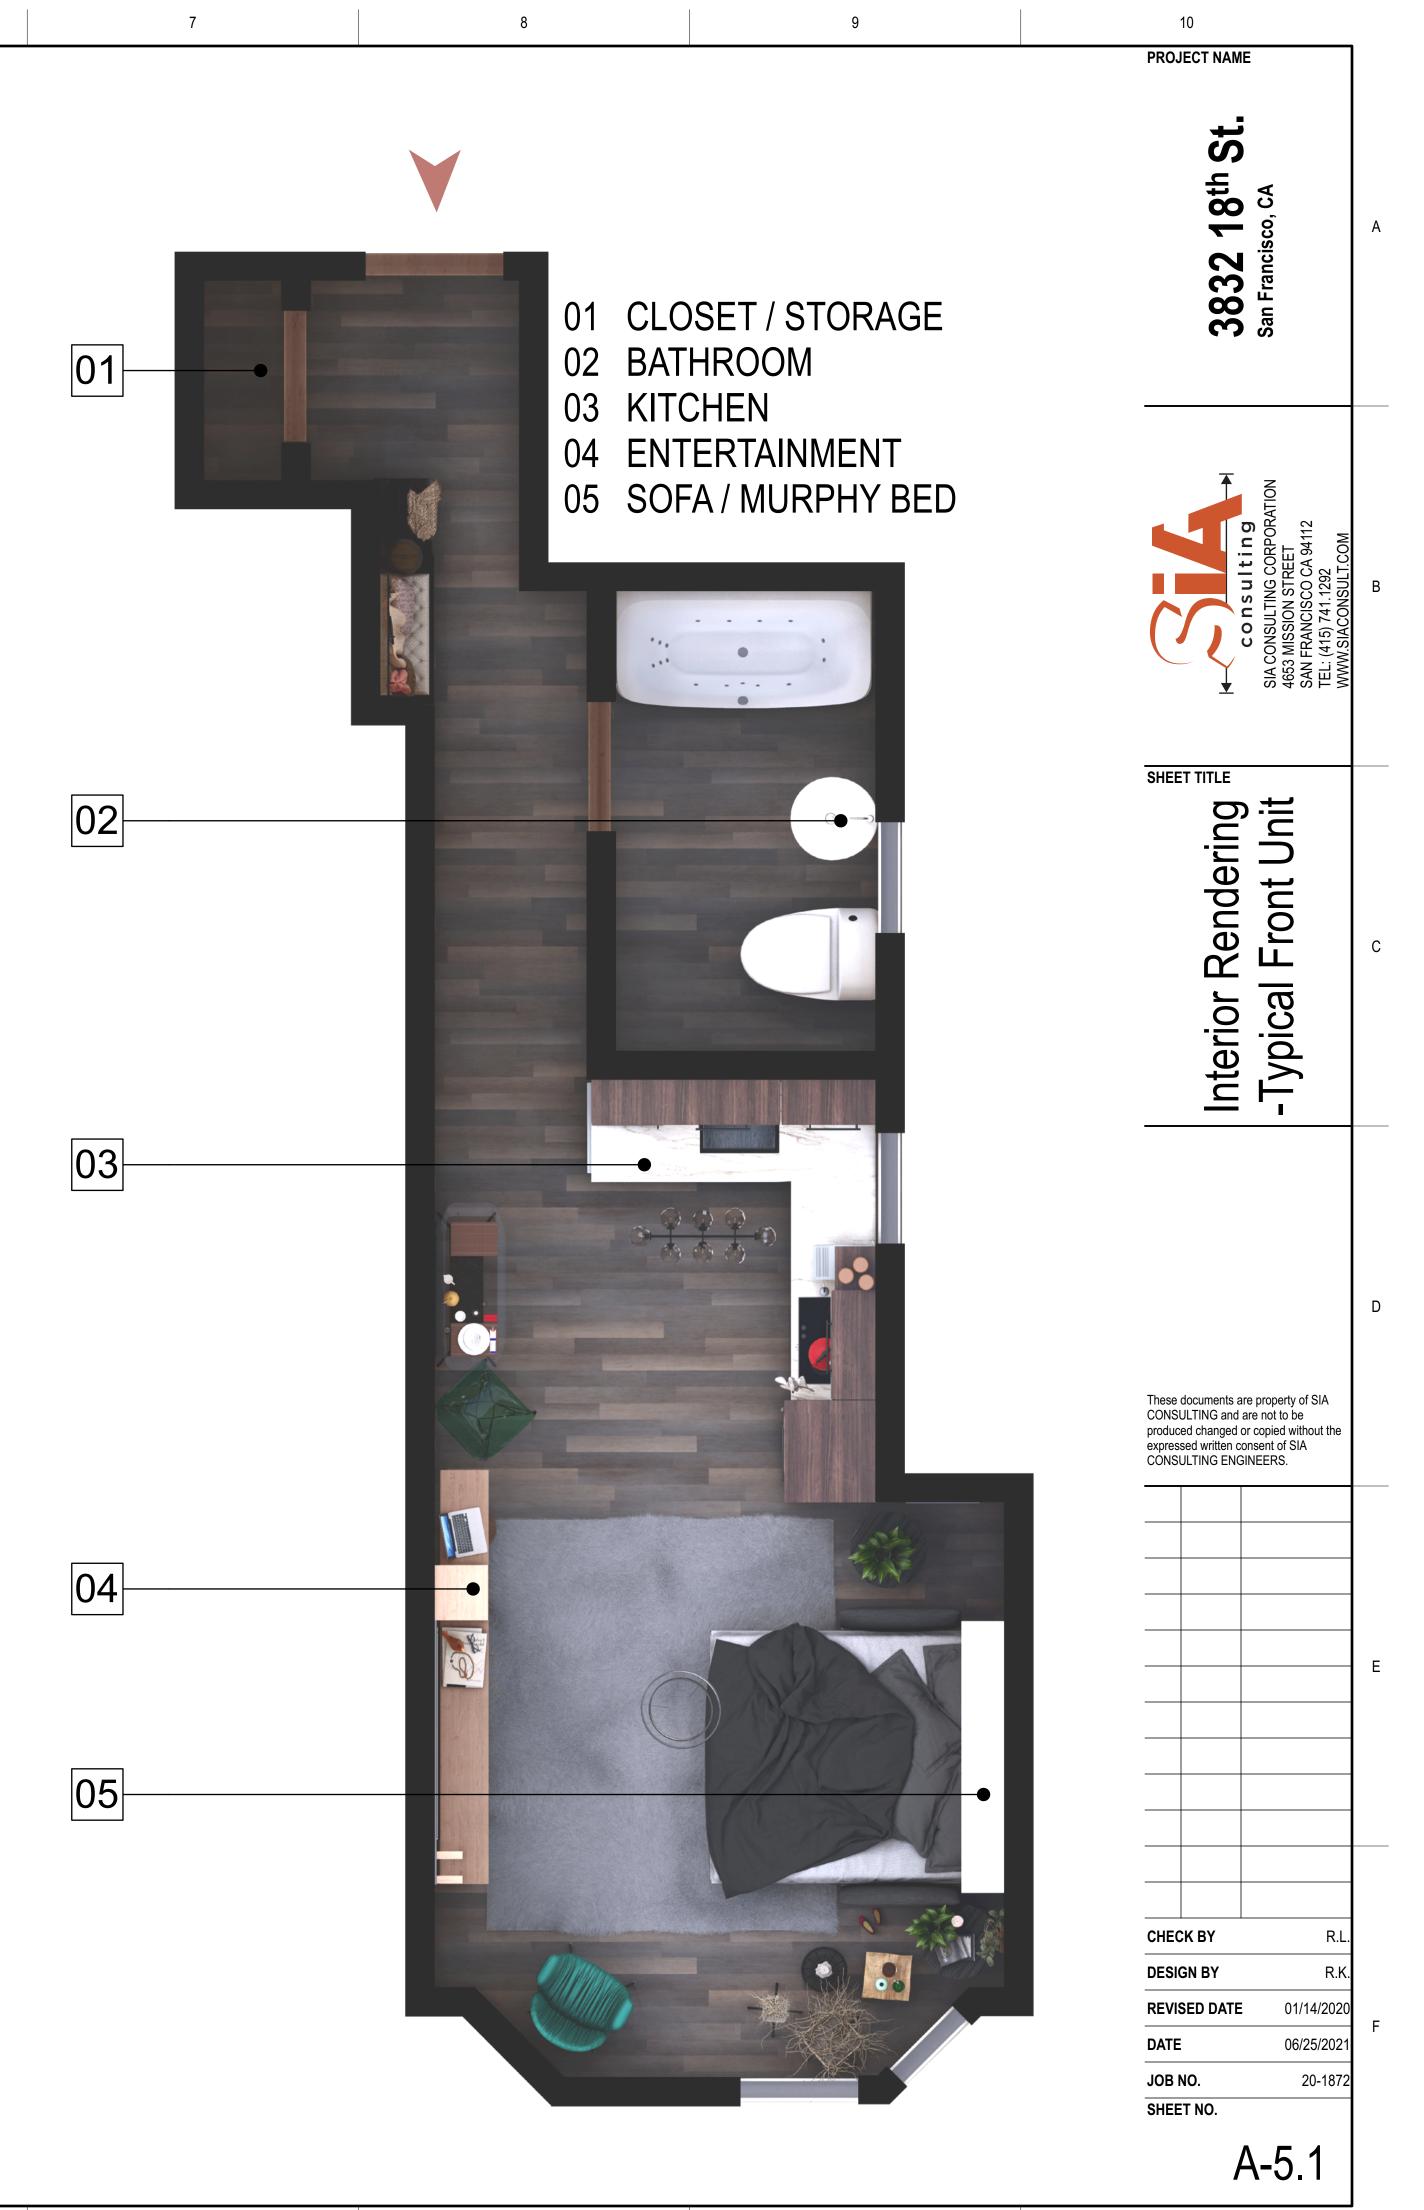






a shat a			
Quantitative Summa	ary of Shadow Findings on		
			20 acres (or 618,561 sf)
		Square Foot Hours	Percentage (of TAAS)
Theoretical Annual A	Available Sunlight (TAAS)	2,301,914,692 sfh	100 %
	Existing Shadow	91,997,866 sfh	3.997 %
	New Shadow	12,327 sfh	+0.001 %
Total Shado	w with Proposed Project	92,010,192 sfh	3.998 %
Qualitative Summar	y of Shadow Findings on N	Aission Dolores Park	
TATIN STREET	FE & Largest area of net new shadow on Massion Defi	vers Park (8/21 at 7.35 pm)	Proposed Project Existing (current) Shadow Net New Shadow from Proposed Project Parks and Open Spaces (Jurisdiction) Mission Dolores Park (RPD)
Time Of Day	Evening (7:36 PM)	Amount, Date & Time Of Max New Shadow	860 sf on June 21
Time Of Year	Spring-Summer; April 20 – Aug 22	Location/Avg Area	NW corner covering approximately 0.12%
Avg Daily Duration	12.1 minutes	Of New Shadow	of park area (773 sf)
Activities Affected	 Maintenance/uti 	lity area	
By New Shadow	2. Pathway		




Source: Recreation and Parks Commission Staff Report

3. Muni stop

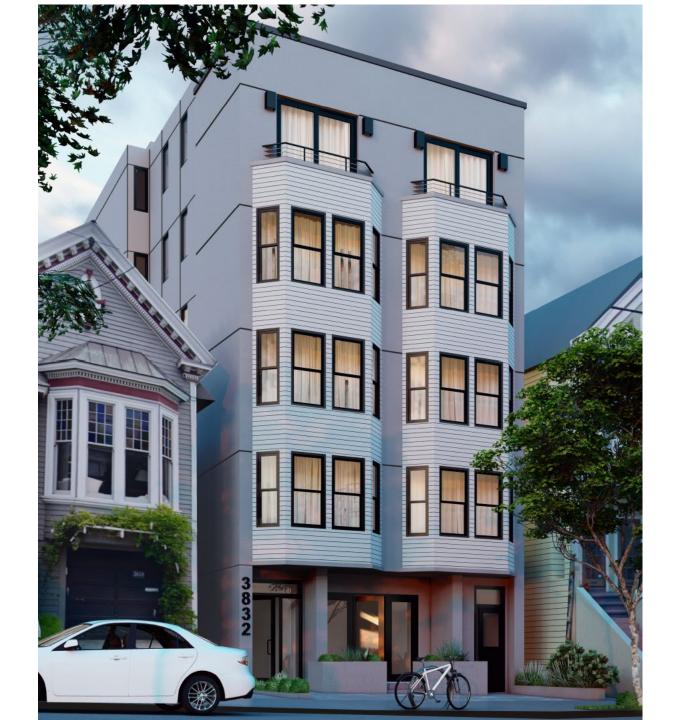

Thank you




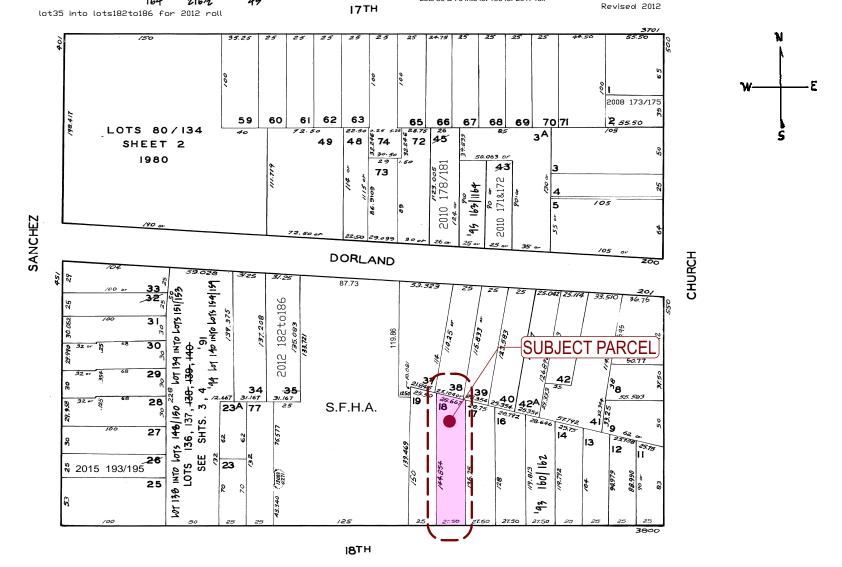



F

	5		6		7			8	9		10	MF I
LOT	<u>NNING DATA</u> AREA: CK / LOT: ING:	3,8 35	JECT DATA 868 ± S.F. 580/018 M-1				, WITH 19 GR		IORK 6-STORY RESIDENTIAL NITS UNDER STATE-DE		0 1 8th St	rcisco, CA
BUIL	DING HEIGHT. ALLOWED PROPOSED): 40)-X)'-0"			- THIS IS A PRIVA	TELY FUNDED COVER	ED MULTIFAMILY DWELLING E	BUILDING & COMPLIES W/ CBC CH. 11A.		× ×	San Frar
PAR CLA	BLE OPEN SF REQUIRED PROVIDED KING SUMMA ASS I BICYCL ASS II BICYCI): 82 : (8 9 RY: E : 19	1 S.F.(133/3) X 17 90 @ 1st FLR + 31	(, , , , , , , , , , , , , , , , , , ,		A-1.1 A-1.2		P / SITE PHOTOS ASSING DIAGRAN N /S (1)				CONSULTING CORPORATION SIA CONSULTING CORPORATION 4653 MISSION STREET SAN FRANCISCO CA 94112 TEL: (415) 741.1292 WWW.SIACONSULT.COM
<u>BUIL</u>	<u>DING CODE </u>	<u>SUMMARY</u>				A-1.3 A-2.0 A-2.1		EMÓ FLOOR PLA	NS		SHEET TITLE	
# OF CON OCC	STORIES: UNITS: ISTRUCTION UPANCY GRO	TYPE: TY DUP: R-	9 RESIDENTIAL 'PE "V-A" OVEF -2 FPA 13			A-3.2	BUILDING EL BUILDING EL BUILDING SE	EVATIONS (EAST EVATION (NORTH EVATION (SOUTH CTION	-) -			Cover Sheet
2019 (2019 (2019 (2019 (2019 (2019 (2019 (CALIFORNIA ELE CALIFORNIA ME CALIFORNIA PLI	ILDING CODE ECTRICAL CO CHANICAL CO JMBING COD E CODE W/ S ERGY CODE		ICISCO AMENDM NCISCO AMENDN ISCO AMENDMEI	ENTS //ENTS	A-5.2 A-5.3 A-5.4 A-5.5 G-1.0	INTERIOR RI INTERIOR RI EXTERIOR R	ENDERING - TYPI ENDERING - GRO ENDERING - COM ENDERING - REA DING CHECKLIST	UND FLOOR UNIT IMUNITY ROOM AR YARD			S
NFPA NFPA NFPA		S & FDC & ERRCS (CI CY STANDBY	BC SEC. 510) POWER SYSTEM STEM (ALSO CBC			& SHALL NO DIMENSION	T BE USED FOR S S MAY VARY FRO	SELLING OR LEASING F M THESE PLANS DUE 1	R PERMIT APPLICATION PURPO PURPOSES. FINAL SQ.FT & FIN TO CONSTRUCTION VARIABLES REQ. PER PLANNING CODE SE	ISHED S.	CONSULTING an	l or copied without the consent of SIA
					UNIT	MATRIX						
FLOOR ARE	EA DATA BRE		(GSF)					RESIDEN	TIAL UNIT COUNT			E
LEVEL	OPEN SPACE	RESIDENTIAL	CIRCULATION	GARBAGE / UTILITY/MAIL	COMMON ROOM	BIKE PARKING	TOTAL	UNIT TYPE	# OF UNITS			
1ST FLOOR	890 ± S.F. COMMON	400 ± S.F.	1,160 ± S.F.	370 ± S.F.	367 ± S.F.	128 ± S.F.	2,425 ± S.F.	-	1			
2ND FLOOR	-	1,605 ± S.F.	305 ± S.F.	-	-	-	1,910 ±S.F.	-	4			
3RD FLOOR	-	1,605 ± S.F.	305 ± S.F.	-	-	-	1,910 ±S.F.	GROUP HOUSING	4		CHECK BY	R.L.
4TH FLOOR 5TH FLOOR	-	1,605 ± S.F. 1,563 ± S.F.	305 ± S.F. 305 ± S.F.	-	-	-	1,910 ±S.F. 1,868 ±S.F.		4		REVISED DAT	
6TH FLOOR	314 ± S.F. (165+149)	819 ± S.F.	305 ± S.F.	-	-	-	1,124 ±S.F.		2		JOB NO. SHEET NO.	20-1872
TOTAL	PRIVATE 1,204 ± S.F.	7,597 ± S.F.	2,685 ± S.F.	370 ± S.F.	367 ± S.F.	128 ± S.F.	11,147 ±S.F.		19			A-0.1


			PROJI	ECT DATA					SCOPE OF WO	DRK	PROJECT NAM	ME
	LOT BLO	NNING DATA AREA: OCK / LOT: IING:	3,86	8 ± S.F. 0/018				, WITH 19 GR	NSTRUCTION OF 6-	STORY RESIDENTIAL	32 18th St	sco, CA
	BUIL	DING HEIGH ALLOWEI PROPOSEI): 40-2				- THIS IS A PRIVA	TELY FUNDED COVER	ED MULTIFAMILY DWELLING BUI	ILDING & COMPLIES W/ CBC CH. 11A.		San Franci
	USA	BLE OPEN SF REQUIRED PROVIDED): 821	,	UNITS + (100/3)		A-0.1 A-0.2 A-0.3					ulting G CORPORATION TREET D CA 94112
	CL	KING SUMMA ASS I BICYCL ASS II BICYC	E: 19				C-1 A-1.1 A-1.2 A-1.3	SURVEY (N) SITE PLA AERIAL VIEV AERIAL VIEV	VS (1)			CONSULTING SIA CONSULTING 4653 MISSION S SAN FRANCISCO
	<u>BUII</u>		<u>SUMMARY</u>				A-2.0 A-2.1	EXISTING / E	DEMO FLOOR PLAN	IS	SHEET TITLE	
	# OF CON OCC	STORIES: UNITS: NSTRUCTION CUPANCY GRO NKLER SYST	TYPE: TYP DUP: R-2	RESIDENTIAL E "V-A" OVER PA 13			A-2.2 A-3.1 A-3.2	FLOOR & RO BUILDING EI BUILDING EI BUILDING EI BUILDING SI	OF PLANS EVATIONS (EAST & EVATION (NORTH) EVATION (SOUTH)			ver Sheet
	APP	LICABLE COD	ES:				A-5.2 A-5.3	INTERIOR R	ENDERING - TYPIC ENDERING - GROU	AL REAR UNIT		ပိ
<image/>	2019 2019 2019 2019 2019 2019 2019 2019	CALIFORNIA BU CALIFORNIA EL CALIFORNIA ME CALIFORNIA PL CALIFORNIA FIF CALIFORNIA FIF CALIFORNIA EN SAN FRANCISC A 13 SPRINKLERS A 14 STANDPIPES A 72 FIRE ALARM A 110 EMERGENO A 720 CARBON M	ECTRICAL COD CHANICAL COD JMBING CODE & CODE W/ SA ERGY CODE O HOUSING CO & & FDC & ERRCS (CBC CY STANDBY PC	E W/ SAN FRAN DE W/ SAN FRAN W/ SAN FRANCI N FRANCISCO A DE SEC. 510) DWER SYSTEM	CISCO AMENDA NCISCO AMENDA ISCO AMENDME MENDMENTS	IENTS MENTS	& SHALL NC DIMENSION	EXTERIOR F GREEN BUIL	SELLING OR LEASING PU M THESE PLANS DUE TO		These documents CONSULTING and produced changed expressed written CONSULTING EN	d are not to be d or copied with consent of SIA
						UNIT	MATRIX					
N 	FLOOR AR	EA DATA BRE	AKDOWN (G	SF)					RESIDENT	IAL UNIT COUNT		
Ε Ε	LEVEL	OPEN SPACE	RESIDENTIAL	CIRCULATION	GARBAGE / UTILITY/MAIL	COMMON ROOM	BIKE PARKING	TOTAL	UNIT TYPE	# OF UNITS		
	1ST FLOOR	890 ± S.F. COMMON	400 ± S.F.	1,160 ± S.F.	370 ± S.F.	367 ± S.F.	128 ± S.F.	2,425 ± S.F.		1		
	2ND FLOOR	-	1,605 ± S.F.	305 ± S.F.	-	-	-	1,910 ±S.F.		4		
	3RD FLOOR	-	1,605 ± S.F.	305 ± S.F.	-	-	-	1,910 ±S.F.		4	СНЕСК ВҮ	
	4TH FLOOR	-	1,605 ± S.F.	305 ± S.F.	-	-	-	1,910 ±S.F.		4	DESIGN BY	E 01/ [.]
	5TH FLOOR	- 314 ± S.F.	1,563 ± S.F.	305 ± S.F.	-	-	-	1,868 ±S.F.		4	DATE JOB NO.	07/
	6TH FLOOR	314 ± 5.F. (165+149) PRIVATE	819 ± S.F.	305 ± S.F.	-	-	-	1,124 ±S.F.		2	SHEET NO.	
	TOTAL	1,204 ± S.F.	7,597 ± S.F.	2,685 ± S.F.	370 ± S.F.	367 ± S.F.	128 ± S.F.	11,147 ±S.F.		19		A-0.

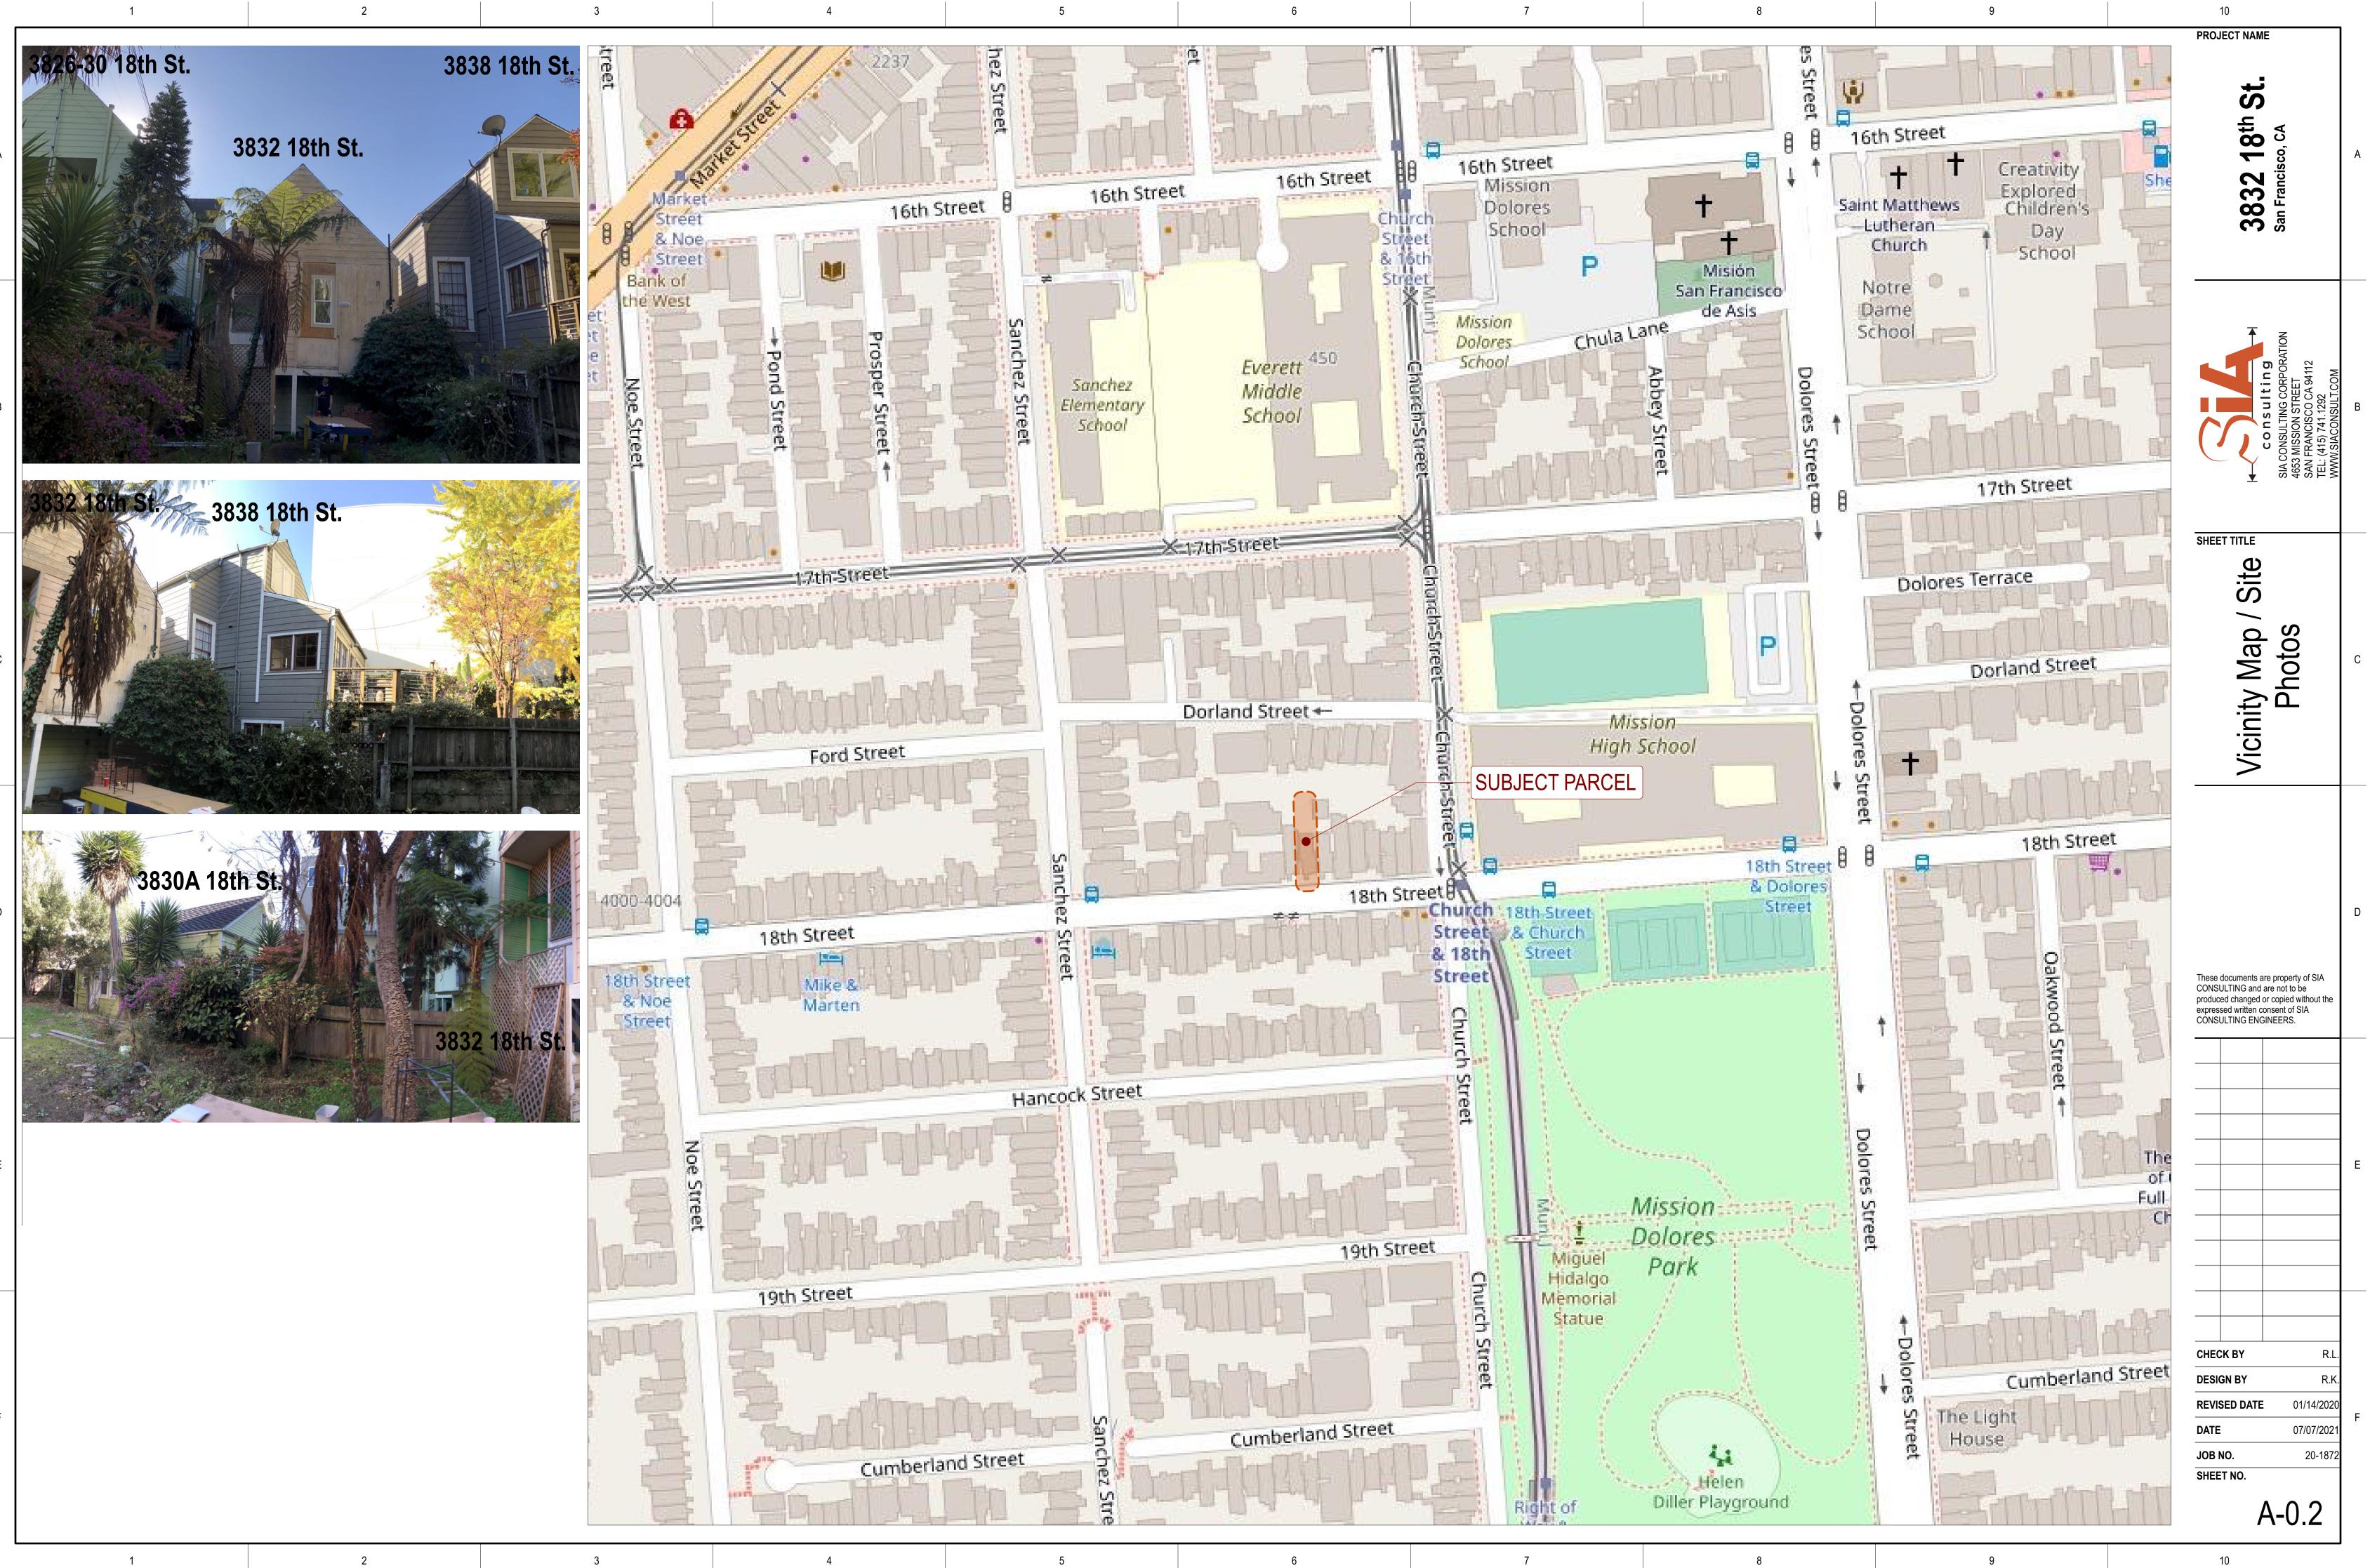


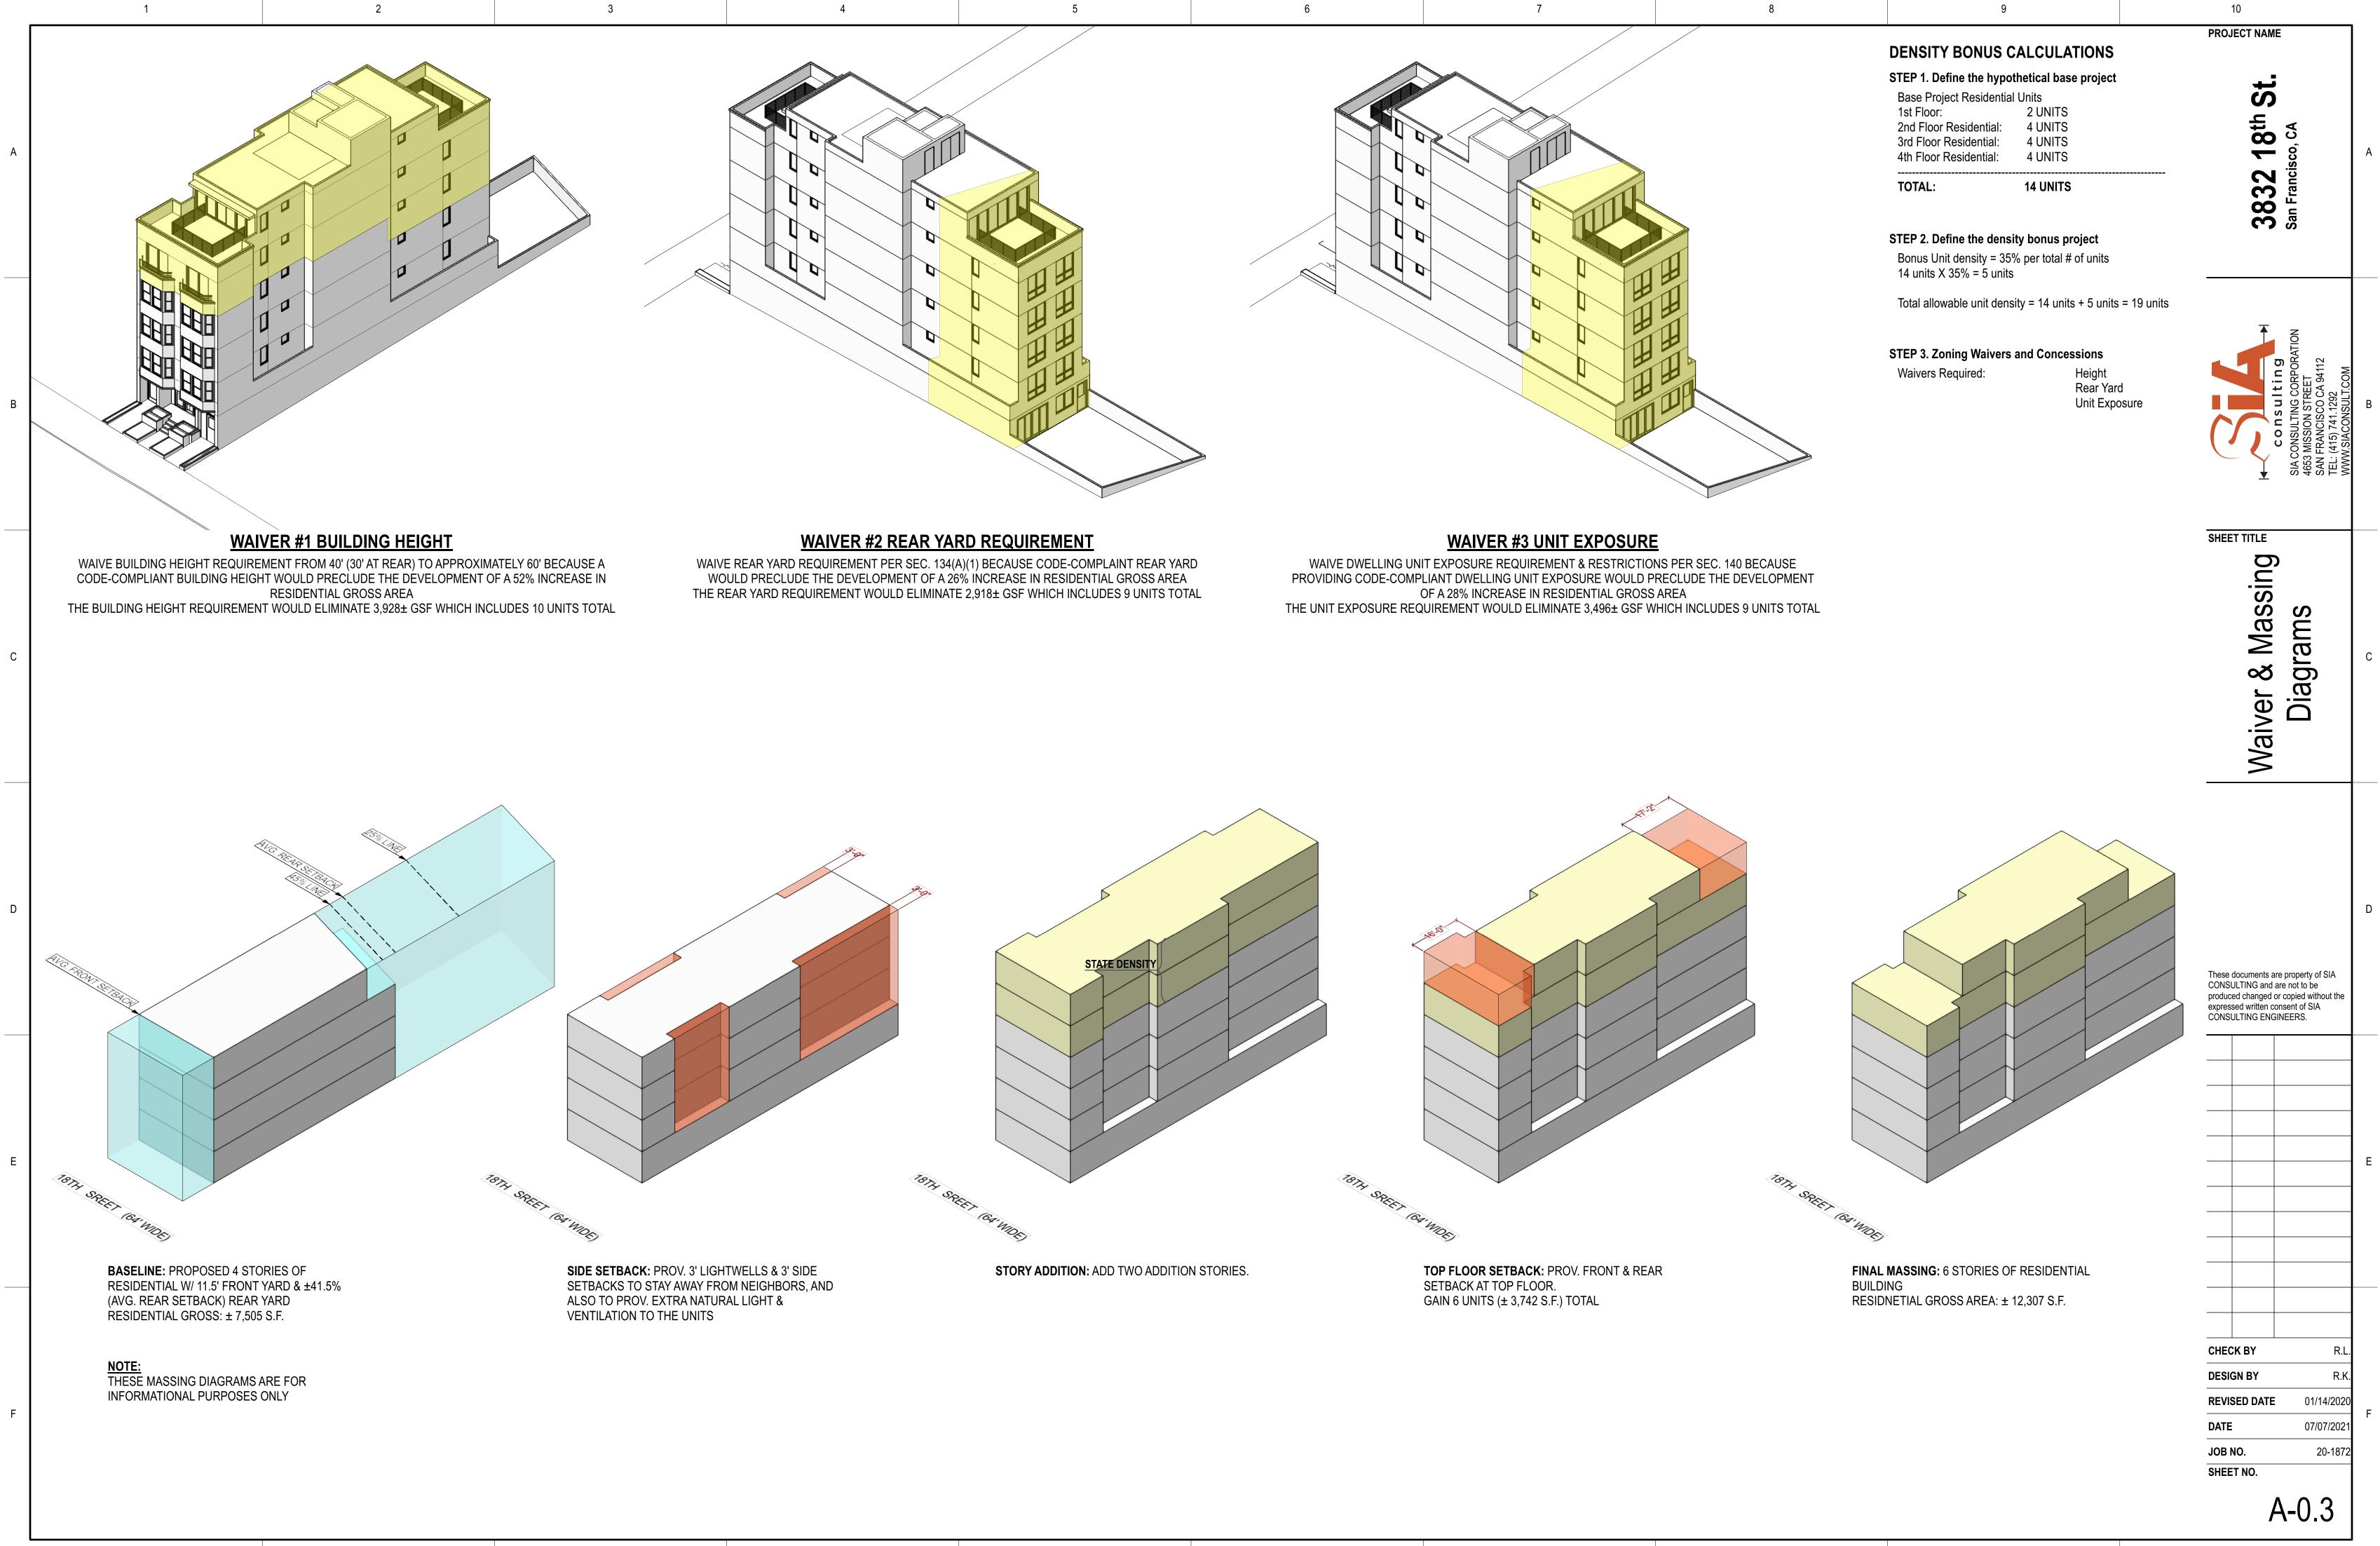

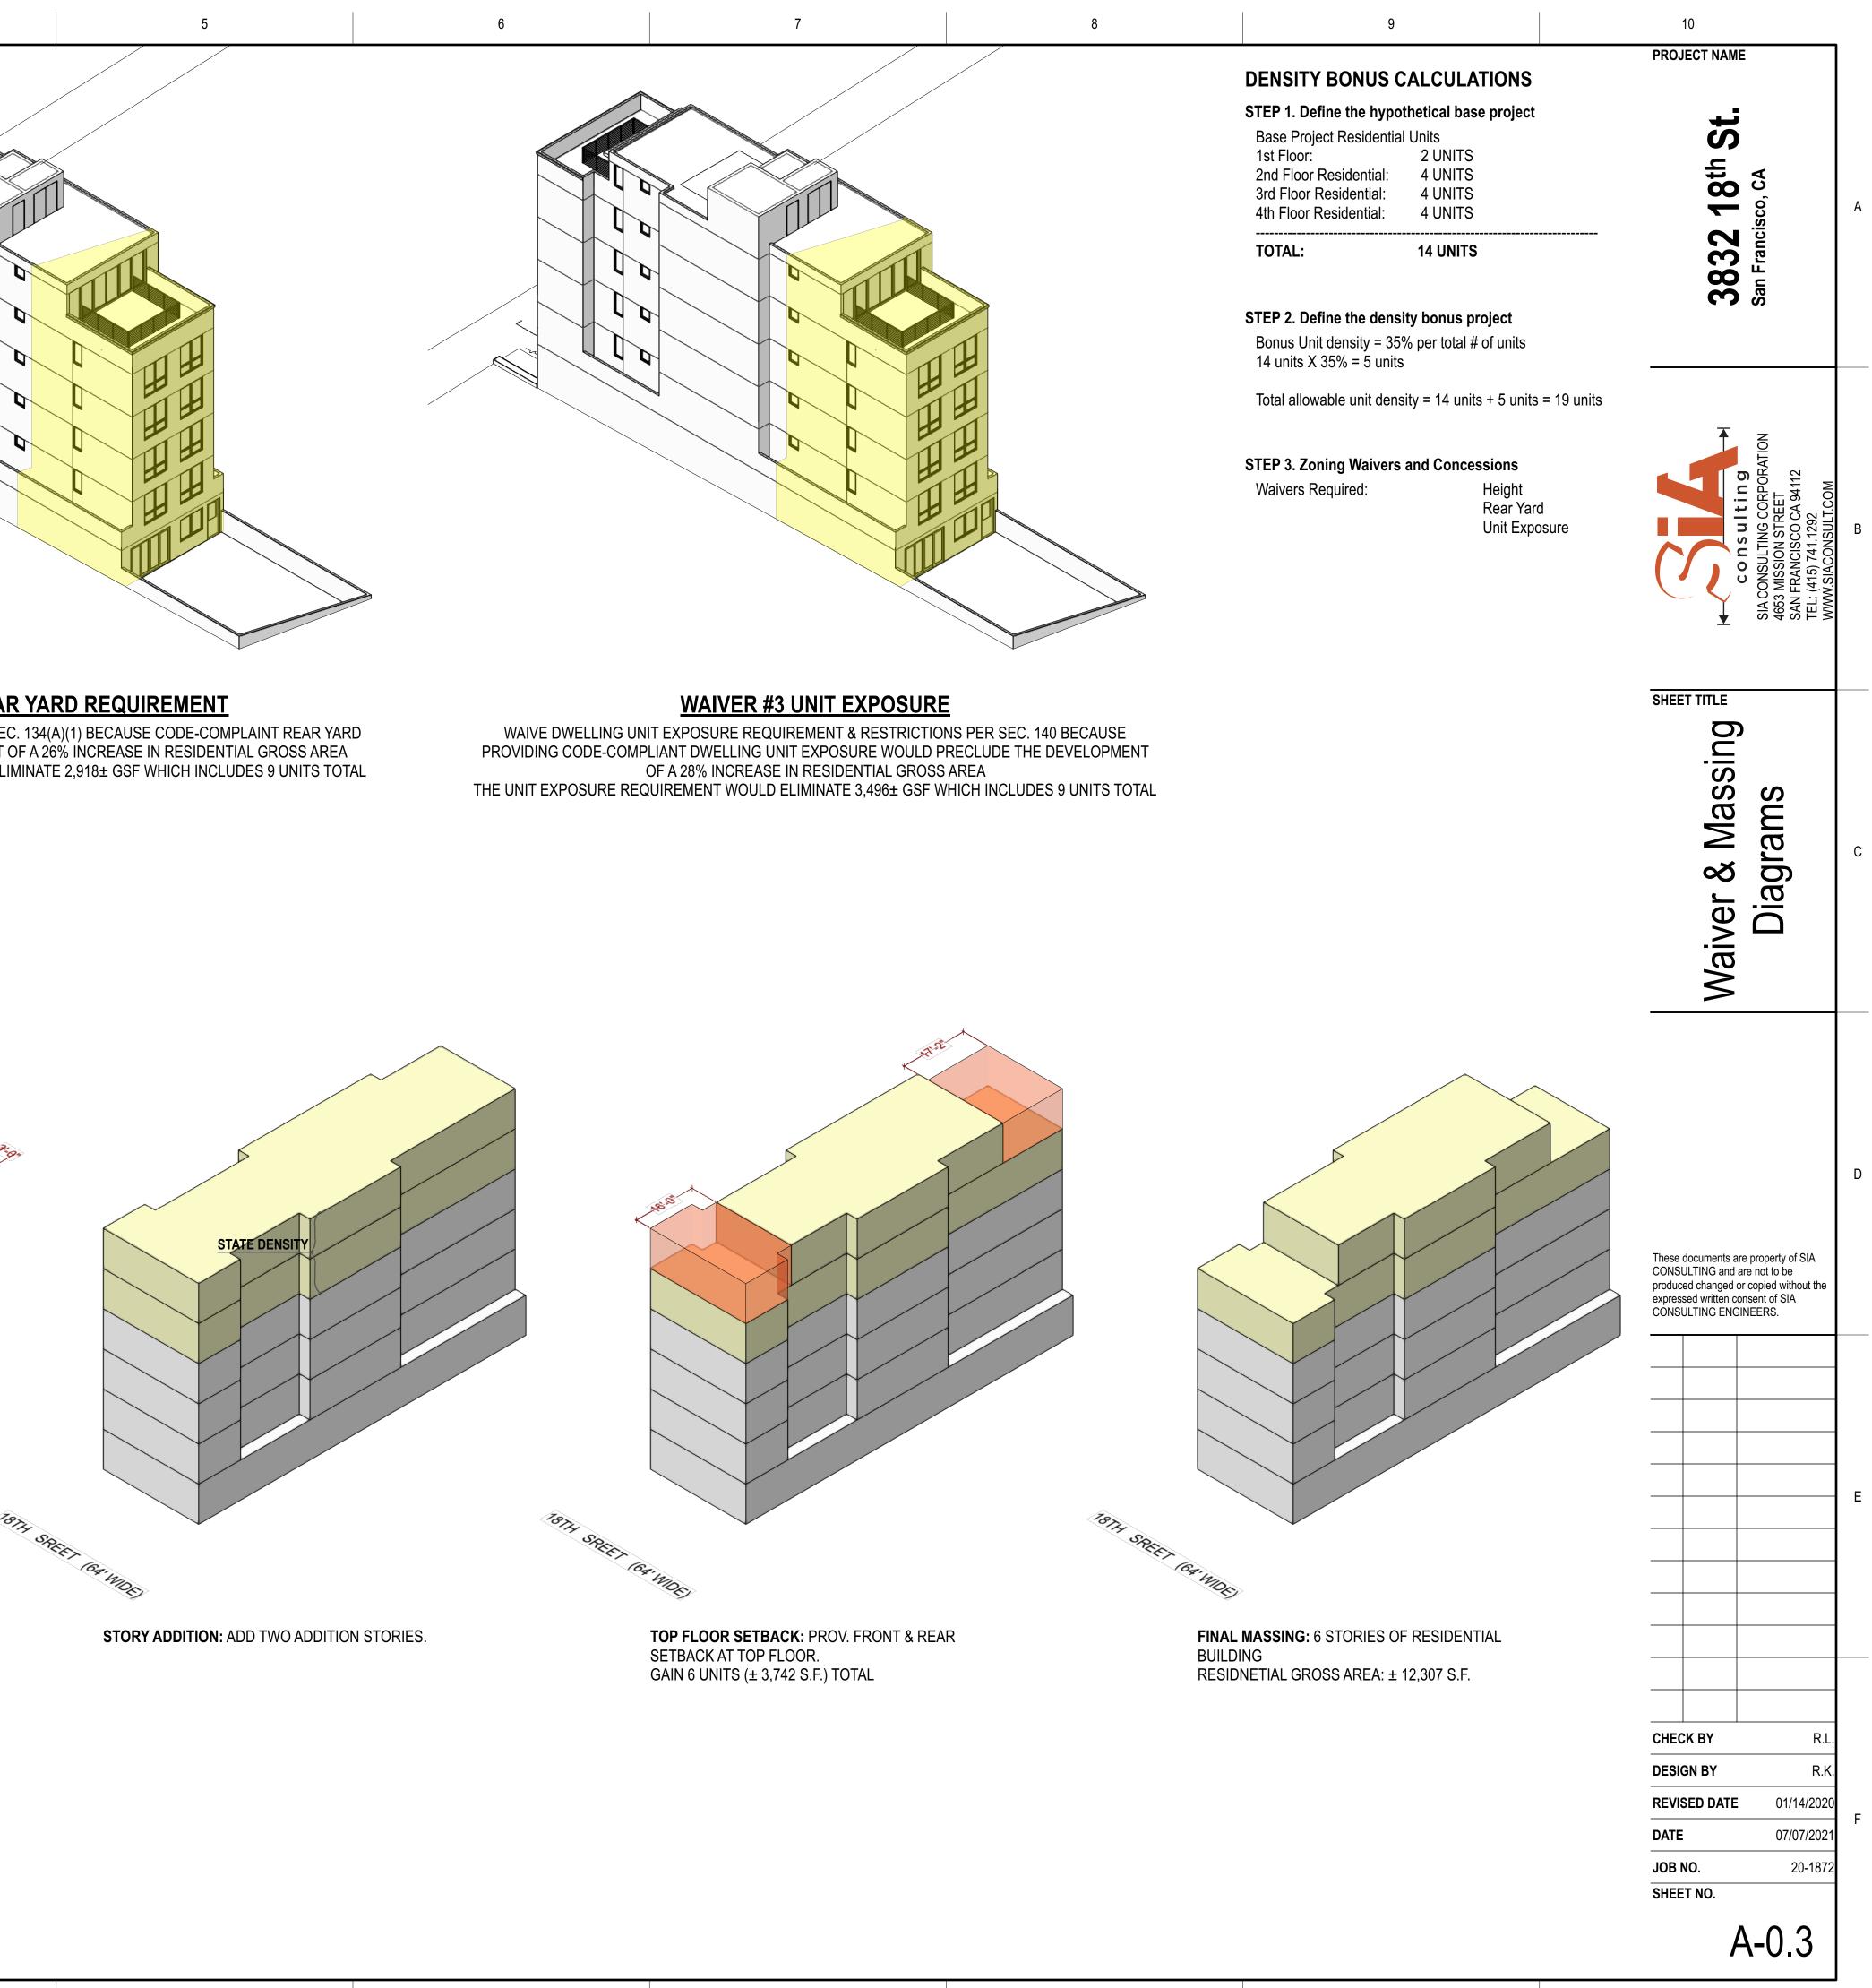


ATT <u>64.35 TBC</u> 64.02 FL 64.50× Catv 64.56 GV WM <u>64.09</u>TBC 63.62 FL <u>APN 3580-016</u> 64.15^{\times} 64.15^{\times} (D.N. 2013-J661975-00) 3824 18TH ST. RF *97.00* PEAK LVL2 BAY-<u>63.34 TBC</u> 63.27 FL 63.65 RF*88.19 ⊁*−−− _____ O × 63.43 63.06 LVL2 BAY (64' WIDE) 63.13 TBC 10 381 S <u>APN 3580-018</u> 63.20[×] (D.N. 2019-K854219-00) 3832 18TH ST. N <u>3872± SQ.FT.</u> 9.5' TO CENTER OF TRUNK Ш RE 62.84 <u>62.64 TBC</u> 62.23 FL [×]62.72 S LVL2 BAY RF*94.46* ///////// HH UWS=80.7' UWS=80.7' GV LWS=76.5' LWS=74.1' $\hat{\mathbf{0}}$ UWS=85.4' 7 LWS=80.7' [×]62.25 *62.14* FL 62.33 WM. PEAK APN 3580-017 ELEV. 104.8' RF106.45 PEAK (D.N. 2019-K854219-00) 3826-3830A 18TH ST. <u>61.61 TBC</u> 61.21 FL 61.71 [×] 61.72

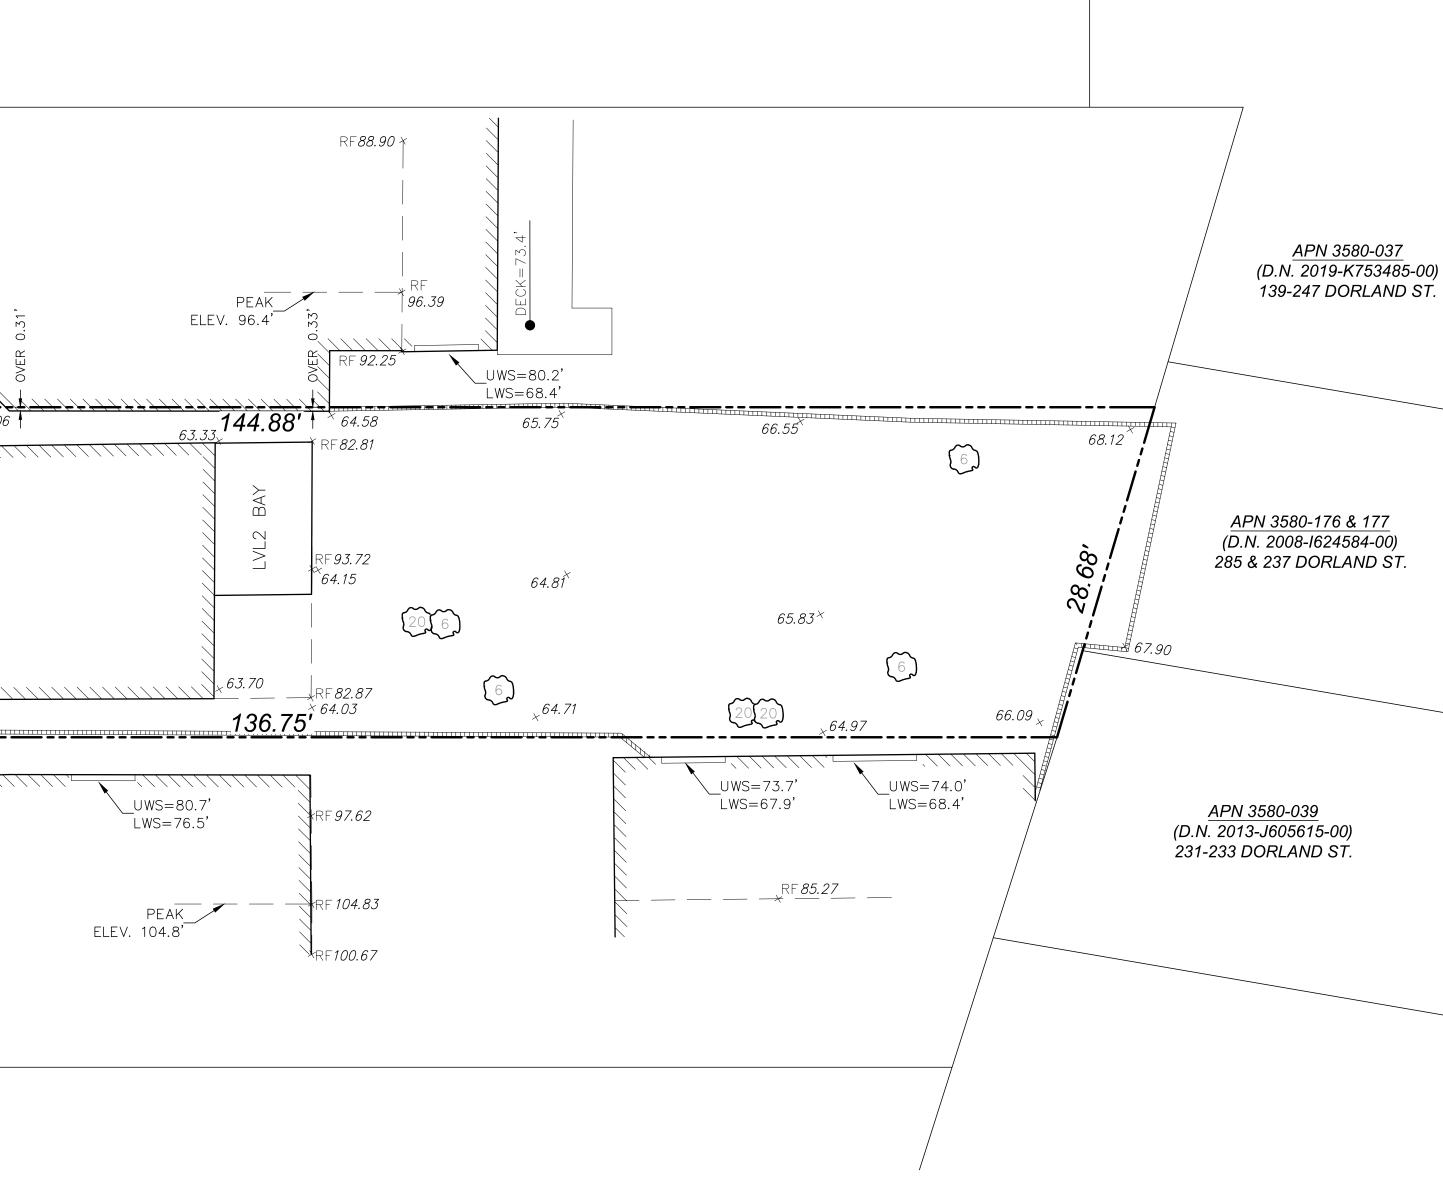

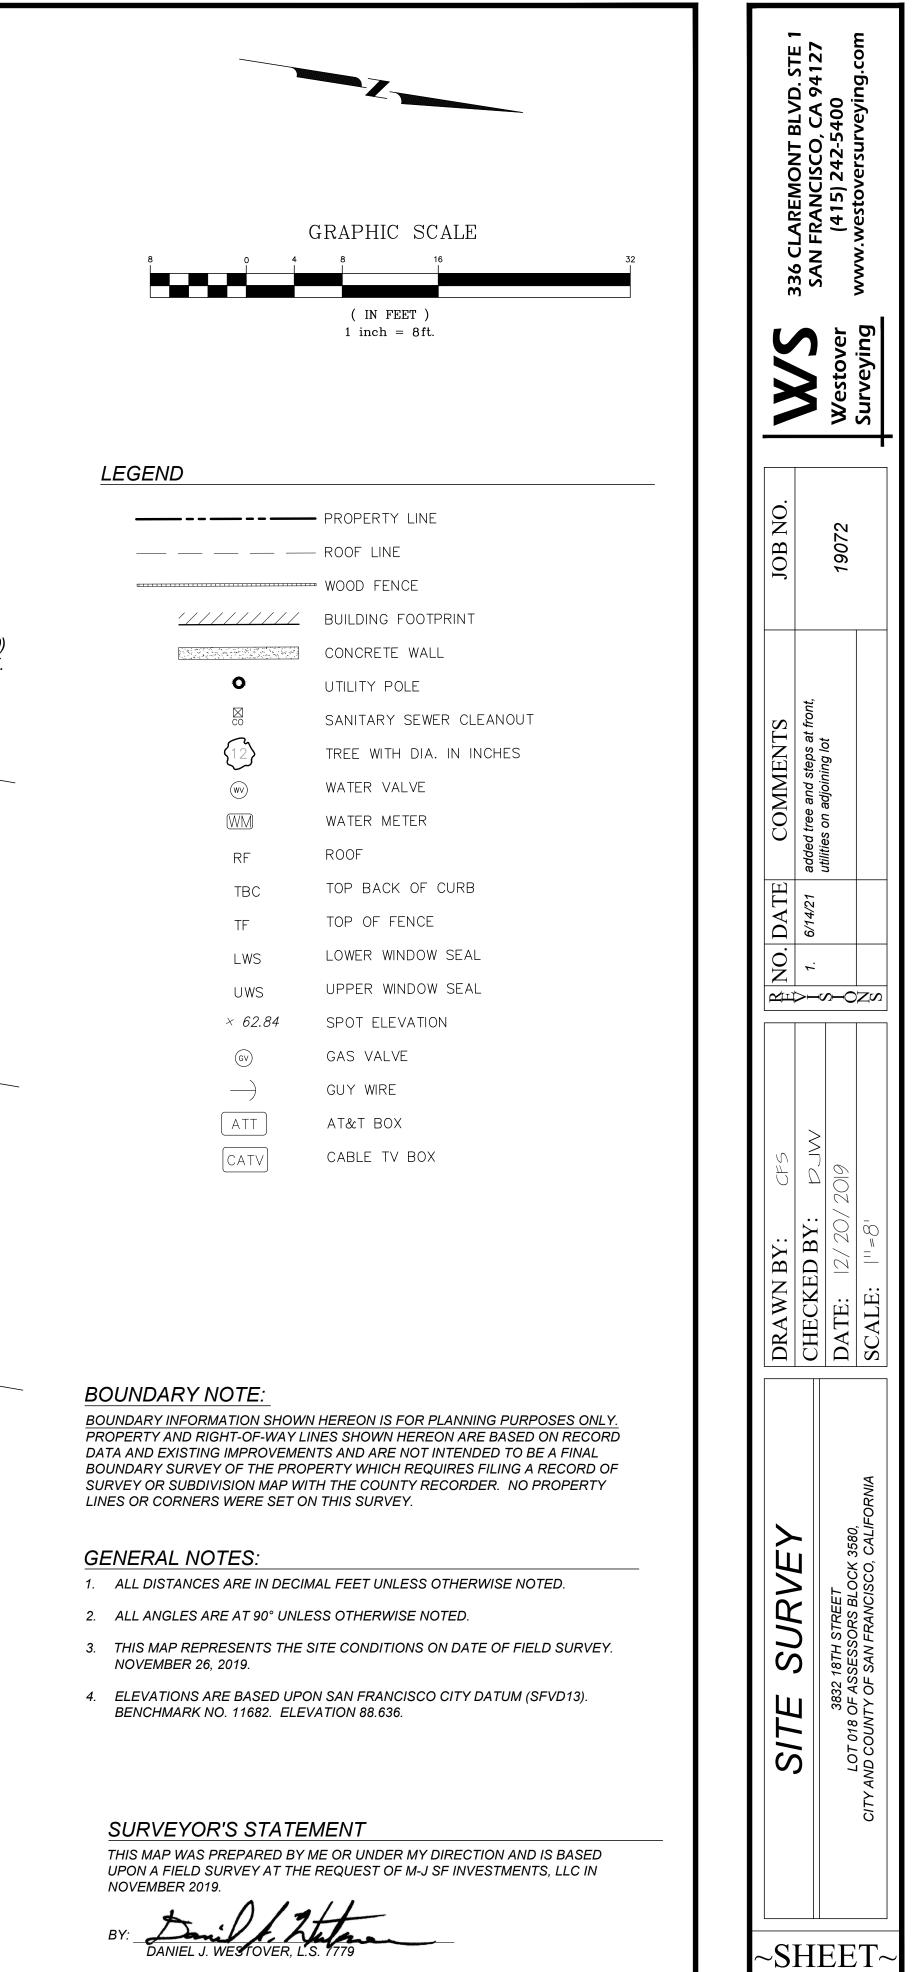


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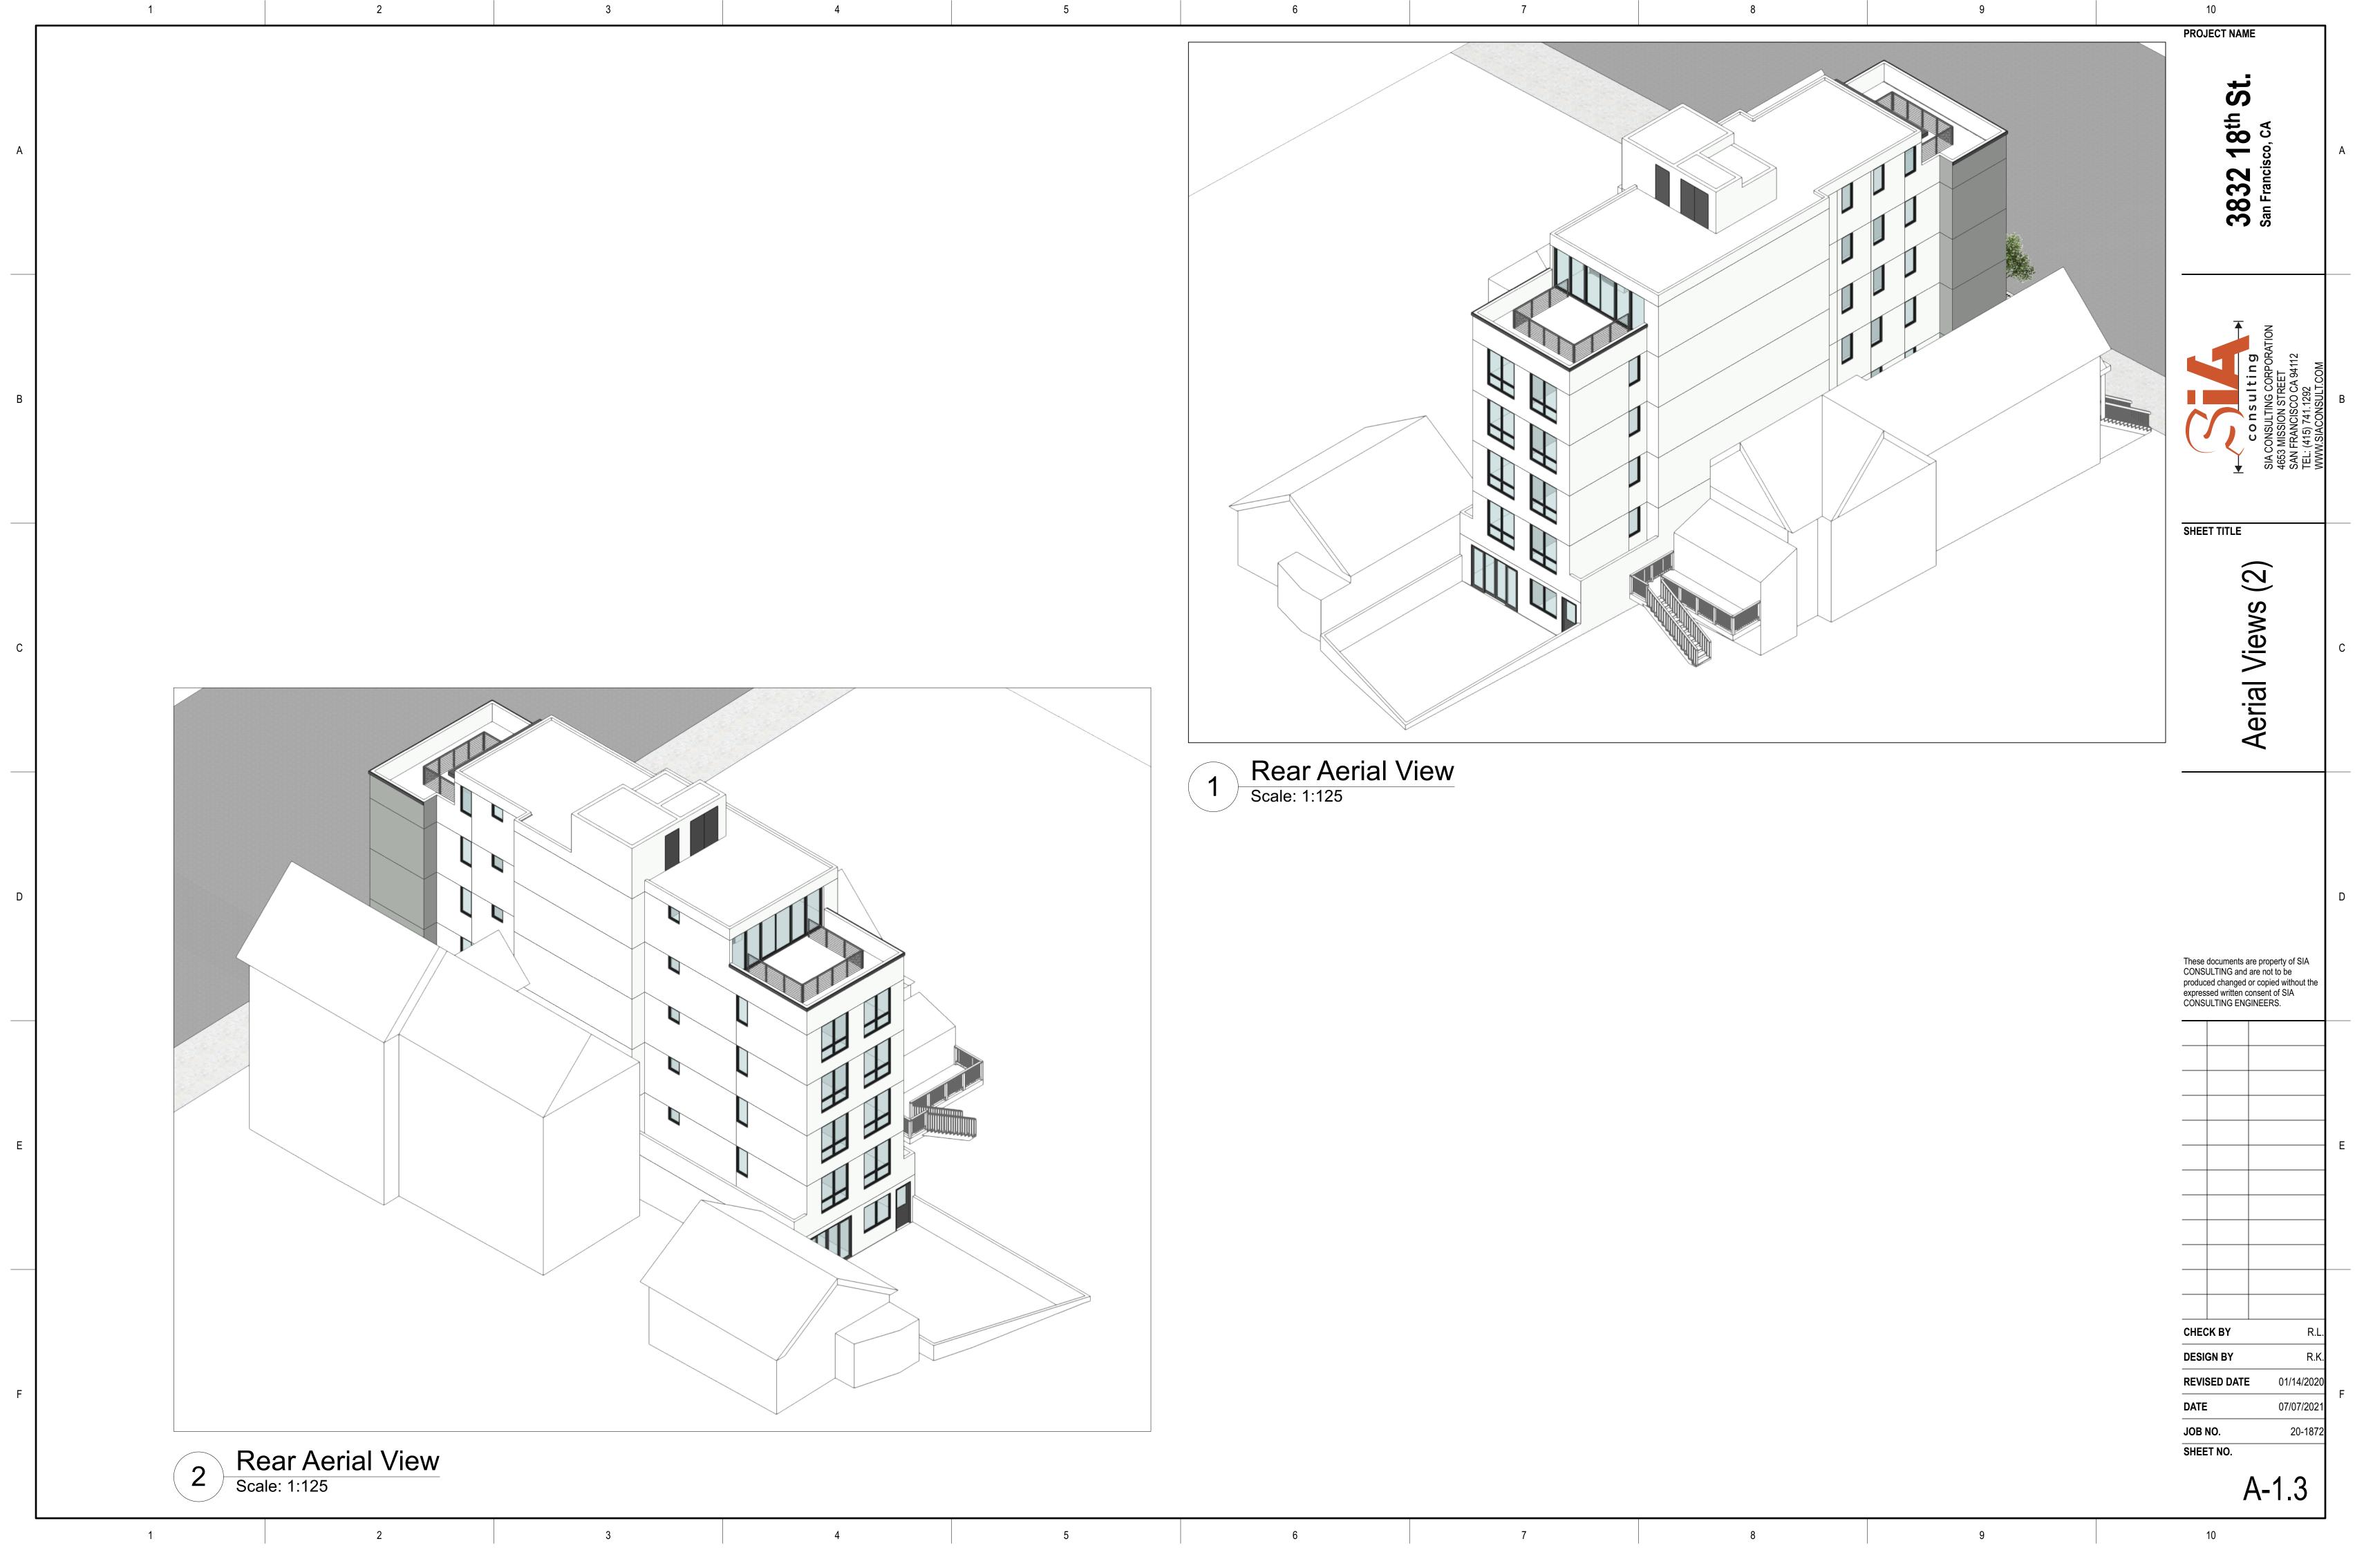
	1	2	3	4
A				
	-			
В				
С				
D				
D				
E				
F				
	1	2	3	4

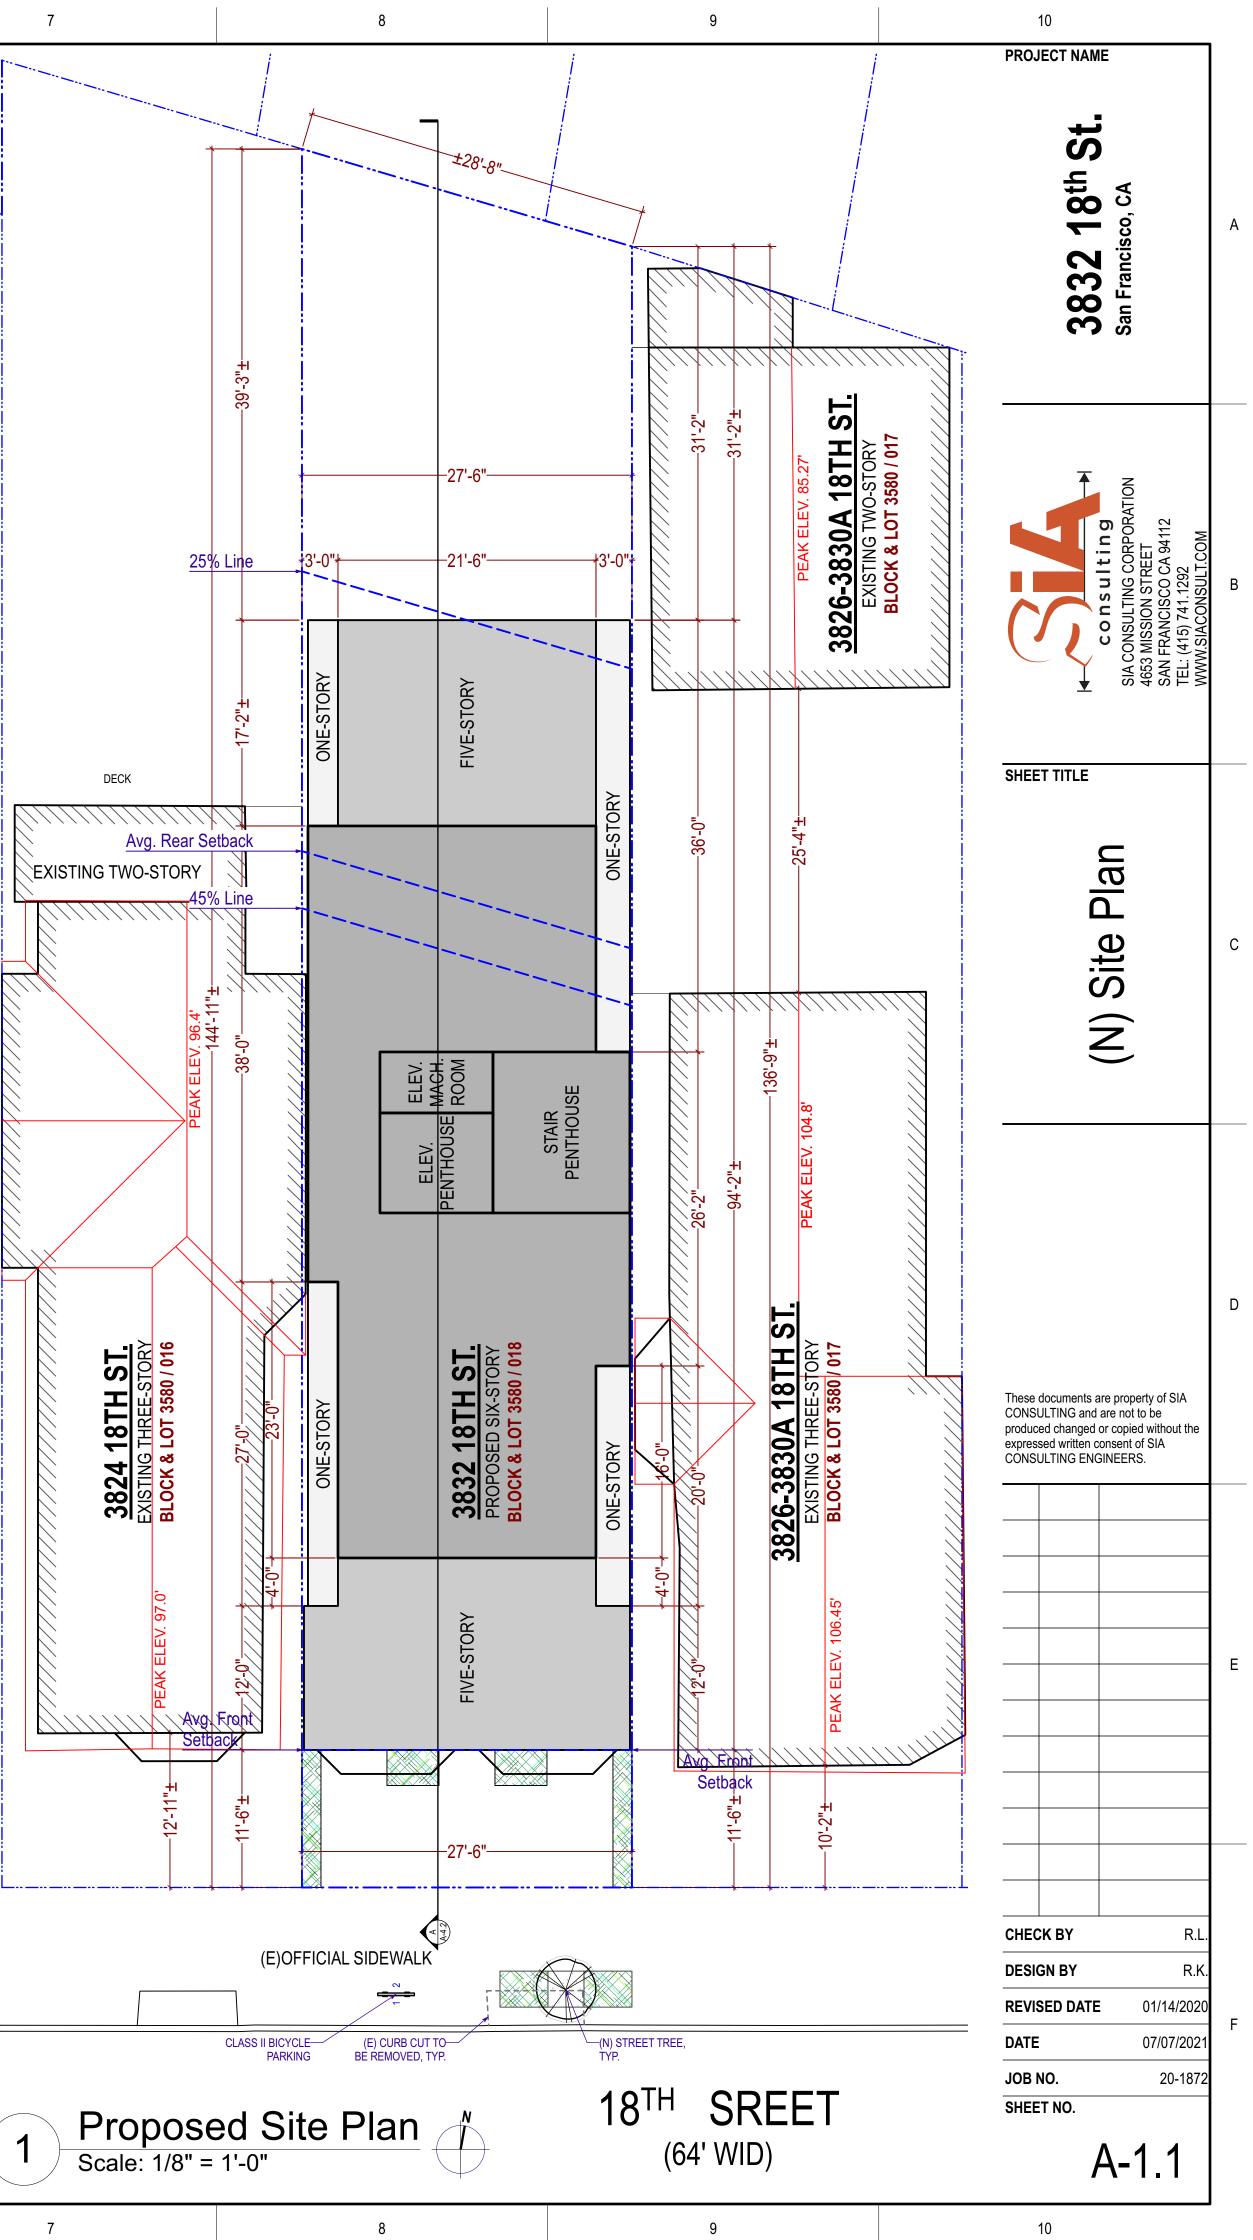

REQ FRONT SETBAC 315 Sq.Ft.	K AREA:
20% LANDSCAPING: 20% of Front Setback Area: Landscaping Prov.	63 S.F. 67 S.F.
50% PERMEABLE: 50% of Front Setback Area: Total Permeable Area Prov.:	158 S.F. 160 S.F.





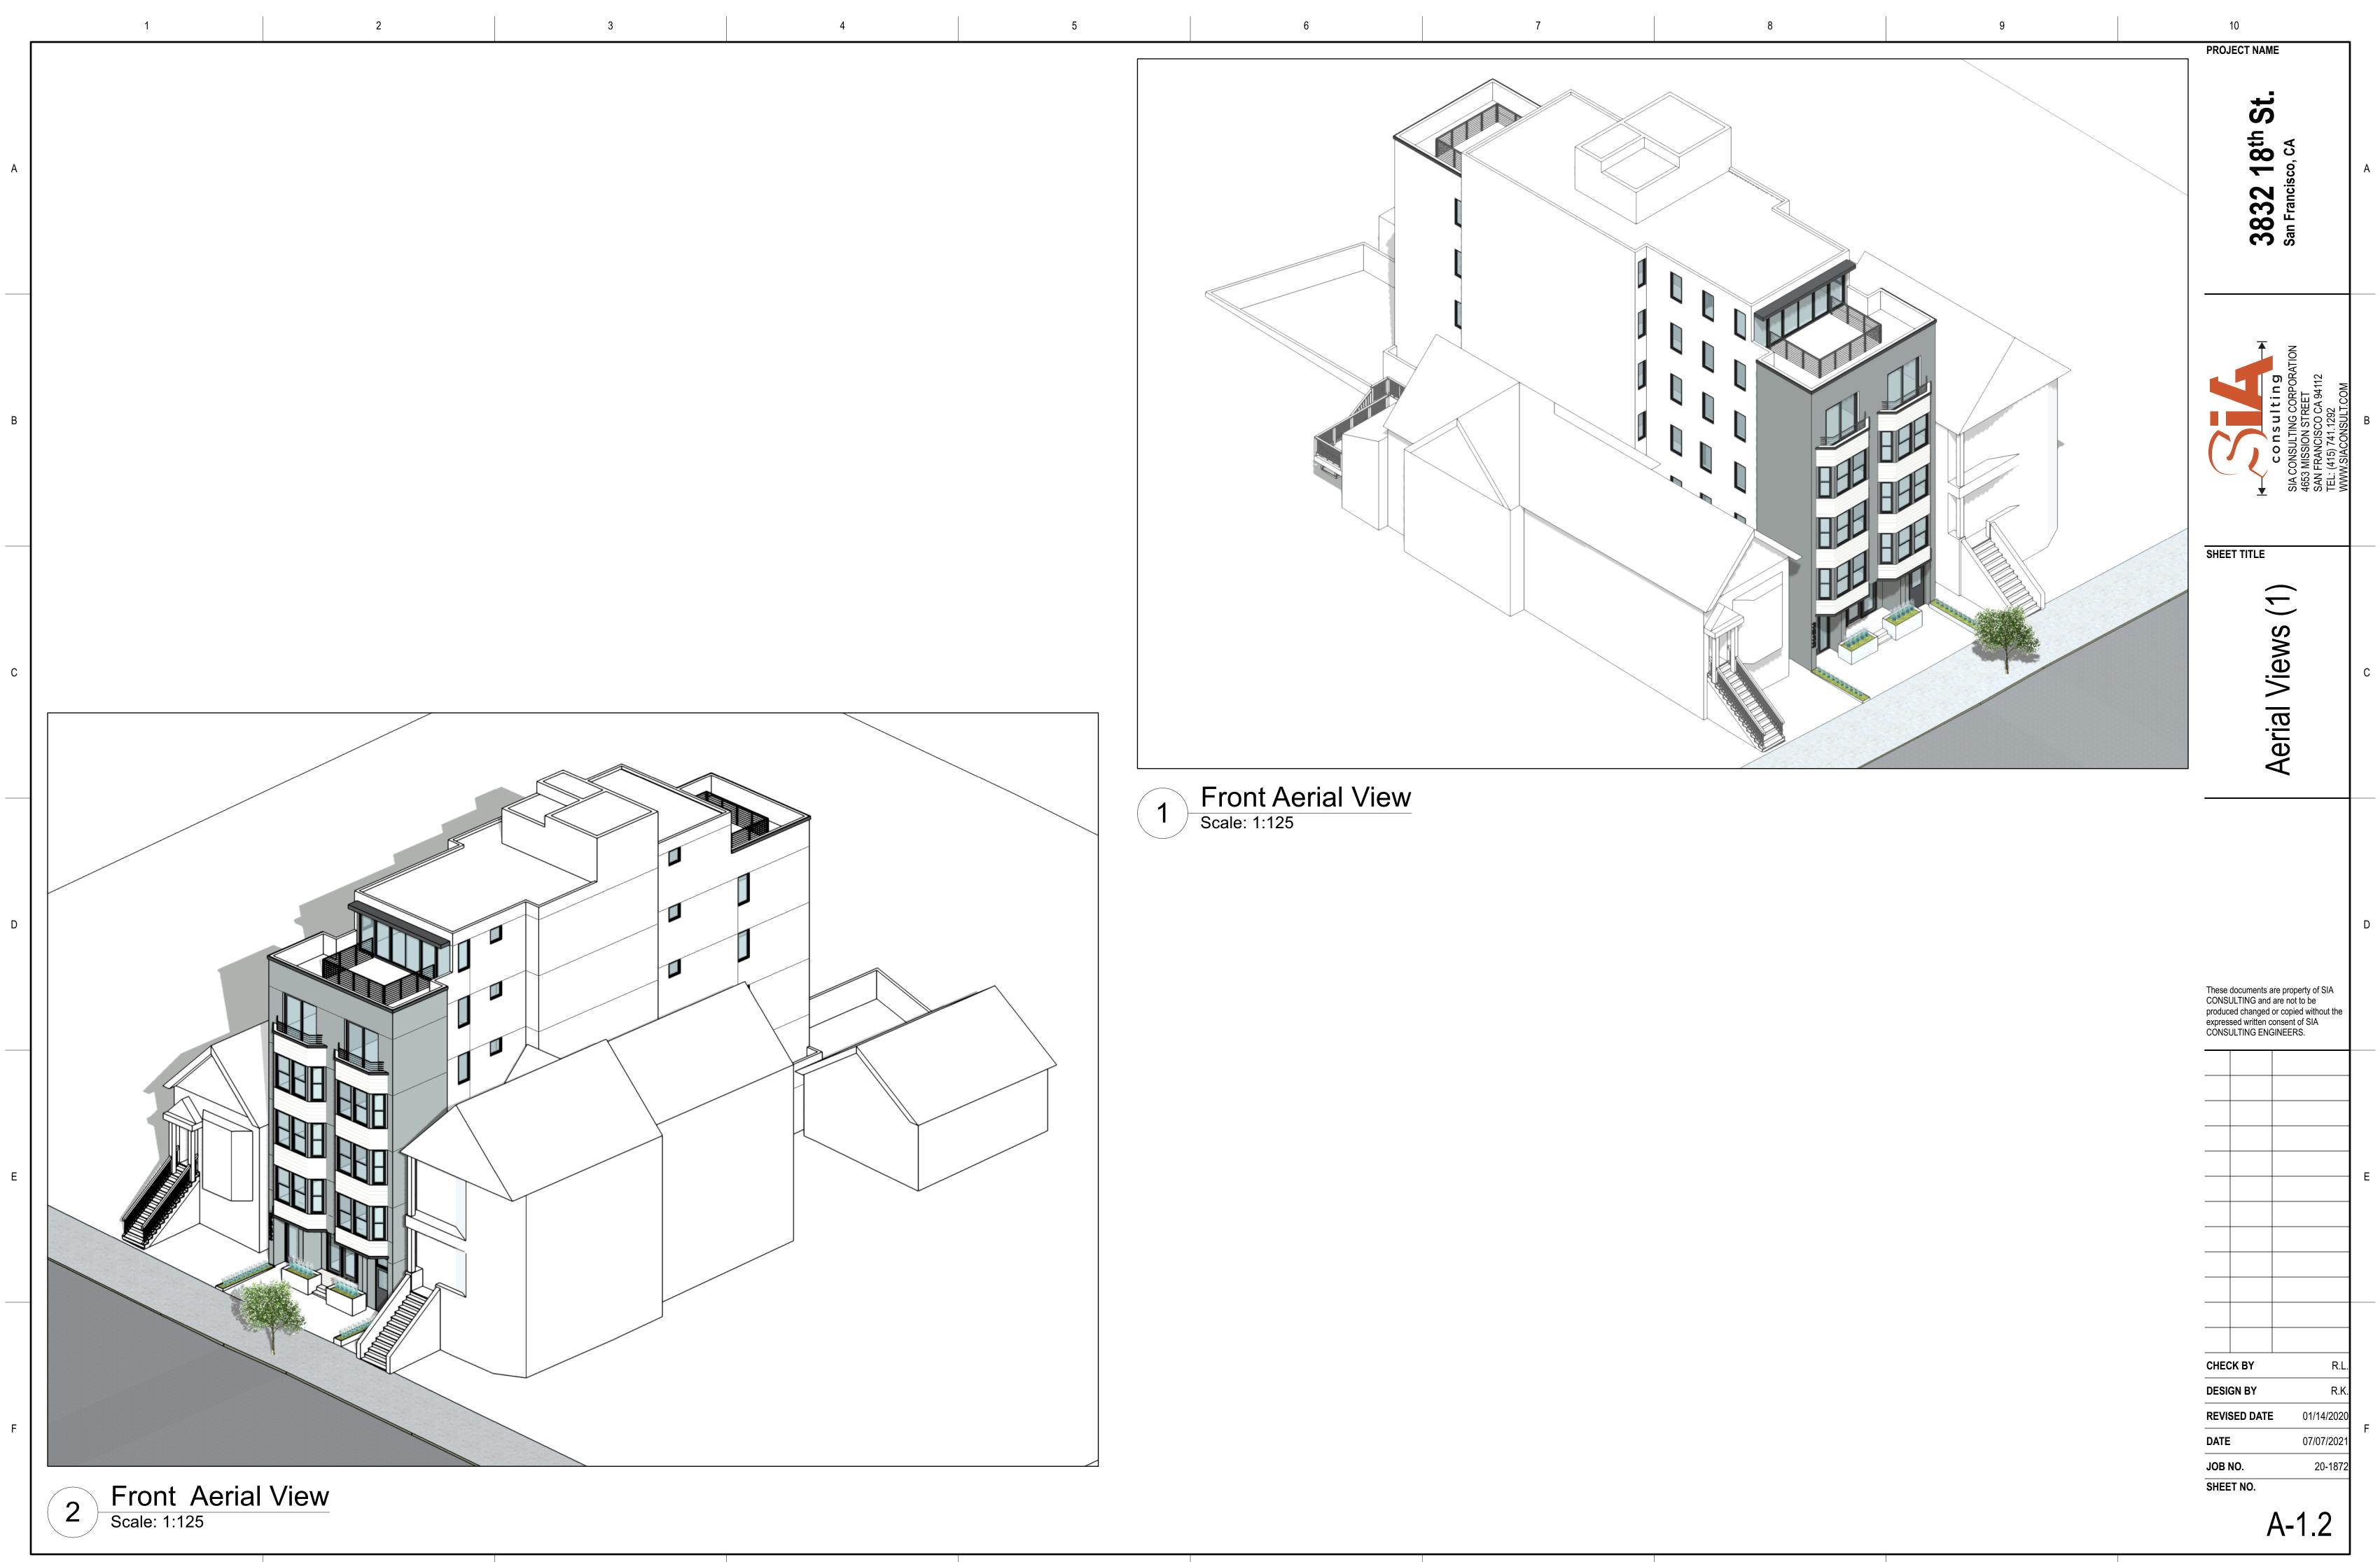



$\begin{pmatrix} 2\\ 2\\ 3 \end{pmatrix}$	90 GPM AT 33 FT. TDH, 100 BELL & GOSSETT E-90 2AE PROVIDE AS PART OF FLC) LBS 3						
ST 1	HOT WATER STORAGE TA ULTONIUM GLASS LINING 175 GAL VERTICAL TANK, WITH 2"THK R-16 TOPCOA NILES STEEL TANK BH-30- PROVIDE AS PART OF FLO	STORA(30" DIA > T INSUL 63	63" HIGH, 1970 LBS ATION					
ET 1	EXPANSION TANK TANK SIZE 22 GALLONS / J TANK TO BE CHARGED IN 16"DIA, 34"H, 300 LBS WESSELS MODEL TTA-42 PROVIDE AS PART OF FLO	THE FIE	LD TO 40 PSIG.	D PACKAGE				
		I	BOILER SCH	IEDULE				
UNIT	MANUFACTURER	NO.	SERVICE	HEATIN	G BTUH	ELEC	TRICAL DATA	OPER. WT.
NO.	& MODEL NO.	OF	SERVICE	INPUT	OUTPUT	HP/W	VOLTAGE	(LBS.)
B 1 2	LAARS NEOTHERM NTV 750	2	HOT WATER	750,000	705,000	1	120V/1PH	475

3

2

TAG.

 $\left\langle \begin{array}{c} CP \\ 1 \end{array} \right\rangle$

/ср`

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DOMESTIC HOT WATER CIRCULATION PUMP

IN-LINE PUMP, 120V/1 PH, 125W 5 GPM AT 15 FT. TDH, 15 LBS

SPACE HEATING HOT WATER PUMP

BELL & GOSSETT NBF-25

DESCRIPTION

PUMP & TANK SCHEDULE

PROVIDE AS PART OF FLOWTHERM UL LISTED FTDW SKID PACKAGE


IN-LINE PUMP, 208V/3 PH, 1.5 HP, ALL BRONZE CONSTRUCTION











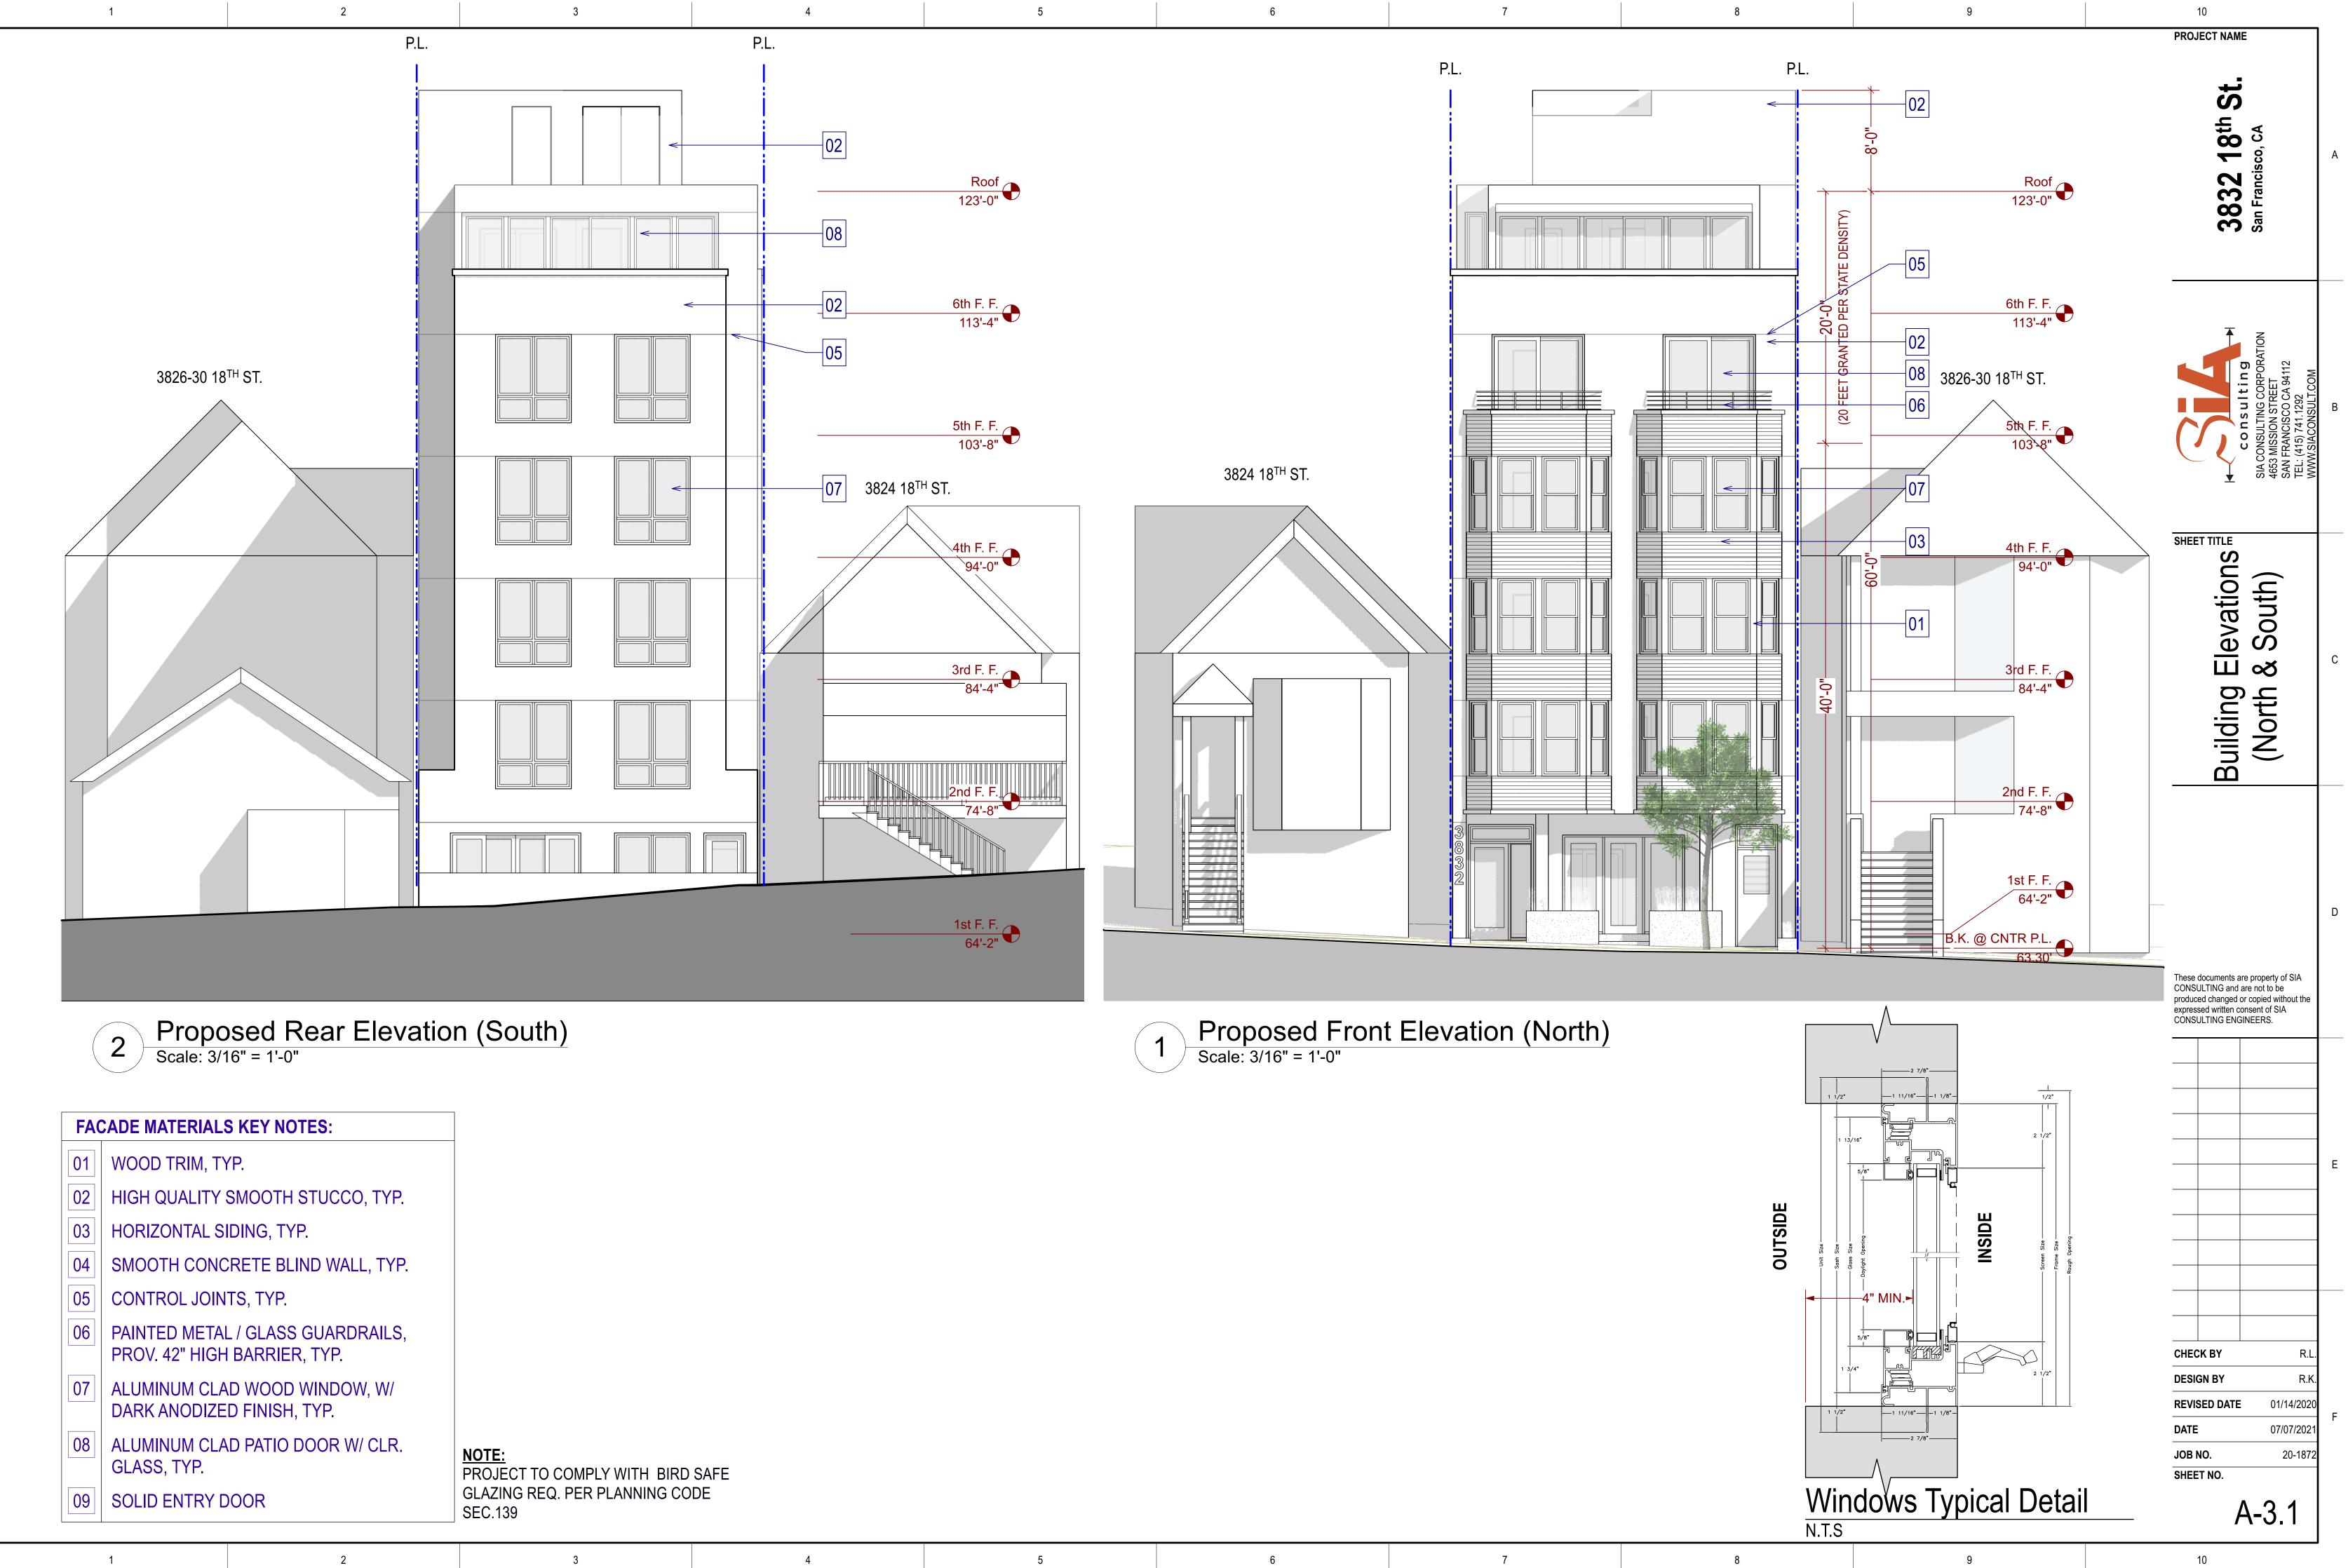

FAC	CADE MATERIALS KEY NOTES:	
01	WOOD TRIM, TYP.	
02	HIGH QUALITY SMOOTH STUCCO, TYP.	
03	HORIZONTAL SIDING, TYP.	
04	SMOOTH CONCRETE BLIND WALL, TYP.	
05	CONTROL JOINTS, TYP.	
06	PAINTED METAL / GLASS GUARDRAILS, PROV. 42" HIGH BARRIER, TYP.	
07	ALUMINUM CLAD WOOD WINDOW, W/ DARK ANODIZED FINISH, TYP.	
08	ALUMINUM CLAD PATIO DOOR W/ CLR. GLASS, TYP.	<u>NOTE:</u> PROJECT T
09	SOLID ENTRY DOOR	GLAZING RE SEC.139

D

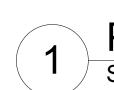

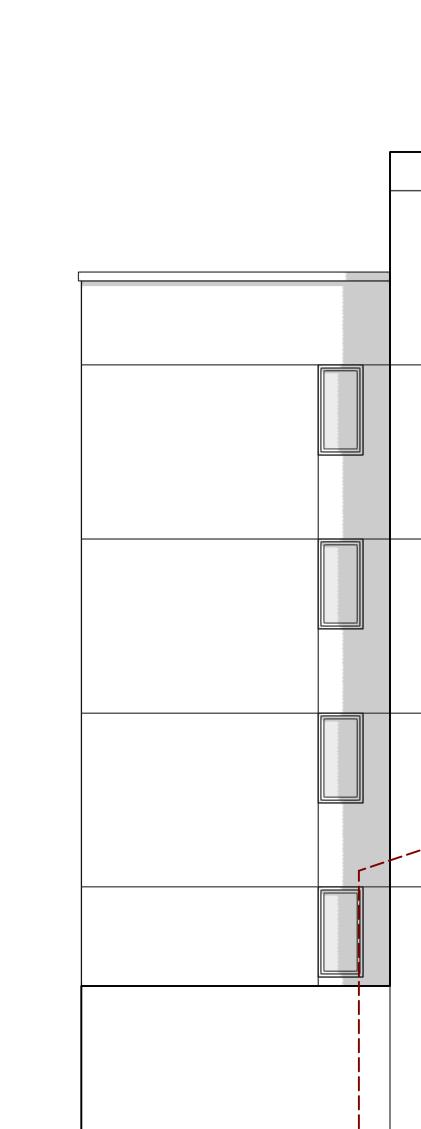

1	Proposed Left
	Scale: 3/16" = 1'-0"

FAC	CADE MATERIALS KEY NOTES:
01	WOOD TRIM, TYP.
02	HIGH QUALITY SMOOTH STUCCO, TYP.
03	HORIZONTAL SIDING, TYP.
04	SMOOTH CONCRETE BLIND WALL, TYP.
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08	ALUMINUM CLAD PATIO DOOR W/ CLR. GLASS, TYP.
09	SOLID ENTRY DOOR


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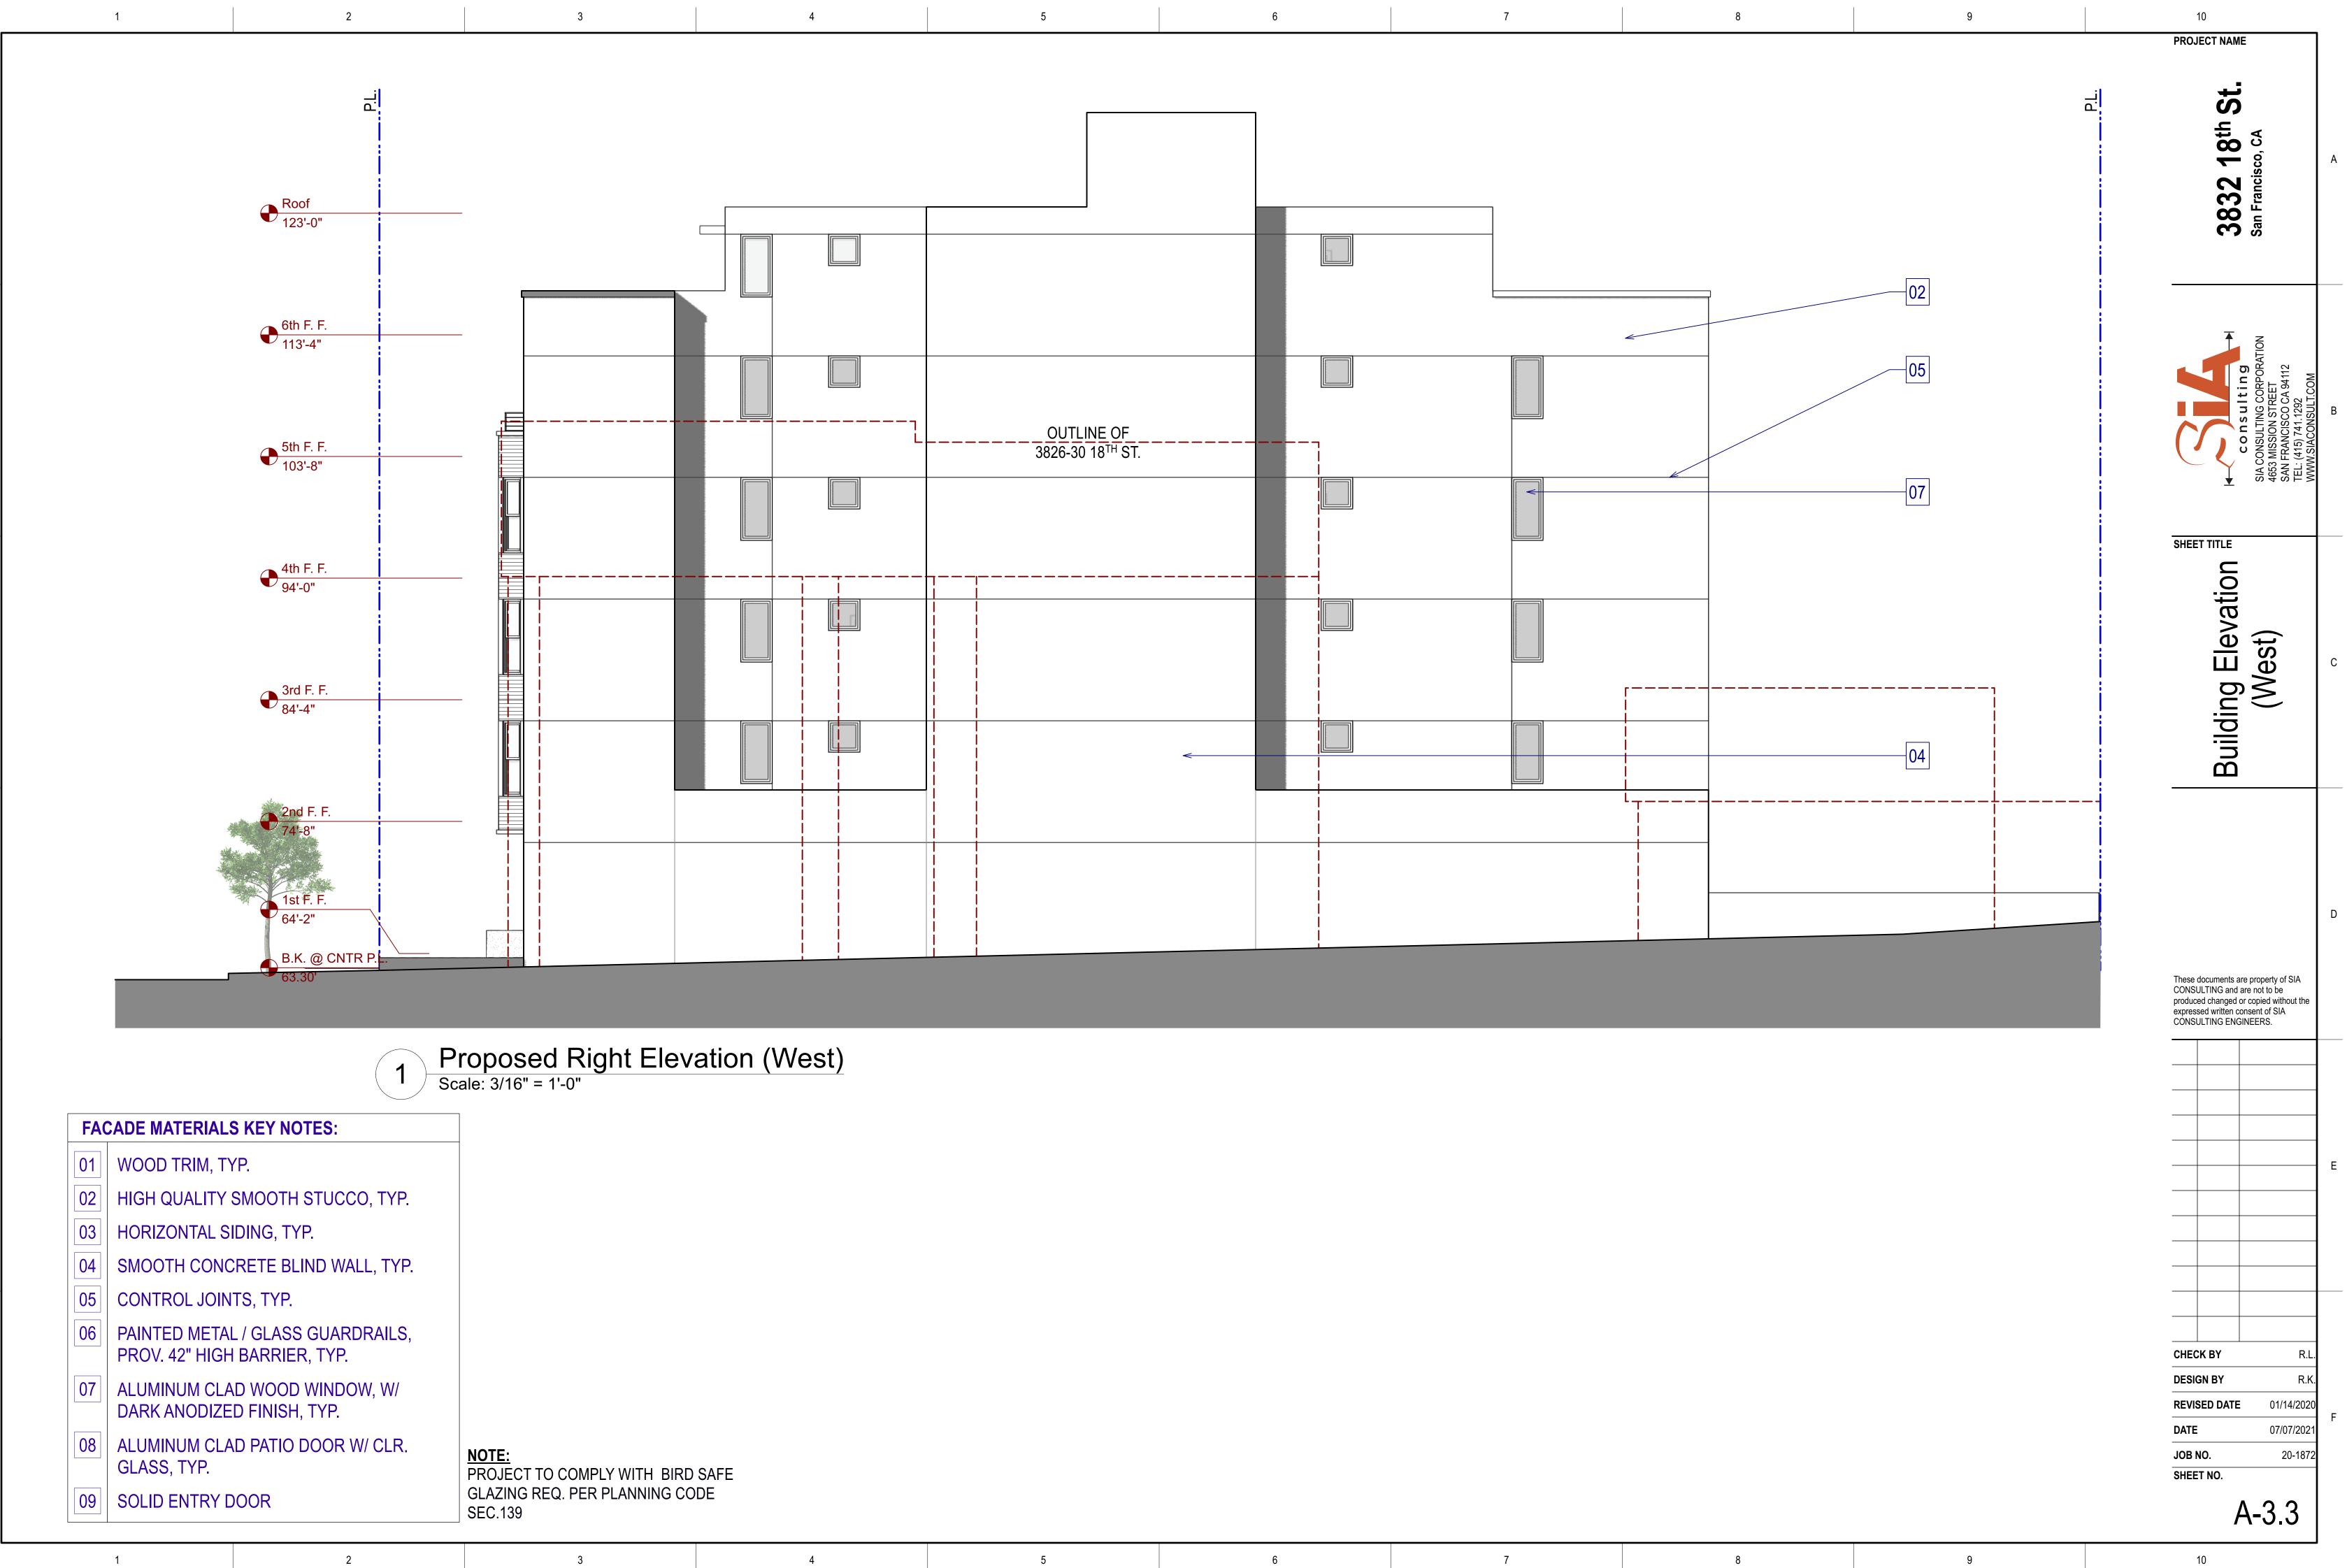
NOTE: PROJECT TO COMPLY WITH BIRD SAFE GLAZING REQ. PER PLANNING CODE SEC.139

3

D


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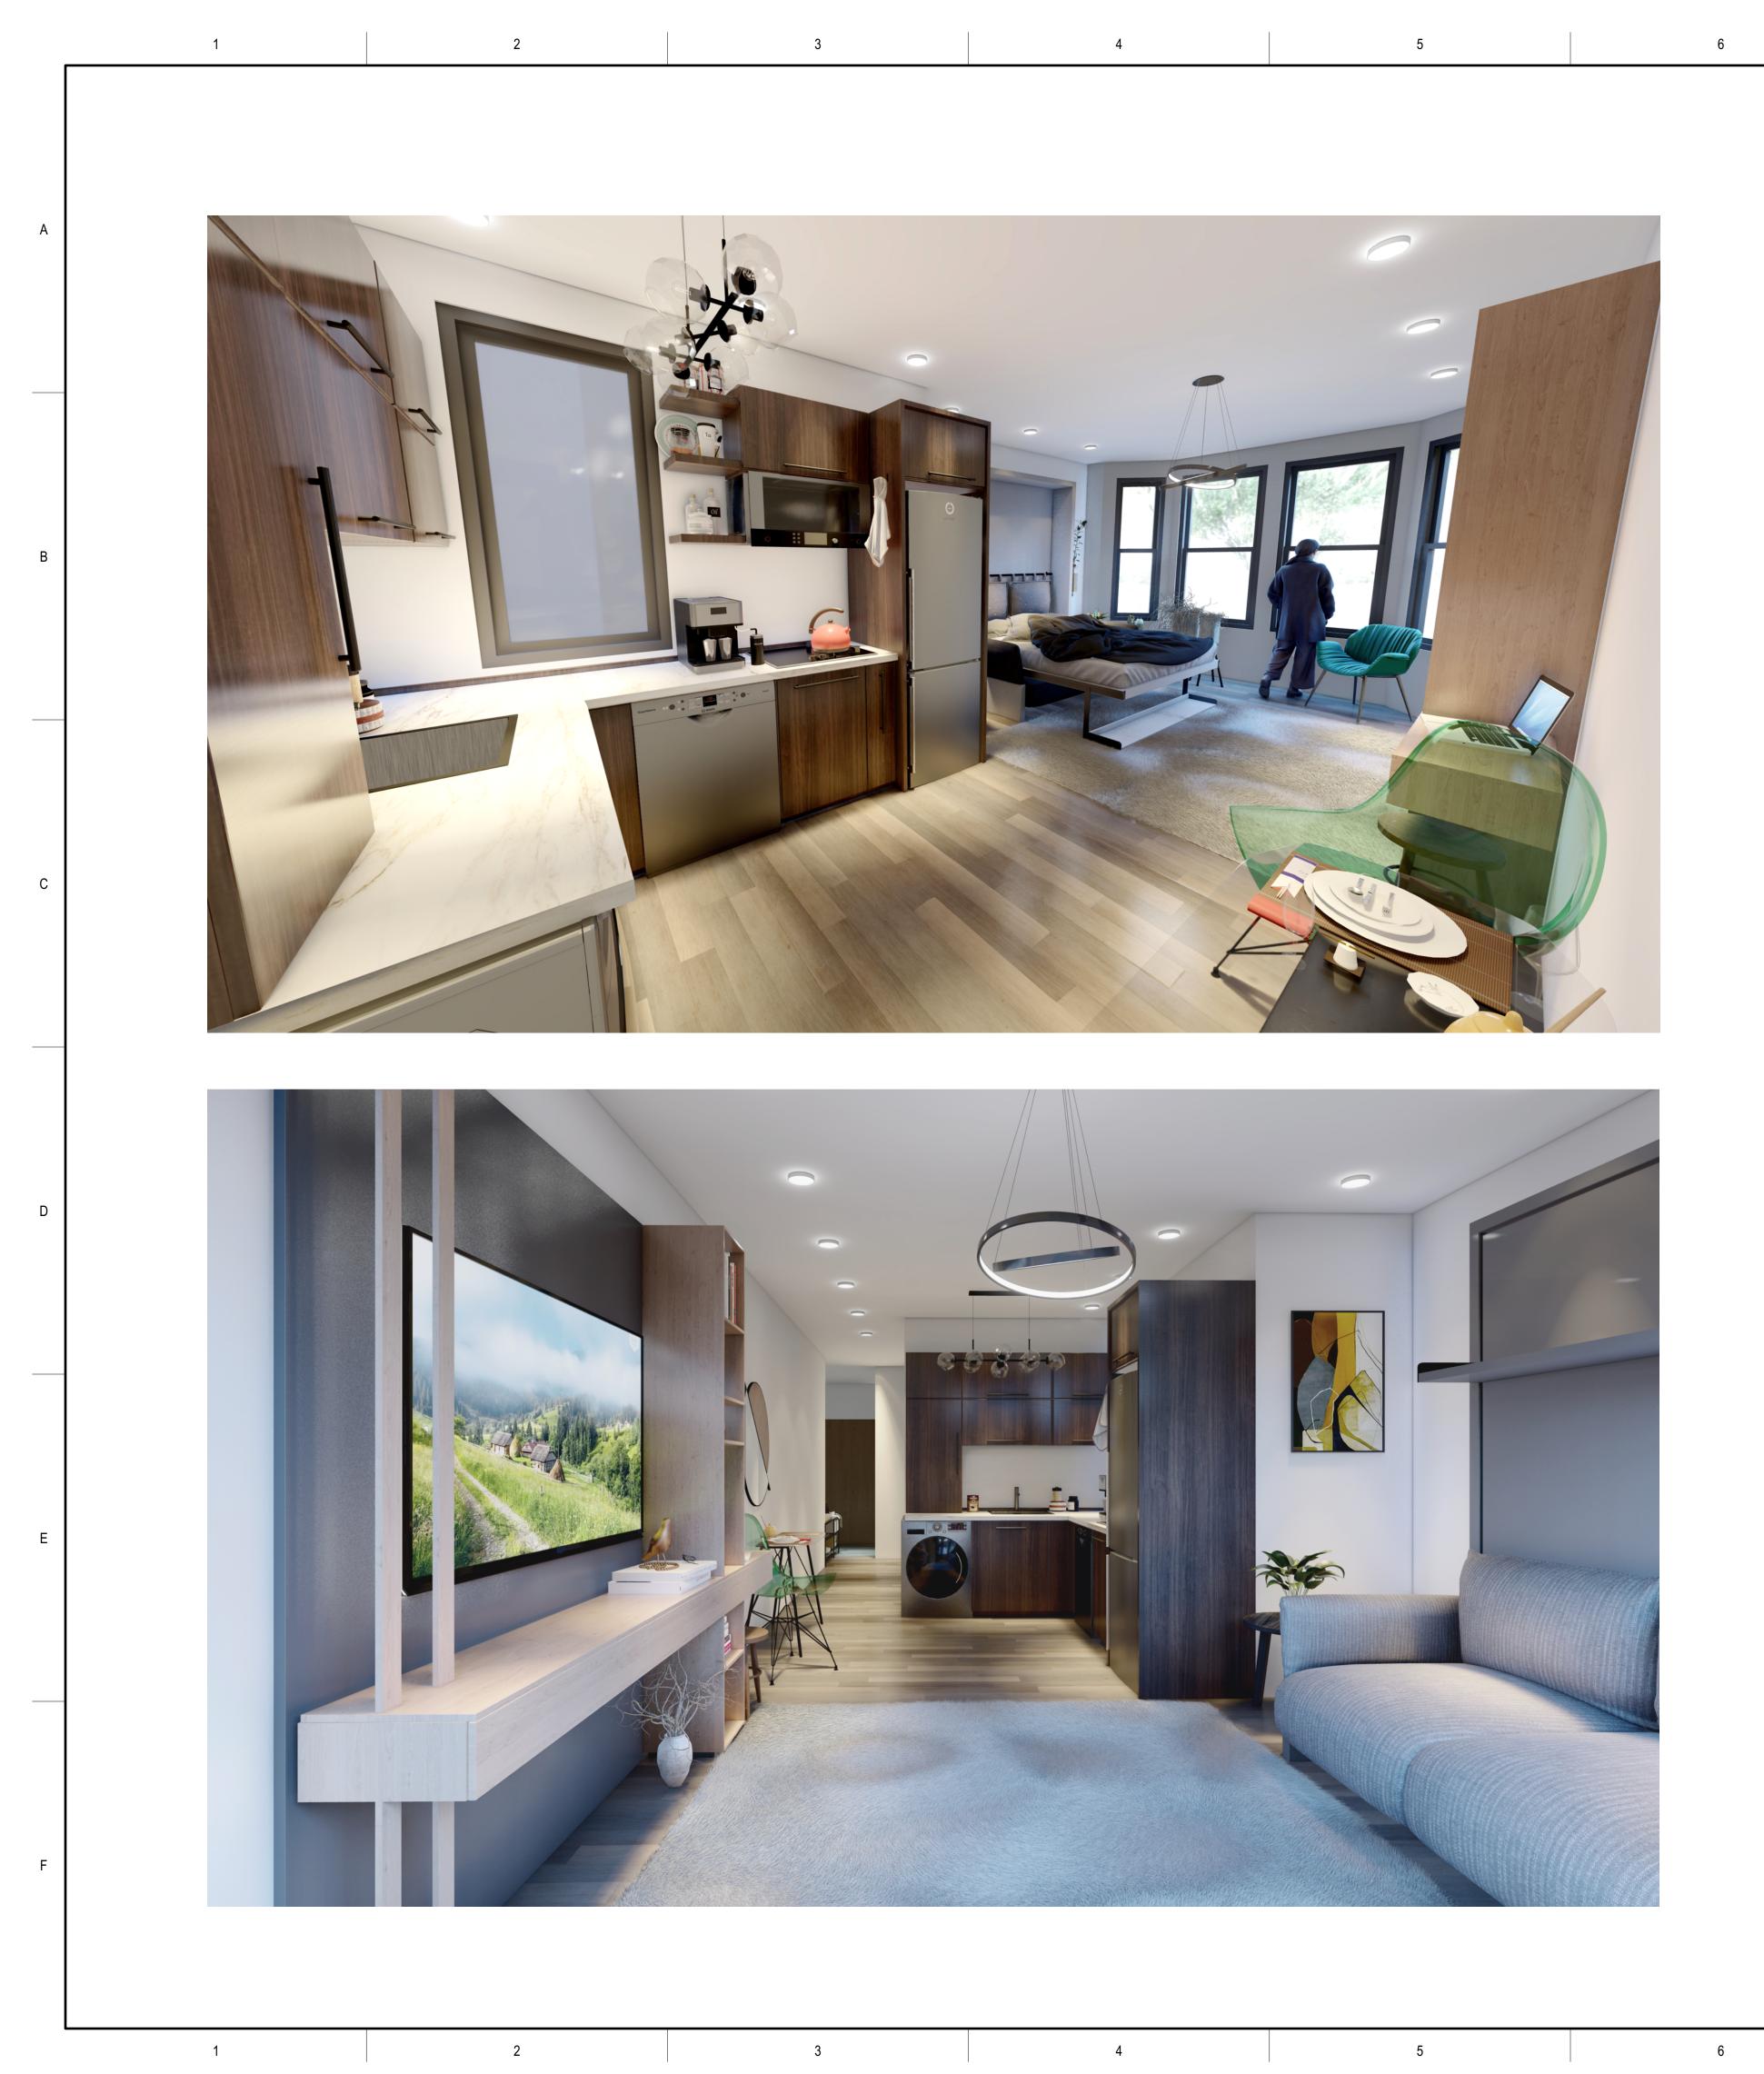


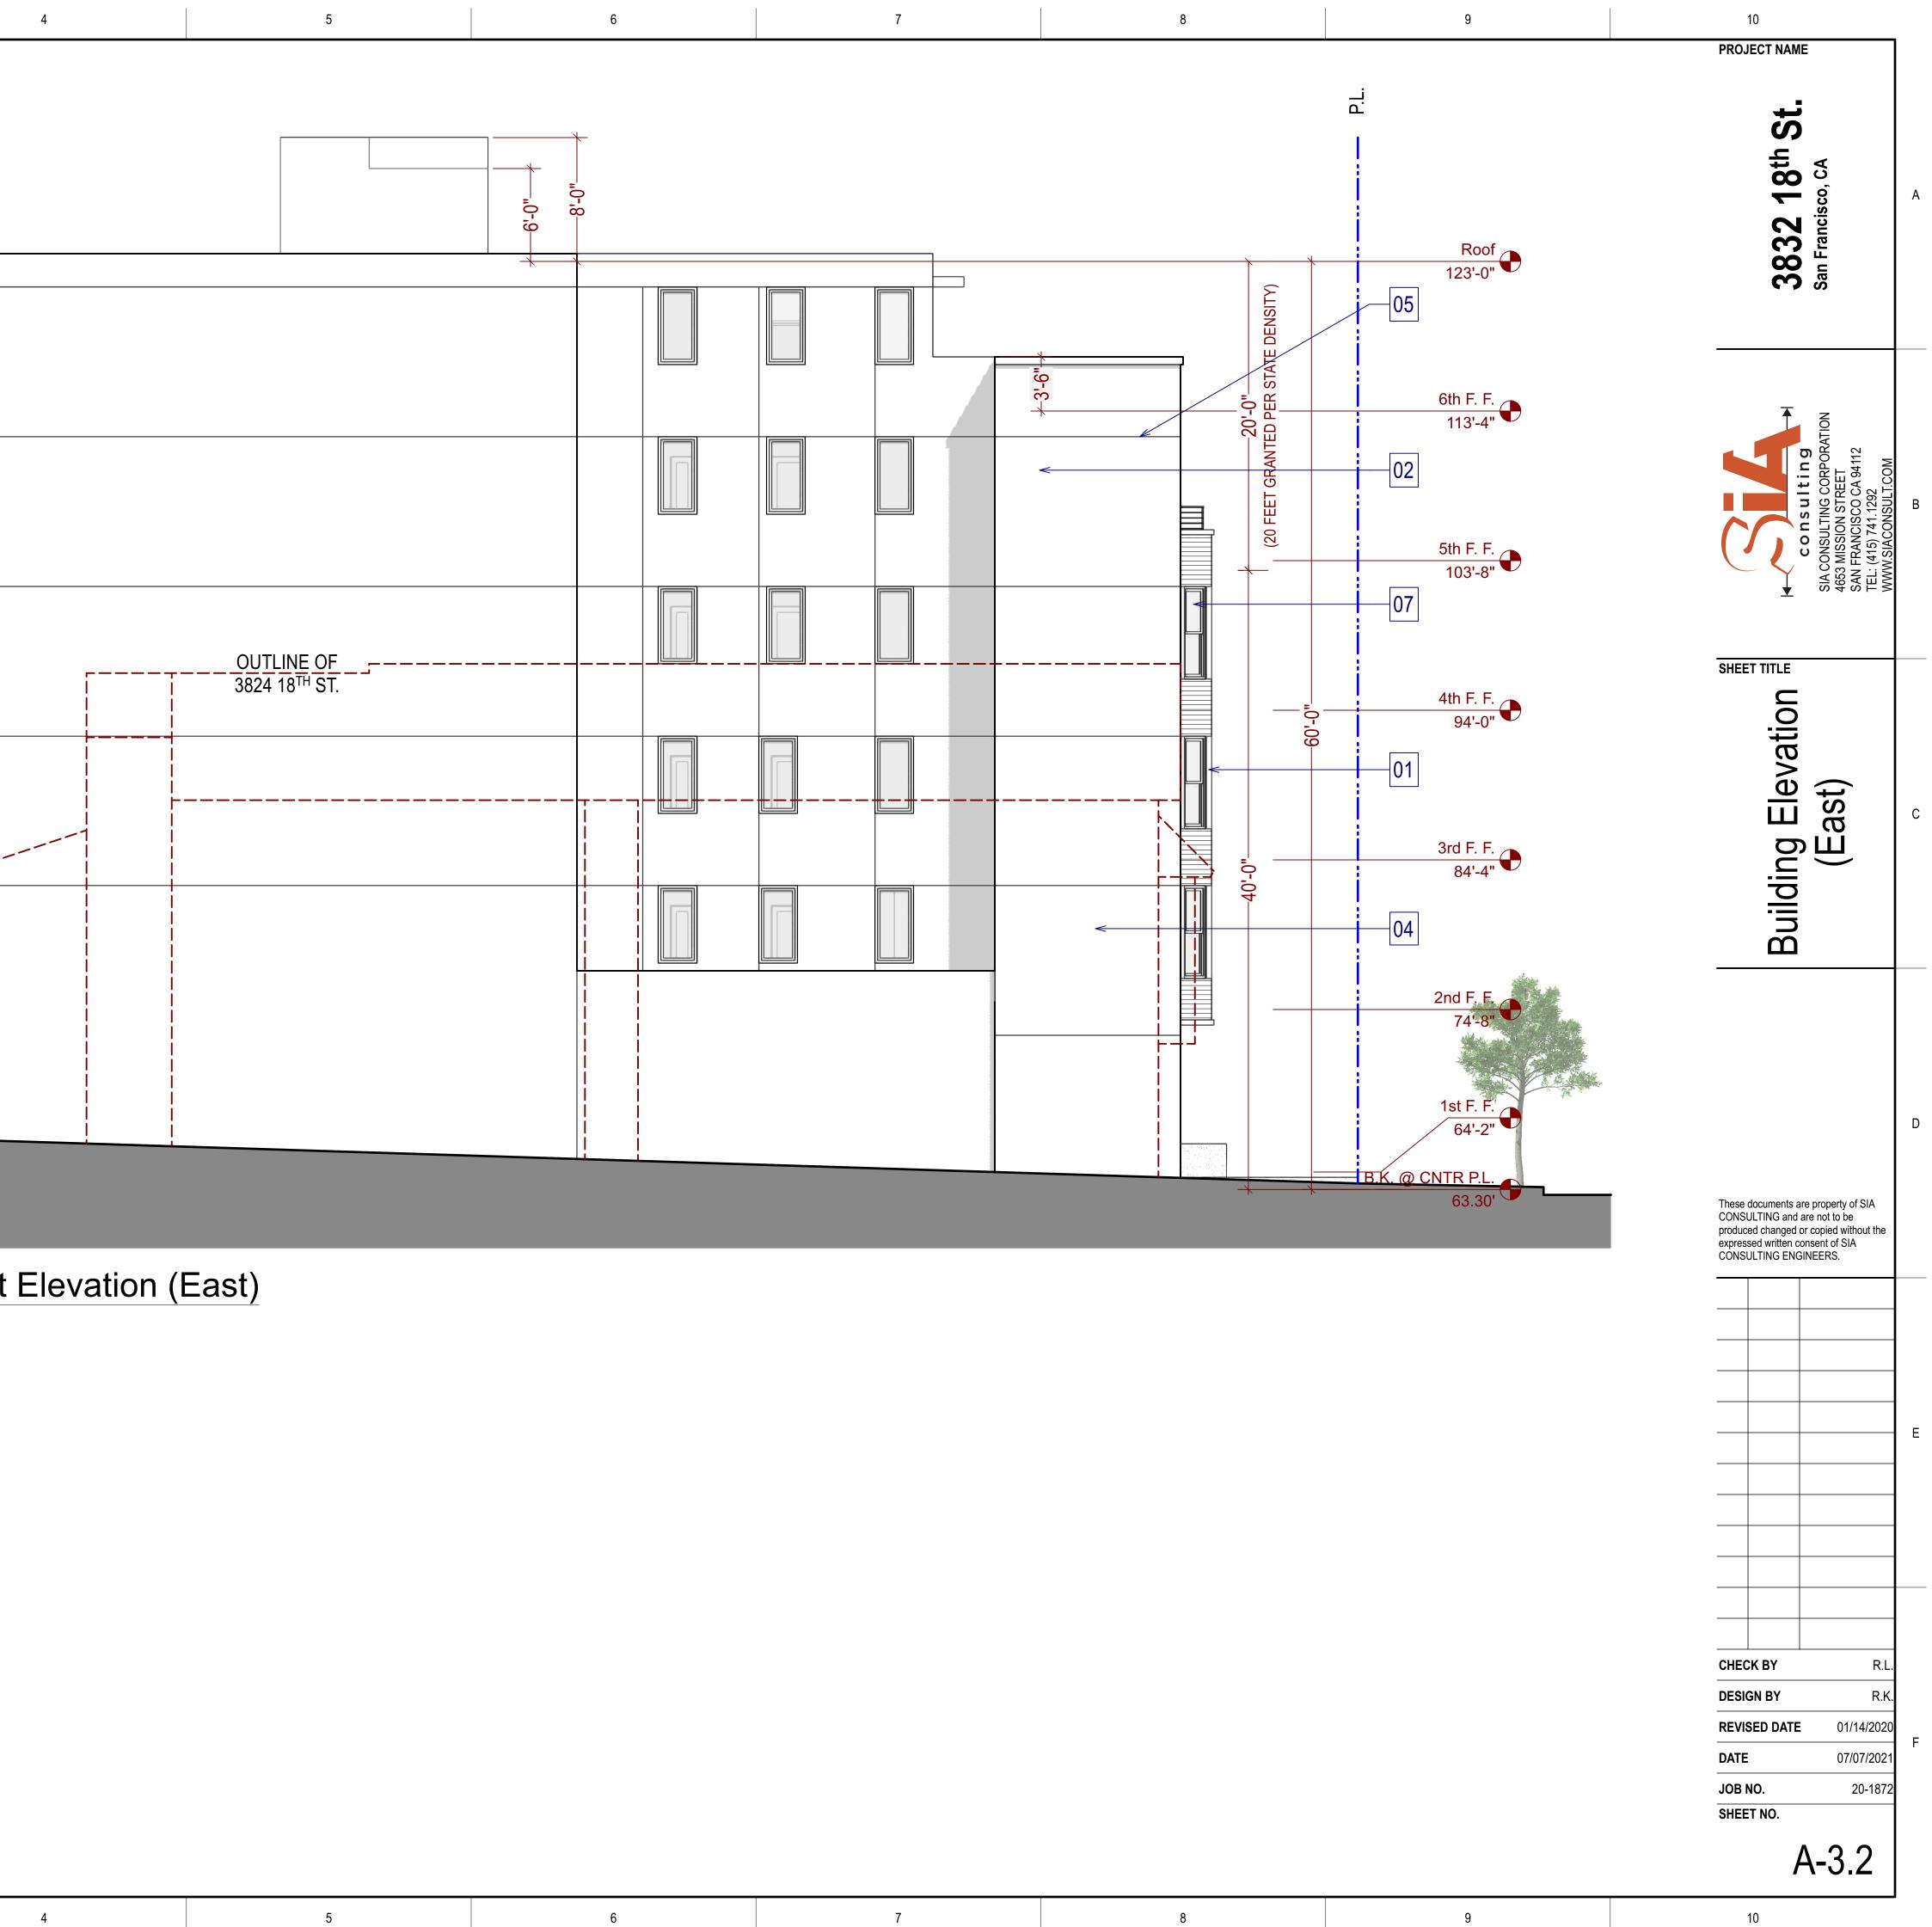



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07	ALUMINUM CLAD WOOD WINDOW, W/ DARK ANODIZED FINISH, TYP.	
08	ALUMINUM CLAD PATIO DOOR W/ CLR. GLASS, TYP.	<u>NOTE:</u> PROJECT TO CON
09	SOLID ENTRY DOOR	GLAZING REQ. PEI SEC.139

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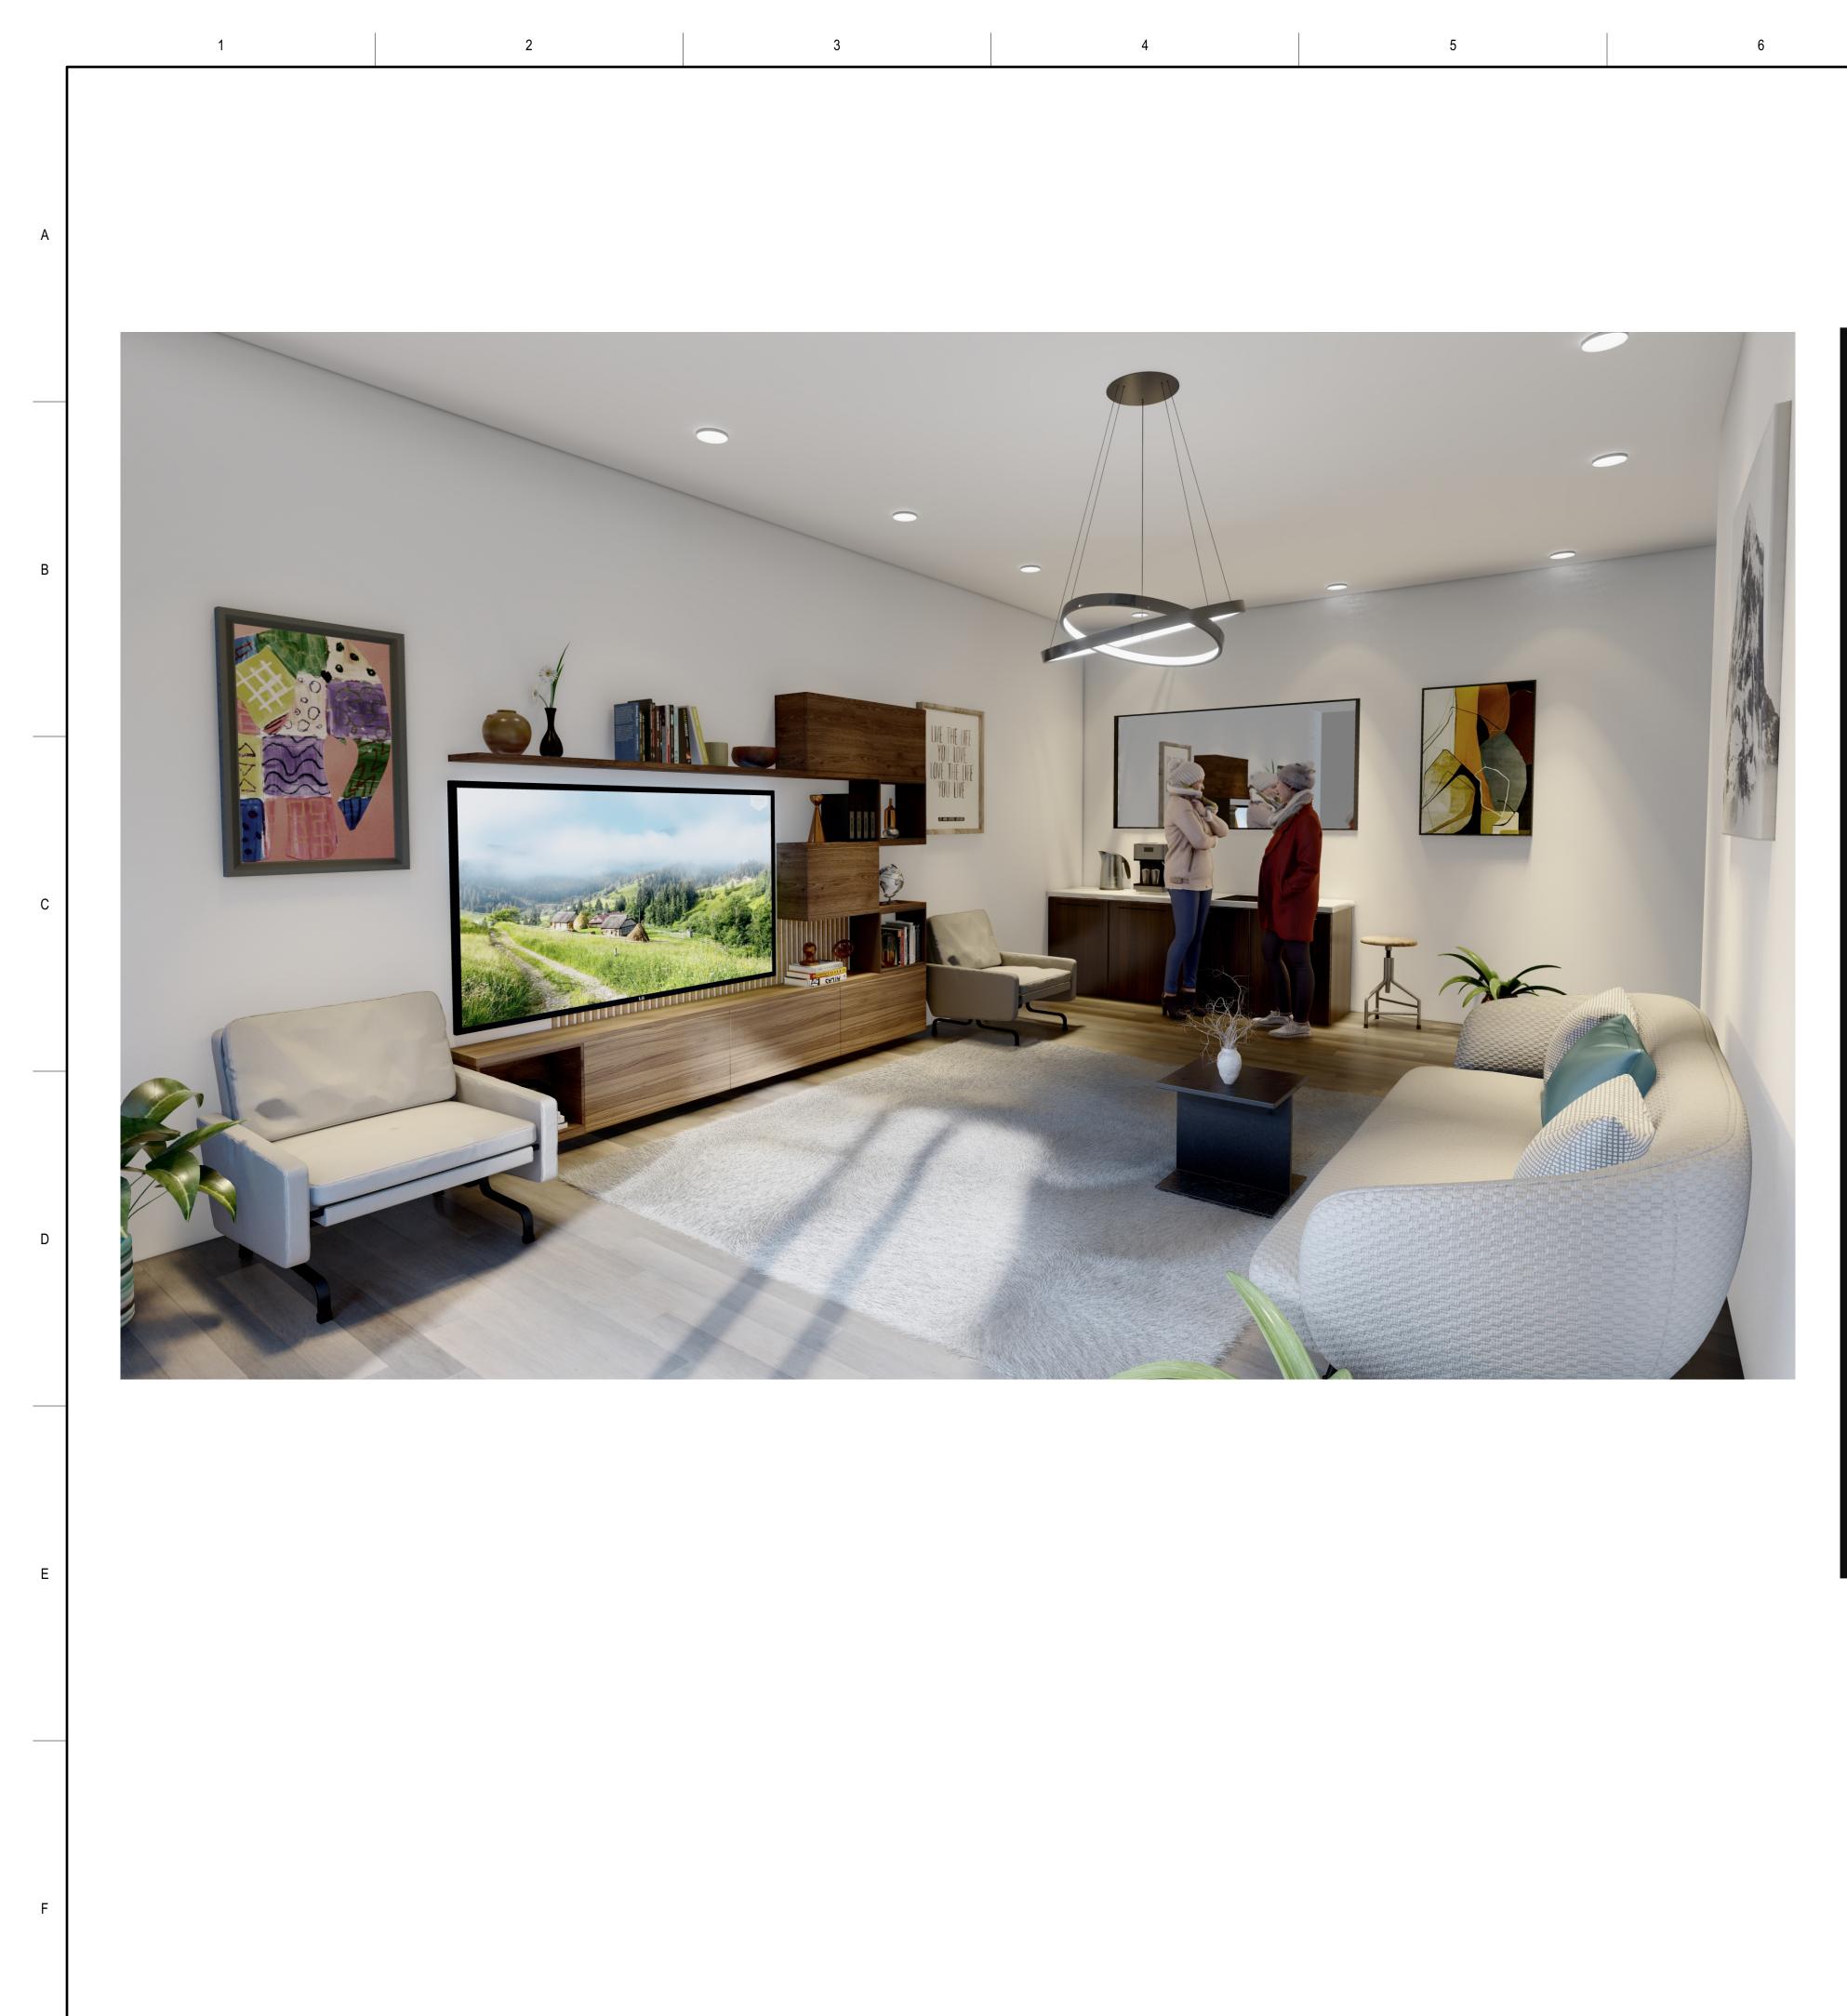


- 01 CLOSET / STORAGE
- 02 BATHROOM
- 03 KITCHEN

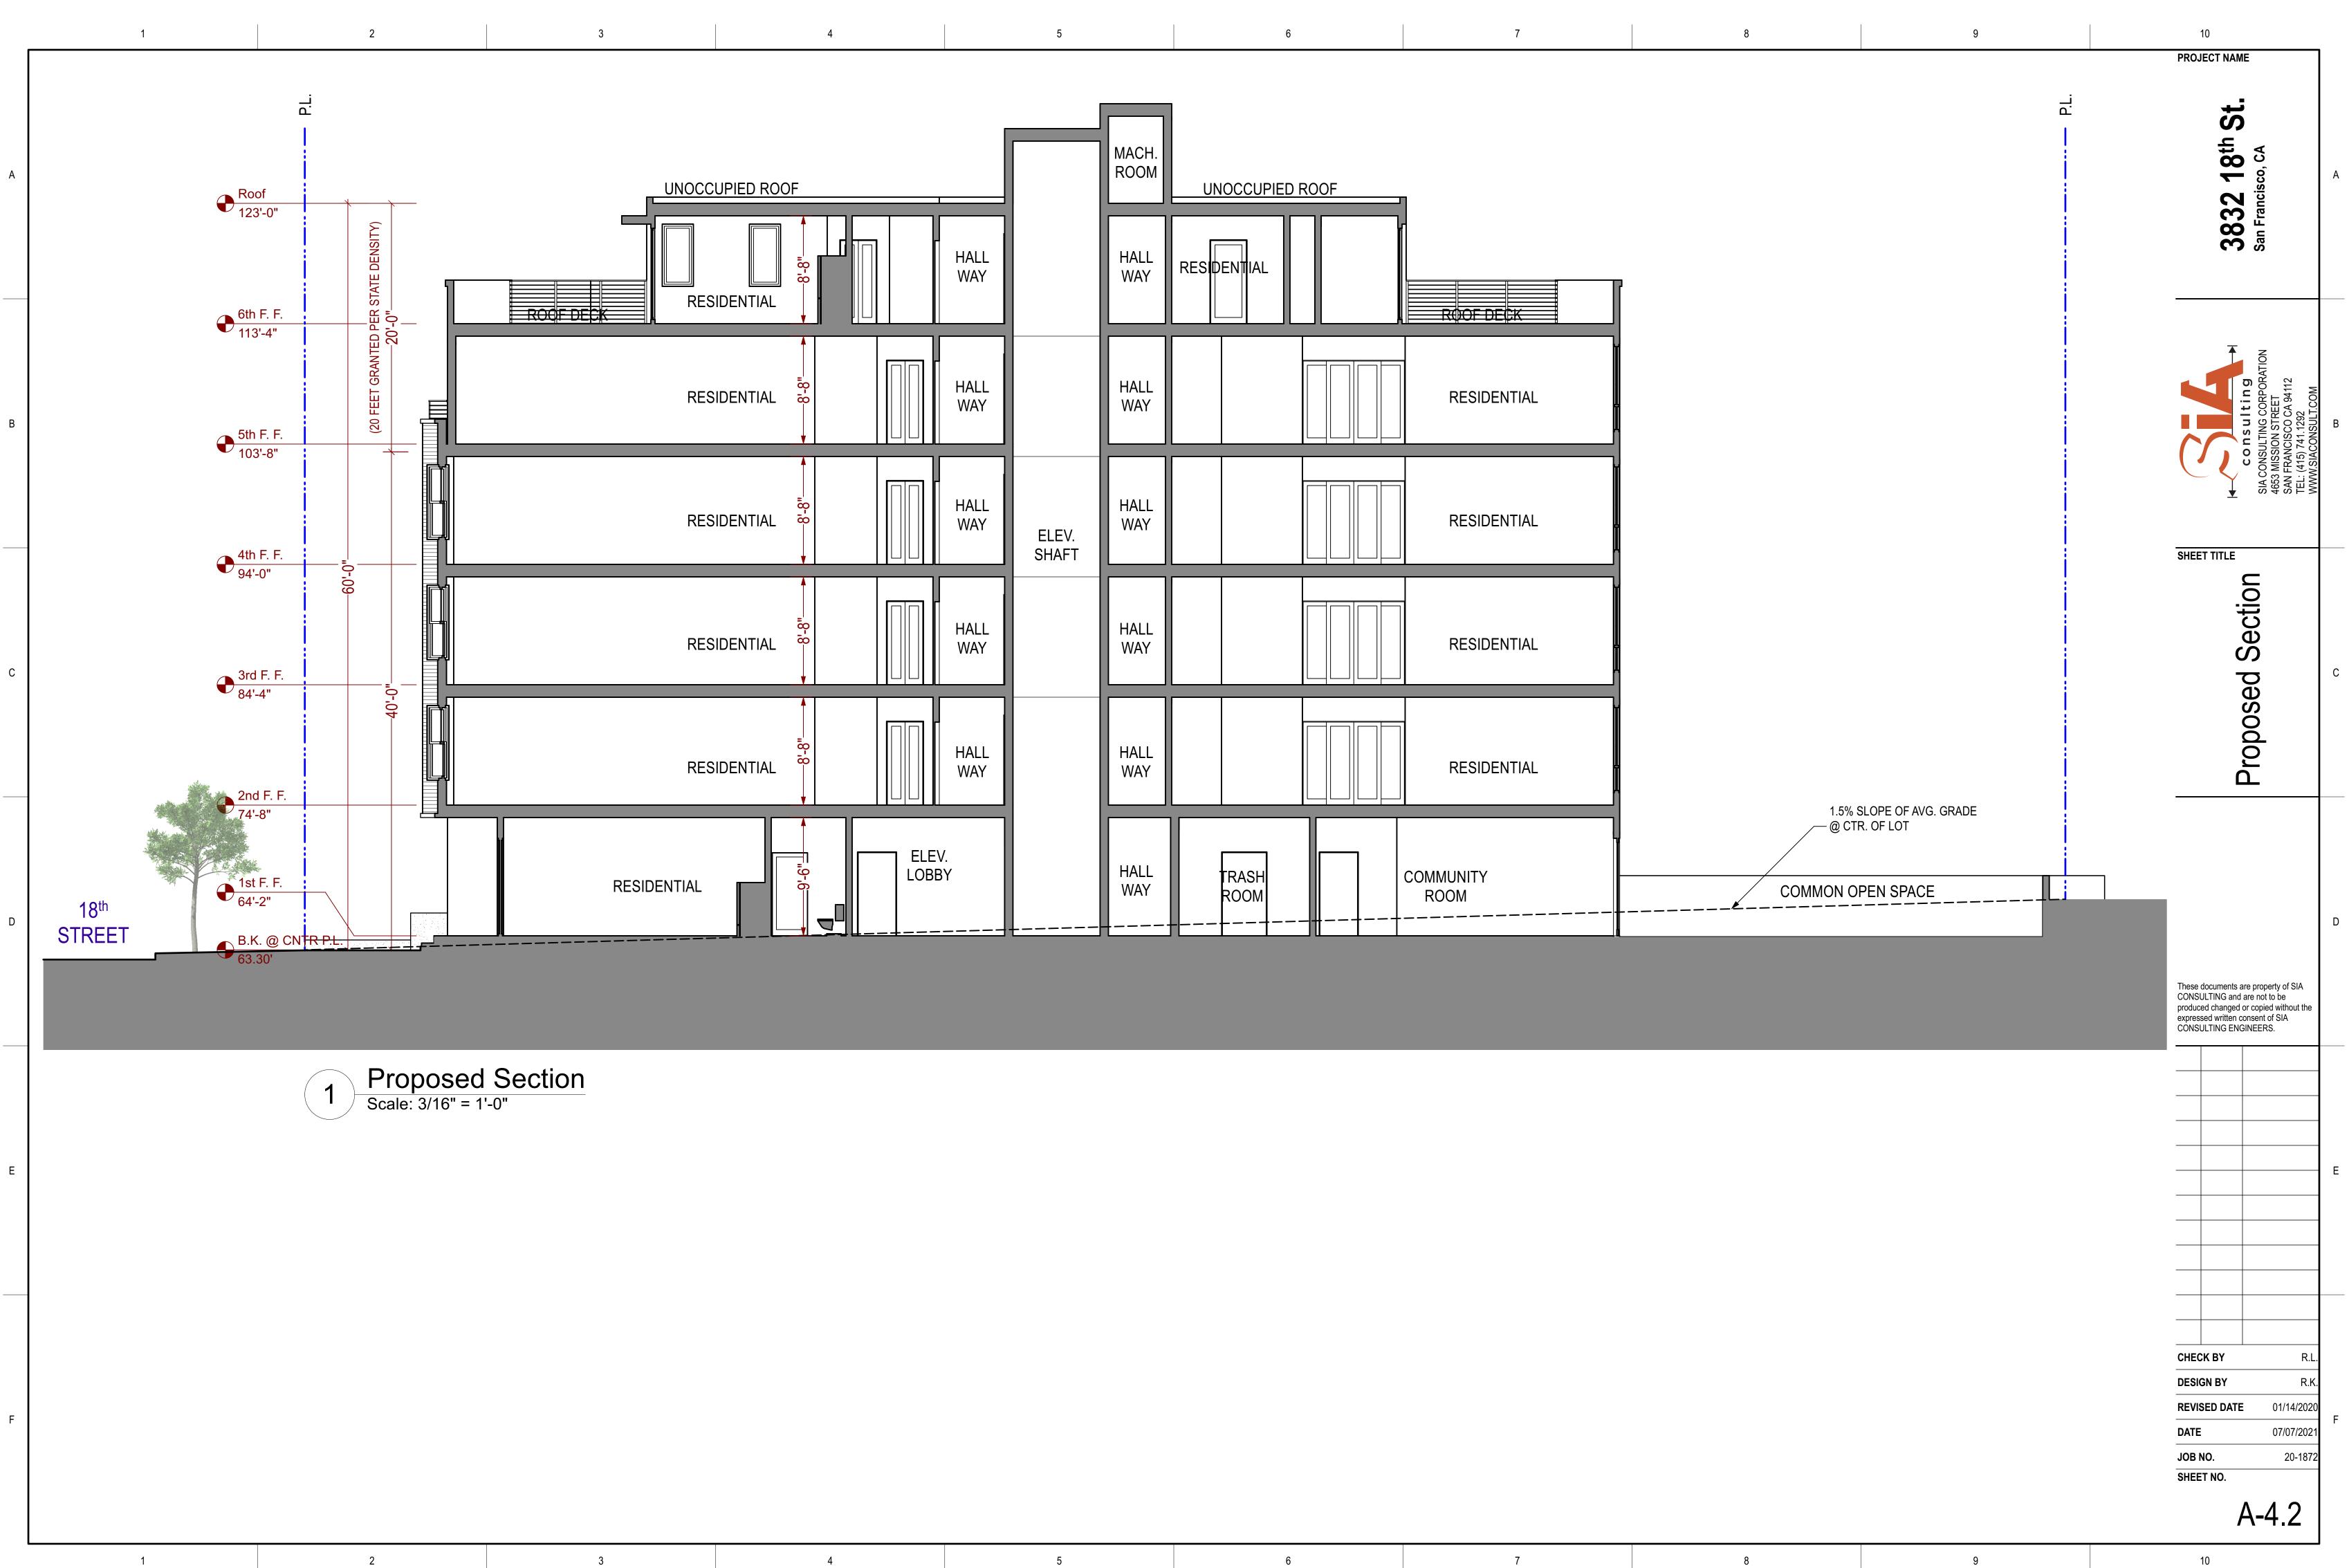02-

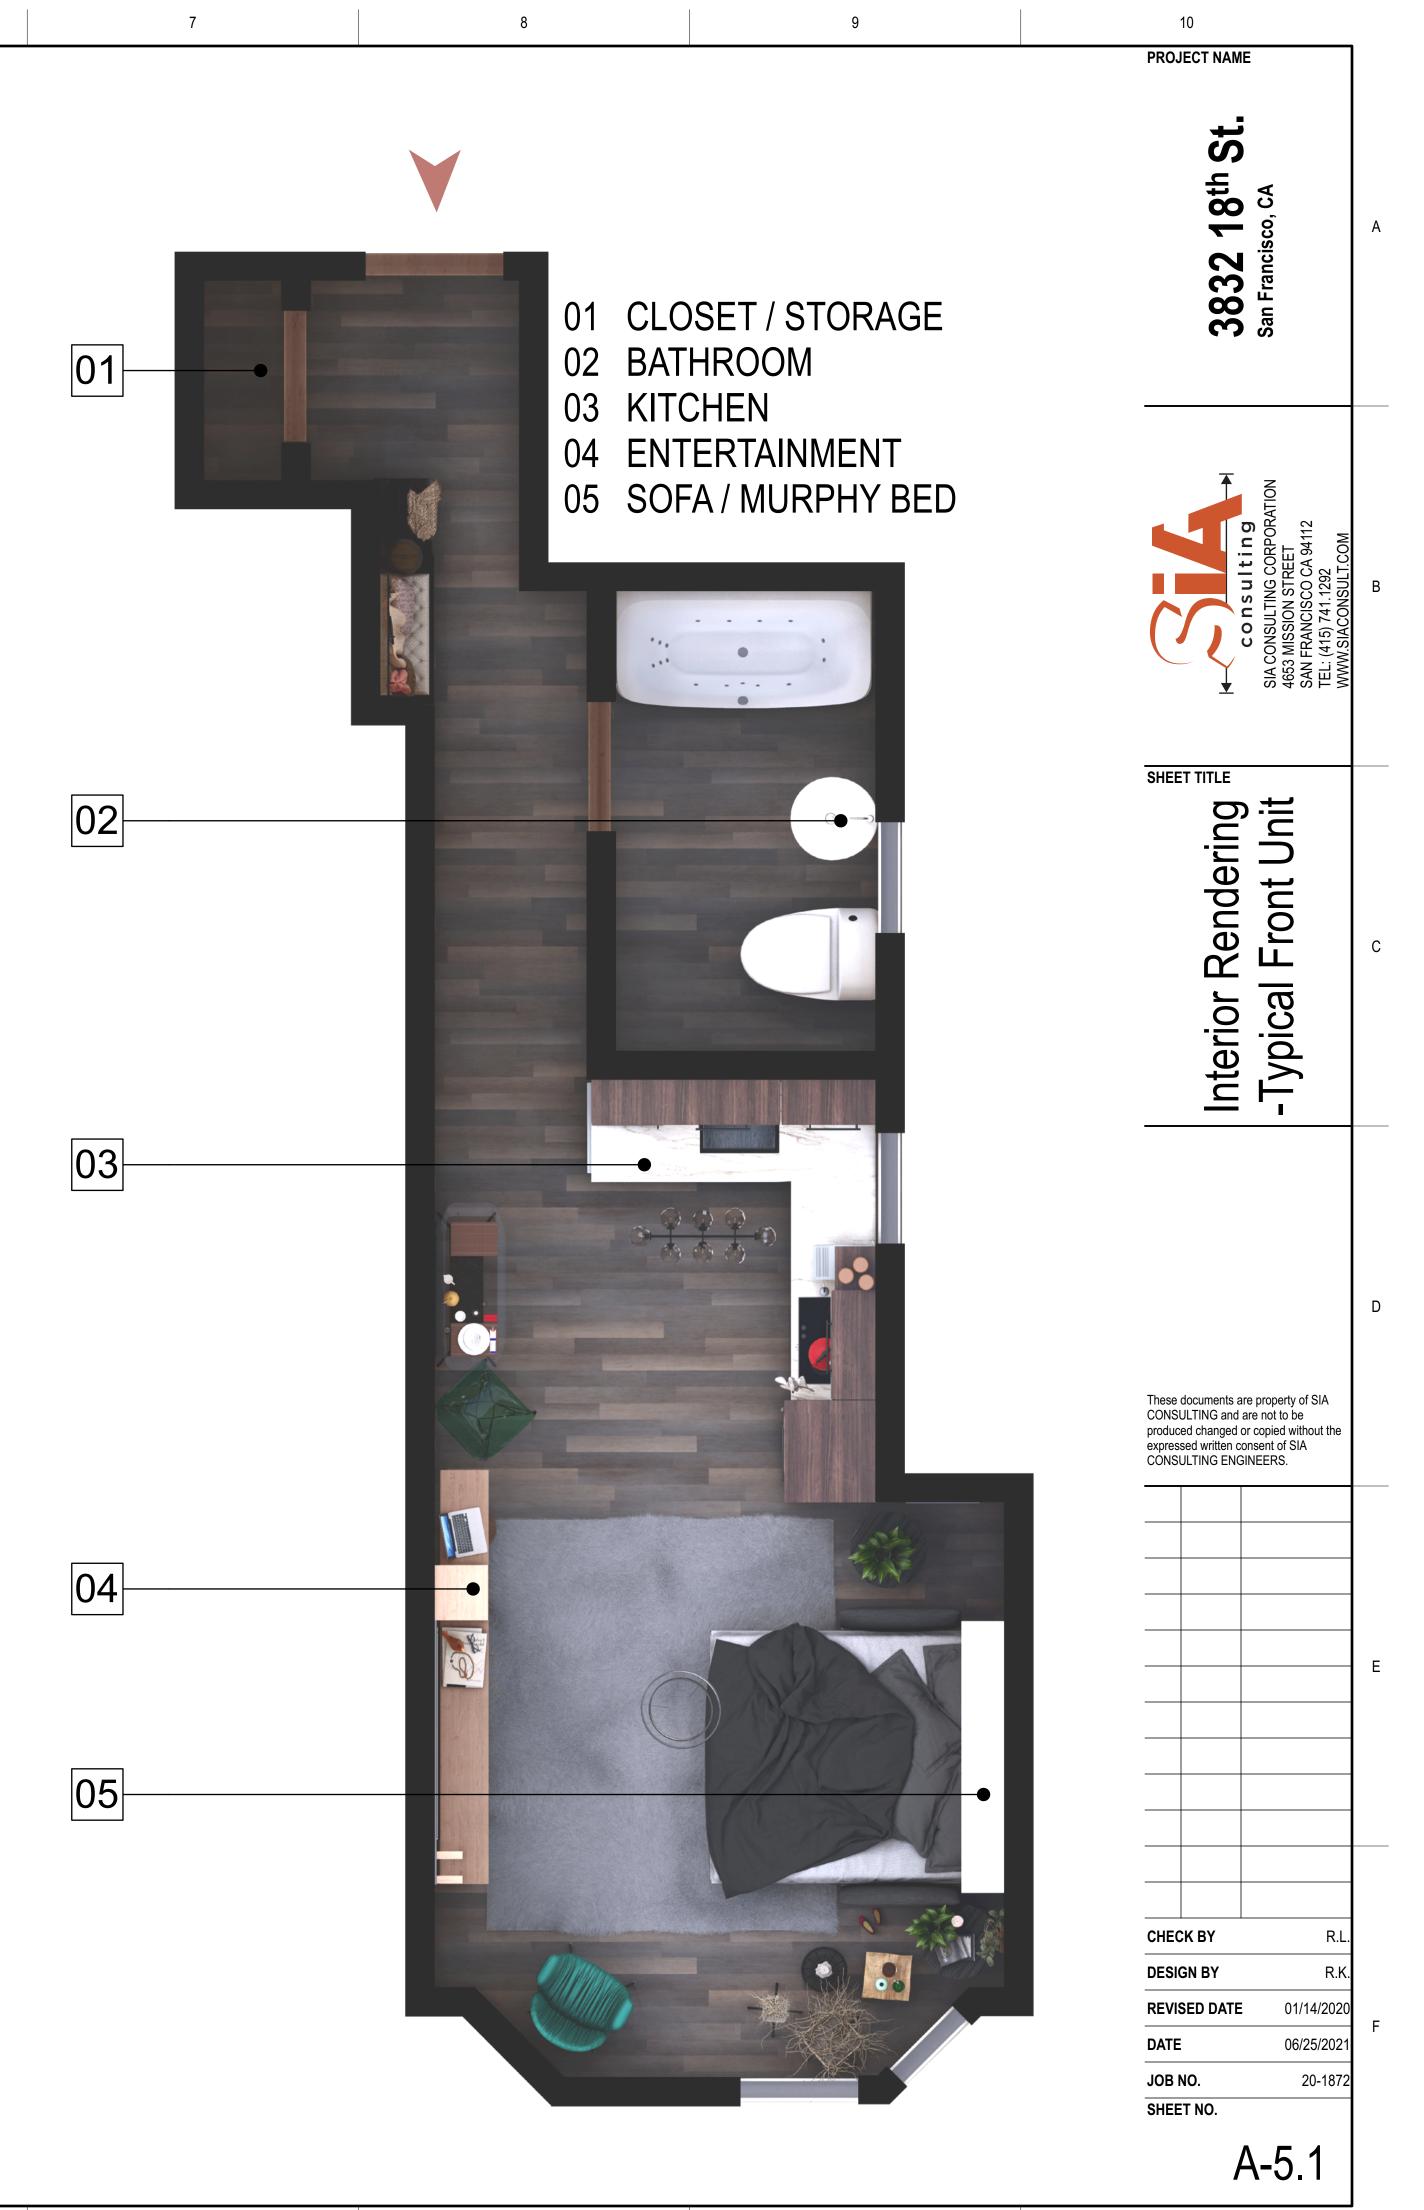- 04 ENTERTAINMENT
- 05 SOFA / MURPHY BED

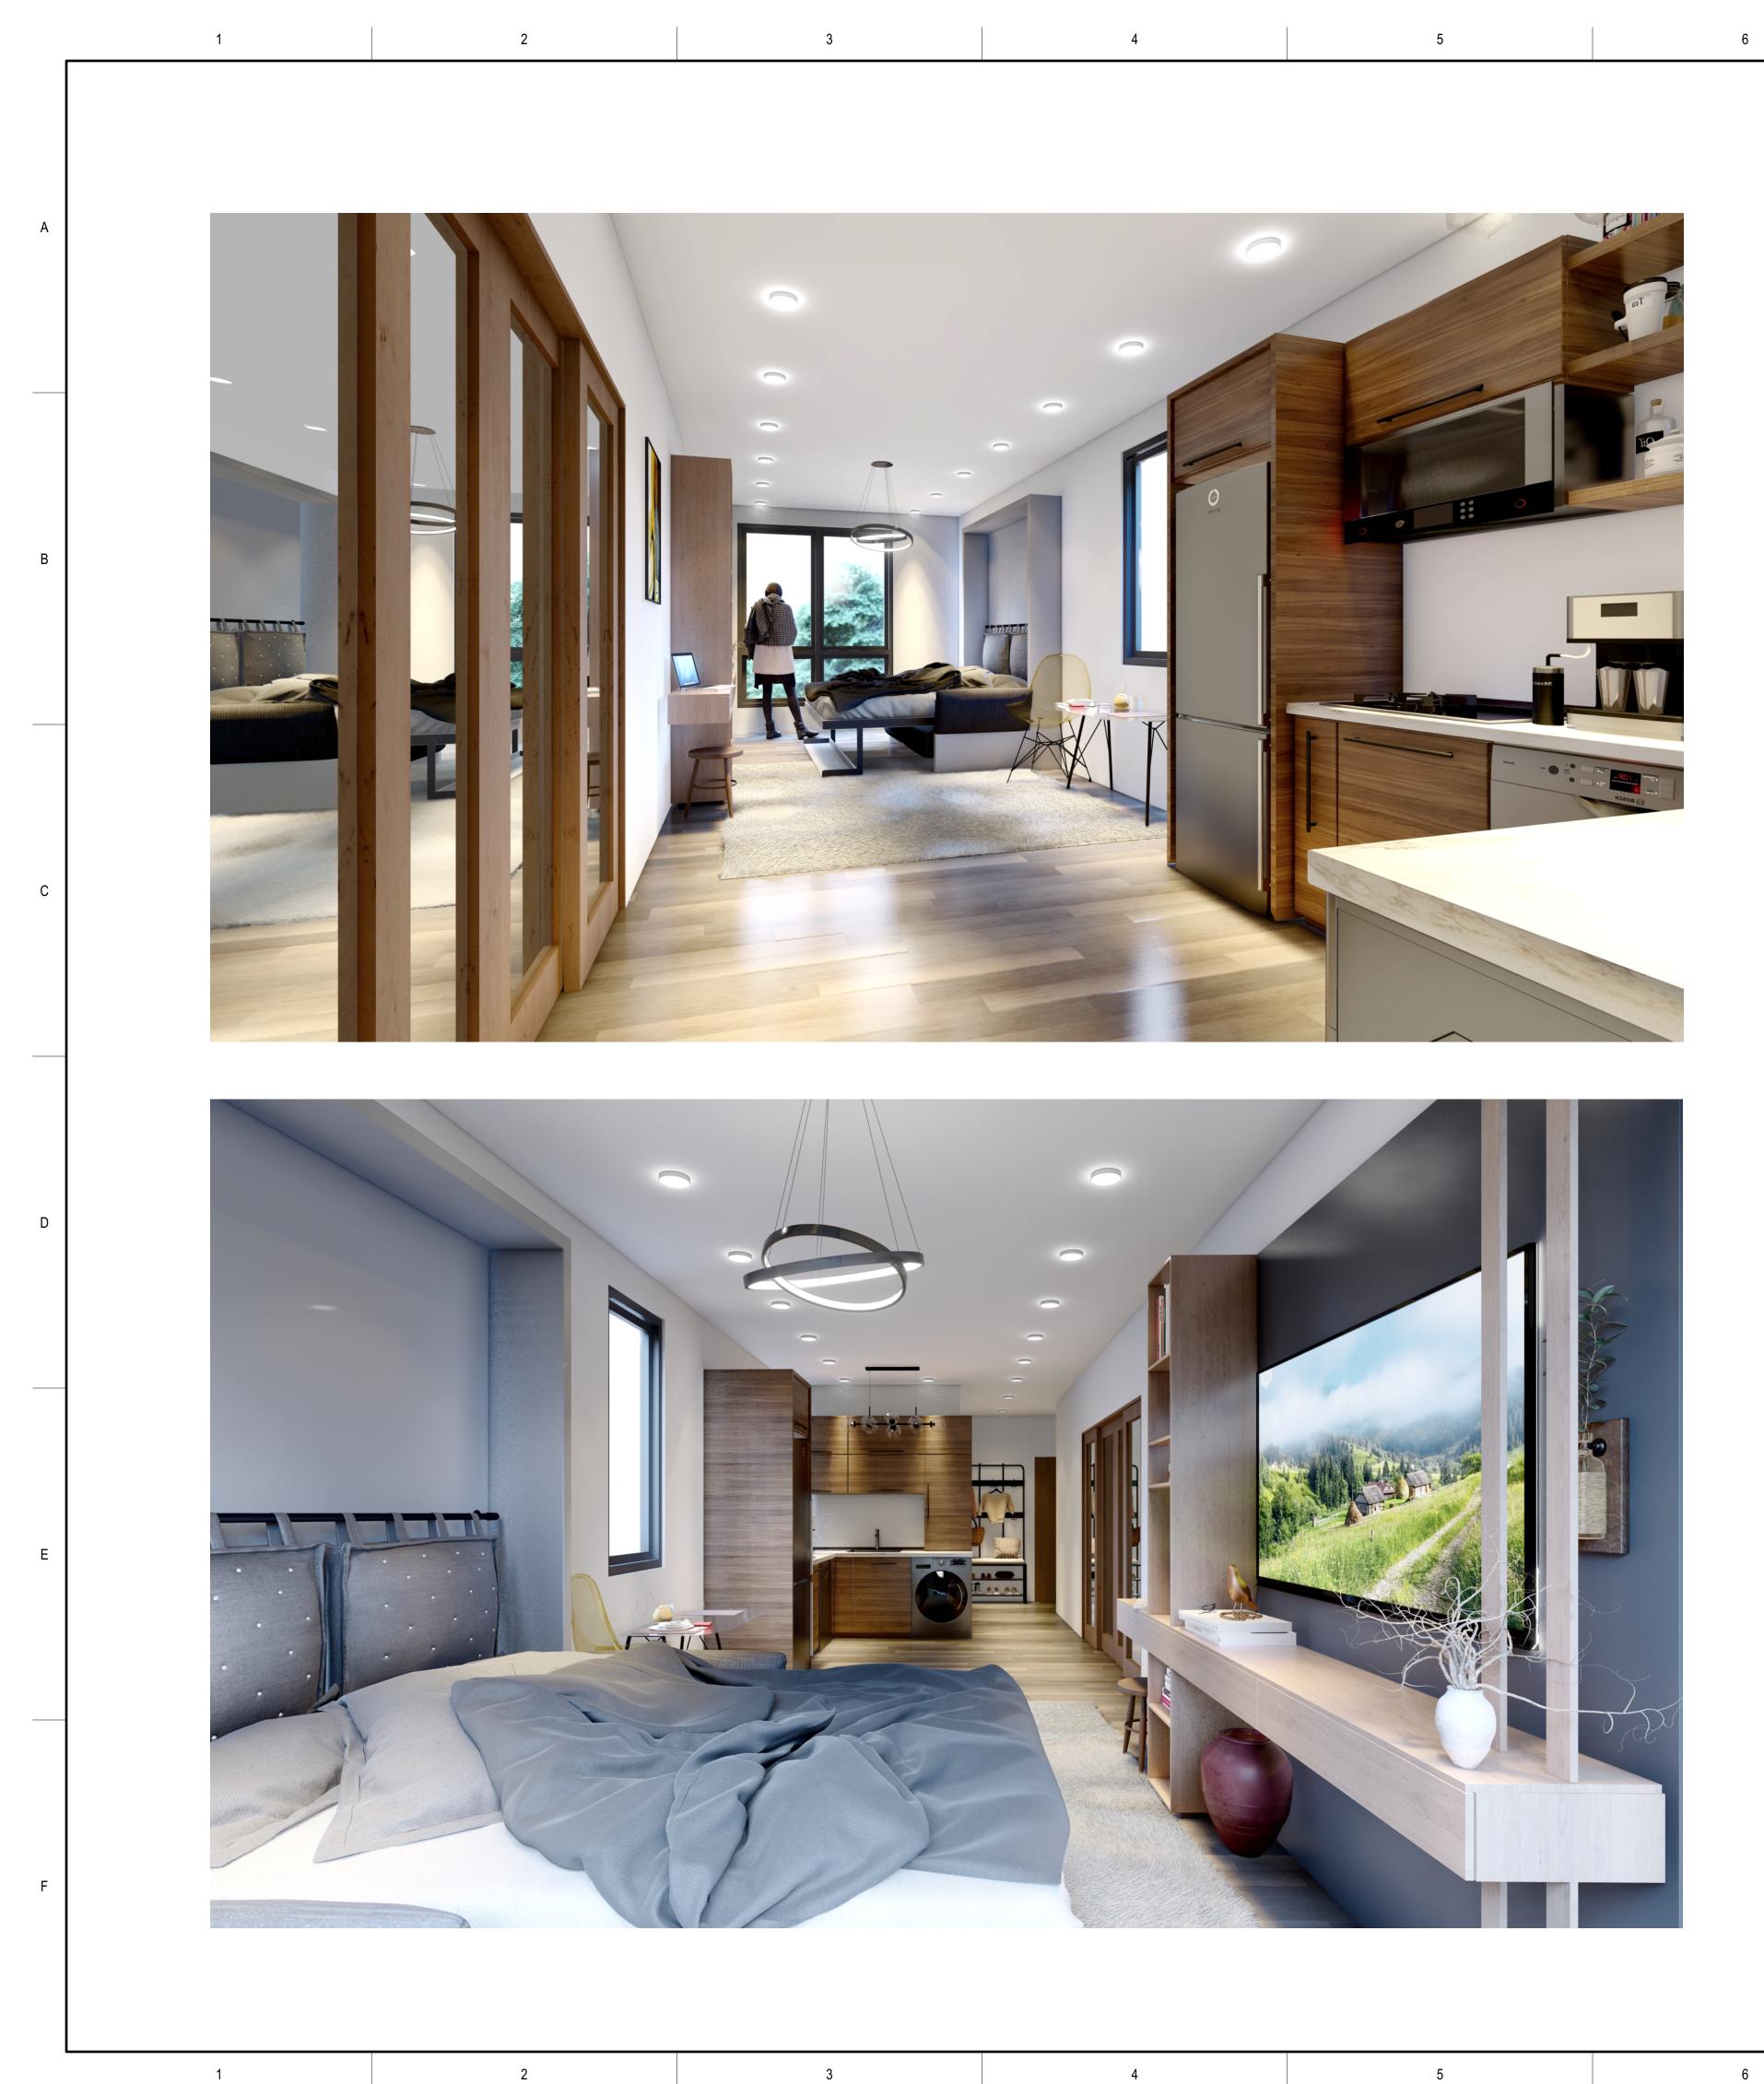







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С



01 LANDSCAPE 02 SEATING

03 COMMUNITY ROOM

		GS1: San Francisco Green Building Si	te Per	mit Su	ıbmitt	al For	m		For	m version: February 1, 2	018 (For permit application	ions January 2017 - December 2019)	
NSTRUCTIONS: . Select one (1) column to identify requirements for the project. For addition and alteration projects,			NEW CONSTRUCTION					Form version: February 1, 2018 (For permit application ALTERATIONS + ADDITIONS				PROJECT INFO	18th
Select one (1) column to identify requirements for the project. For addition and alteration projects, Dicability of specific requirements may depend upon project scope. Provide the Project Information in the box at the right. A LEED or GreenPoint Rated Scorecard is not required with the site permit application, but using such tools											3832 18 th St.	32 Francis	
y as possible is recommended. nsure legibility of DBI archives, s	ubmittal must be a i	ninimum of 24" x 36".	LOW-RISE RESIDENTIAL	HIGH-RISE RESIDENTIAL	LARGE NON- RESIDENTIAL	OTHER NON- RESIDENTIAL	RESIDENTIAL MAJOR ALTERATIONS + ADDITIONS	OTHER RESIDENTIAL ALTERATIONS + ADDITIONS	NON-RESIDENTIAL MAJOR ALTERATIONS + ADDITIONS	FIRST-TIME NON-RESIDENTIAL INTERIORS	OTHER NON- RESIDENTIAL INTERIORS, ALTERATIONS		383 San Frar
nent GS2, GS3, GS4, GS5 or GS6 ICATION" form will be required prior inicipal projects, additional Environn	will be due with the a r to Certificate of Com nent Code Chapter 7	oplicable addendum. A separate "FINAL COMPLIANCE oletion. For details, see Administrative Bulletin 93. requirements may apply; see GS6.	R	R	A,B,E,I,M 25,000 sq.ft.	F,H,L,S,U or	R	R	B,M	A,B,I,M	ALTERATIONS + ADDITIONS A,B,E,F,H,L,I,M,S,U	3580/018 BLOCK/LOT	
TITLE	SOURCE OF REQUIREMENT SFGBC 4.103.1.1,	DESCRIPTION OF REQUIREMENT	1-3 Floors	4+ Floors	25,000 sq.ft. or greater	A,B,E,I,M less than 25,000 sq.ft.	25,000 sq.ft. or greater	adds any amount of conditioned area	25,000 sq.ft. or greater	A,B,I,M 25,000 sq.ft. or greater	A,B,E,F,H,L,I,M,S,U more than 1,000 sq.ft. or \$200,000	3832 18 th St.	
Required LEED or GPR Certification Level	4.103.2.1, 4.103.3.1, 5.103.1.1, 5.103.3.1 & 5.103.4.1	Project is required to achieve sustainability certification listed at right.	LEED SILVER (50+) or GPR (75+) CERTIFIED	LEED SILVER (50+ or GPR (75+) CERTIFIED	LEED GOLD (60+) CERTIFIED	n/r	LEED GOLD (60+) or GPR (75+) CERTIFIED	n/r	LEED GOLD (60+) CERTIFIED	LEED GOLD (60+) CERTIFIED	n/r	ADDRESS	T Z
LEED/GPR Point Adjustment for Retention/Demolition of Historic Features/Building	SFGBC 4.104, 4.105, 5.104 & 5.105	Enter any applicable point adjustments in box at right.				n/r		n/r			n/r	PRIMARY OCCUPANCY	PORATIC
	CALGreen 4.504.2.1-5	Use products that comply with the emission limit requirements of 4.504.2.1-5, 5.504.4.1-6 for adhesives, sealants, paints, coatings, carpet systems including cushions and adhesives, resilient flooring (80% of area), and composite wood products.										11,147 ±S.F.	u l t i J STREET
LOW-EMITTING MATERIALS	& 5.504.4.1-6, SFGBC 4.103.3.2, 5.103.1.9, 5.103.3.2 & 5.103.4.2	Major alterations to existing residential buildings must use low-emitting coatings, adhesives and sealants, and carpet systems that meet the requirements for GPR measures K2, K3 and L2 or LEED EQc2, as applicable. New large non-residential interiors and major alterations to existing residential and non-residential buildings must also use interior paints, coatings, sealants, and adhesives when applied on-site, flooring and composite wood that meet the requirements of LEED credit Low-Emitting Materials (EQc2).	4.504.2.1-5	4.504.2.1-5	LEED EQc2	5.504.4.1-6	LEED EQc2 or GPR K2, K3 & L2	4.504.2.1-5	LEED EQc2	LEED EQc2	5.504.4.1-6	GRUSS BUILDING AREA	c o n s d consultin
INDOOR WATER USE REDUCTION	CALGreen 4.303.1 & 5.303.3, SFGBC 5.103.1.2, SF Housing Code	Meet flush/flow requirements for: toilets (1.28gpf); urinals (0.125gpf wall, 0.5gpf floor); showerheads (2.0gpm); lavatories (1.2gpm private, 0.5gpm public/common); kitchen faucets (1.8gpm); wash fountains (1.8gpm); metering faucets (0.2gpc); food waste disposers (1gpm/8gpm). Residential projects must upgrade all non-compliant fixtures per SF Housing Code sec.12A10. Large non-residential interiors, alterations & additions must upgrade all non-compliant fixtures per SF Housing Code sec.12A10. Large non-residential interiors, alterations & additions must upgrade all non-compliant fixtures per SF Housing Code sec.12A10. Large non-residential interiors, alterations & additions must upgrade all non-compliant fixtures per SF Housing Code sec.12A10. Large non-residential interiors, alterations & additions must upgrade all non-compliant fixtures per SF Housing Code sec.12A10.	•	•	LEED WEc2 (2 pts)	•	•	•	•	•	•	DESIGN PROFESSIONAL or PERMIT APPLICANT	SIA C SIA C 4653
		Now large non-residential buildings must also achieve minimum 30% indeer notable water use reduction as calculated to meet LEED credit Indeer Water Use Reductio										(sign & date)	SHEET TITLE
NON-POTABLE WATER REUSE WATER-EFFICIENT	Health Code art.12C	and use in toilet and urinal flushing and irrigation. See www.sfwater.org for details.	11/1	•	•	n/r	n/r	n/r	n/r	n/r	n/r		
IRRIGATION WATER METERING	CALGreen 5.303.1	New construction projects with aggregated landscape area ≥500 sq.ft., or existing projects with modified landscape area ≥1,000 sq.ft. shall use low water use plants or climate appropriate plants, restrict turf areas and comply with Model Water Efficient Landscape Ordinance restrictions by calculated ETAF (.55 for residential, .45 for non-residential or less) or by prescriptive compliance for projects with ≤2,500 sq.ft. of landscape area. See www.sfwater.org for details. Provide submeters for spaces projected to consume >1,000gal/day (or >100gal/day in buildings >50,000 sq.ft.).	• n/r	• n/r	•	•	• n/r	• n/r	•	•	•		st st
ENERGY EFFICIENCY	CA Energy Code	Comply with all provisions of the CA Title 24 Part 6 Energy Standards.	•	•	•	•	•	•	•	•	•		
BETTER ROOFS	SFGBC 4.201.1 & 5.201.1.2	New non-residential buildings >2,000 sq.ft. and ≤10 occupied floors, and new residential buildings of any size and ≤10 occupied floors, must designate 15% of roof Solar Ready, per Title 24 rules. Install photovoltaics or solar hot water systems in this area. With Planning Department approval, projects subject to SFPUC Stormwater	•	≤10 floors	•	•	n/r	n/r	n/r	n/r	n/r		l l l l l l l l l l l l l l l l l l l
RENEWABLE ENERGY	SFGBC 5.201.1.3	Requirements may substitute living root for solar energy systems. Non-residential buildings with ≥11 floors must acquire at least 1% of energy from on-site renewable sources, purchase green energy credits, or achieve 5 points under	n/r	n/r	•	•	n/r	n/r	n/r	n/r	n/r		C B H
COMMISSIONING (Cx)	CALGreen	LEED credit Optimize Energy Performance (EAc2). For projects ≥10,000 sq.ft, include OPR, BOD, and commissioning plan in design & construction. Commission to comply. Alterations & additions with new HVAC equipment must test and adjust all equipment.	n/r	n/r	LEED EAc1 opt. 1	•	n/r	n/r	•	•	•		
BICYCLE PARKING	CALGreen 5.106.4, Planning Code 155.1-2	Provide short- and long-term bike parking equal to 5% of motorized vehicle parking, or meet SF Planning Code sec.155.1-2, whichever is greater.	SF Planning Code sec.155.1-2	SF Planning Code sec.155.1-2	•	•	if applicable SF Planning Code sec.155.1-2	if applicable SF Planning Code sec.155.1-2	•	•	if >10 stalls added		
DESIGNATED PARKING	CALGreen 5.106.5.2	Mark 8% of total parking stalls for low-emitting, fuel efficient, and carpool/van pool vehicles.	n/r	n/r	•	•	n/r	n/r	•	•	if >10 stalls added		
WIRING FOR EV CHARGERS	SFGBC 4.106.4 & 5.106.5.3	Permit application January 2018 or after: Construct all new off-street parking spaces for passenger vehicles and trucks with dimensions capable of installing EVSE. Install service capacity and panelboards sufficient to provide ≥40A 208 or 240V to EV chargers at 20% of spaces. Install ≥40A 208 or 240V branch circuits to ≥10% of spaces, terminating close to the proposed EV charger location. Installation of chargers is not required. Projects with zero off-street parking exempt. See SFGBC 4.106. or SFGBC 5.106.5.3 for details. Permit applications prior to January 2018 only: Install infrastructure to provide electricity for EV chargers at 6% of spaces for non-residential (CalGreen 5.106.5.3), 3% of spaces for multifamily with ≥17 units (CalGreen 4.106.4.2), and each space in 1-2 unit dwellings (CalGreen 4.106.4.1). Installation of chargers is not required.		•	•	•	applicable for permit application January 2018 or after	n/r	applicable for permit application January 2018 or after	n/r	n/r		
RECYCLING BY OCCUPANTS	SF Building Code AB-088	spaces for multifamily with ≥17 units (CalGreen 4.106.4.2), and each space in 1-2 unit dwellings (CalGreen 4.106.4.1). Installation of chargers is not required. Provide adequate space and equal access for storage, collection and loading of compostable, recyclable and landfill materials.	•	•	•	•	•	•	•	•	•		
CONSTRUCTION & DEMOLITION (C&D) WASTE MANAGEMENT	SFGBC 4.103.2.3 & 5.103.1.3.1,	For 100% of mixed C&D debris use registered transporters and registered processing facilities with a minimum of 65% diversion rate. Divert a minimum of 75% of total C&D debris if noted.	•	75% diversion	75% diversion	•	•	•	•	75% diversion	•		
HVAC INSTALLER QUALS	CALGreen 4.702.1	Installers must be trained and certified in best practices.	•	•	n/r	n/r	•	•	n/r	n/r	n/r		These documents are property CONSULTING and are not to b produced changed or copied w expressed written consent of S
HVAC DESIGN	CALGreen 4.507.2 CALGreen 5.508.1	HVAC shall be designed to ACCA Manual J, D, and S. Use no halons or CFCs in HVAC.	● n/r	• n/r	n/r	n/r	● n/r	• n/r	n/r	n/r	n/r •		CONSULTING ENGINEERS.
LIGHT POLLUTION REDUCTION	CA Energy Code, CALGreen 5.106.8	Comply with CA Energy Code for Lighting Zones 1-4. Comply with 5.106.8 for Backlight/Uplight/Glare.	n/r	n/r	•	•	n/r	n/r	•	•	•		
BIRD-SAFE BUILDINGS	Planning Code sec.139 CALGreen 5.504.7,	Glass facades and bird hazards facing and/or near Urban Bird Refuges may need to treat their glass for opacity. For non-residential projects, prohibit smoking within 25 feet of building entries, air intakes, and operable windows.	•	•	•	•	•	•	•	•	•		
OBACCO SMOKE CONTROL	Health Code art.19F	For residential projects, prohibit smoking within 10 feet of building entries, air intakes, and operable windows and enclosed common areas.	•	•	•	•	•	•	•	•	•		
STORMWATER CONTROL PLAN	Public Works Code art.4.2 sec.147	Projects disturbing ≥5,000 sq.ft. in combined or separate sewer areas, or replacing ≥2,500 impervious sq.ft. in separate sewer area, must implement a Stormwater Control Plan meeting SFPUC Stormwater Management Requirements. See www.sfwater.org for details.	•	•	•	•	if project extends outside envelope	if project extends outside envelope	if project extends outside envelope	if project extends outside envelope	if project extends outside envelope		
CONSTRUCTION SITE RUNOFF CONTROLS		Provide a construction site Stormwater Pollution Prevention Plan and implement SFPUC Best Management Practices. See www.sfwater.org for details.	if disturbing ≥5,000 sq.ft.	•	if disturbing ≥5,000 sq.ft.	if disturbing ≥5,000 sq.ft.	if project extends outside envelope	if project extends outside envelope	if project extends outside envelope	if project extends outside envelope	if project extends outside envelope		
ACOUSTICAL CONTROL	SF Building Code sec.1207	walls/floor-ceilings between tenants). New residential projects' interior noise due to exterior sources shall not exceed 45dB.	•	•	•	•	n/r	n/r	•	•	•		
(CONSTRUCTION) AIR FILTRATION	CALGreen 4.504.1-3 & 5.504.1-3 CALGreen 5.504.5.3,	Seal permanent HVAC ducts/equipment stored onsite before installation. Non-residential projects must provide MERV-8 filters on HVAC for regularly occupied, actively ventilated spaces.	• if applicable	• if applicable	•	•	if applicable	• n/r	•	•	•		
(OPERATIONS) CONSTRUCTION IAQ MANAGEMENT PLAN	SF Health Code art.38 SFGBC 5.103.1.8	Residential new construction and major alteration & addition projects in Air Pollutant Exposure Zones per SF Health Code art.38 must provide MERV-13 filters on HVAC During construction, meet SMACNA IAQ guidelines; provide MERV-8 filters on all HVAC.	if applicable	if applicable	• LEED EQc3	n/r	if applicable	n/r n/r	● n/r	n/r	• n/r		
GRADING & PAVING	CALGreen 4.106.3	Show how surface drainage (grading, swales, drains, retention areas) will keep surface water from entering the building.	•	•	n/r	n/r	if applicable	if applicable	n/r	n/r	n/r]	
RODENT PROOFING FIREPLACES &	CALGreen 4.406.1	Seal around pipe, cable, conduit, and other openings in exterior walls with cement mortar or DBI-approved similar method.	•	•	n/r	n/r	•	•	n/r	n/r	n/r		DESIGN BY REVISED DATE 0 ⁷
WOODSTOVES CAPILLARY BREAK, SLAB ON GRADE	CALGreen 4.503.1 CALGreen 4.505.2	Install only direct-vent or sealed-combustion, EPA Phase II-compliant appliances. Slab on grade foundation requiring vapor retarder also requires a capillary break such as: 4 inches of base 1/2-inch aggregate under retarder; slab design specified by licensed professional.	•	•	n/r n/r	n/r n/r	•	•	n/r n/r	n/r n/r	n/r n/r		DATE 07
MOISTURE CONTENT	CALGreen 4.505.3	Wall and floor wood framing must have <19% moisture content before enclosure.	•	•	n/r	n/r	•	•	n/r	n/r	n/r	1	JOB NO.

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