Certificate of Appropriateness Case Report

HEARING DATE: SEPTEMBER 19, 2018

1650 Mission St. Suite 400 San Francisco, CA 94103-2479

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Planning Information: 415.558.6377

Filing Date: September 19, 2018
Case No.: 2018-002272COA

Project Address: 1513 GOLDEN GATE AVENUE
Historic Landmark: Alamo Square Landmark District

Zoning: RH-3 (Residential-House, Three Family)

40-X Height and Bulk District

Block/Lot: 0776/025
Applicant: Brian Milford

101 Montgomery Street, Suite 650

San Francisco, CA 94115

Staff Contact: Jonathan Vimr - (415) 575-9109

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Reviewed By: Tim Frye – (415) 575-6822

tim.frye @sfgov.org

PROPERTY DESCRIPTION

1513 Golden Gate Avenue, south side between Scott and Pierce Streets, Assessor's Block 0776, Lot 025 (District 5). The subject property is developed with a two-story over basement residential building completed in 1876. The structure was designed and constructed by an unknown architect and/or builder. 1513 Golden Gate Avenue is contributory to the Alamo Square Landmark District and is located within a RH-3 (Residential-House, Three Family) Zoning District and a 40-X Height and Bulk District.

PROJECT DESCRIPTION

The proposed project is to make interior and exterior alterations to the subject building primarily in order to accommodate the insertion of a garage and garage door opening at the basement level of the front façade, and to construct a horizontal addition above an existing first floor pop-out at the non-visible rear of the building. More specifically, the project proposes to:

- Remove front landscaping, two basement level front windows, and a limited amount of existing siding.
- Create new opening at basement level and install a painted wood garage door with louvers meeting the minimum requirements in size.
- Install new wood trim above the breezeway gate.
- Replace the existing, non-historic entry stair and door. The new steps will be composed of
 concrete treads and risers but will have bull-nosed edge to mimic traditional wood steps. Wood
 will be used for the railing spindles and the simple newel posts, which will feature only curved
 edges.

- Reconfigure the historic front landscape wall to allow for the creation of a driveway. All intact landscape wall material will be reincorporated with any additional fabric required matching the historic in appearance, texture, and tooling.
- Install two new skylights. Each will be set off the ridgeline and will be mounted low to the roof with a curb as low as possible. Each will be significantly setback from the front of the building.
- Create new window openings along the east elevation and install new wood windows.
- Remove existing windows, doors, and a portico at the non-visible rear of the building. Install new wood windows and doors as well as a second floor horizontal addition above the existing first floor pop-out.
- Modify landscaping at the rear yard; all elements will possess a height less than three feet above grade.

OTHER ACTIONS REQUIRED

Prior to the approval of the associated building permit applications, the project will require neighborhood notification in conformance with Section 311 of the Planning Code.

APPLICABLE PRESERVATION STANDARDS

ARTICLE 10

Pursuant to Section 1006.2 of the Planning Code, unless exempt from the Certificate of Appropriateness requirements or delegated to Planning Department Preservation staff through the Administrative Certificate Appropriateness process, the Historic Preservation Commission is required to review any applications for the construction, alteration, removal, or demolition of any designated Landmark for which a City permit is required. Section 1006.6 states that in evaluating a request for a Certificate of Appropriateness for an individual landmark or a contributing building within a historic district, the Historic Preservation Commission must find that the proposed work is in compliance with the Secretary of the Interior's Standards for the Treatment of Historic Properties, as well as the designating Ordinance and any applicable guidelines, local interpretations, bulletins, related appendices, or other policies.

ARTICLE 10 – Appendix E – Alamo Square Landmark District

In reviewing an application for a Certificate of Appropriateness, the Historic Preservation Commission must consider whether the proposed work would be compatible with the character of the Alamo Square Landmark District as described in Appendix E of Article 10 of the Planning Code and the character-defining features specifically outlined in the designating ordinance.

THE SECRETARY OF THE INTERIOR'S STANDARDS

Rehabilitation is the act or process of making possible a compatible use for a property through repair, alterations, and additions while preserving those portions or features that convey its historical, cultural, or architectural values. The Rehabilitation Standards provide, in relevant part(s):

Standard 1. A property will be used as it was historically or be given a new use that requires minimal change to its distinctive materials, features, spaces, and spatial relationships.

2

The project would retain the historic residential use of the property.

Standard 2. The historic character of a property shall be retained and preserved. The removal of historic materials or alteration of features and spaces that characterize a property shall be avoided.

The historic character of the property would be retained. The only visible alterations would be at the front façade, where two existing basement level windows and a limited amount of siding would be removed to create a new garage opening. This new garage would not alter the massing and overall proportions of the subject building, nor would it be deeply recessed or project out from the façade. The garage door would be composed of painted wood, reflecting a ubiquitous material and finish within the District, and would possess simple detailing in order to maintain subordination to and differentiation from the historic façade. Condition of Approval No. 1 will ensure that the historic millwork in proximity to the new garage opening will be protected and preserved during construction. Although the historic landscape wall would be reconfigured to accommodate a driveway to the new garage, it would be retained at either end of the property and also include returns following the first several feet of the driveway. This adaptation of the landscape wall allows for the feature to be maintained but reincorporated as part of the building's evolution over time. Condition of Approval No. 2 will ensure that any new landscape wall that may need to be fabricated will match the historic in appearance, texture, and tooling. Planters will continue to be utilized at the front of the property, providing continuity from the historic conditions and enhancing the pedestrian experience. The new entry stair would utilize cast concrete treads and risers, but these would feature a bull-nosed edge to mimic the appearance of traditional wood steps, and the railing would be composed of painted wood with simple newel posts with curved edges. This simpler newel post will avoid creating a false sense of history without resulting in an overly differentiated condition. There would be no alterations to the existing west elevation, while those at the non-visible east elevation would be limited to new window and door openings and installation of associated painted wood windows and a door, as well as the removal of an entry portico. New skylights would be limited in number while being sufficiently setback, located off the ridgeline, and mounted low to the roof with a minimal curb. The opening at the rear of the first floor pop-out would be modified to accommodate a centered door, while the rear of the second level would be extended above said pop-out. A new brick wall at the west end of this horizontal addition would retain privacy, with the addition largely consisting of a glass solarium with a painted metal frame. None of these modifications would be visible from the public right-of-way, and would implement a more contemporary architectural language properly denoting the addition's period of construction.

Standard 3. Each property will be recognized as a physical record of its time, place, and use. Changes that create a false sense of historical development, such as adding conjectural features or elements from other historic properties, will not be undertaken.

The project would not create a false sense of historical development. The new garage door would be of a standard, contemporary design with exhaust louvers at the minimal required size and a simple trim would be utilized as the surround. The entry stair railing would be composed of painted wood

with simple newel posts with curved edges. This more simple post will avoid creating a false sense of history without resulting in an overly differentiated condition.

Standard 5. Distinctive materials, features, finishes, and construction techniques or examples of craftsmanship that characterize a property will be preserved.

No distinctive materials, features, finishes, or construction or craftsmanship examples that characterize the property would be removed. The only visible alterations would be at the front façade, where two existing basement level windows and a limited amount of siding would be removed to create a new garage opening. This new garage would not alter the massing and overall proportions of the subject building, nor would it be deeply recessed or project out from the façade. The garage door would be composed of painted wood, reflecting a ubiquitous material and finish within the District, and would possess simple detailing in order to maintain subordination to and differentiation from the historic façade. Condition of Approval No. 1 will ensure that the historic millwork in proximity to the new garage opening will be protected and preserved during construction. Although the historic landscape wall would be reconfigured to accommodate a driveway to the new garage, it would be retained at either end of the property and also include returns following the first several feet of the driveway. This adaptation of the landscape wall allows for the feature to be maintained but reincorporated as part of the building's evolution over time. Condition of Approval No. 2 will ensure that any new landscape wall that may need to be fabricated will match the historic in appearance, texture, and tooling. Planters will continue to be utilized at the front of the property, providing continuity from the historic conditions and enhancing the pedestrian experience. The new entry stair would utilize cast concrete treads and risers, but these would feature a bull-nosed edge to mimic the appearance of traditional wood steps, and the railing would be composed of painted wood with simple newel posts with curved edges. This simpler newel post will avoid creating a false sense of history without resulting in an overly differentiated condition.

Standard 9. New additions, exterior alterations, or related new construction will not destroy historic materials, features, and spatial relationships that characterize the property. The new work will be differentiated from the old and will be compatible with the historic materials, features, size, scale and proportion, and massing to protect the integrity of the property and its environment.

The only visible alterations would be at the front façade, where two existing basement level windows and a limited amount of siding would be removed to create a new garage opening. This new garage would not alter the massing and overall proportions of the subject building, nor would it be deeply recessed or project out from the façade. The garage door would be composed of painted wood, reflecting a ubiquitous material and finish within the District, and would possess simple detailing in order to maintain subordination to and differentiation from the historic façade. Condition of Approval No. 1 will ensure that the historic millwork in proximity to the new garage opening will be protected and preserved during construction. Although the historic landscape wall would be reconfigured to accommodate a driveway to the new garage, it would be retained at either end of the property and also include returns following the first several feet of the driveway. This adaptation of the landscape wall allows for the feature to be maintained but reincorporated as part

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Standard 10. New additions and adjacent or related new construction will be undertaken in such a manner that, if removed in the future, the essential form and integrity of the historic property and its environment would be unimpaired.

The new skylights, entry stairs, and rear addition could be removed in the future without harming the integrity of the historic property. Similarly, the garage opening at the basement level could be infilled with siding and windows matching the existing. All portions of the landscape wall that are intact after demolition will be retained and reincorporated; new fabric matching the historic in appearance, texture, and tooling will be used in the proposed project as needed and could also be employed to restore the original configuration in the future.

PUBLIC/NEIGHBORHOOD INPUT

The Department has received no public input on the project at the date of this report.

STAFF ANALYSIS

Based on the requirements of Article 10 and the Secretary of Interior's Standards, staff has determined that the proposed work is compatible with the character-defining features of the subject property and the Alamo Square Landmark District.

The project will retain the historic residential use and historic character of the buildings and landmark district. The only visible alterations would be at the front façade, where two existing basement level windows and a limited amount of siding would be removed to create a new garage opening. This new garage would not alter the massing and overall proportions of the subject building, nor would it be deeply recessed or project out from the façade. The garage door would be composed of painted wood, reflecting a ubiquitous material and finish within the District, and would possess simple detailing in

order to maintain subordination to and differentiation from the historic façade. Condition of Approval No. 1 will ensure that the historic millwork in proximity to the new garage opening will be protected and preserved during construction.

Although the historic landscape wall would be reconfigured to accommodate a driveway to the new garage, it would be retained at either end of the property and also include returns following the first several feet of the driveway. This adaptation of the landscape wall allows for the feature to be maintained but reincorporated as part of the building's evolution over time. Condition of Approval No. 2 will ensure that any new landscape wall that may need to be fabricated will match the historic in appearance, texture, and tooling. Planters will continue to be utilized at the front of the property, providing continuity from the historic conditions and enhancing the pedestrian experience.

The new entry stair would utilize cast concrete treads and risers, but these would feature a bull-nosed edge to mimic the appearance of traditional wood steps, and the railing would be composed of painted wood with simple newel posts with curved edges. This simpler newel post will avoid creating a false sense of history without resulting in an overly differentiated condition.

There would be no alterations to the existing west elevation, while those at the non-visible east elevation would be limited to new window and door openings and installation of associated painted wood windows and a door, as well as the removal of an entry portico. New skylights would be limited in number while being sufficiently setback, located off the ridgeline, and mounted low to the roof with a minimal curb.

The opening at the rear of the first floor pop-out would be modified to accommodate a centered door, while the rear of the second level would be extended above said pop-out. A new brick wall at the west end of this horizontal addition would retain privacy, with the addition largely consisting of a glass solarium with a painted metal frame. None of these modifications would be visible from the public right-of-way, and would implement a more contemporary architectural language properly denoting the addition's period of construction.

Staff therefore finds that the proposed work is compatible with the Alamo Square Landmark District and recommends approval, with conditions.

ENVIRONMENTAL REVIEW STATUS

The Planning Department has determined that the proposed project is exempt/excluded from environmental review, pursuant to CEQA Guideline Sections 15301 (Class One – Minor Alteration) because the project includes a minor alteration of an existing structure that meets the Secretary of the Interior's Standards.

PLANNING DEPARTMENT RECOMMENDATION

Planning Department staff recommends APPROVAL WITH CONDITIONS of the proposed project as it appears to meet the Secretary of the Interior Standards for Rehabilitation.

CONDITIONS OF APPROVAL

To ensure that the proposed work is undertaken in conformance with this Certificate of Appropriateness, staff recommends the following conditions:

- 1. As part of the Building Permit, the project sponsor shall provide to Planning Department preservation staff for review and approval a detailed construction protection plan concerning the preservation of historic millwork in proximity to the new garage opening.
- 2. As part of the Building Permit, the project sponsor shall contact Planning Department preservation staff for review and approval of an on-site mockup of any matching replacement material for the reconfigured landscape wall.

ATTACHMENTS

Draft Motion
Parcel Map
1998 Sanborn Map
Alamo Square Landmark District Map
Aerial Photograph
Zoning Map
Site Photographs
Project Plans

Historic Preservation Commission Motion No.

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40-X Height and Bulk District

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ADOPTING FINDINGS FOR A CERTIFICATE OF APPROPRIATENESS FOR PROPOSED WORK DETERMINED TO BE APPROPRIATE FOR AND CONSISTENT WITH THE PURPOSES OF ARTICLE 10, TO MEET THE STANDARDS OF ARTICLE 10 AND TO MEET THE SECRETARY OF INTERIOR'S STANDARDS FOR REHABILITATION, FOR THE PROPERTY LOCATED ON LOT 025 IN ASSESSOR'S BLOCK 0776, WITHIN A RH-3 (RESIDENTIAL-HOUSE, THREE FAMILY) ZONING DISTRICT, A 40-X HEIGHT AND BULK DISTRICT, AND THE ALAMO SQUARE LANDMARK DISTRICT.

PREAMBLE

WHEREAS, on May 9, 2018 Brian Milford ("Project Sponsor") filed an application with the San Francisco Planning Department (hereinafter "Department") for a Certificate of Appropriateness for exterior and interior alterations of the subject property including: insertion of a garage and garage door at the basement level, removal of two double-hung windows on the front façade, alterations to the existing front landscape wall, new landscaping at the front and rear, replacement of the entry stair and door, and a second floor horizontal addition at the rear above an existing first floor pop-out.

WHEREAS, the Project was determined by the Department to be categorically exempt from environmental review. The Historic Preservation Commission ("Commission") has reviewed and concurs with said determination.

WHEREAS, on Septmebr 19, 2018, the Commission conducted a duly noticed public hearing on the current project, Case No. 2018-002272COA (Project) for its appropriateness.

Motion No. XXXX Hearing Date: September 19, 2018

WHEREAS, in reviewing the Application, the Commission has had available for its review and consideration case reports, plans, and other materials pertaining to the Project contained in the Department's case files, has reviewed and heard testimony and received materials from interested parties during the public hearing on the Project.

MOVED, that the Commission hereby grants the Certificate of Appropriateness, in conformance with the architectural plans labeled Exhibit A on file in the docket for Case 2018-002272COA based on the following conditions and findings:

CONDITIONS

- 1. As part of the Building Permit, the project sponsor shall provide to Planning Department preservation staff for review and approval a detailed construction protection plan concerning the preservation of historic millwork in proximity to the new garage opening.
- 2. As part of the Building Permit, the project sponsor shall contact Planning Department preservation staff for review and approval of an on-site mockup of any matching replacement material for the reconfigured landscape wall.

FINDINGS

Having reviewed all the materials identified in the recitals above and having heard oral testimony and arguments, this Commission finds, concludes, and determines as follows:

- 1. The above recitals are accurate and also constitute findings of the Commission.
- 2. Findings pursuant to Article 10:

The Historic Preservation Commission has determined that the proposed work is compatible with the character of the landmark as described in the designation report.

- The project will retain the existing single-family residential use of the building.
- The project will cause minimal changes to the form of the building with alterations to character-defining features limited to the insertion of a garage at the front façade and the corresponding removal of two windows, as well as modifications to the configuration of the front landscape wall.
- All historic millwork in proximity to the new garage opening will be protected and preserved during construction.
- All new windows and doors will be painted wood, which is appropriate to the subject building as well as a character-defining feature throughout the District.

SAN FRANCISCO
PLANNING DEPARTMENT 2

CASE NO 2018-002272COA 1513 Golden Gate Avenue

Motion No. XXXX Hearing Date: September 19, 2018

- The new stairs will have concrete treads and risers with a bull-nosed edge to mimic wood steps, whiel the new railing will be composed of wood spindles and simple newel posts with curved edges.
- Any new material required for the reconfigured landscape wall will match the existing in appearance, texture, and tooling.
- The proposed project meets the requirements of Article 10, Appendix E of the Planning Code.
- The proposed project meets the following *Secretary of Interior's Standards for Rehabilitation*:

Standard 1.

A property shall be used for its historic purpose or be placed in a new use that requires minimal change to the defining characteristics of the building and its site and environment.

Standard 2.

The historic character of a property shall be retained and preserved. The removal of historic materials or alteration of features and spaces that characterize a property shall be avoided.

Standard 3.

Each property will be recognized as a physical record of its time, place, and use. Changes that create a false sense of historical development, such as adding conjectural features or elements from other historic properties, will not be undertaken.

Standard 5.

Distinctive features, finishes, and construction techniques or examples of craftsmanship that characterize a property shall be preserved.

Standard 9.

New additions, exterior alterations, or related new construction will not destroy historic materials, features, and spatial relationships that characterize the property. The new work will be differentiated from the old and will be compatible with the historic materials, features, size, scale and proportion, and massing to protect the integrity of the property and its environment.

Standard 10.

New additions and adjacent or related new construction shall be undertaken in such a manner that if removed in the future, the essential form and integrity of the historic property and its environment would be unimpaired.

3. **General Plan Compliance.** The proposed Certificate of Appropriateness is, on balance, consistent with the following Objectives and Policies of the General Plan:

I. URBAN DESIGN ELEMENT

THE URBAN DESIGN ELEMENT CONCERNS THE PHYSICAL CHARACTER AND ORDER OF THE CITY, AND THE RELATIONSHIP BETWEEN PEOPLE AND THEIR ENVIRONMENT.

SAN FRANCISCO
PLANNING DEPARTMENT

Motion No. XXXX Hearing Date: September 19, 2018

GOALS

The Urban Design Element is concerned both with development and with preservation. It is a concerted effort to recognize the positive attributes of the city, to enhance and conserve those attributes, and to improve the living environment where it is less than satisfactory. The Plan is a definition of quality, a definition based upon human needs.

OBJECTIVE 1

EMPHASIS OF THE CHARACTERISTIC PATTERN WHICH GIVES TO THE CITY AND ITS NEIGHBORHOODS AN IMAGE, A SENSE OF PURPOSE, AND A MEANS OF ORIENTATION.

POLICY 1.3

Recognize that buildings, when seen together, produce a total effect that characterizes the city and its districts.

OBJECTIVE 2

CONSERVATION OF RESOURCES WHICH PROVIDE A SENSE OF NATURE, CONTINUITY WITH THE PAST, AND FREEDOM FROM OVERCROWDING.

POLICY 2.4

Preserve notable landmarks and areas of historic, architectural or aesthetic value, and promote the preservation of other buildings and features that provide continuity with past development.

POLICY 2.5

Use care in remodeling of older buildings, in order to enhance rather than weaken the original character of such buildings.

POLICY 2.7

Recognize and protect outstanding and unique areas that contribute in an extraordinary degree to San Francisco's visual form and character.

The goal of a Certificate of Appropriateness is to provide additional oversight for buildings and districts that are architecturally or culturally significant to the City in order to protect the qualities that are associated with that significance.

The proposed project qualifies for a Certificate of Appropriateness and therefore furthers these policies and objectives by maintaining and preserving the character-defining features of the contributory property and landmark district for the future enjoyment and education of San Francisco residents and visitors.

4. The proposed project is generally consistent with the eight General Plan priority policies set forth in Section 101.1 in that:

Motion No. XXXX Hearing Date: September 19, 2018

CASE NO 2018-002272COA 1513 Golden Gate Avenue

- A) The existing neighborhood-serving retail uses will be preserved and enhanced and future opportunities for resident employment in and ownership of such businesses will be enhanced:
 - The proposed project is for the rehabilitation of a residential property and will not have any effect on neighborhood-serving retail uses.
- B) The existing housing and neighborhood character will be conserved and protected in order to preserve the cultural and economic diversity of our neighborhoods:
 - The proposed project will strengthen neighborhood character by respecting the character-defining features of the site and landmark district in conformance with the Secretary of the Interior's Standards.
- C) The City's supply of affordable housing will be preserved and enhanced:
 - The project will not reduce the affordable housing supply as the existing single-family residential use will not be changed.
- D) The commuter traffic will not impede MUNI transit service or overburden our streets or neighborhood parking:
 - The proposed project will not result in commuter traffic impeding MUNI transit service or overburdening the streets or neighborhood parking.
- E) A diverse economic base will be maintained by protecting our industrial and service sectors from displacement due to commercial office development. And future opportunities for resident employment and ownership in these sectors will be enhanced:
 - The proposed project will not have any impact on industrial and service sector jobs.
- F) The City will achieve the greatest possible preparedness to protect against injury and loss of life in an earthquake.
 - Preparedness against injury and loss of life in an earthquake will be improved by the proposed work. The work will be executed in compliance with all applicable construction and safety measures.
- G) That landmark and historic buildings will be preserved:
 - The proposed project is in conformance with Article 10 of the Planning Code and the Secretary of the Interior's Standards.
- H) Parks and open space and their access to sunlight and vistas will be protected from development:

SAN FRANCISCO
PLANNING DEPARTMENT

Motion No. XXXX CASE NO 2018-002272COA Hearing Date: September 19, 2018 1513 Golden Gate Avenue

The proposed project will not impact the access to sunlight or vistas for the parks and open space.

5. For these reasons, the proposal overall, is appropriate for and consistent with the purposes of Article 10, meets the standards of Article 10, and the Secretary of Interior's Standards for Rehabilitation, General Plan and Prop M findings of the Planning Code.

SAN FRANCISCO
PLANNING DEPARTMENT

Motion No. XXXX Hearing Date: September 19, 2018

DECISION

That based upon the Record, the submissions by the Applicant, the staff of the Department and other interested parties, the oral testimony presented to this Commission at the public hearings, and all other written materials submitted by all parties, the Commission hereby **APPROVES WITH CONDITIONS a Certificate of Appropriateness** for the property located at Lot 025 in Assessor's Block 0776 for proposed work in conformance with the renderings and architectural sketches labeled Exhibit A on file in the docket for Case No. 2018-002272COA.

APPEAL AND EFFECTIVE DATE OF MOTION: The Commission's decision on a Certificate of Appropriateness shall be final unless appealed within thirty (30) days. Any appeal shall be made to the Board of Appeals, unless the proposed project requires Board of Supervisors approval or is appealed to the Board of Supervisors as a conditional use, in which case any appeal shall be made to the Board of Supervisors (see Charter Section 4.135).

Duration of this Certificate of Appropriateness: This Certificate of Appropriateness is issued pursuant to Article 10 of the Planning Code and is valid for a period of three (3) years from the effective date of approval by the Historic Preservation Commission. The authorization and right vested by virtue of this action shall be deemed void and canceled if, within 3 years of the date of this Motion, a site permit or building permit for the Project has not been secured by Project Sponsor.

THIS IS NOT A PERMIT TO COMMENCE ANY WORK OR CHANGE OF OCCUPANCY UNLESS NO BUILDING PERMIT IS REQUIRED. PERMITS FROM THE DEPARTMENT OF BUILDING INSPECTION (and any other appropriate agencies) MUST BE SECURED BEFORE WORK IS STARTED OR OCCUPANCY IS CHANGED.

I hereby certify that the Historical Preservation Commission ADOPTED the foregoing Motion on September 19, 2018.

Jonas P. Ionin Commission Secretary


AYES: X

NAYS: X

ABSENT: X

ADOPTED: September 19, 2018

Parcel Map

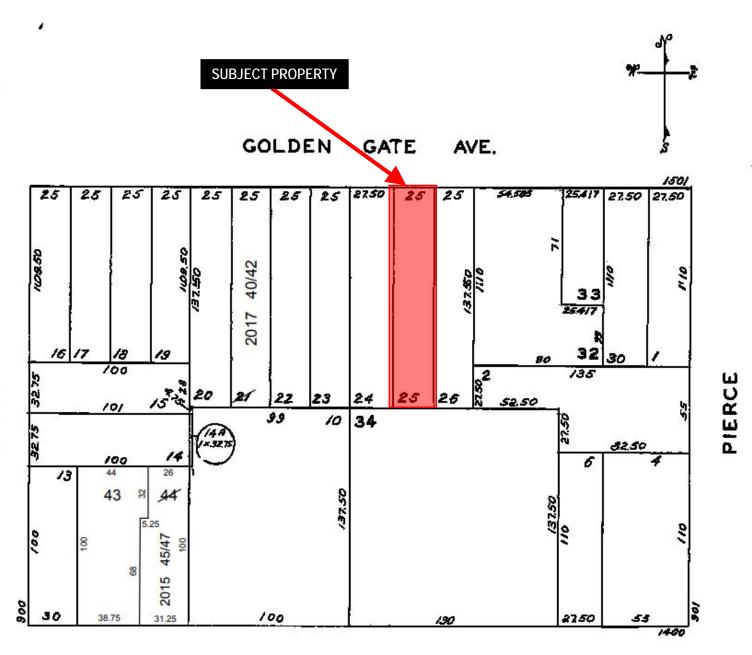


Mc ALLISTER



Certificate of Appropriateness **Case Number 2018-002272COA** 1513 Golden Gate Avenue

SCOTT

Sanborn Map*

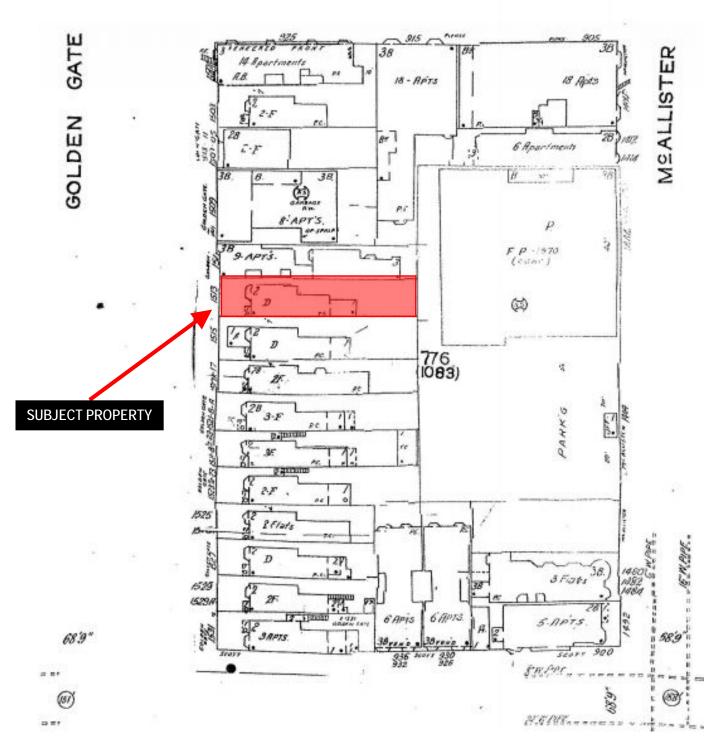

*The Sanborn Maps in San Francisco have not been updated since 1998, and this map may not accurately reflect existing conditions.



Certificate of Appropriateness **Case Number 2018-002272COA**1513 Golden Gate Avenue

Alamo Square Landmark District

ALAMO SQUARE HISTORIC DISTRICT






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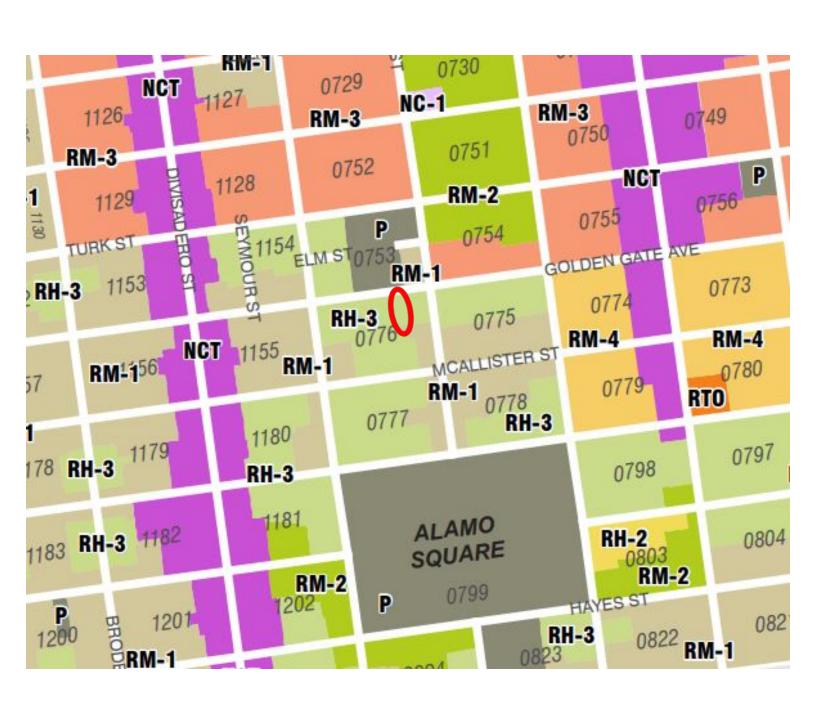
Aerial Photograph


SUBJECT PROPERTY



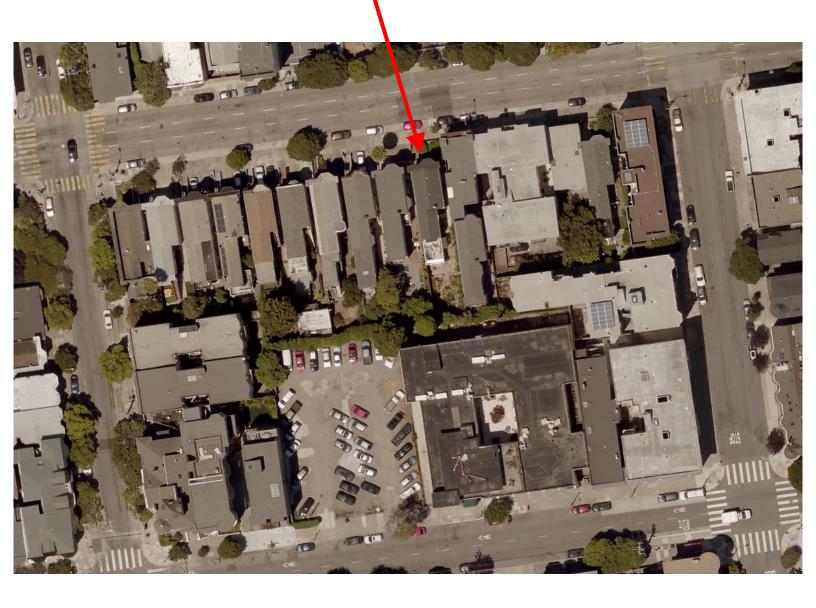


Zoning Map



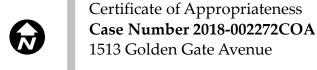

Site Photo

SUBJECT PROPERTY

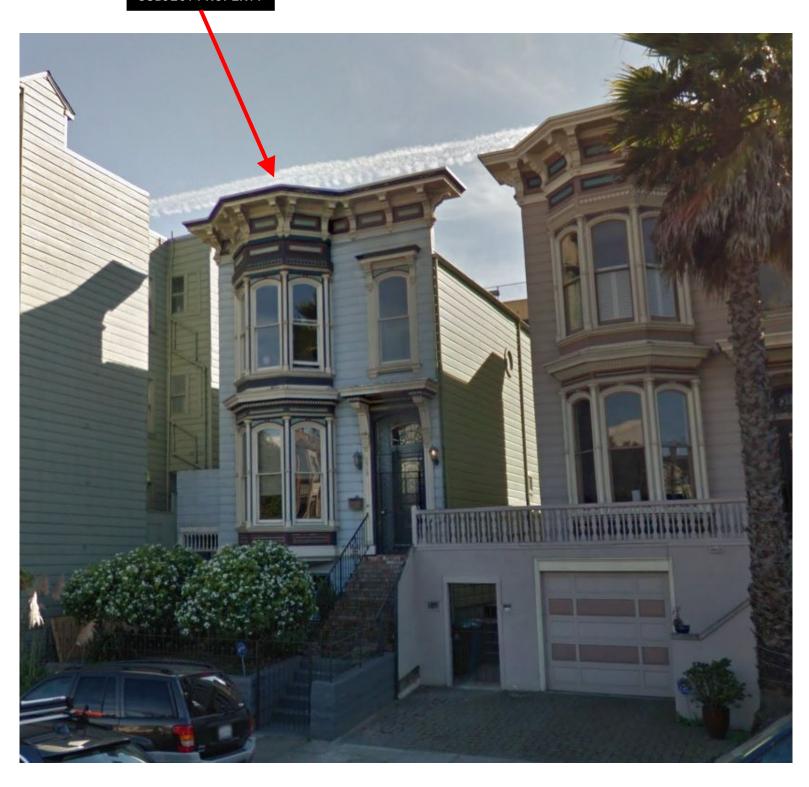

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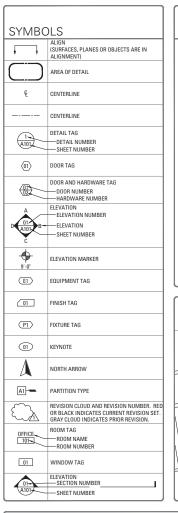
Site Photo




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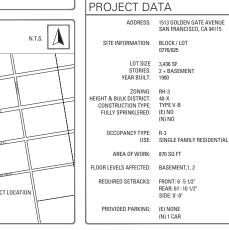




N.T.S. LOCATION MAP

1513 GOLDEN GATE AVENUE GARAGE ADDITION

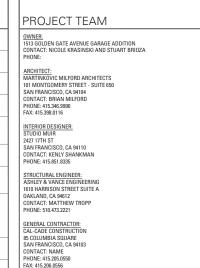1513 GOLDEN GATE AVENUE SAN FRANCISCO, CALIFORNIA 94115




SCOPE OF WORK

SCOPE OF WORK INCLUDES REMOVAL OF FRONT IDSCAPING AND RETAINING WALLS TO INCORPORATE NEW DRIVEWAY AND RECONFIGURED FRONT ENTRY STAIRS EXISTING BASEMENT STORAGE IS TO BE CONVERTED INTO NEW GARAGE WITH MINOR EXCAVATION, WORK AT THE FIRST FLOOR TO INCLUDE RELOCATED WINDOWS AND DOORS AT REAR ONLY, WORK AT SECOND FLOOR TO INCLUDE HORIZONTAL ADDITION AT REAR ABOVE EXISTING FIRST FLOOR AND AND CONVERTING EXISTING FLAT ROOF TO NEW ROOF DECK. EXTERIOR WORK INCLUDES A NEW GARAGE DOOR AT FRONT FACADE AND NEW WINDOWS AND DOORS AT REAR AND EAST FACADE AT FIRST AND SECOND FLOOR.

DEFERRED SUBMITTAL

DEFERRED SUBMITTALS & COORDINATING SCOPE O

MECHANICA STRUCTURAL ENGINEERING PLUMBING LANDSCAPING FIRE ALARM FLECTRICAL TITLE 24 CIVIL ENGINEERING

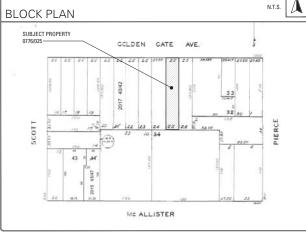

DRAWING INDEX 1513 GOLDEN GATE **AVENUE GARAGE** INCLUDED AND REVISED **ADDITION**

DRAWING TITLE

A002 EXISTING SITE PLAN

A003 PROPOSED SITE PLAN

A004 EXISTING SITE PHOTOGRAPH:

A004a SECTION 1005(f) CALCULATIONS

A004b SECTION 1005(f) CALCULATIONS

A004c SECTION 1005(f) CALCULATIONS

A100 DEMOLITION & CONSTRUCTION NOTES

A112 SECOND FLOOR CONSTRUCTION PLAN

A201 EXTERIOR ELEVATIONS

A202 EXTERIOR ELEVATIONS

A203 EXTERIOR ELEVATIONS

A301 BUILDING SECTIONS A901 SCHEDULES


A102 SECOND FLOOR EXISTING & DEMOLITION PLAN

A111 BASEMENT & FIRST FLOOR CONSTRUCTION PLAN

A101 BASEMENT & FIRST FLOOR EXISTING & DEMOLITION PLAN

A001 TITLE SHEET

1513 GOLDEN GATE AVENUE SAN FRANCISCO, CA 94115

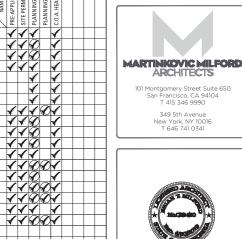

349 5th Avenue New York, NY 10016 T 646 741 0341



ABBREVIATIONS




APPLICABLE CODES


2016 CALIFORNIA BUILLINIS CUDE
2016 CALIFORNIA ELECTRICAL CODE
2016 CALIFORNIA MECHANICAL CODE
2016 CALIFORNIA PLUMBING CODE
2016 CALIFORNIA FIRE CODE
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2016 CALIFORNIA GREEN BUILLINIS CODE


SIDE: 0'-0"

ADDRESS: 1513 GOLDEN GATE AVENUE SAN FRANCISCO, CA 94115

2016 SAN FRANCISCO BUILDING CODE AMENDMENTS

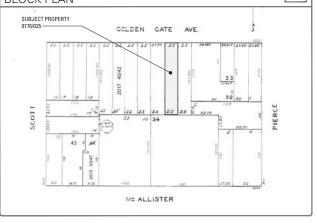

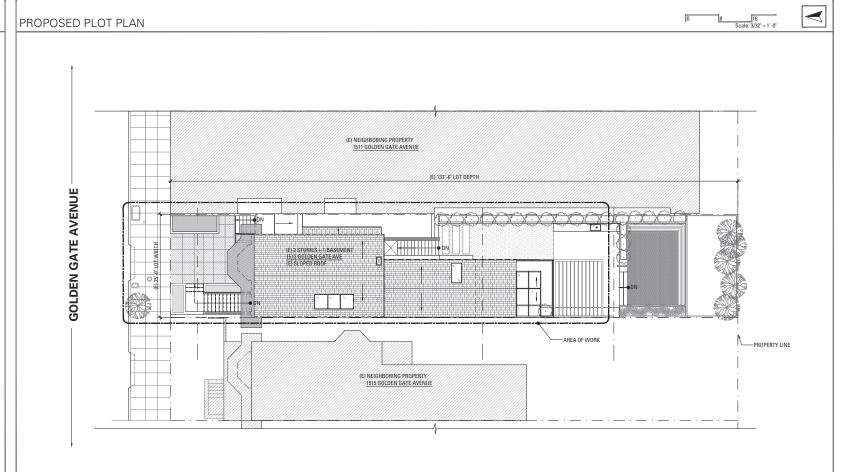

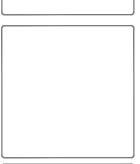

NO.	RECORD OF DRAWING ISSUANCE	DATE
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1	PRE-APPLICATION MEETING	12.19.2
2	SITE PERMIT SET	01.03.2
3	PLANNING RESPONSE 1	06.05.2
4	PLANNING RESPONSE 2	07.23.2
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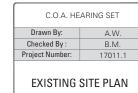



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3	PLANNING RESPONSE 1	06.05.2
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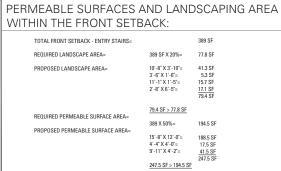
4 PLANNING RESPONSE 5 C.O.A. HEARING SET

ET 09.07.2018







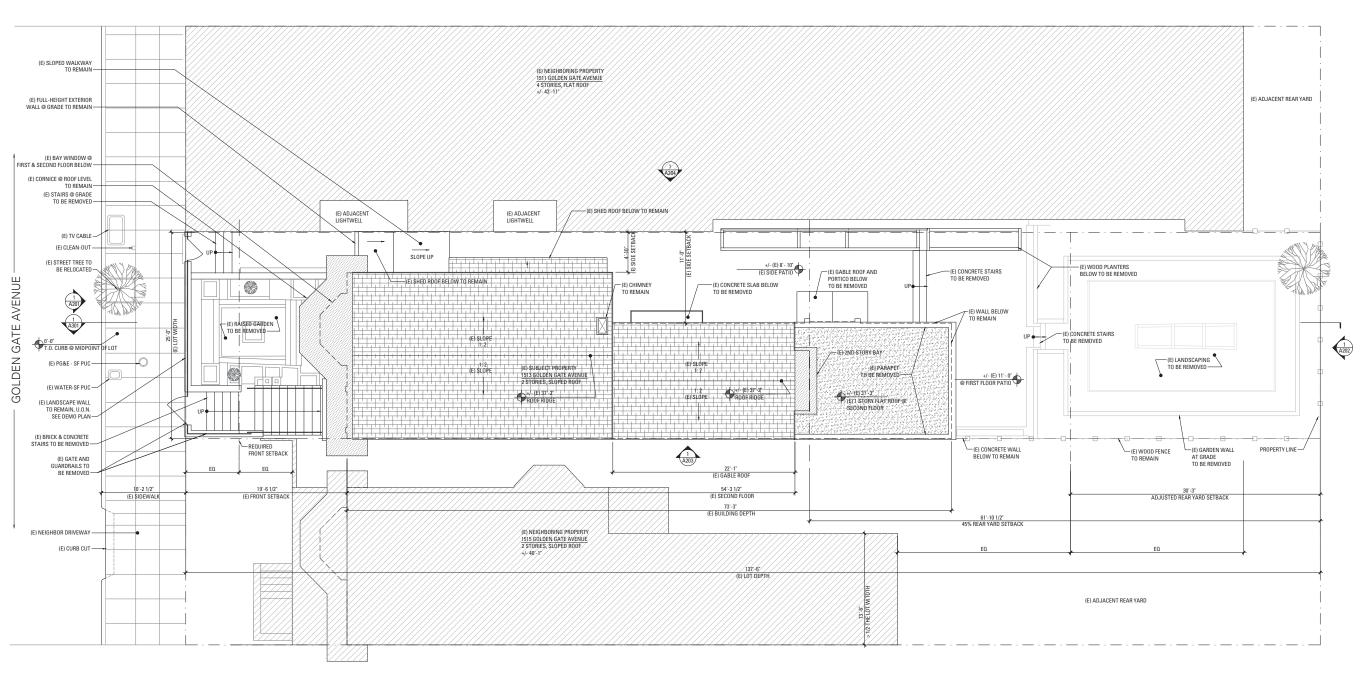

1513 GOLDEN GATE **AVENUE GARAGE ADDITION**

1513 GOLDEN GATE AVENUE SAN FRANCISCO, CA 94115



101 Montgomery Street Suite 650 San Francisco, CA 94104 T 415 346 9990

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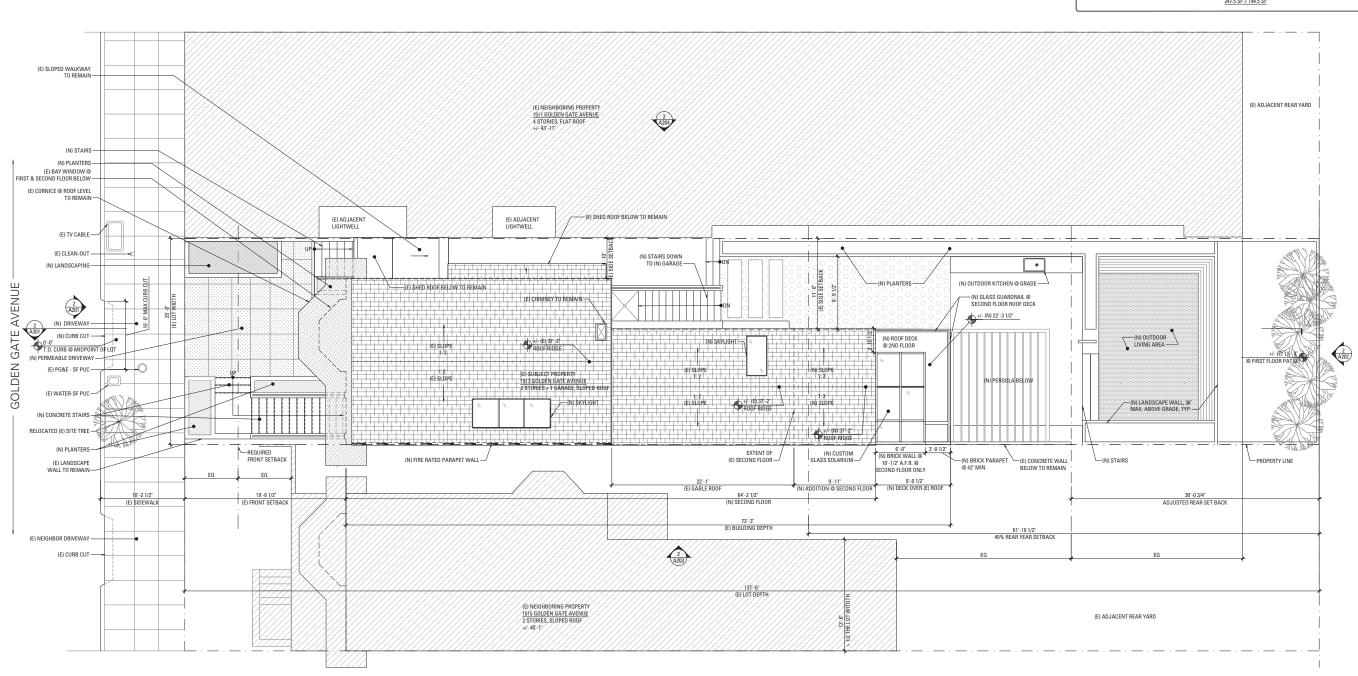
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	PRE-APPLICATION MEETING	12.19.201
	SITE PERMIT SET	01.03.201
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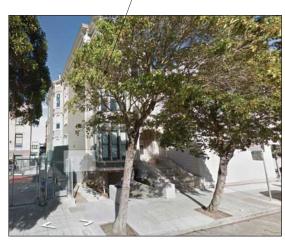
Drawn By: A.W.					
Checked By:	B.M.				
Project Number:	17011.1				

PROPOSED SITE PLAN









- 1502 GOLDEN GATE AVENUE

1513 GOLDEN GATE AVENUE GARAGE ADDITION

> 1513 GOLDEN GATE AVENUE SAN FRANCISCO, CA 94115



101 Montgomery Street Suite 650 San Francisco, CA 94104 T 415 346 9990

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(E) SITE PHOTOS - GOLDEN GATE AVENUE STREET VIEWS (ACROSS FROM SUBJECT PROPERTY)

SCALE: N.T.S.



(E) SITE PHOTOS - GOLDEN GATE AVENUE STREET VIEWS





— 1513 GOLDEN GATE (SUBJECT PROPERTY)





(E) SITE PHOTOS - BACKYARD VIEWS

N	O. RECORD OF DRAWING ISSUANCE	DATE
[1	PRE-APPLICATION MEETING	12.19.2
2	SITE PERMIT SET	01.03.2
3	PLANNING RESPONSE 1	06.05.2
4	PLANNING RESPONSE 2	07.23.2


C.O.A. HEARING SET

C.O.A. HEARING SET					
Drawn By:	A.W.				
Checked By:	B.M.				
Project Number:	17011.1				

PHOTOGRAPHS

A004

(E) SITE PHOTOS - OVERHEAD CONTEXT PHOTO SCALE N.T.S.

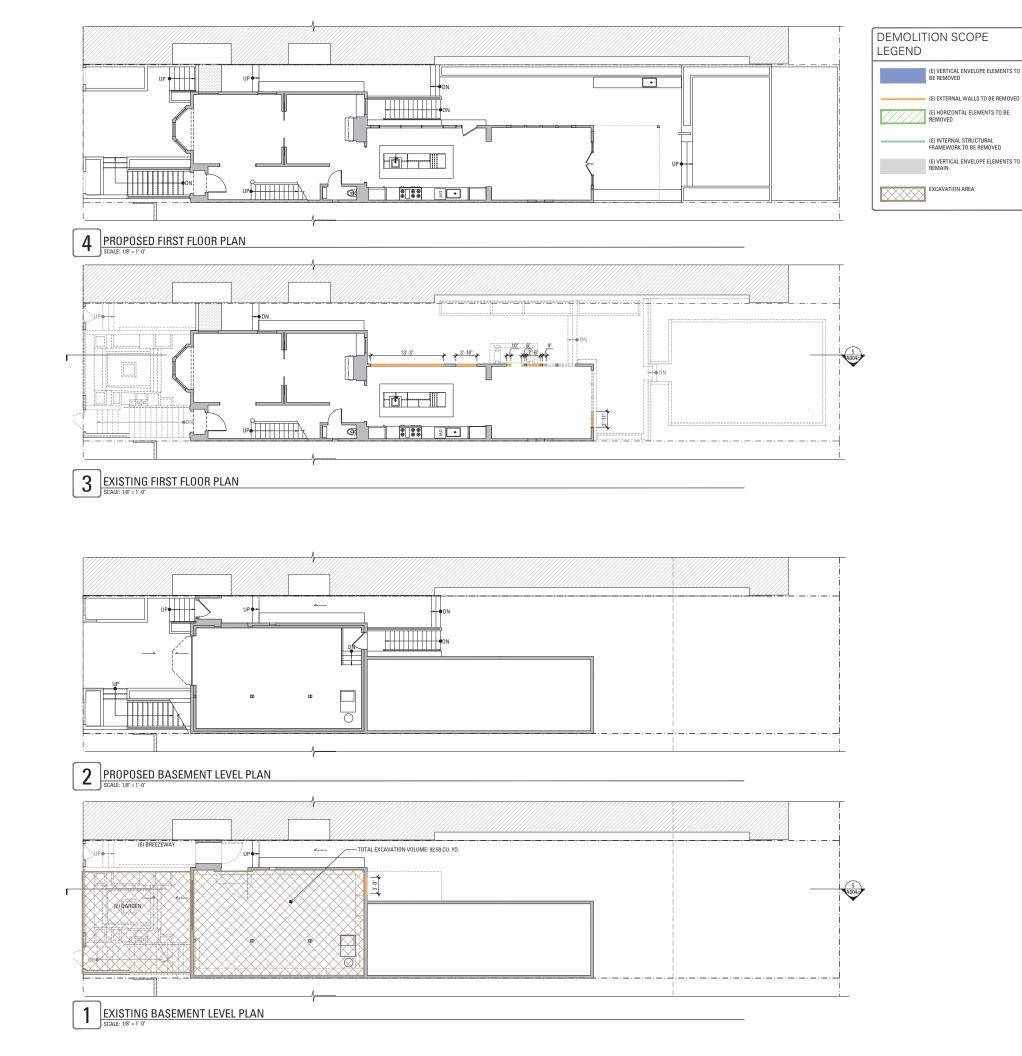

1513 GOLDEN GATE AVENUE GARAGE ADDITION


> 1513 GOLDEN GATE AVENUE SAN FRANCISCO, CA 94115



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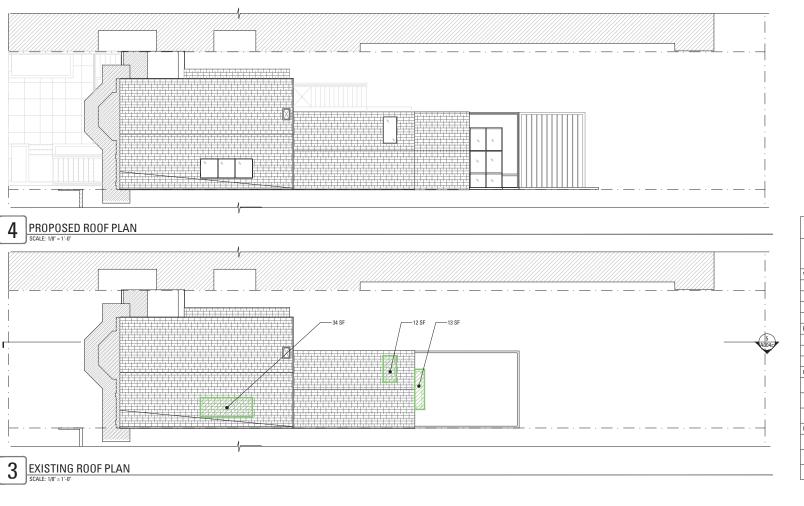



4 PLANNING RESPONSE 5 C.O.A. HEARING SET

09.07.2018

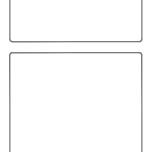C.O.A. HEARING SET					
Drawn By: A.W.					
Checked By: B.M.					
Project Number: 17011.1					
Section 1005(f) Calculations					

A004a



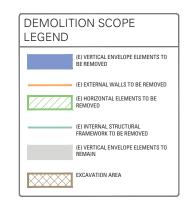

1513 GOLDEN GAT
AVENUE GARAGE
ADDITION


1513 GOLDEN GATE AVENUE SAN FRANCISCO, CA 94115



101 Montgomery Street Suite 650 San Francisco, CA 94104 T 415 346 9990 349 5th Avenue New York, NY 10016 T 646 741 0341




DEMOLITION CALCULATIONS TABLE							
REMOVAL OF ELEMENTS	DEMOLITION AREA OR LINEAR FT	SECTION 1005 LIMITS	EXISTING PROJECT TOTAL SF OR LINEAR FT	PROPOSED PROJECT TOTAL %	PROPOSED PROJECT TOTAL SF OR LINEAR FT	MEET PLANNING CODE?	LEGEND
VERTICAL ENVELOPE ELEMENTS (s.f. of surface area)							
FRONT ELEVATION	27 sf	500/					
REAR ELEVATION	89 sf	50% or more (function as	4.128 sf	6%	248 sf	YES	
EAST ELEVATION	116 sf	external walls) OR	4,120 51	070 Z46 SI	TES		
WEST ELEVATION	16 sf	UK					
EXTERNAL WALLS (used for	external <u>or</u> interna	l wall functions)					
BASEMENT LEVEL	3'-0"						1
FIRST FLOOR	23'-7"	25% or more OR	25% or more OR 526'-2"	8% 42'-9"	YES		
SECOND FLOOR	15'-2"	1					
HORIZONTAL ELEMENTS (ro	of area, floor plate:	s, except at/below ç	grade)				
FIRST FLOOR	0 sf	75% or more (combined					
SECOND FLOOR	0 sf	internal structural frame	3,220 sf	2%	59 sf	YES	
ROOF	59 sf	work or floor plates)					
INTERNAL STRUCTURAL FRA	AMEWORK (interior	r partitions, etc.)					
BASEMENT LEVEL	0'-0"	75% or more (combined					
FIRST FLOOR	0'-0"	internal structural frame	ural frame 281'-7"	9%	24'-4"	YES	
SECOND FLOOR	24'-4"	work or floor plates)					

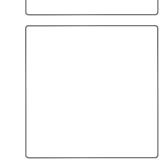


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3	PLANNING RESPONSE 1	06.05.201
4	PLANNING RESPONSE 2	07.23.201
5	C.O.A. HEARING SET	09.07.201



C.O.A. HE	ARING SET
Drawn By:	A.W.
Checked By:	B.M.
Project Number:	17011.1
Section	1111115(†)
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12.19.2017 01.03.2018

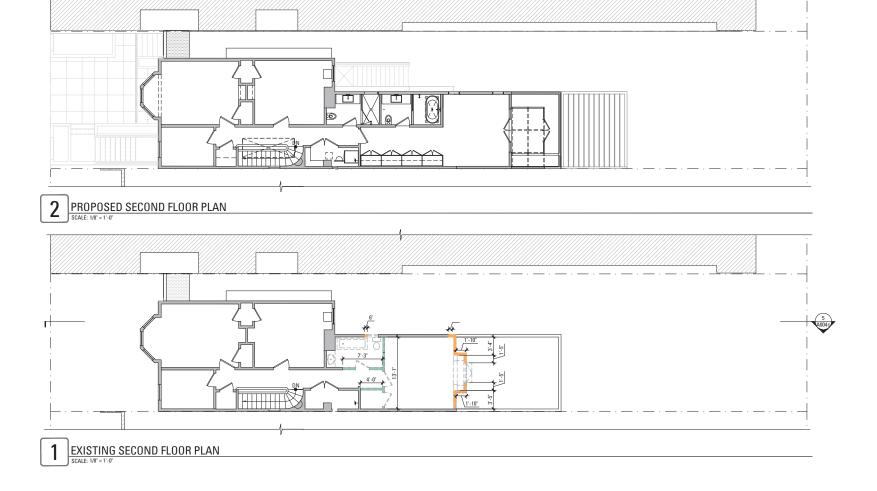06.05.2018

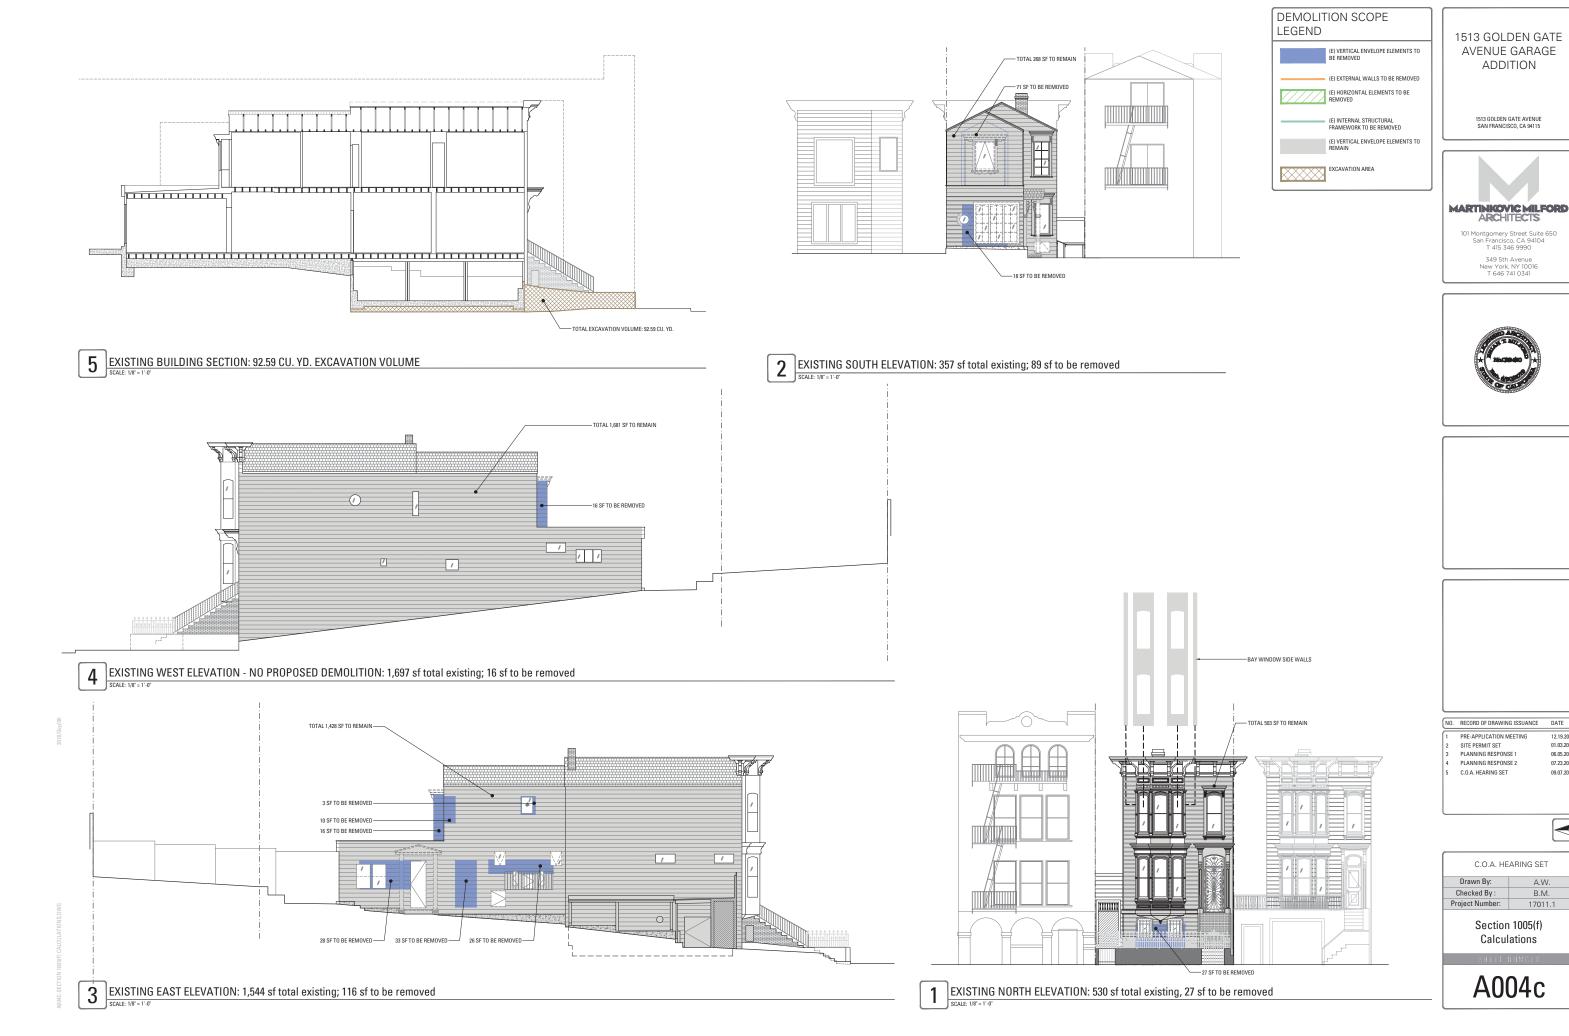07.23.2018 09.07.2018

A.W.

CONSTRUCTION **GENERAL NOTES**

- ALL (N) WALLS TYPE "A" U.O.N. SEE SCHEDULE, A901. ALL DIMENSIONS ARE TO FACE OF FINISH, CENTERLINE OF OPENING OR EDGE OF JAMB FRAME, U.O.N.
- DOORS NOT LOCATED BY DIMENSION SHALL BE PLACED 3" OFF JAMB, U.O.N.
- PLACED 3' OFF. JAMB, U.O.N.
 ALL REQUIRED HANDRAILS SHALL COMPLY WITH
 HANDRAIL GRASPABILITY PER CBC 1012.3.
 PROVIDE 8. INSTALLE HASHING, COUNTERFLASHING,
 CAP FLASHING, METAL TRIM, OTHER FASRICATED
 ITEMS AND MISCELLANEOUS SHEET METALWORK AT
 JUNCTIONS OF A ROOF AND WALL AT CHIMNEYS,
 OWER EVENES TO ROORS AND WALL AT CHIMNEYS. OVER EXPOSED DOORS AND WINDOWS, AT CHANGES
 OF SIDING MATERIAL IN ROOF VALLEYS OR WHERE
 REQUIRED TO PROVIDE COMPLETE WATERTIGHT AND

- REQUIRED TO PROVIDE COMPLETE WATERTIGHT AND WATERPROF CONSTRUCTION. PROVIDE & INSTALL ONE PIECE GSM PAN FLASHING AT ALL NEW AND REPLACEMENT EXTERIOR DOODS. COMPLY WITH ASTM 2211207, STANDARD PRACTICE FOR INSTALLATION OF EXTERIOR WINDOWS, DOORS, AND SKYLIGHTS. SHALL OVERLAP FLASHINGS FOR POSITIVE ORBAINAGE AT ALL CONDITIONS. FLASHING & SHEET METALLWORK SHALL BE FABRICATED AND INSTALLED IN ACCORDANCE WITH SHEET METAL & AIR CONDITIONING CONTRACTORS NATIONAL ASSOCIATION (SMACNA) ARCHITECTURAL SHEET METAL & AIR CONDITIONING CONTRACTORS NATIONAL ASSOCIATION (SINGEMENT) AS SPECIFIED IN SMACNA ARCHITECTURAL SHEET METAL MANUAL COMPLY WITH MINIMUM THICKNESS OR GAGE REQUIREMENTS AS SPECIFIED IN SMACNA ARCHITECTURAL SHEET METAL MANUAL ISOLATE AND PROTECT DISSIMILAR METALS FROM CONTRACT WITH EACH OTHER THE APPLYING SPECIFIED ISOLATION MATERIAL TO CONTACT SURFACES.
- PROTECT SURFACES OF SHEET METAL IN CONTACT WITH CONCRETE, TREATED WOOD, OR ALUMINUM WITH A HEAVY COATING OF BITUMINOUS PAINT AS RECOMMENDED BY MANUFACTURER/FABRICATOR
- FLASHING & SHEET METALWORK WILL NOT BE MEASURED SEPARATELY FOR PAYMENT BUT WILL BE PAID FOR AS PART OF THE CONTRACT LUMP SUM PRICE FOR ARCHITECTURAL WORK. PROVIDE MINIMUM OF R-13 BATT INSULATION IN
- EXTERIOR WALLS ADJACENT TO (N) AND (E) LIVING SPACE, IN AREAS NOT ALREADY INSULATED PROVIDE CEMENT BOARD BACKING IN AREAS TO RECEIVE TILE FINISH
- WOOD LOCATED NEARER THAN 6" TO EARTH SHALL BE
- TREATED WOOD
 ALL DOORS AND WINDOWS NOT TAGGED ARE
- EXISTING TO REMAIN U.O.N.
 ALL TOILETS TO HAVE A MINIMUM CLEARANCE OF 24'
 IN FRONT AND 15' FROM CENTERLINE OF THE TOILET TO
- EACH SIDE.

 STAIRWAYS SHALL HAVE A MINIMUM HEADROOM
 CLEARANCE OF 80 INCHES ABOVE THE FRONT EDGE OF
- CLEARANCE OF BUTTH OUTCK ACTING VALVES

 ALL APPLIANCES WITH OUTCK ACTING VALVES

 INCLUDING BUT NOT LIMITED TO DISHWASHERS &
 CLOTHES WASHERS, SHALL HAVE WATER HAMMER
 ARRESTORS (DC 608-10)

 ALL EXISTING NON-COMPLIANT AND NEW PLUMBING
 FIXTURES SHALL COMPLY WITH CALIFORNIA SB-407

 (2006)

- FIXTURES SHALL COMPLY WITH CALIFORNIA SB-407 (2009)

 WATER HEATERS SHALL HAVE SEISMIC STRAPPING AT A POINT WITHIN THE UPPER IT SAND THE LOWER 12 OF THE WATER HEATERS VERTICAL DIMENSIONS. AT THE LOWER POINT, A MINIMUM DISTANCE OF FOUR 10 (INCRES SHALL BE MAINTAINED ABOVE THE CONTROLS THE LOWER POINT, A MINIMUM DISTANCE OF FOUR 11 (INCRES SHALL BE MAINTAINED ABOVE THE CONTROLS THE SHALL BE MAINTAINED ABOVE THE CONTROLS WITH A METAL VERTILLATING 2000. A VERTILLATION (2000. A VERTILLATION (2000.) A VERTI

- 22 INCHES BY 30 INCHES. (CPC 508.4)
 APPLIANCES IN ATTIC AND UNDER-FLOOR SPACES
 SHALL HAVE A SOLID FLOOR PASSAGEWAY OF NOT LESS THAN 24 INCHES AND A WORK PLATFORM OF NOT LESS THAN 30 INCHES BY 30 INCHES IN FRONT OF THE SERVICE SIDE OF THE APPLIANCE, (CPC 508.4.2.8)
- APPLIANCES IN ATTIC AND LINDER-FLOOR SPACES APPLIANCES IN A THE AND UNDER-FLUOR SPACES
 SHALL HAVE A PERMANENT 120-VOLT RECEPTACLE
 OUTLET AND A LIGHTING FIXTURE NEAR THE
 APPLIANCE. (CPC 508.4.4)

MECHANICAL **GENERAL NOTES**

- ENVIRONMENTAL AIR DUCTS TERMINATE 3' FROM PROPERTY LINE & OPENINGS INTO BUILDING. PROVIDE GAS VENT TERMINATIONS PER CMC 802.6 &
- PROVIDE COMBUSTION AIR PER CMC CHAPTER 7. PROVIDE SPACE HEATING TO ALL INTERIOR SPACES INTENDED FOR HUMAN OCCUPANCY.

LEGEND

======== (E) CONSTRUCTION TO BE REMOVED

INDICATES RATED ASSEMBLY.
SEE SHEET A901.

(N) SOUND ATTENUATION BATT INSULATION

(N) GAS SHUT OFF; LOCATE IN ACCESSIBLE AREA IN CABINET [CMC 1312.3]

NOTE: ALL (N) WALLS TYPE "A" U.O.N.

EXISTING & **DEMOLITION NOTES**

- CONTRACTOR SHALL COORDINATE THE EXTENT OF THE EMOLITION WITH CONSTRUCTION PLANS AND PROT ALL PORTIONS OF (E) STRUCTURE TO REMAIN
- REMOVE ALL (E) FINISHES, HARDWARE, EQUIPMENT, CONDUIT, PLUMBING, AND FRAMING NECESSARY TO ACCOMMODATE ALL NEW WORK
- CAP OFF ALL PLUMBING, GAS, & ELECTRICAL LINES AS
- CONTRACTOR SHALL ENSURE THE STABILITY OF ALL (E) STRUCTURE, FRAMING AND FOUNDATIONS TO REMAIN DURING DEMOLITION AND CONSTRUCTION OF NEW CONTRACTOR SHALL REPLACE ALL DAMAGED OR
- DECAYED EXISTING WOOD FRAMING , FLOOR, OR SHEATHING IN AREAS OF REMODEL AND REPAIR. NOTIFY ARCHITECT IF DAMAGED OR DECAYED CONDITIONS ARE ENCOUNTERED PRIOR TO COMMENCING REPAIR WORK. CONTRACTOR SHALL BE SOLEY RESPONSIBLE FOR SAFE
- REMOVAL AND DISPOSAL OF ALL MATERIALS NOT FOR RE-USE ON THIS PROJECT. RECYCLE AND HAUL ALL
- RE-USE ON THIS PROJECT. RECYCLE AND HAUL ALL DEBRIS IN ACCORDANCE WITH LOCAL JURISDICTION REQUIREMENTS & APPLICABLE LAWS. DOCUMENTATION HEREIN DOSS NOT AUTHORIZE, DESCRIBE, REQUIRE OR INCLUDE THE REMOVAL OF ANY HAZAROUS AMATERIALS OR LEMENTS, INCLUDING, BUT NOT LIMITED TO LEAD PAINT, ASSESTOS AND PCB'S. GENERAL CONTRACTION, ASSESTOS AND PCB'S. GENERAL CONTRACTOR SHALL COMPLY WITH ALL APPLICABLE LAWS, REGULATIONS, ORDINANICES AND RULES RELATING TO ANY HAZAROUS OR TOXIC MATERIALS. IN GENERAL CONTRACTOR DISCOVERS ANY SUCH MATERIALS ON THE PROPERTY, GENERAL CONTRACTOR SHALL PROMPTLY NOTHEY THE OWNER. ANY REMOVAL OF HAZARDOUS MATERIALS SHALL BE DOCUMENTED SEPARATELY, AND SHALL OCCUR AS REQUIRED BY CODE AND REGULATORY REQUIREMENTS.

DEMOLITION PROTECTION

CONTRACTOR SHALL PROVIDE AND COORDINATE CONTRACTION SHALL PHOVIDE AND COUNTINATE
PROTECTION FOR ALL EXISTING CONSTRUCTION ON THE
INTERIOR AND EXTERIOR OF THE BUILDING FROM DUST,
DEBRIS, CONSTRUCTION EQUIPMENT, AND ANY OTHER CONSTRUCTION RELATED WORK.

1513 GOLDEN GATE AVENUE GARAGE ADDITION

1513 GOLDEN GATE AVENUE SAN FRANCISCO, CA 94115



101 Montgomery Street Suite 650 San Francisco, CA 94104 T 415 346 9990

349 5th Avenue New York, NY 10016 T 646 741 0341




NO. RECORD OF DRAWING ISSUANCE DATE

PRE-APPLICATION MEETING SITE PERMIT SET 01.03.2018 PLANNING RESPONSE 1 06.05.2018 PLANNING RESPONSE 2 07.23.2018 09.07.2018


C.O.A. HEARING SET

A.W. Checked By: B.M. Project Number: 17011.1

EXISTING & DEMOLITION AND CONSTRUCTION GENERAL NOTES

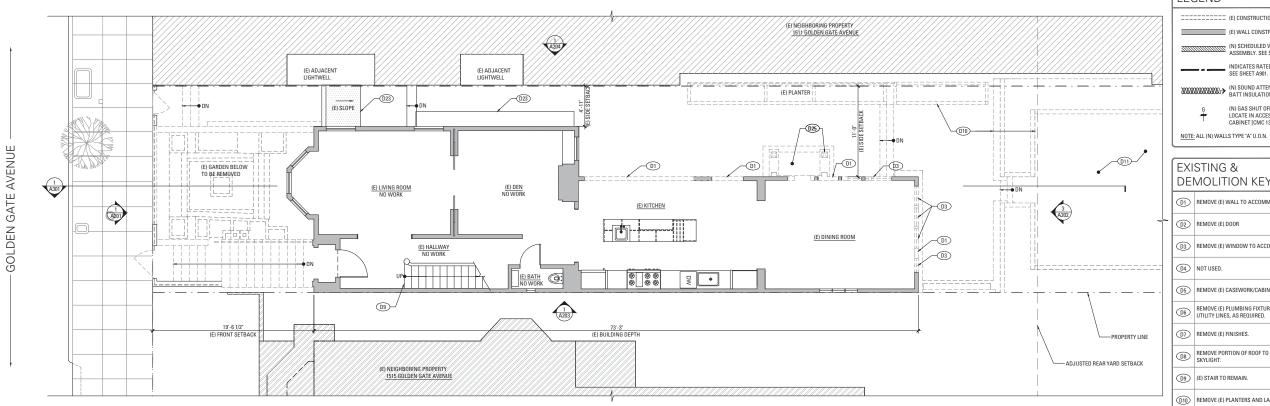

FIRST FLOOR EXISTING/DEMOLITION PLAN

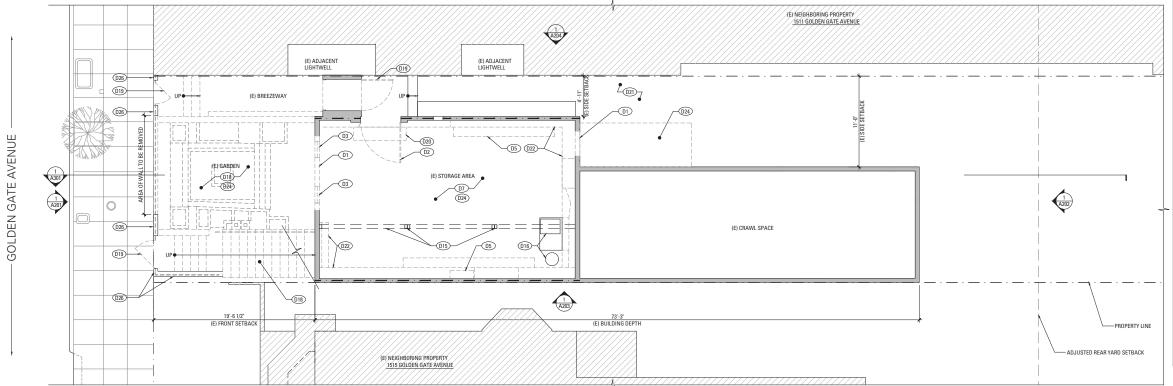

LEGEND

(N) SCHEDULED WALL OR FINISH ASSEMBLY. SEE SHEET A901.

(N) SOUND ATTENUATION BATT INSULATION

(N) GAS SHUT OFF; LOCATE IN ACCESSIBLE AREA IN CABINET [CMC 1312.3]

EXISTING & DEMOLITION KEYNOTES

D1 REMOVE (E) WALL TO ACCOMMODATE (N) WORK (S.S.D.

D2 REMOVE (E) DOOR

D3 REMOVE (E) WINDOW TO ACCOMMODATE (N) WORK

D4 NOT USED.

D5 REMOVE (E) CASEWORK/CABINETRY

REMOVE (E) PLUMBING FIXTURE; CAP OFF/RE-ROUTE UTILITY LINES, AS REQUIRED.

D7 REMOVE (E) FINISHES.

(N) REMOVE PORTION OF ROOF TO ACCOMMODATE (N) SKYLIGHT.

D9 (E) STAIR TO REMAIN.

(D10) REMOVE (E) PLANTERS AND LANDSCAPE WALLS.

REAR YEAR TO BE RE-GRADED TO ACCOMMODATE (N) WORK.

REMOVE (E) APPLANCE/EQUIPMENT. CAP OFF/REMOVE UTILITY LINES AS REQUIRED.

D13 REMOVE (E) SECOND FLOOR POPOUT

D14 REMOVE (E) ROOF TO ACCOMMODATE (N) WORK

(E) MECHANICAL EQUIPMENT TO BE REPLACED ON - KIND, CAP OFF/ RE-ROUTE UTILITY LINES AS REQUIRED.

(E) FLAT ROOF TO REMAIN AS REQUIRED.

(E) EXTERIOR STAIR, HANDRAILS AND FINISHES TO BE REMOVED.

(E) EXTERIOR GATES TO BE REMOVED.

(E) CONCRETE STEP TO BE REMOVED.

(E) CONCRETE WALKWAY TO REMAIN.

(E) FOOTING AND FOUNDATIONS TO BE REMOVED.

(E) SHED ROOF TO REMAIN.

D24 EXCAVATE TO ACCOMMODATE (N) WORK.

(E) ENTRY PORTICO AND ROOF TO BE REMOVED.

(E) PORTIONS OF THE LANDSCAPE WALL TO REMAIN (D26) ALONG PROPERTY LINE AND SIDEWALK. ANY
MATERIALS REMOVED TO ACCOMMODATE NEW
WORK SHALL BE STORED FOR REUSE.

D27 REMOVE (E) PARAPET WALLS

(E) WOOD FENCE TO REMAIN.

(E) CHIMNEY FLUE TO REMAIN.

(E) SLOPED ROOF TO REMAIN.

1513 GOLDEN GATE AVENUE GARAGE **ADDITION**

1513 GOLDEN GATE AVENUE SAN FRANCISCO, CA 94115



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SITE PERMIT SET 01.03.2018 PLANNING RESPONSE 1 PLANNING RESPONSE 2 07.23.2018 C.O.A. HEARING SET 09.07.2018




C.O.A. HEARING SET

A.W. Checked By: B.M. Project Number: 17011.1


BASEMENT & FIRST FLOOR EXISTING & DEMO **PLANS**

A101

BASEMENT LEVEL EXISTING/DEMOLITION PLAN (PUBLIC RIGHT-OF-WAY)

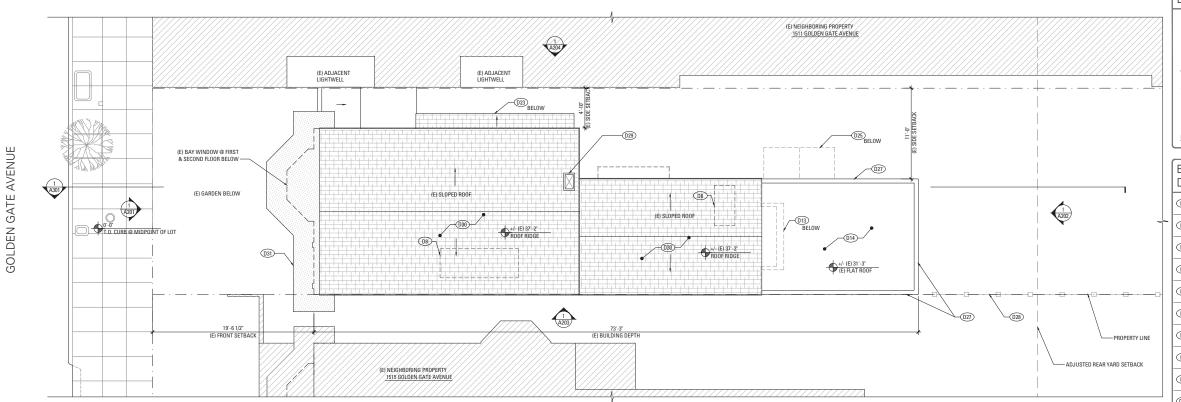

2 ROOF EXISTING/DEMOLITION PLAN

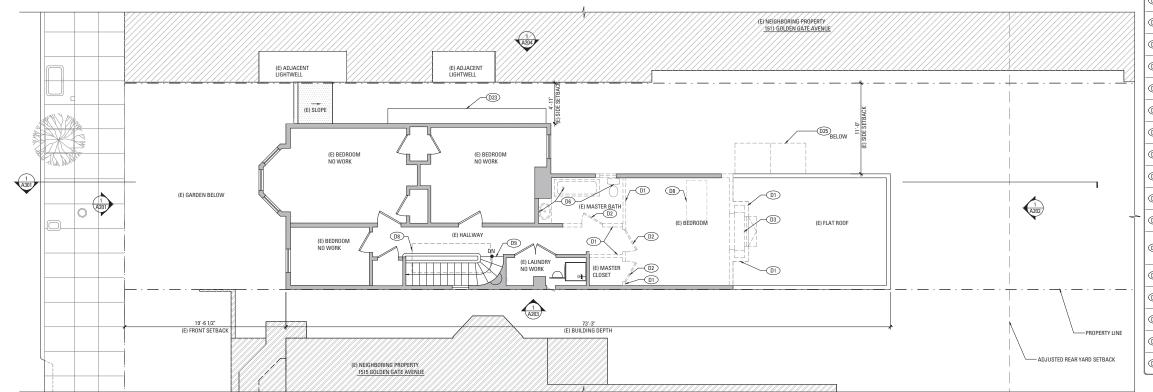

LEGEND

(E) CONSTRUCTION TO BE REMOVED

(E) WALL CONSTRUCTION

ASSEMBLY. SEE SHEET A901.

INDICATES RATED ASSEMBLY.
SEE SHEET A901.

G (N) GAS SHUT OFF; LOCATE IN ACCESSIBLE AREA IN CABINET [CMC 1312.3]

NOTE: ALL (N) WALLS TYPE "A" U.O.N.

EXISTING & DEMOLITION KEYNOTES

D1 REMOVE (E) WALL TO ACCOMMODATE (N) WORK (S.S.D.)

D2 REMOVE (E) DOOR

D3 REMOVE (E) WINDOW TO ACCOMMODATE (N) WORK

D4 NOT USED.

D5 REMOVE (E) CASEWORK/CABINETRY

REMOVE (E) PLUMBING FIXTURE; CAP OFF/RE-ROUTE UTILITY LINES, AS REQUIRED.

D7 REMOVE (E) FINISHES.

(N) REMOVE PORTION OF ROOF TO ACCOMMODATE (N) SKYLIGHT.

D9 (E) STAIR TO REMAIN.

D10 REMOVE (E) PLANTERS AND LANDSCAPE WALLS.

REAR YEAR TO BE RE-GRADED TO ACCOMMODATE (N) WORK.

D12 REMOVE (E) APPLANCE/EQUIPMENT. CAP OFF/REMOVE UTILITY LINES AS REQUIRED.

D13 REMOVE (E) SECOND FLOOR POPOUT

D14 REMOVE (E) ROOF TO ACCOMMODATE (N) WORK

(E) COLUMNS AND BEAM TO REMAIN.

(E) MECHANICAL EQUIPMENT TO BE REPLACED ON KIND, CAP OFF/ RE-ROUTE UTILITY LINES AS
REQUIRED.

(E) FLAT ROOF TO REMAIN AS REQUIRED.

(E) EXTERIOR STAIR, HANDRAILS AND FINISHES TO BE REMOVED.

(E) EXTERIOR GATES TO BE REMOVED.

(E) CONCRETE STEP TO BE REMOVED.

(E) CONCRETE WALKWAY TO REMAIN.

(E) FOOTING AND FOUNDATIONS TO BE REMOVED.

(E) SHED ROOF TO REMAIN.

(D24) EXCAVATE TO ACCOMMODATE (N) WORK.

D25 (E) ENTRY PORTICO AND ROOF TO BE REMOVED.

(E) PORTIONS OF THE LANDSCAPE WALL TO REMAIN ALONG PROPERTY LINE AND SIDEWALK. ANY MATERIALS REMOVED TO ACCOMMODATE NEW WORK SHALL BE STORED FOR REUSE.

D27 REMOVE (E) PARAPET WALLS.

D28 (E) W00D FENCE TO REMAIN.

D29 (E) CHIMNEY FLUE TO REMAIN.

_

(E) SLOPED ROOF TO REMAIN.

(E) DECORATIVE ROOF CORNICE TO REMAIN.

1513 GOLDEN GATE AVENUE GARAGE ADDITION

> 1513 GOLDEN GATE AVENUE SAN FRANCISCO, CA 94115



101 Montgomery Street Suite 650 San Francisco, CA 94104 T 415 346 9990

349 5th Avenue New York, NY 10016 T 646 741 0341





 Drawn By:
 A.W.

 Checked By:
 B.M.


 Project Number:
 17011.1

SECOND FLOOR AND ROOF EXISTING & DEMO PLAN


A102

SECOND FLOOR EXISTING AND DEMOLITION PLAN

GOLDEN GATE AVENUE

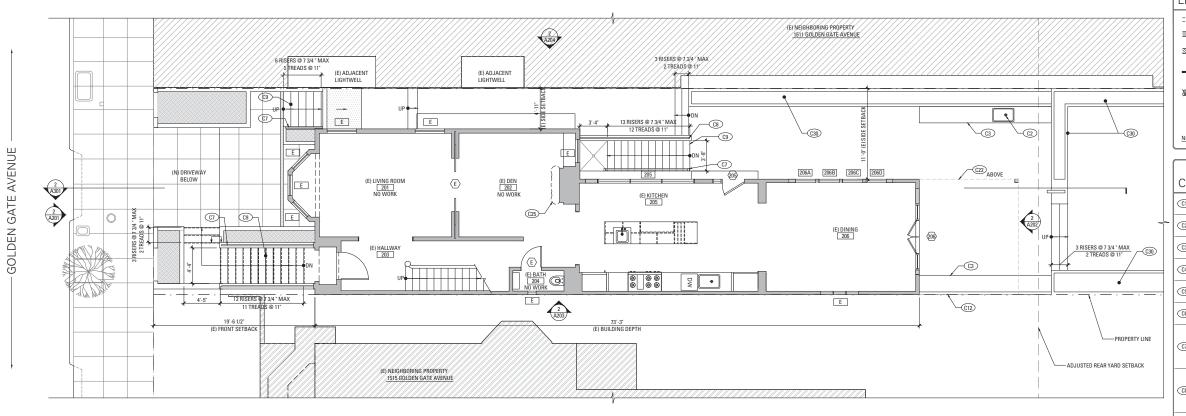

FIRST FLOOR CONSTRUCTION PLAN

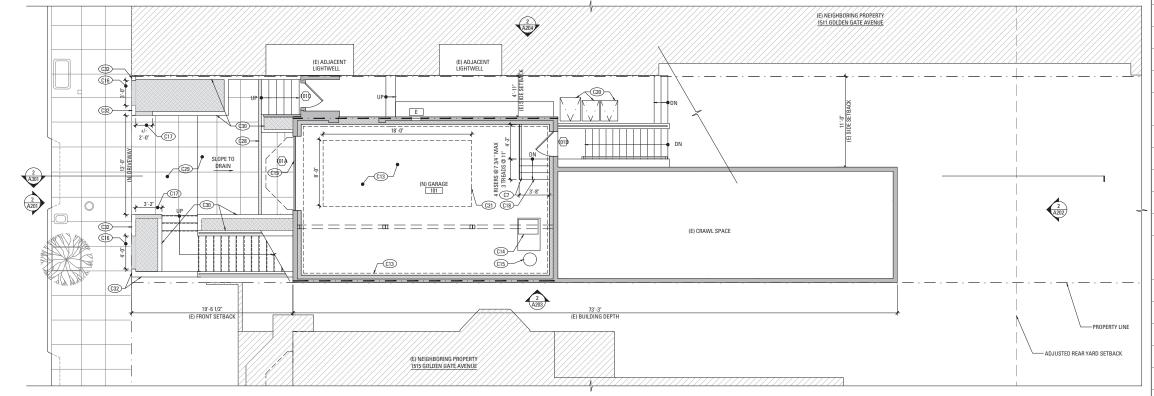

LEGEND

(E) CONSTRUCTION TO BE F

(E) WALL CONSTRUCTION

INDICATES RATED ASSI

G (N) GAS SHUT OFF; LOCATE IN ACCESSIBLE AREA IN CABINET [CMC 1312.3]

NOTE: ALL (N) WALLS TYPE "A" U.O.N.

CONSTRUCTION KEYNOTES

- (N) APPLIANCES AND EQUIPMENT.
- (N) PLUMBING FIXTURES, TYP.
- (N) BUILT-IN CASEWORK. PROVIDE BACKING
- (N) FULL HEIGHT BUILT-IN CASEWO
- (N) PARTIAL HEIGHT FIRE RATED PARAPET
- (N) GLASS SHED ROOF EXTENDS ABOVE.
- (N) GRIPPABLE HANDRAIL @ 36° ABOVE NOSING;
 DESIGN SHALL RESIST LINEAR LOAD OF 50 P.L.F. IN
 ACCORDANCE W/ SECTION 4.5.1 OF ASCE 7 PER CBC
 1607.8.1;
- (N) GUARDRAIL AT 42" A.F.F. WITH 4" MAX. OPENING, DESIGN SHALL RESIST LINEAR LOAD 0F 50 P.L.F. IN ACCORDANCE W/ SECTION 4.5.1 0F ASCE 7 PER CBC 1007.8.1;
- (N) CONCRETE STAIR.
- (N) TEMPERED GLASS SHOWER ENCLOSURE
- (N) SKYLIGHT ABOVE. SEE SCHEDULE
- C12 (E) FENCE TO REMAIN
- PROVIDE MIN. 1/2" TYPE "X" GWB. TO WALLS & MIN. 5/8" TYPE "X" GWB. TO THE CEILING ON THE GARAGE SIDE PER CBC 406.3.4
- (N) FAU. HEAT SYSTEM BY G.C.
- (N) HOT WATER HEATER BY G.C.
- C16 AREA OF INFILL, G.C. TO REUSE (E) LANDSCAPE WALL REMOVED TO ACCOMMODATE NEW DRIVEWAY
- PORTION OF LANDSCAPING WALL TO BE CONSTRUCTED WITH (E) MATERIALS REMOVE ACCOMMODATE (N) DRIVEWAY
- (N) CARPENTER-BUILT STAIR;
 (3) ZX12 WD. STRINGERS MIN. W/ 3/4" PLYWD.
 TREADS & RISERS;
 P.T. LUMBER AT ALL EXTERIOR CONDITIONS
- (N) GARAGE DOOR W/ MIN 200 SQ. INCH VENTILATION LOUVER
- LOCATION OF EQUAL ACCESS FOR STORAGE
 COLLECTION AND LOADING OF RECYCLABLE
- COMPOSTABLE AND LANDFILL MATERIALS.
- (X) 144 SQUARE FOOT DEDICATED PARKING SPACE
 (X) STAINED WOOD PERGOLA
- (C23) (N) FULL HEIGHT BRICK WALL. SEE ELEVATIONS.
- (N) GLASS GUARDRAIL WITH PAINTED METAL FRAMI AT 42° A.F. WITH 4' MAX OPENING, DESIGN SHALL RESIST LINEAR LOAD OF 50 P.L.F. IN ACCORDANCE W/SECTION 45.1 OF ASCE 7 PER CBC 1607.8.1
- C25 (E) FIREPLACE TO REMAIN
- (N) PARTIAL HEIGHT FIRE RATED BRICK WALL. SEE ELEVATIONS.
- ELEVATIONS.
- (N) CUSTOM GLASS SOLARIUM
- (N) TRENCH DRAINING
- (N) PERMEABLE DRIVEWAY
- (N) PLANTERS AND LANDSCAPE WALLS, 36" MAX. ABOVE GRADE, TYP.
- C31 EXTENT OF (E) UPPER STORY
- C32 AREA OF (E) LANDSCAPE WALL TO REMAIN

1513 GOLDEN GATE AVENUE GARAGE ADDITION

> 1513 GOLDEN GATE AVENUE SAN FRANCISCO, CA 94115



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RECORD OF DRAWING ISSUANCE DATE

PRE-APPLICATION MEETING 12.19.2017

SITE PERMIT SET 01.03.2018

SITE PERMIT SET PLANNING RESPONSE 1 PLANNING RESPONSE 2 C.O.A. HEARING SET

07.23.2018

09.07.2018

C.O.A. HEARING SET

 Drawn By:
 A.W.

 Checked By :
 B.M.

 Project Number:
 17011.1


 BASEMENT & FIRST

FLOOR CONSTRUCTION PLAN


A111

GATE AVENUE

GOLDEN

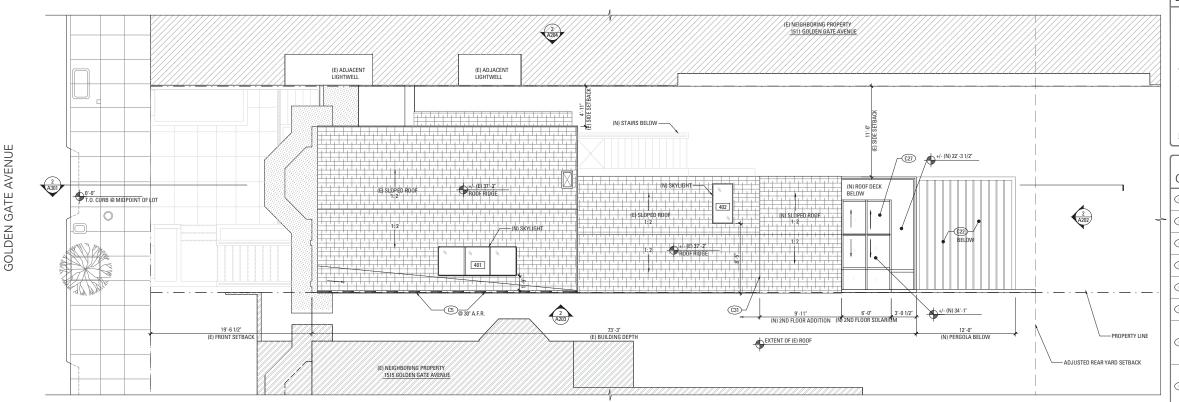

2 ROOF CONSTRUCTION PLAN SCALE: 1/4" = 1'-0"

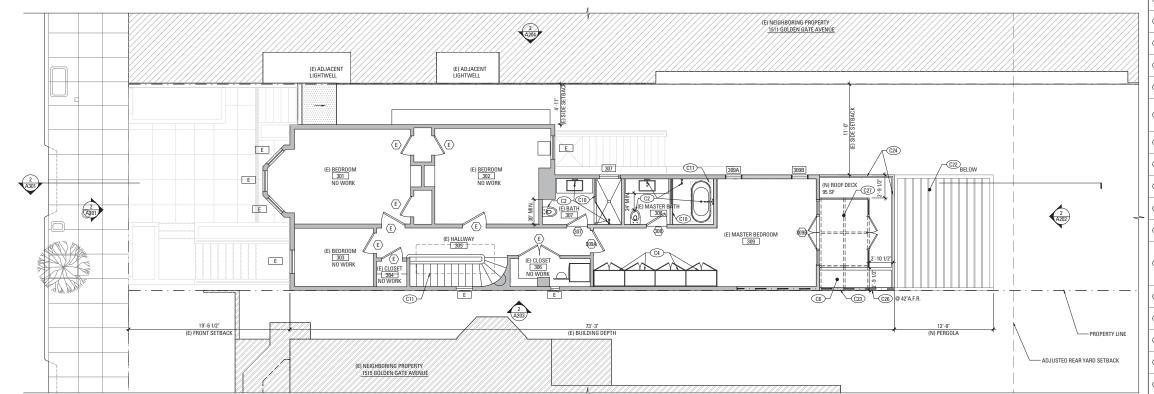

LEGEND

INDICATES RATED ASSEMBLY SEE SHEET A901.

(N) SOUND ATTENUATION BATT INSULATION (N) GAS SHUT OFF; LOCATE IN ACCESSIBLE AREA IN CABINET [CMC 1312.3]

NOTE: ALL (N) WALLS TYPE "A" U.O.N.

CONSTRUCTION KEYNOTES

- (N) APPLIANCES AND EQUIPMENT.
- (N) PLUMBING FIXTURES, TYP.
- (N) BUILT-IN CASEWORK. PROVIDE BACKING
- (N) FULL HEIGHT BUILT-IN CASEWORK. PROVIDE BACKING
- (N) PARTIAL HEIGHT FIRE RATED PARAPET
- (N) GRIPPABLE HANDRAIL @ 36" ABOVE NOSING; DESIGN SHALL RESIST LINEAR LOAD OF 50 P.L.F. IN ACCORDANCE W/ SECTION 4.5.1 OF ASCE 7 PER CBC
- (N) GUARDRAIL AT 42" A.F.F. WITH 4" MAX. OPENING; DESIGN SHALL RESIST LINEAR LOAD 0F 50 P.L.F. IN ACCORDANCE W/ SECTION 4.5.1 OF ASCE 7 PER CBC 1607.8.1;
- (N) CONCRETE STAIR.
- (N) TEMPERED GLASS SHOWER ENCLOSURE
- (E) FENCE TO REMAIN
- PROVIDE MIN. 1/2' TYPE "X" GWB. TO WALLS & MIN. 5/8" TYPE "X" GWB. TO THE CEILING ON THE GARAGE SIDE PER CBC 406.3.4
- C14 (N) FAU. HEAT SYSTEM BY G.C.
- (N) HOT WATER HEATER BY G.C.
- AREA OF INFILL, G.C. TO REUSE (E) LANDSCAPE WALL REMOVED TO ACCOMMODATE NEW DRIVEWAY
- PORTION OF LANDSCAPING WALL TO BE CONSTRUCTED WITH (E) MATERIALS REMOVED TO ACCOMMODATE (N) DRIVEWAY
- (N) CARPENTER-BUILT STAIR;
 (3) ZX12 WD. STRINGERS MIN. W/ 3/4" PLYWD.
 TREADS & RISERS;
 P.T. LUMBER AT ALL EXTERIOR CONDITIONS
- (N) GARAGE DOOR W/ MIN 200 SQ. INCH VENTILATION LOUVER
- LOCATION OF EQUAL ACCESS FOR STORAGE COLLECTION OF EQUAL ACCESS FOR STORAGE, COLLECTION AND LOADING OF RECYCLABLE COMPOSTABLE AND LANDFILL MATERIALS.
- (C21) (N) 144 SQUARE FOOT DEDICATED PARKING SPACE
- (N) STAINED WOOD PERGOLA
- (N) FULL HEIGHT BRICK WALL. SEE ELEVATIONS.
- (N) GLASS GUARDRAIL WITH PAINTED METAL FRAME AT 42" A.F.F. WITH 4" MAX OPENING, DESIGN SHALL RESIST LINEAR LOAD 0F 50 P.L.F. IN ACCORDANCE WISECTION 45.1 0F ASCE 7 PER CBC 1607.8.1
- (E) FIREPLACE TO REMAIN
- (N) PARTIAL HEIGHT FIRE RATED BRICK WALL. SEE ELEVATIONS.
- (N) CUSTOM GLASS SOLARIUM
- (N) TRENCH DRAINING
- (N) PERMEABLE DRIVEWAY
- (N) PLANTERS AND LANDSCAPE WALLS, 36° MAX. ABOVE GRADE, TYP.
- (31) EXTENT OF (E) UPPER STORY
- C32 AREA OF (E) LANDSCAPE WALL TO REMAIN

1513 GOLDEN GATE **AVENUE GARAGE** ADDITION

1513 GOLDEN GATE AVENUE SAN FRANCISCO, CA 94115



101 Montgomery Street Suite 650 San Francisco, CA 94104 T 415 346 9990

349 5th Avenue New York, NY 10016 T 646 741 0341



SITE PERMIT SET 01.03.2018 PLANNING RESPONSE 1 06.05.2018 PLANNING RESPONSE 2 07.23.2018 C.O.A. HEARING SET 09.07.2018



C.O.A. HEARING SET

A.W. Checked By: B.M. Project Number: 17011.1

SECOND FLOOR AND ROOF CONSTRUCTION PLAN

A112

GATE AVENUE


GOLDEN (



PROPOSED FRONT ELEVATION (NORTH)

SCALE: 3/16' = 1'-0'



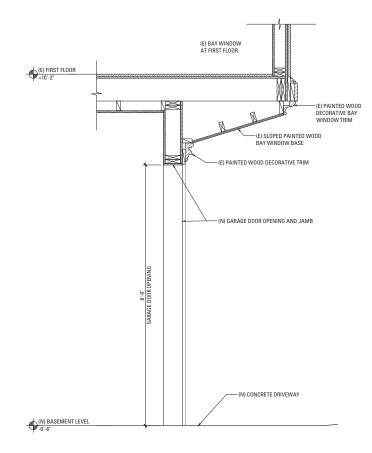

PROPOSED GARAGE DOOR HEADER SECTION
SCALE: 1"= 1"-0"

ELEVATION KEYNOTES

- (E) WINDOW OR DOOR TO REMAIN
- (E) WINDOW OR DOOR TO BE REMOVED
- (N) WINDOW OR DOOR
- 1 (N) FIRE RATED PARAPET
- (E) PAINTED WOOD SIDING TO BE REMOVED
- (E) PAINTED WOOD TRIM TO REMAIN
- 5 (E) PAINTED BRICK FINISH TO REMOVE
- 6 (E) PAINTED STUCCO FINISH TO REMAIN
- (E) PAINTED WOOD SIDING TO REMAIN
- AREAS OF (E) LANDSCAPE WALLS TO BE REMOVED AND STORED FOR REUSE.
- (E) EXTERIOR STAIRS, HANDRAILS, AND FINISHES, TO BE REMOVED
- (E) FIREWALL AT PROPERTY LINE TO REMAIN
- 12 PROPERTY LINE
- (E) METAL GATE TO BE REMOVED
- (E) ROOF TO BE REMOVED
- (N) PAINTED METAL GUARDRAIL @ EXTERIOR STAIRS
- (E) HANDRAIL, TO REMAIN
- (N) CAST IN PLACE CUNCRETE STEPS TO HAVE BUILL-NOSE EDGE AT NOSING TO MATCH THE (E) WOOD STAIRS
- (N) CUSTOM GLASS SOLARIUM WITH PAINTED METAL FRAMES
- (N) SKYLIGHT, SEE SCHEDULE
- (E) CHIMNEY TO REMAIN
- 22 ADJUSTED REAR YARD SETBACK
- (N) STAINED WOOD PERGOLA
- (N) BRICK WALL
- (N) PAINTED WOOD TRIM
- (N) CONCRETE PLANTERS AND GARDEN/LANDSCAPE WALLS.
- (N) PERMEABLE DRIVEWAY
- (E) PORTICO AND COLUMNS TO BE REMOVED
- (E) POP-OUT TO BE REMOVED
- (E) PAINTED WOOD TRIM TO BE REMOVED
- (N) ROOF TO MATCH (E)
- (E) FENCE TO REMAIN
- (N) LANDSCAPE GARDEN WALL, </= 36" ABOVE GRADI
- (E) CONCRETE WALL TO REMAIN
- (N) GLASS SHED ROOF ABOVE
- (E) EXTENT OF SECOND FLOOR
- (E) OPEN AREA OF LANDSCAPE WALL TO BE INFILLED
 WITH (E) MATERIALS REMOVED TO ACCOMMODATE
 THE (N) DRIVEWAY
- (E) LANDSCAPE WALL ALONG SIDEWALK AND PROPERTY LINE TO REMAIN
- MINIMUM TOTAL 200 SQ. INCH LOUVER IN GARAGE DOOR FINISI
- (N) PAINTED WOOD HANDRAIL WITH PAINTED WOOD NEWEL POSTS ON TOP OF CONCRETE CURB @ EXTERIOR ENTRY STAIRS

1513 GOLDEN GATE **AVENUE GARAGE ADDITION**

1513 GOLDEN GATE AVENUE SAN FRANCISCO, CA 94115



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SITE PERMIT SET 01.03.2018 PLANNING RESPONSE 1 PLANNING RESPONSE 2 07.23.2018 C.O.A. HEARING SET 09.07.2018

C.O.A. HEARING SET

A.W. Checked By: B.M. Project Number: 17011.1

EXTERIOR ELEVATIONS

A201


EXISTING FRONT ELEVATION (NORTH)



(N) BASEMENT LEVEL

PROPOSED REAR ELEVATION (SOUTH)

SCALE: 3/16' = 1'-0'

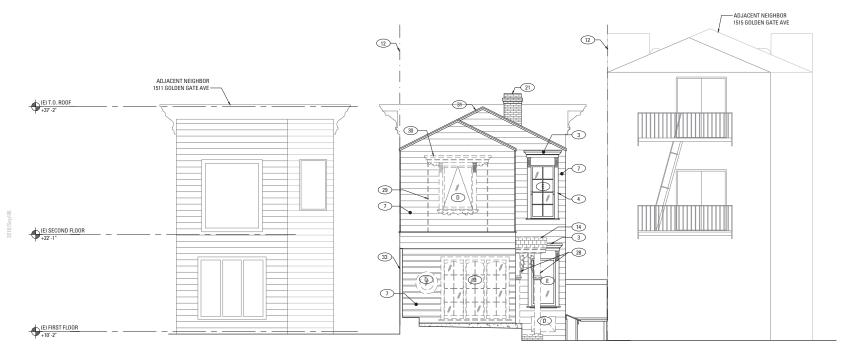



EXISTING REAR ELEVATION (SOUTH)
SCALE: 3/16" = 1'-0"

ELEVATION KEYNOTES

(E) WINDOW OR DOOR TO REMAIN

(E) WINDOW OR DOOR TO BE REMOVED

(N) WINDOW OR DOOR

(N) FIRE RATED PARAPET

(E) PAINTED WOOD SIDING TO BE REMOVED

(E) PAINTED WOOD CORNICE TO REMAIN

(E) PAINTED WOOD TRIM TO REMAIN

5 (E) PAINTED BRICK FINISH TO REMOVE

6 (E) PAINTED STUCCO FINISH TO REMAIN

(E) PAINTED WOOD SIDING TO REMAIN

9 AREAS OF (E) LANDSCAPE WALLS TO BE REMOVED AND STORED FOR REUSE.

(E) EXTERIOR STAIRS, HANDRAILS, AND FINISHES, TO BE REMOVED

(E) FIREWALL AT PROPERTY LINE TO REMAIN

12 PROPERTY LINE

(E) METAL GATE TO BE REMOVED

(E) ROOF TO BE REMOVED

(N) PAINTED METAL GUARDRAIL @ EXTERIOR STAIRS

(N) GLASS GUARDRAIL AT DECK, 42° A.F.F.

(E) HANDRAIL, TO REMAIN

(N) CAST IN PLACE CONCRETE STEPS TO HAVE BULL-NOSE EDGE AT NOSING TO MATCH THE (E) WOOD STAIRS

(N) CUSTOM GLASS SOLARIUM WITH PAINTED METAL FRAMES

(N) SKYLIGHT, SEE SCHEDULE

(E) CHIMNEY TO REMAIN

22 ADJUSTED REAR YARD SETBACK

(N) STAINED WOOD PERGOLA

(N) BRICK WALL

(N) PAINTED WOOD TRIM

(N) CONCRETE PLANTERS AND GARDEN/LANDSCAPE WALLS.

(N) PERMEABLE DRIVEWAY

(E) PORTICO AND COLUMNS TO BE REMOVED

(E) POP-OUT TO BE REMOVED

(E) PAINTED WOOD TRIM TO BE REMOVED

(E) ROOF TO REMAIN

(N) ROOF TO MATCH (E)

(E) FENCE TO REMAIN

(N) LANDSCAPE GARDEN WALL, </= 36" ABOVE GRADE

(E) CONCRETE WALL TO REMAIN

(N) GLASS SHED ROOF ABOVE

(E) EXTENT OF SECOND FLOOR

(E) OPEN AREA OF LANDSCAPE WALL TO BE INFILLED
WITH (E) MATERIALS REMOVED TO ACCOMMODATE
THE (N) DRIVEWAY

(E) LANDSCAPE WALL ALONG SIDEWALK AND PROPERTY LINE TO REMAIN

MINIMUM TOTAL 200 SQ. INCH LOUVER IN GARAGE DOOR TO BE PAINTED TO MATCH GARAGE DOOR FINISI

(N) PAINTED WOOD HANDRAIL WITH PAINTED WOOD NEWEL POSTS ON TOP OF CONCRETE CURB @ EXTERIOR ENTRY STAIRS

1513 GOLDEN GATE **AVENUE GARAGE ADDITION**

1513 GOLDEN GATE AVENUE SAN FRANCISCO, CA 94115



101 Montgomery Street Suite 650 San Francisco, CA 94104 T 415 346 9990 349 5th Avenue New York, NY 10016 T 646 741 0341






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NO.	RECORD OF DRAWING ISSUANCE	DATE
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1	PRE-APPLICATION MEETING	12.19.2
2	SITE PERMIT SET	01.03.2
3	PLANNING RESPONSE 1	06.05.2
4	PLANNING RESPONSE 2	07.23.2
5	C.O.A. HEARING SET	09.07.2



C.O.A. HEARING SET Drawn By: A.W. Checked By: B.M. Project Number: 17011.1

EXTERIOR ELEVATIONS

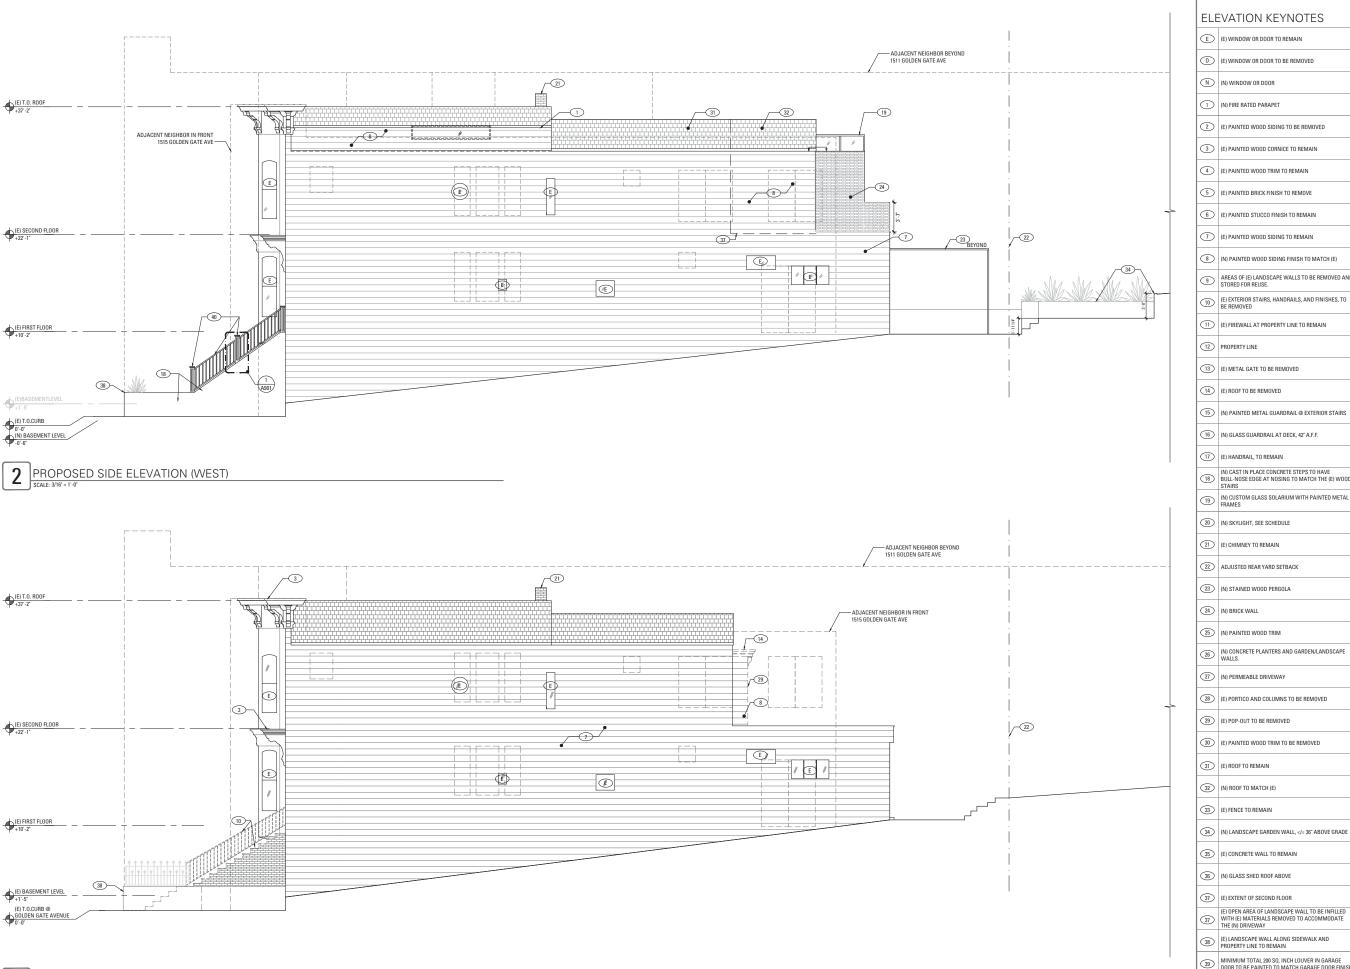

ELEVATION KEYNOTES

(E) WINDOW OR DOOR TO REMAIN

(E) WINDOW OR DOOR TO BE REMOVED

(N) FIRE RATED PARAPET

(E) PAINTED WOOD SIDING TO BE REMOVED

(E) PAINTED WOOD CORNICE TO REMAIN

(E) PAINTED WOOD SIDING TO REMAIN

(E) FIREWALL AT PROPERTY LINE TO REMAIN

(E) METAL GATE TO BE REMOVED

(E) ROOF TO BE REMOVED

(N) PAINTED METAL GUARDRAIL @ EXTERIOR STAIRS

(N) GLASS GUARDRAIL AT DECK, 42° A.F.F.

(E) HANDRAIL, TO REMAIN

(N) CAST IN PLACE CONCRETE STEPS TO HAVE BULL-NOSE EDGE AT NOSING TO MATCH THE (E) WOOD

(N) CUSTOM GLASS SOLARIUM WITH PAINTED METAL FRAMES

(N) SKYLIGHT, SEE SCHEDULE

(E) CHIMNEY TO REMAIN

22 ADJUSTED REAR YARD SETBACK

(N) STAINED WOOD PERGOLA

(N) PAINTED WOOD TRIM

(N) CONCRETE PLANTERS AND GARDEN/LANDSCAPE WALLS.

(N) PERMEABLE DRIVEWAY

(E) PORTICO AND COLUMNS TO BE REMOVED

32 (N) ROOF TO MATCH (E)

(E) FENCE TO REMAIN

(N) LANDSCAPE GARDEN WALL, </= 36" ABOVE GRADE

(E) CONCRETE WALL TO REMAIN

(N) GLASS SHED ROOF ABOVE

(E) EXTENT OF SECOND FLOOR

(E) OPEN AREA OF LANDSCAPE WALL TO BE INFILLED
WITH (E) MATERIALS REMOVED TO ACCOMMODATE
THE (N) DRIVEWAY

(E) LANDSCAPE WALL ALONG SIDEWALK AND PROPERTY LINE TO REMAIN

MINIMUM TOTAL 200 SQ. INCH LOUVER IN GARAGE DOOR TO BE PAINTED TO MATCH GARAGE DOOR FINISI

(N) PAINTED WOOD HANDRAIL WITH PAINTED WOOD NEWEL POSTS ON TOP OF CONCRETE CURB @ EXTERIO ENTRY STAIRS

1513 GOLDEN GATE **AVENUE GARAGE ADDITION**

1513 GOLDEN GATE AVENUE SAN FRANCISCO, CA 94115



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349 5th Avenue New York, NY 10016 T 646 741 0341





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(NO.	RECORD OF DRAWING ISSUANCE	DATE
=		
1	PRE-APPLICATION MEETING	12.19.20
2	SITE PERMIT SET	01.03.20
3	PLANNING RESPONSE 1	06.05.20
4	PLANNING RESPONSE 2	07.23.20
5	C.O.A. HEARING SET	09.07.20



C.O.A. HEARING SET Drawn By: A.W. B.M. Checked By: Project Number: 17011.1


EXTERIOR ELEVATIONS

A203

EXISTING SIDE ELEVATION (WEST)



PROPOSED SIDE ELEVATION (EAST)

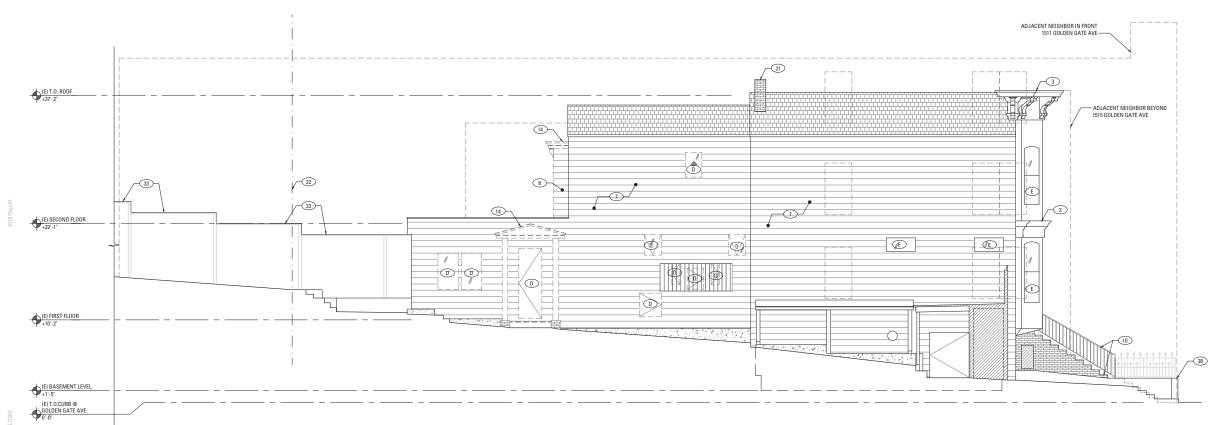

EXISTING SIDE ELEVATION (EAST)

ELEVATION KEYNOTES

- (E) WINDOW OR DOOR TO REMAIN
- (E) WINDOW OR DOOR TO BE REMOVED
- (N) WINDOW OR DOOR
- (N) FIRE RATED PARAPET
- (E) PAINTED WOOD SIDING TO BE REMOVED
- (E) PAINTED WOOD CORNICE TO REMAIN
- (E) PAINTED BRICK FINISH TO REMOVE
- (E) PAINTED WOOD SIDING TO REMAIN
- 9 AREAS OF (E) LANDSCAPE WALLS TO BE REMOVED AND STORED FOR REUSE.
- (E) FIREWALL AT PROPERTY LINE TO REMAIN
- 12 PROPERTY LINE
- (E) METAL GATE TO BE REMOVED
- (E) ROOF TO BE REMOVED
- (N) PAINTED METAL GUARDRAIL @ EXTERIOR STAIRS
- (N) GLASS GUARDRAIL AT DECK, 42" A.F.F.
- (E) HANDRAIL, TO REMAIN
- (N) CAST IN PLACE CONCRETE STEPS TO HAVE BULL-NOSE EDGE AT NOSING TO MATCH THE (E) WOOD
- (N) CUSTOM GLASS SOLARIUM WITH PAINTED METAL FRAMES
- (N) SKYLIGHT, SEE SCHEDULE
- (E) CHIMNEY TO REMAIN
- 22 ADJUSTED REAR YARD SETBACK
- (N) STAINED WOOD PERGOLA
- (N) BRICK WALL
- (N) PAINTED WOOD TRIM
- (N) CONCRETE PLANTERS AND GARDEN/LANDSCAPE WALLS.
- (N) PERMEABLE DRIVEWAY
- (E) PORTICO AND COLUMNS TO BE REMOVED
- (E) POP-OUT TO BE REMOVED
- (E) PAINTED WOOD TRIM TO BE REMOVED
- (E) ROOF TO REMAIN
- 32 (N) ROOF TO MATCH (E)
- (E) FENCE TO REMAIN
- (N) LANDSCAPE GARDEN WALL, </= 36" ABOVE GRADE
- (N) GLASS SHED ROOF ABOVE
- (E) EXTENT OF SECOND FLOOR
- (E) OPEN AREA OF LANDSCAPE WALL TO BE INFILLED
 WITH (E) MATERIALS REMOVED TO ACCOMMODATE
 THE (N) DRIVEWAY
- (E) LANDSCAPE WALL ALONG SIDEWALK AND PROPERTY LINE TO REMAIN
- MINIMUM TOTAL 200 SQ. INCH LOUVER IN GARAGE DOOR TO BE PAINTED TO MATCH GARAGE DOOR FINISI
- (N) PAINTED WOOD HANDRAIL WITH PAINTED WOOD NEWEL POSTS ON TOP OF CONCRETE CURB @ EXTERIO ENTRY STAIRS

1513 GOLDEN GATE **AVENUE GARAGE ADDITION**

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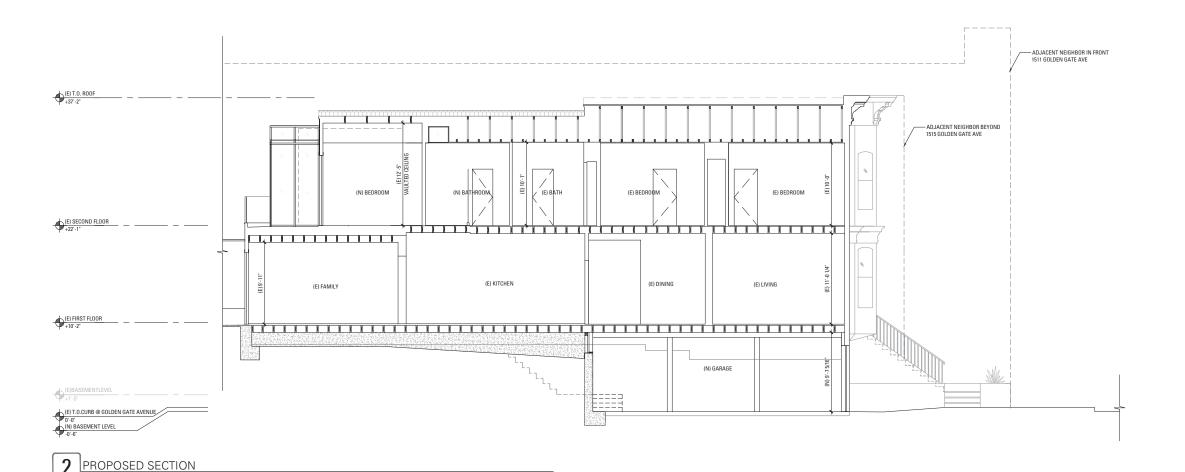
PRE-APPLICATION MEETING SITE PERMIT SET 12.19.2017 01.03.2018 PLANNING RESPONSE 1 PLANNING RESPONSE 2 07.23.2018


C.O.A. HEARING SET 09.07.2018

C.O.A. HEARING SET

A.W. B.M. Checked By: Project Number: 17011.1

EXTERIOR ELEVATIONS



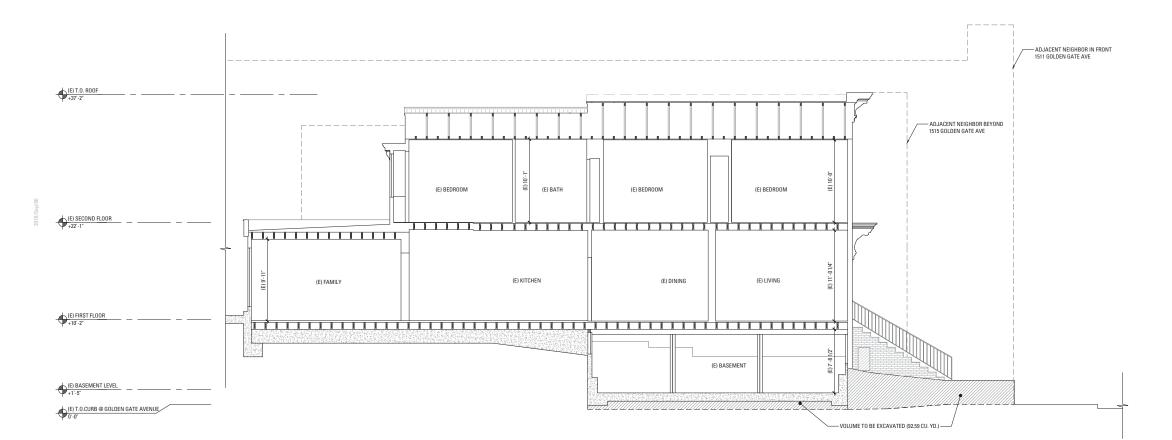

1 EXISTING SECTION

SCALE: 3/16" = 1'-0"

VOLUME OF EXCAVATION CALCULATION

EXCAVATION AREA #1
(E) BASEMENT: 25-0' LOT WIDTH X 29 SQ FT = 725 CU.FT.
725 CU.FT. X 1 CU.YD/ 27 CU.FT. = 26.85 CU.YD.

EXCAVATION AREA #2 (E) FRONT GARDEN:

25'-0" LOT WIDTH X 71 SQ FT = 1775 CU.FT. 1775 CU.FT. X 1 CU.YD/ 27 CU.FT. = 65.74 CU.YD.

TOTAL AREA OF EVACUATION 26.85 + 65.74 = 92.59 CU. YD.

1513 GOLDEN GATE AVENUE GARAGE ADDITION


> 1513 GOLDEN GATE AVENUE SAN FRANCISCO, CA 94115



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C.O.A. HEARING SET								
Drawn By:	A.W.							
Checked By:	B.M.							
Project Number:	17011 1							

07.23.2018

09.07.2018

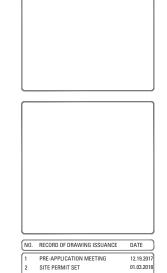PLANNING RESPONSE 1 PLANNING RESPONSE 2

C.O.A. HEARING SET


SECTIONS


SHEEL NUMB

WINDOW SCHEDULE											
	LOCATIO	N	WINDO	W							
NO.	FL00R	ROOM	TYPE	HEIGHT	WIDTH	MATERIAL	HEAD HEIGHT A.F.F.	INTERIOR FINISH	EXTERIOR FINISH	MFR.	COMMENTS
E	01,02,03	VARIES	VARIES	EXISTING	EXISTING	EXISTING	EXISTING	EXISTING	EXISTING		
205	02	KITCHEN	W1	2'-6 1/4 "	11'-9 1/4"	WOOD	8'-11 "	PAINTED WOOD	PAINTED WOOD	MARVIN OR EQUAL	
206A	02	DINING	W2	5'-1 3/4 "	2'-5 1/2 "	WOOD	8'-7 1/2 "	PAINTED WOOD	PAINTED WOOD	MARVIN OR EQUAL	
206B	02	DINING	W2	5'-1 3/4 "	2'-5 1/2 "	WOOD	8'-7 1/2 "	PAINTED WOOD	PAINTED WOOD	MARVIN OR EQUAL	
206C	02	DINING	W2	5'-1 3/4"	2'-5 1/2 "	WOOD	8'-7 1/2 "	PAINTED WOOD	PAINTED WOOD	MARVIN OR EQUAL	-
206D	02	DINING	W2	5'-1 3/4 "	2'-5 1/2 "	WOOD	8'-7 1/2 "	PAINTED WOOD	PAINTED WOOD	MARVIN OR EQUAL	
307	03	BATH	W2	3'-3 1/4 "	2'-4"	WOOD	8'-7 "	PAINTED WOOD	PAINTED WOOD	MARVIN OR EQUAL	SAFETY GLAZING
309A		MASTER BEDROOM	W3	4'-10 1/4"	2'-0"	WOOD	8'-7 "	PAINTED WOOD	PAINTED WOOD	MARVIN OR EQUAL	-
309B		MASTER BEDROOM	W3	4'-10 1/4"	2'-0"	WOOD	8'-7 "	PAINTED WOOD	PAINTED WOOD	MARVIN OR EQUAL	-
401		HALLWAY	SL-1	9'-6 1/2"	3'-7"	WOOD		TBD	COLOR TO MATCH (E) ROOF	TBD	SAFETY GLAZING, MAXIMUM GLAZING PANEL TO BE 16 SQ FT. SHALL BE FLAT AND MOUNTED ON LOW CURB
402		MASTER BATH	SL-1	4'-10 1/4"	2'-6"	WOOD		TBD	COLOR TO MATCH (E) ROOF	TBD	SAFETY GLAZING, MAXIMUM GLAZING PANEL TO BE 16 SQ FT. SHALL BE FLAT AND MOUNTED ON LOW CURB

WINDOW & SKYLIGHT NOTES

- 2. SILL OR HEAD REGIONS ARE UNIT SIZES TO OUTSIDE FRAME DIMENSIONS, U.O.N.
 2. SILL OR HEAD REGIONS ARE UNIT SIZES TO OUTSIDE FRAME DIMENSIONS, U.O.N.
 3. GENERAL CONTRACTOR TO PROVIDE CODE COMPILANT SAFETY GLAZING WHERE REQUIRED
 4. EGRESS WINDOWS TO COMPLY WITH ZOIS GES SECTION 1003 AND SHALL HAVE A MINIMUM NET CLEAR OPENING OF 5.7 SQUARE FEET, A MINIMUM NET CLEAR OPENING HEIGHT OF 2° AND MINIMUM NET OPENING WIDTH OF 20° AS A
 RESULT OF NORMAL OPERATION OF THE OPENING. THE BOTTOM OF THE OPENING SHALL HAVE A MINIMUM NET CLEAR OPENING OF 5.7 SQUARE FEET, A MINIMUM NET CLEAR OPENING HEIGHT OF 2° AND MINIMUM NET OPENING WIDTH OF 20° AS A
 RESULT OF NORMAL OPERATION OF THE OPENING. THE BOTTOM OF THE OPENING SHALL HAVE AS A CREATER THAN 4" ABOVE FINISHED FLOOR.
 5. WINDOWN TO BE GLAZED WITH DOUBLE PARK, LOW-CLEAR GLASS, AZZ U-FACTOR OR BETTER, WITH UN. PROTECTION, U.O.N.
 6. PER 2016 GGC SECTION 10158, AT OPERABLE EXTERIOR WINDOWS LOCATED MORE THAN 72 ABOVE FINISHED GRADE OR OTHER SURFACE BELOW, THE CLOOR AND A HEIGHT OF 36' SHALL BE FIXED OR NAVE OPENINGS THROUGH WHICH A 4" DIAMETER
 SPHERE CANNOT PASS, EXCEPTION. OPENINGS THAT ARE PROVIDED WITH WINDOW GUARDS THAT COMPLY WITH ASTM F 2008, F 2090 OR 1015.8.1
 7. ALL GLAZED SECTIONS. OPENINGS THAT ARE PROVIDED WITH WINDOW GUARDS THAT COMPLY WITH ASTM F 2008, F 2090 OR 1015.8.1
 8. ALL EXTERNIO DOORS AND WINDOWS TO HAVE GALL VANIZED SHEET METAL PAN FLASHING AND GALVANIZED METAL HEAD FLASHING, U.O.N.
 9. ALL EXTERNIO DOOR AND WINDOWS TO HAVE GALVANIZED SHEET METAL PAN FLASHING AND GALVANIZED METAL HEAD FLASHING, U.O.N.
 9. ALL EXTERNIO DOOR AND WINDOWS TO HAVE GALVANIZED SHEET METAL PAN FLASHING AND GALVANIZED METAL HEAD FLASHING, U.O.N.
 9. ALL EXTERNIO DOOR AND WINDOWS TO HAVE GALVANIZED SHEET METAL PAN FLASHING AND GALVANIZED METAL HEAD FLASHING AND GALVANIZED METAL HEAD

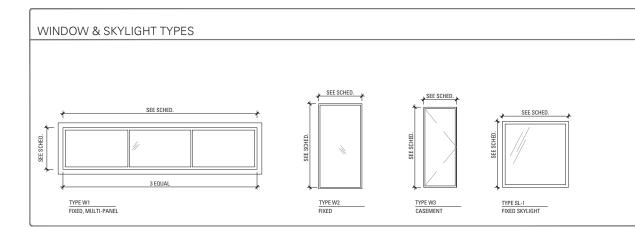

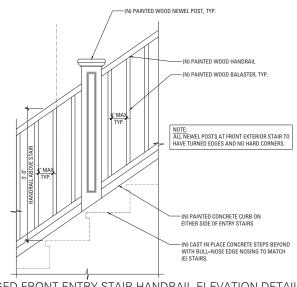

DOOR SCHEDULE

	DOOR									
TYPE	ELEV. TYPE	ROOM NAME	WIDTH	HEIGHT	THICK	MATERIAL	FINISH	MATERIAL	FINISH	COMMENTS
E	EXISTING	VARIES				EXISTING	EXISTING	EXISTING	EXISTING	
(01)A	D2	GARAGE	9'-0"	8'-0"	2*	WD	PT	WD	PT	MINIMUM 200 SQ INCH LOUVER, PAINTED TO MATCH GARAGE DOOR FINISH
(1)	D1	GARAGE	3'-0"	6'-8"	1 3/4*	WD	PT	WD	PT	20-MIN RATED DOOR AND FRAME
(1)	D3	GARAGE	3'-0"	6'-11"	1 3/4*	WD	PT	WD	PT	
205	D8	KITCHEN	2'-7 1/2"	8'-6"	1 3/4"	WD	PT	WD	PT	
206	D5	DINING	4'-0"	8'-6"	1 3/4*	WD	PT	WD	PT	
307	D6	ВАТН	2'-6"	6'-8"	1 3/4*	WD	PT	WD	PT	•
⟨308⟩	D6	MASTER BATH	2'-6"	6'-8"	1 3/4*	WD	PT	WD	PT	•
\$69A	D6	MASTER BEDROOM	2'-8"	6'-8"	1 3/4*	WD	PT	WD	PT	•
3093	D5	MASTER BEDROOM	8'-0"	6'-8"	1 3/4"	WD	PT	WD	PT	

1513 GOLDEN GATE **AVENUE GARAGE** ADDITION

1513 GOLDEN GATE AVENUE SAN FRANCISCO, CA 94115




349 5th Avenue New York, NY 10016 T 646 741 0341



DOOR NOTES

- I. HARDWARE ON RATED DOORS SHALL BEAR UL LABEL 2. GENERAL CONTRACTOR TO PROVIDE CODE COMPLIANT SAFETY GLAZING WHERE REQUIRED
- B. GENERAL CONTRACTOR TO VERIFY SIZE OF DOORS TO FIT IN (E) OPENINGS.
- 4. EXTERIOR DOORS TO BE GLAZED WITH DOUBLE PANE, LOW-E CLEAR GLASS WITH U.V. PROTECTION 5. PROVIDE MASTER BEDROOM & ALL BATHROOMS W/ PRIVACY LOCKS.

DOOR TYPES

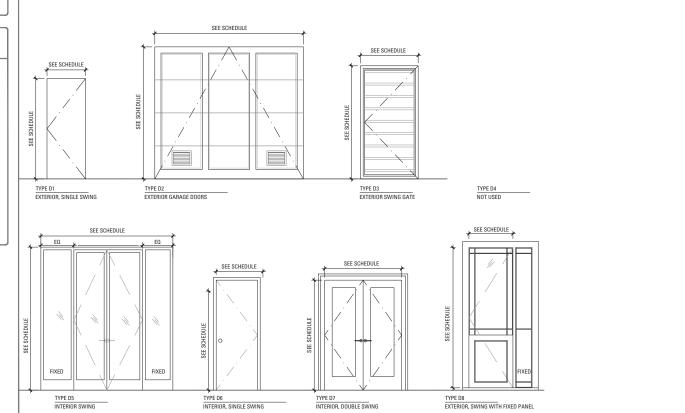

01.03.2018

SITE PERMIT SET PLANNING RESPONSE 1

PLANNING RESPONSE 2

06.05.2018

07.23.2018 09.07.2018

C.O.A. HEARING SET Drawn By:

A.W. Checked By: B.M. Project Number: 17011.1

SCHEDULES