Certificate of Appropriateness Case Report

HEARING DATE: JANUARY 21, 2015 CONTINUED FROM DECEMBER 17, 2014

Filing Date: June 12, 2014 Case No.: **2014.0655A**

Project Address: 3751-3753 20th Street

Historic Landmark: Liberty-Hill Landmark District

Zoning: RH-2 (Residential, House, Two-Family) Zoning District

40-X Height and Bulk District

Block/Lot: 3607/066

Applicant: Shane Curryn, Matarozzi/Pelsinger Builders, Inc.

355 11th Street, Ste. 200 San Francisco, CA 94103

Staff Contact Richard Sucre - (415) 575-9108

richard.sucre@sfgov.org

Reviewed By Timothy Frye – (415) 575-6822

tim.frye@sfgov.org

PROPERTY DESCRIPTION

3751-3753 20th STREET is a three-story, two-family residence designed in a simple Greek Revival architectural style located on a rectangular lot (measuring approximately 25 ft x 114 ft) on the south side of Liberty Street between Dolores and Guerrero Streets. Constructed prior to 1900, the existing building features wood-frame construction, wood siding, aluminum-sash and wood-sash windows, a gable roof, and is slightly setback from the street edge. At the street, the subject property features a brick retaining wall and a set of concrete steps. Currently, the subject property does not have any off-street parking.

Per Article 10 of the San Francisco Planning Code, 3751-3753 20th Street is designated as contributing resource to the Liberty-Hill Landmark District.

PROJECT DESCRIPTION

The proposed project consists of rehabilitation of the two-family residence, including:

- Construction of a New Garage/Basement Level: The project would construct a new three-car garage. The new garage opening would be approximately 9-ft wide and would feature painted, wood panel garage doors. The proposed curb cut would measure approximately 10-ft wide. As part of the work at the basement level, the project would replace the existing foundation with a new concrete foundation.
- Primary Façade Alterations: The project would remove the aluminum-sash window on the third
 floor and insert a pair of new eight-lite fixed windows to match the existing historic windows on

1650 Mission St. Suite 400 San Francisco, CA 94103-2479

Reception: 415.558.6378

Fax:

415.558.6409

Planning Information: 415.558.6377

the first and second floors. In addition, portions of the existing brick retaining wall would be removed to accommodate the new garage opening.

- **Inset Roof Windows**: The project would construct a set of inset wood-sash windows on the west and east facades of the existing gable roof.
- Rear Yard Alterations: The project would remove portions of the grade at the rear yard to provide exposure to the ground floor level. With the grade work, the subject property appears as four-stories tall. As part of the rear yard work, the project would construct a new set of stairs from the new grade up to the existing grade.
- Construction of Rear Addition: At the rear, the project would remove the existing two-story, non-historic rear addition and construct a new three-story horizontal addition with a roof deck that would extend approximately 34-ft 6-in from the existing rear wall. This new horizontal addition would feature large wood windows, a flat roof, and tongue and groove wood siding (dimensioned at half the height of the existing wood siding on the historic property). The new addition would also feature a roof deck at the third and fourth floor levels. These roof decks would feature a simple metal cable rail system around the roof deck perimeter.
- West/East Façade Alterations: The project would add new window and door openings on the west facade. The rear facade would be clad in a smooth stucco finish, and would feature woodsash casement windows.

The proposed project would increase the square footage of the two-family residence from 2,347 square feet to 7,111 square feet.

OTHER ACTIONS REQUIRED

Proposed work requires a Rear Yard Variance from the Zoning Administrator and a Building Permit from the Department of Building Inspection (DBI).

COMPLIANCE WITH THE PLANNING CODE PROVISIONS

The proposed project is in compliance with all other provisions of the Planning Code.

APPLICABLE PRESERVATION STANDARDS

ARTICLE 10

Pursuant to Section 1006.2 of the Planning Code, unless exempt from the Certificate of Appropriateness requirements or delegated to Planning Department Preservation staff through the Administrative Certificate Appropriateness process, the Historic Preservation Commission is required to review any applications for the construction, alteration, removal, or demolition of any designated Landmark for which a City permit is required. Section 1006.6 states that in evaluating a request for a Certificate of Appropriateness for an individual landmark or a contributing building within a historic district, the Historic Preservation Commission must find that the proposed work is in compliance with the Secretary of the Interior's Standards for the Treatment of Historic Properties, as well as the designating Ordinance and any applicable guidelines, local interpretations, bulletins, related appendices, or other policies.

2

THE SECRETARY OF THE INTERIOR'S STANDARDS

Rehabilitation is the act or process of making possible a compatible use for a property through repair, alterations, and additions while preserving those portions or features that convey its historical, cultural, or architectural values. The Rehabilitation Standards provide, in relevant part(s):

Standard 1: A property shall be used for its historic purpose or be placed in a new use that requires minimal change to the defining characteristics of the building and its site and environment.

The proposed project would maintain the subject property's current and historic use as a residence. Therefore, the proposed project complies with Rehabilitation Standard 1.

Standard 2: The historic character of a property shall be retained and preserved. The removal of historic materials or alteration of features and spaces that characterize a property shall be avoided.

The proposed project maintains the historic character of the subject property, as defined by its character-defining features, including, but not limited to, its overall mass and form, double-hung wood-sash windows, gable roof, wood siding, as well as, other elements identified in the designating ordinance for the landmark.

Overall, the project does not call for the removal of character-defining historic materials or features. On the front façade, the project would remove a non-historic aluminum-sash window and add a new compatible, wood-sash window within the gable. In addition, the project would remove a portion of the brick retaining wall to accommodate the new garage; however, the remainder of the brick retaining wall would be maintained in place. At the rear, the proposed project would remove a non-historic two-story rear addition and construct a new three-story horizontal rear addition, which would be located at the rear of the subject property and would be minimally visible from the public rights-of-way. This new addition would maintain a sense of the existing building's form and massing, since it would be located behind the existing gable roof, would not extend past the peak of the existing roofline, and would not impact any significant historic characteristics of the subject property. The new addition would not impact any historic materials or features of the subject property or district. Therefore, the proposed project complies with Rehabilitation Standard 2.

Standard 3: Each property will be recognized as a physical record of its time, place and use. Changes that create a false sense of historical development, such as adding conjectural features or architectural elements from other buildings, shall not be undertaken.

The proposed project does not include the addition of conjectural elements or architectural features from other buildings. The new work will not create a false sense of historical development and would be compatible with the surrounding district. Therefore, the proposed project complies with Rehabilitation Standard 3.

Standard 4: Most properties change over time; those changes that have acquired historic significance in their own right shall be retained and preserved.

The proposed project does not involve alterations to the subject building, which have acquired significance in their own right. The existing rear addition does not possess historical significance and does not contribute to the district's historic character. Therefore, the proposed project complies with Rehabilitation Standard 4.

Standard 5: Distinctive features, finishes, and construction techniques or examples of fine craftsmanship that characterize a property will be preserved.

The proposed project maintains and preserves the subject property's distinctive finishes and character-defining features, including, but not limited to, its overall mass and form, double-hung wood-sash windows, gable roof, and wood siding. The proposed project does include alteration of the existing gable to accommodate new inset windows on the west and east facades. These new windows still allow the overall form of the roof to be expressed, while minimizing a new feature. Therefore, the proposed project complies with Rehabilitation Standard 5.

Standard 6: Deteriorated historic features will be repaired rather than replaced. Where the severity of deterioration requires replacements of a distinctive feature, the new feature will match the old in design, color, texture and other visual qualities and, where possible, materials. Replacement of missing features shall be substantiated by documentary, physical, or pictorial evidence.

The proposed project does not call for the repair or replacement of any deteriorated historic features. The project does include replacement of non-historic aluminum-sash windows with new compatible wood-sash windows; however, this alteration does not affect any existing feature. Therefore, the proposed project complies with Rehabilitation Standard 6.

Standard 7: Chemical or physical treatments, such as sandblasting, that cause damage to historic materials shall not be used. The surface cleaning of structures, if appropriate, shall be undertaken using the gentlest means possible.

The proposed project does not involve chemical or physical treatments. Therefore, the proposed project complies with Rehabilitation Standard 7.

Standard 8: Significant archaeological resources affected by a project shall be protected and preserved. If such resources must be disturbed, mitigation measures will be undertaken.

The proposed project does include excavation and foundation work, and will undertake the appropriate mitigation and protection measures if any archaeological resource is uncovered. Therefore, the proposed project complies with Rehabilitation Standard 8.

SAN FRANCISCO
PLANNING DEPARTMENT

Standard 9:

New additions, exterior alterations, or related new construction will not destroy historic materials, features, and spatial relationships that characterize the property. The new work will be differentiated from the old and will be compatible with the historic materials, features, size, scale and proportion, and massing to protect the integrity of the property and its environment.

The proposed project includes exterior alterations to the subject property, including replacement of an aluminum-sash window for a new compatible wood-sash window, and construction of a new three-car garage and three-story horizontal addition.

The new three-car garage would be located along the eastern lot line via a 10-ft wide curb cut and a 9-ft wide garage entry. Garages are common alterations to residences within the surrounding district. Relative to the site's existing setting, the project would still maintain the building's historic setback's and the overall site's sloped character, as evidenced by the adjacent landscaping. The construction of this new garage would not impact any character-defining features of the existing residence. The new garage would feature a simple painted wood garage door, which is consistent with the subject property's simple architectural style, thus is compatible with the overall character of the residence.

On the front façade within the gable, the project would replace a non-historic aluminum-sash window with a new compatible, wood-sash window, which would match the remaining historic windows on the exterior façade. This aspect of the project assists in reinforcing the property's historic character by removing a non-historic element and introducing a new compatible feature.

At the rear, the new three-story horizontal addition is clearly differentiated from the historic mass of the original residence, as noted by the roofline and the change in siding. The project also includes trim board between the historic residence and the new addition to better distinguish between the old and new. The new addition has a flat roof, while the existing historic residence features a gable roof. The new additions would be constructed on top of an existing non-historic addition currently located at the rear of the existing residence. The new additions and rear façade alterations are compatible with the subject property's overall historic character, since the new work is occurring on a rear and non-visible façade, the new wood siding is similar in material and design to the property's historic wood siding (evident on the primary facades), and the mass of the new addition is differential to the historic mass of the original residence.

Overall, the proposed project maintains the historic integrity of the subject property and provides new additions, which are compatible, yet differentiated with the historic residence. Therefore, the proposed project complies with Rehabilitation Standard 9.

Standard 10:

New additions and adjacent or related new construction shall be undertaken in such a manner that if removed in the future, the essential form and integrity of the historic property and its environment would be unimpaired.

The proposed project includes construction of a three-story rear horizontal addition, which would be located behind the existing three-story residence. This new addition would not affect the essential form and integrity of the landmark district, and does not impact any character-defining features of the subject property. Therefore, the proposed project complies with Rehabilitation Standard 10.

Summary:

The Department finds that the overall project is consistent with the *Secretary of the Interior Standards for Rehabilitation*.

PUBLIC/NEIGHBORHOOD INPUT

As of January 9, 2015, the Department has received two public comments on the proposed project, which has expressed opposition to the project. Copies of these correspondences have been included within the Commissioner packets.

STAFF ANALYSIS

Included as an exhibit are architectural drawings of the existing building and the proposed project. Based on the requirements of Article 10 and the *Secretary of Interior's Standards*, Department staff has determined the following:

Construction of New Three-Car Garage: The project would construct a new three-car garage with a 10-ft wide curb cut and 9-ft wide garage door. This new garage would not impact any character-defining features of the subject property, and its location and character assist in maintaining the residence's historic setting and characteristic sloped lot. Given the character of the new garage doors, the project would assist in reinforcing the property's architectural style and its relationship to other properties on the street. This alteration would comply with the Secretary of the Interior's Standards for Rehabilitation and the requirements of Article 10 of the San Francisco Planning Code, since the new work would be compatible the existing historic features. To ensure compatibility with the surrounding landmark district, the Department has included a condition of approval to salvage and reuse the brick retaining wall within any new construction.

Primary Façade Alterations (Window Replacement): The proposed project includes replacement of an aluminum-sash window with a pair of new eight-lite, fixed wood-sash windows. This alteration would comply with the Secretary of the Interior's Standards for Rehabilitation and the requirements of Article 10 of the San Francisco Planning Code, since this work would remove an incompatible alteration and new work would be compatible with the existing historic features. To ensure compatibility, the Department has included a condition of approval for additional detail on the proposed window, including a window schedule.

Inset Roof Windows: The proposed project includes insertion of inset wood-sash roof windows on the east and west facades of the gable roof of the historic residence. This alteration would comply with the Secretary of the Interior's Standards for Rehabilitation and the requirements of Article 10 of the San Francisco Planning Code, since this work is minimal in amount of material removed from the roof, maintains the overall form and mass of roof, and constructed of a compatible material.

Three-Story Horizontal Rear Addition/East-West Façade Alterations: The proposed project includes a three-story rear horizontal addition and alterations to the east and west facades. This work would occur on the side (non-visible) and rear portions of the subject property and would not be visible from any public rights of way. The façade alterations on the side façades primarily consist of adding new windows and doors on the ground floor level. These alterations would not remove any character-defining historic materials, and would be in discrete locations not visible from any public rights-of-way, especially given the site's topography. The mass, scale and location of the new rear addition is consistent and compatible with the rear additions found on contributing properties within the surrounding district. Further, this work would not impact any character-defining features of the subject property or surrounding landmark district. The new materials on the rear facade (wood-siding and wood-sash windows) would be in alignment with the district's character-defining features, which include wood siding and wood-sash windows. Therefore, this alteration would comply with the Secretary of the Interior's Standards for Rehabilitation and the requirements of Article 10 of the San Francisco Planning Code, since the new work would be compatible with the historic features. To ensure compatibility with the surrounding landmark district, the Department has included a condition of approval to review and approval the proposed wood siding.

Rear Yard Alterations: The proposed rear yard alterations include excavation of the existing grade/yard and construction of a new rear yard staircase. The rear yard landscaping is not identified as a character-defining feature of the Liberty-Hill Landmark District. The proposed site work within the rear yard would not detract from the historical significance of the subject property or the surrounding landmark district.

Summary: Department staff finds that proposed work will be in conformance with the Secretary's Standards and requirements of Article 10, as the proposed work shall not adversely affect the special character or special historical, architectural, or aesthetic interest or value of the landmark and its site.

CONDITIONS OF APPROVAL

To ensure that the proposed work is undertaken in conformance with this Certificate of Appropriateness, staff recommends the following conditions:

- Prior to approval of the Building Permit, the Project Sponsor shall provide material samples, including the proposed wood siding, to ensure compatibility with the surrounding landmark district. These material samples shall demonstrate the range of color, texture and finish for the identified materials. Generally, the materials should feature a matte or painted finish, and be consistent with the building's overall historic character.
- Prior to approval of the Building Permit, the Project Sponsor shall provide a window schedule and conditions assessment. The window schedule shall detail the current issues with the existing windows on the primary façade, shall outline the repair methodologies and replacement products, and shall provide detailed information about the proposed material, glazing, dimension and profile.

Prior to approval of the Building Permit, the Project Sponsor shall salvage and reuse the retaining walls bricks. Since portions of the existing brick retaining wall would be removed, the Project Sponsor shall reuse the historic bricks within the repair of the exterior wall to the extent feasible, as determined by Planning Department Preservation staff.

ENVIRONMENTAL REVIEW STATUS

The Department anticipates publication of a Class 32 Categorical Exemption for the proposed project. Copies of this exemption shall be provided to the Historic Preservation Commission at the public hearing.

PLANNING DEPARTMENT RECOMMENDATION

Planning Department staff recommends APPROVAL WITH CONDITIONS of the proposed project as it appears to meet the *Secretary of the Interior Standards for Rehabilitation* and requirements of Article 10.

ATTACHMENTS

Draft Motion
Exhibits, including Parcel Map, Sanborn Map, Zoning Map, Aerial Photos, and Site Photos
Architectural Drawings
Project Sponsor Submittal-Neighborhood Outreach Log
Public Correspondence

RS: G:|Documents|Certificate of Appropriateness|2014.0655A 3751 20th St|CofA Case Report_3751 20th St.doc

Historic Preservation Commission Motion No. XXXX

HEARING DATE: JANUARY 21, 2015

1650 Mission St. Suite 400 San Francisco, CA 94103-2479

Reception: 415.558.6378

Fax:

415.558.6409

Planning Information: **415.558.6377**

Filing Date: June 12, 2014
Case No.: 2014.0655A

Project Address: 3751-3753 20th Street

Historic Landmark: Liberty-Hill Landmark District

Zoning: RH-2 (Residential, House, Two-Family) Zoning District

40-X Height and Bulk District

Block/Lot: 3607/066

Applicant: Shane Curryn, Matarozzi/Pelsinger Builders, Inc.

355 11th Street, Ste. 200 San Francisco, CA 94103

Staff Contact Richard Sucre - (415) 575-9108

richard.sucre@sfgov.org

Reviewed By Timothy Frye – (415) 575-6822

tim.frye@sfgov.org

ADOPTING FINDINGS FOR A CERTIFICATE OF APPROPRIATENESS FOR PROPOSED WORK DETERMINED TO BE APPROPRIATE FOR AND CONSISTENT WITH THE PURPOSES OF ARTICLE 10, TO MEET THE STANDARDS OF ARTICLE 10 AND TO MEET THE SECRETARY OF INTERIOR'S STANDARDS FOR REHABILITATION, FOR THE PROPERTY LOCATED ON LOT 066 IN ASSESSOR'S BLOCK 3607, DESIGNATED AS A CONTRIBUTING RESOURCE TO THE LIBERTY-HILL LANDMARK DISTRICT, AND LOCATED WITHIN RH-2 (RESIDENTIAL, HOUSE, TWO-FAMILY) ZONING DISTRICT AND A 40-X HEIGHT AND BULK DISTRICT.

PREAMBLE

WHEREAS, on June 12, 2014, Shane Curryn of Matarozzi/Pelsinger (Project Sponsor) on behalf of Justin McBaine (Property Owners), filed an application with the San Francisco Planning Department (Department) for a Certificate of Appropriateness for exterior alterations and a three-story rear addition to the subject property located on Lot 066 in Assessor's Block 3607.

WHEREAS, the Project received an exemption from the California Environmental Quality Act ("CEQA") as a Class 32 Categorical Exemption (CEQA Guideline Section 15332) on December XX, 2014.

WHEREAS, the Planning Department, Jonas Ionin, is the custodian of records, located in Case No. 2014.0655A at 1650 Mission Street, Fourth Floor, San Francisco, California; and

WHEREAS, on January 21, 2015, the Commission conducted a duly noticed public hearing on the current project, Case No. 2014.0655A (Project) for its appropriateness.

Motion No. XXXX Hearing Date: January 21, 2015

WHEREAS, in reviewing the Application, the Commission has had available for its review and consideration case reports, plans, and other materials pertaining to the Project contained in the Department's case files, has reviewed and heard testimony and received materials from interested parties during the public hearing on the Project.

MOVED, that the Commission hereby grants a Certificate of Appropriateness WITH CONDITIONS, in conformance with the project information dated November 4, 2014 and labeled Exhibit A on file in the docket for Case No. 2014.0655A based on the following findings:

CONDITIONS OF APPROVAL

To ensure that the proposed work is undertaken in conformance with this Certificate of Appropriateness, staff recommends the following conditions:

- 1. As part of the Site Permit, the Project Sponsor shall provide material samples, including the examples of the materials for the proposed stair tread and rise, handrails and rear stucco finish, to ensure compatibility with the surrounding landmark district. These material samples shall demonstrate the range of color, texture and finish for the identified materials. Generally, the materials should feature a matte or painted finish, and be consistent with the building's overall historic character.
- 2. As part of the Site Permit, the Project Sponsor shall provide a window schedule and conditions assessment. The window schedule shall detail the current issues with the existing windows on the primary façade, and shall outline the repair methodologies.
- 3. As part of the Site Permit, the Project Sponsor shall provide detailed drawings and specifications for the restoration of the existing wood trellis on the primary façade. The Project Sponsor shall provide detailed drawings of the existing trellis (including plan, section, elevations and details, as determined by Department staff) to assist in guiding the reconstruction. The specifications shall include a conditions assessment of the existing wood, as well as dimensions for the individual pieces of wood, in order to assist with the restoration.

FINDINGS

Having reviewed all the materials identified in the recitals above and having heard oral testimony and arguments, this Commission finds, concludes, and determines as follows:

- 1. The above recitals are accurate and also constitute findings of the Commission.
- 2. Findings pursuant to Article 10:

The Historic Preservation Commission has determined that the proposed work is compatible with the character of the Liberty-Hill Landmark District as described in designating ordinance and Article 10 of the San Francisco Planning Code.

2

CASE NO 2014.0655A 3751 20th Street

Motion No. XXXX Hearing Date: January 21, 2015

- That the proposed project features rear façade and rooftop alterations, which are compatible
 with the Landmark, since this new work does not destroy historic materials, and provides for
 alterations, which are compatible, yet differentiated.
- That the proposed addition is compatible with the historic residence and surrounding landmark district.
- That the essential form and integrity of the landmark district and its environment would be unimpaired if the alterations were removed at a future date.
- That the proposal respects the character-defining features of the Liberty-Hill Landmark District.
- The proposed project meets the requirements of Article 10.
- The proposed project meets the Secretary of the Interior's Standards for Rehabilitation, including:

Standard 2.

The historic character of a property shall be retained and preserved. The removal of historic materials or alteration of features and spaces that characterize a property shall be avoided.

Standard 9.

New additions, exterior alterations, or related new construction will not destroy historic materials, features, and spatial relationships that characterize the property. The new work will be differentiated from the old and will be compatible with the historic materials, features, size, scale and proportion, and massing to protect the integrity of the property and its environment.

Standard 10.

New additions and adjacent or related new construction shall be undertaken in such a manner that if removed in the future, the essential form and integrity of the historic property and its environment would be unimpaired.

3. **General Plan Compliance.** The proposed Certificate of Appropriateness is, on balance, consistent with the following Objectives and Policies of the General Plan:

I. URBAN DESIGN ELEMENT

THE URBAN DESIGN ELEMENT CONCERNS THE PHYSICAL CHARACTER AND ORDER OF THE CITY, AND THE RELATIONSHIP BETWEEN PEOPLE AND THEIR ENVIRONMENT.

GOALS

The Urban Design Element is concerned both with development and with preservation. It is a concerted effort to recognize the positive attributes of the city, to enhance and conserve those attributes, and to improve the living environment where it is less than satisfactory. The Plan is a definition of quality, a definition based upon human needs.

Motion No. XXXX Hearing Date: January 21, 2015

OBJECTIVE 1

EMPHASIS OF THE CHARACTERISTIC PATTERN WHICH GIVES TO THE CITY AND ITS NEIGHBORHOODS AN IMAGE, A SENSE OF PURPOSE, AND A MEANS OF ORIENTATION.

POLICY 1.3

Recognize that buildings, when seen together, produce a total effect that characterizes the city and its districts.

OBJECTIVE 2

CONSERVATION OF RESOURCES WHICH PROVIDE A SENSE OF NATURE, CONTINUITY WITH THE PAST, AND FREEDOM FROM OVERCROWDING.

POLICY 2.4

Preserve notable landmarks and areas of historic, architectural or aesthetic value, and promote the preservation of other buildings and features that provide continuity with past development.

POLICY 2.5

Use care in remodeling of older buildings, in order to enhance rather than weaken the original character of such buildings.

POLICY 2.7

Recognize and protect outstanding and unique areas that contribute in an extraordinary degree to San Francisco's visual form and character.

The goal of a Certificate of Appropriateness is to provide additional oversight for buildings and districts that are architecturally or culturally significant to the City in order to protect the qualities that are associated with that significance.

The proposed project qualifies for a Certificate of Appropriateness and therefore furthers these policies and objectives by maintaining and preserving the character-defining features of the South End Landmark District for the future enjoyment and education of San Francisco residents and visitors.

A) The existing neighborhood-serving retail uses will be preserved and enhanced and future opportunities for resident employment in and ownership of such businesses will be enhanced:

The proposed project will not have any impact on any existing neighborhood serving retail uses. Currently, the site does not possess any retail uses.

B) The existing housing and neighborhood character will be conserved and protected in order to preserve the cultural and economic diversity of our neighborhoods:

CASE NO 2014.0655A 3751 20th Street

Motion No. XXXX Hearing Date: January 21, 2015

The proposed project will strengthen neighborhood character by respecting the character-defining features of Liberty-Hill Landmark District in conformance with the Secretary of the Interior's Standards for Rehabilitation.

C) The City's supply of affordable housing will be preserved and enhanced:

The revisions to the theater rehabilitation project will have no impact to housing supply.

D) The commuter traffic will not impede MUNI transit service or overburden our streets or neighborhood parking:

The proposed project will not result in commuter traffic impeding MUNI transit service or overburdening the streets or neighborhood parking. The proposed project include new off-street parking, and the surrounding area is well-served by public transportation.

E) A diverse economic base will be maintained by protecting our industrial and service sectors from displacement due to commercial office development. And future opportunities for resident employment and ownership in these sectors will be enhanced:

The proposed project does not include commercial office development.

F) The City will achieve the greatest possible preparedness to protect against injury and loss of life in an earthquake.

Preparedness against injury and loss of life in an earthquake is unaffected by the proposed work. The proposed project included a seismic upgrade, which will be executed in compliance with all applicable construction and safety measures.

G) That landmark and historic buildings will be preserved:

The proposed project are in conformance with Article 10 of the Planning Code and the Secretary of the Interior's Standards for Rehabilitation.

H) Parks and open space and their access to sunlight and vistas will be protected from development:

The proposed project will not impact the access to sunlight or vistas for parks and open space.

4. For these reasons, the proposal overall, is appropriate for and consistent with the purposes of Article 10, meets the standards of Article 10, and the *Secretary of Interior's Standards for Rehabilitation*, General Plan and Prop M findings of the Planning Code.

Motion No. XXXX CASE NO 2014.0655A Hearing Date: January 21, 2015 3751 20th Street

DECISION

That based upon the Record, the submissions by the Applicant, the staff of the Department and other interested parties, the oral testimony presented to this Commission at the public hearings, and all other written materials submitted by all parties, the Commission hereby **GRANTS WITH CONDITIONS a Certificate of Appropriateness** for the property located at Lot 066 in Assessor's Block 3607 for proposed work in conformance with the project information dated November 4, 2014, labeled Exhibit A on file in the docket for Case No. 2014.0655A.

APPEAL AND EFFECTIVE DATE OF MOTION: The Commission's decision on a Certificate of Appropriateness shall be final unless appealed within thirty (30) days. Any appeal shall be made to the Board of Appeals, unless the proposed project requires Board of Supervisors approval or is appealed to the Board of Supervisors, such as a conditional use, in which case any appeal shall be made to the Board of Supervisors (see Charter Section 4.135).

Duration of this Certificate of Appropriateness: This Certificate of Appropriateness is issued pursuant to Article 10 of the Planning Code and is valid for a period of three (3) years from the effective date of approval by the Historic Preservation Commission. The authorization and right vested by virtue of this action shall be deemed void and canceled if, within 3 years of the date of this Motion, a site permit or building permit for the Project has not been secured by Project Sponsor.

THIS IS NOT A PERMIT TO COMMENCE ANY WORK OR CHANGE OF OCCUPANCY UNLESS NO BUILDING PERMIT IS REQUIRED. PERMITS FROM THE DEPARTMENT OF BUILDING INSPECTION (and any other appropriate agencies) MUST BE SECURED BEFORE WORK IS STARTED OR OCCUPANCY IS CHANGED.

I hereby certify that the Historic Preservation Commission ADOPTED the foregoing Motion on January 21, 2015.

Commission Secretary

AYES:

NAYS:

ABSENT:

ADOPTED: January 21, 2015

Jonas P. Ionin


Parcel Map





Certificate of Appropriateness Hearing **Case Number 2014.0655A** 3751-3753 20th Street

Sanborn Map*

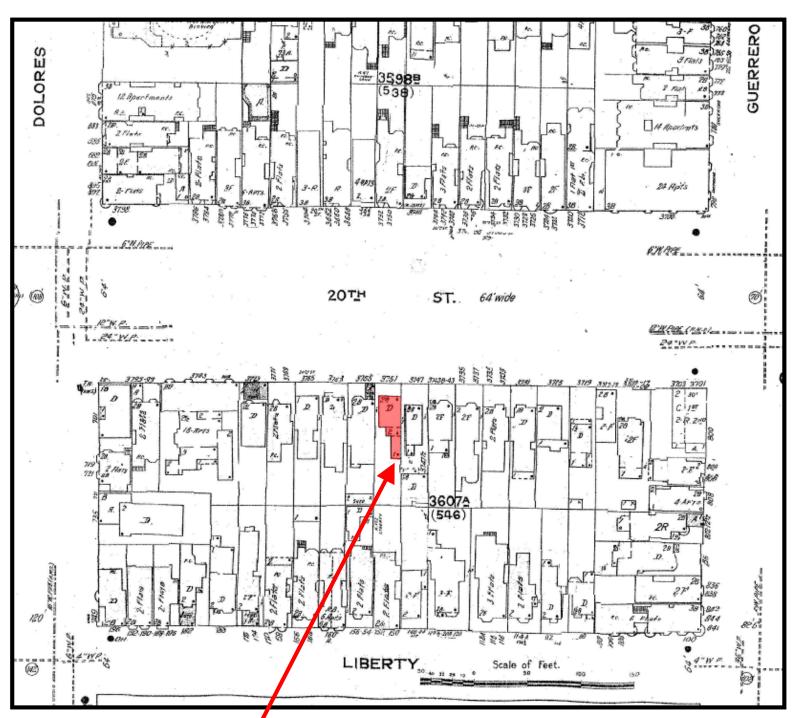


*The Sanborn Maps in San Francisco have not been updated since 1998, and this map may not accurately reflect existing conditions.

SUBJECT PROPERTY



Certificate of Appropriateness Hearing **Case Number 2014.0655A** 3751-3753 20th Street

Zoning Map

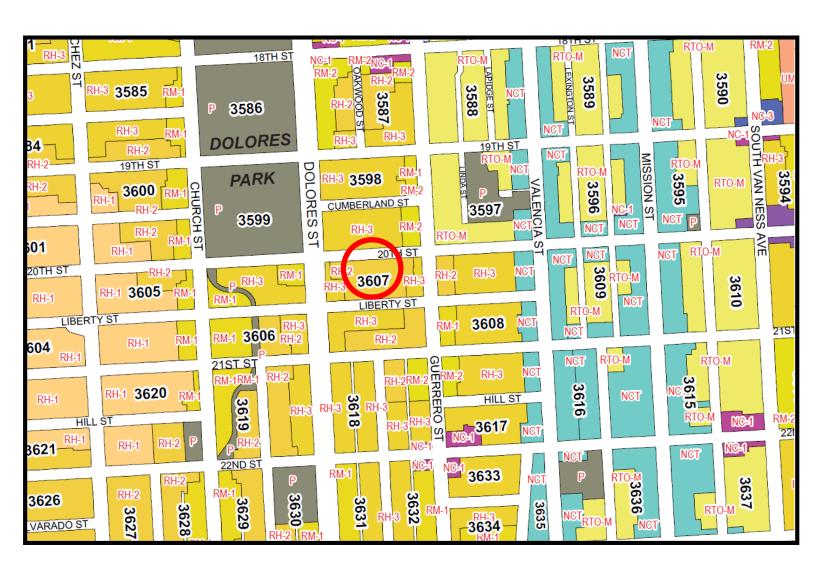





Certificate of Appropriateness Hearing Case Number 2014.0655A 3751-3753 20th Street

Aerial Photo

SUBJECT PROPERTY

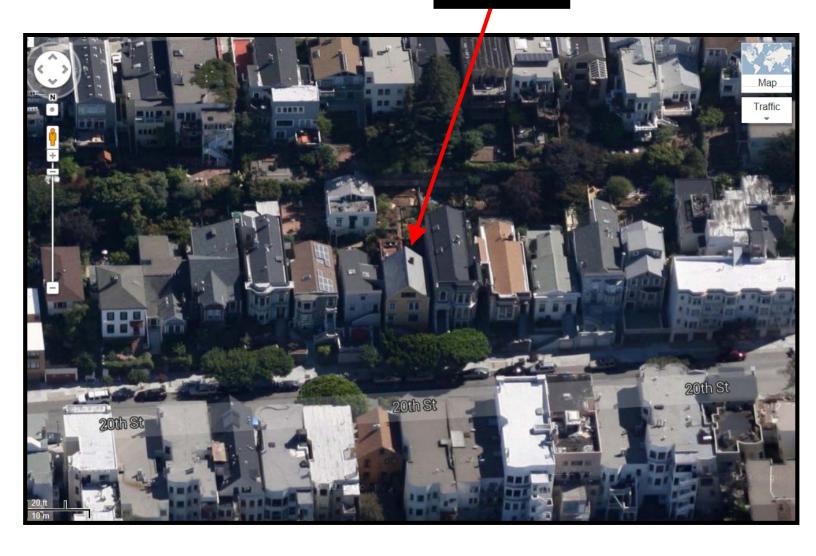

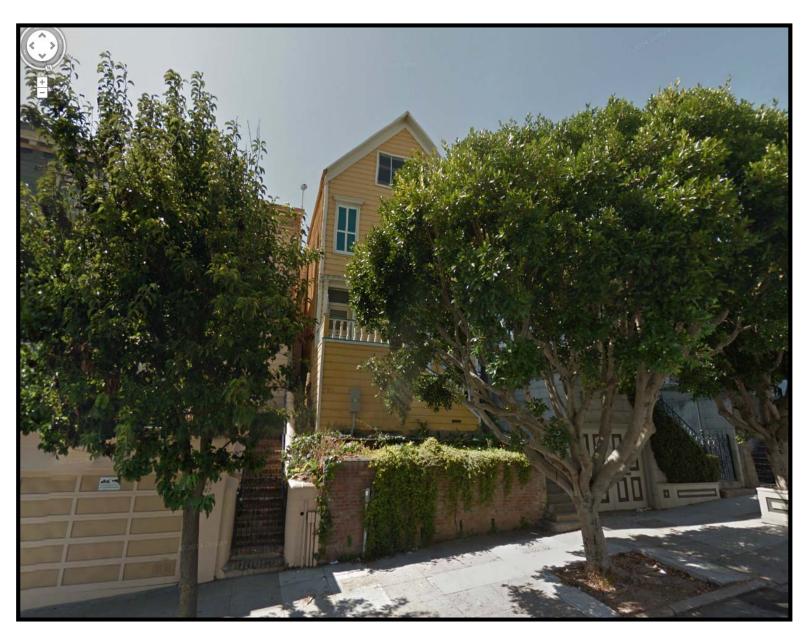


3751-3752 20th Street (Source: Google Maps, August 2014)

Certificate of Appropriateness Hearing Case Number 2014.0655A 3751-3753 20th Street




3751-3752 20th Street (Source: Planning Department, August 2014)

Certificate of Appropriateness Hearing Case Number 2014.0655A 3751-3753 20th Street

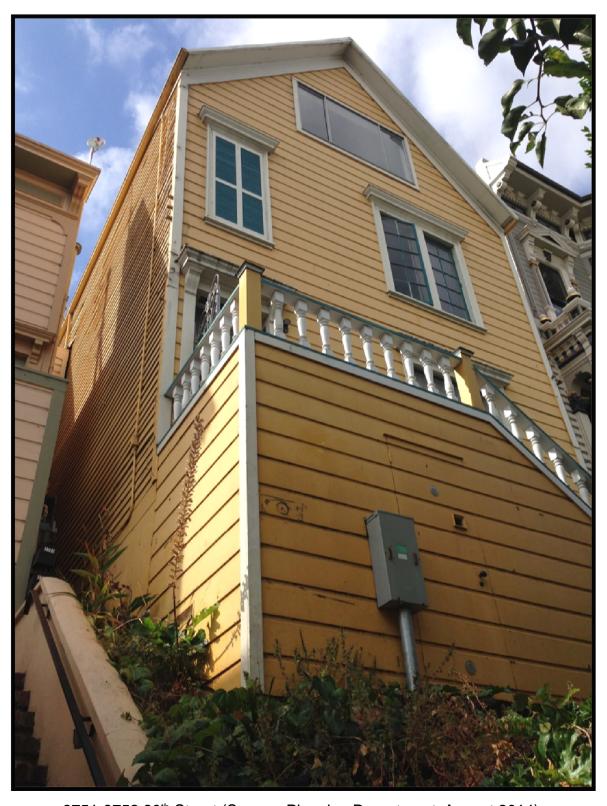

3751-3752 20th Street (Source: Planning Department, August 2014)

Certificate of Appropriateness Hearing Case Number 2014.0655A 3751-3753 20th Street

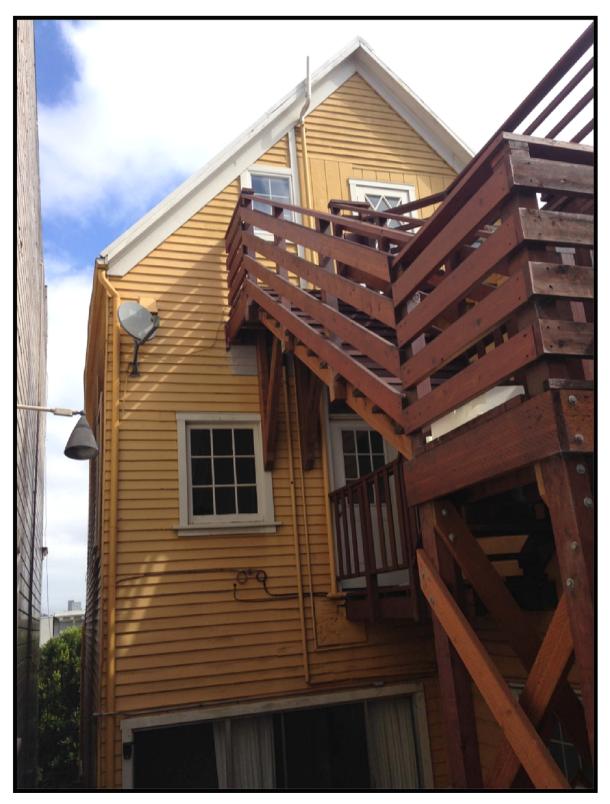

3751-3752 20th Street, Rear Facade (Source: Planning Department)

Certificate of Appropriateness Hearing Case Number 2014.0655A 3751-3753 20th Street

MATAROZZI PELSINGER

DESIGN + BUILD

A DIVISION OF MATAROZZI PELSINGER BUILDERS, INC.

355 11th Street, Suite 200 San Francisco, CA 94103 P: 415.289.6930 F: 415.285.7266 www.matpelbuilders.com

3751 20th St. - Neighbor Outreach Log

Date: 01.08.15

8/25/2013, Liberty Hill Neighborhood Association, 10 Hill (Voluntary Outreach):

Informational meeting with LHNA officers to introduce ourselves and discuss general process for their review and comment on the project. No design presented at this point, only existing site plan showing rear-yard envelope per SF Planning Code.

2/4/2014, Liberty Hill Neighborhood Association, 338 Lexington (Voluntary Outreach):

Project drawings presented to the full LHNA membership as an agenda item at their regular meeting. Membership voted unanimously to support the project. The following materials were presented:

Slideshow:

https://www.dropbox.com/s/s3a9wwxwf2b2kgt/3751%2020th%20St_Liberty%20Hill%20Mtg_Final.pdf?dl=0

Handout:

https://www.dropbox.com/s/t275oxm3hi6brkc/3751%2020th%20St Handout Final.pdf?dl=0

3/4/2014, 5PM, Meeting with Immediate Neighbors to the West at 3755 20th (Henry Hewitt and Sharon Meadows), 3751 20th (Voluntary Outreach):

The owners were generally supportive, but expressed some concern about views from the new rear addition into their rear yard and asked if we could explore ways to increase privacy and reduce view line. We discussed various mitigating measures such as plantings, and reduced bedroom window size. We agreed to have a follow up meeting to review our proposed changes to address the privacy issue. The following materials were presented:

Slideshow:

https://www.dropbox.com/s/a20zroeserecfro/3751%2020th%20St_Pre-App%20Neighbor%20Mtg_Final.pdf?dl=0

3/4/2014, 6PM, Meeting with Immediate Neighbors to the East at 3747 20th (front structure, Corrie & Daniel Conrad) and 3749 20th (rear yard structure, Ingrid Eggers), 3751 20th (Voluntary Outreach):

Owner's Daniel & Corrie Conrad (3747 20th, front) and Ingrid Eggers (3749 20th, rear) attended the meeting. Daniel & Corrie Conrad asked several questions to make sure they clearly understood the drawings and proposed changes, but did not request any specific revisions to the proposal. Ingrid Eggers expressed general concern about the scale of the remodel and rear addition, particularly with respect to the negative effects the construction activity would have on her AirBnB business renting out the lower unit within her home. We asked Ingrid Eggers if there were any specific aspects of the project that she would like to discuss revision, she responded

MATAROZZI PELSINGER

that she felt we ought to abandon the project entirely and seek out a different property that does not require such extensive remodeling. The following materials were presented:

Slideshow:

https://www.dropbox.com/s/a20zroeserecfro/3751%2020th%20St_Pre-App%20Neighbor%20Mtg Final.pdf?dl=0

3/25/2014, Pre-Application Meeting with Neighbors, 3751 20th (Required Outreach):

Sign-in Sheet:

 $\frac{https://www.dropbox.com/s/u44dw0x967zeo7b/3751\%2020th\%20St_PreApplicationMtg_SignIn.}{pdf?dl=0}$

Summary:

 $\frac{https://www.dropbox.com/s/y9i96o2eb5oplym/3751\%2020th\%20St_PreApplicationMtg_Summary.pdf?dl=0$

Drawings Presented:

 $\underline{https://www.dropbox.com/s/40jlt8qq8um5xq6/3751\%2020th\%20St_PreApplicationMtg_Dwgs.pdf?dl=0}$

5/7/2014, Meeting with 3755 20th Owners (Henry Hewitt and Sharon Meadows) to Review Privacy Modifications to Rear Addition, 3751 20th (Voluntary Outreach):

We met with 3755 20th owner Henry Hewitt and presented a combined strategy of planting screens plus reduced bedroom window with an operable shutter functioning as a privacy blind to shield view from the bedroom at 3751 to the rear yard of 3755. The drawings were favorably received. The following materials were presented:

Slideshow:

 $\frac{https://www.dropbox.com/s/bnj4nfrh9eprcw8/3751\%2020th\%20St_Privacy\%20Modifications.pdf}{?dl=0}$

12/16/2014, Meeting with 3755 20th Owners (Henry Hewitt and Sharon Meadows) and Structural Engineer to research existing foundation configuration on their property: The project team toured the lower levels of 3755 20th with the owners to identify the general extent of the sub-grade structure on their lot with the goal of identifying an appropriate preliminary strategy for foundation wall configuration and shoring along the shared property line.

1/13/2015 (Pending), Meeting with 3747 20th Owners (Corrie & Daniel Conrad) to discuss their questions and concerns about the proposed project

Sucre, Richard (CPC)

From: Lynch, Laura (CPC)

Sent: Tuesday, November 18, 2014 8:33 AM

To:eggers ingridCc:Sucre, Richard (CPC)Subject:RE: 3751/3753 20th Street

Hi Ingrid,

Thank you for your comment I will be sure to address your comment as it pertains to my environmental review of the project. I know you have previously spoken to Rich Sucre, but I am ccing him on this email as well. Rich will be reviewing the historic preservation aspect of the project as well as the consistency with the Residential Design Guidelines and the Planning Code. Once the environmental review document is complete I will send you a copy of the report. Please let me know if you would prefer a hard copy of the report or an electronic version.

Best,

Laura C. Lynch | Planner
San Francisco Planning Department | Environmental
1650 Mission Street, Suite 400 | San Francisco, California, 94103
T: (415) 575-9045 | Web: www.sfplanning.org | laura.lynch@sfgov.org

From: eggers ingrid [mailto:iegg44@yahoo.com]
Sent: Tuesday, November 18, 2014 6:08 AM

To: Lynch, Laura (CPC)

Subject: 3751/3753 20th Street

Dear Laura Lynch,

I'm out of the country and in response to your letter of November 7, I hope that this email is acceptable for voicing my concerns regarding the renovation of 3751-53 20th Street.

Last spring the neighbors were introduced to Justin McBean's renovation plans and I reacted by voicing my concerns to him and to Richard Sucre in earlier emails. I'm happily to do it again hoping that it might result in some changes.

My house, 3749 (built around 1880), is located in the back of the garden on a lot with 2 houses almost the same size as 3751/53. Separated from the front house, 3747, by a small garden, I live in about 1200 square feet (about the same as the front house) surrounded by plants and light. I love my small house tucked away from street noise. To update 3751/53 with garage, a new deck, dormers for better views and new interior is perfectly acceptable to me, as long as the unique character of the block is retained and my living and air space is not curtailed. The scope of the renovation, however, does not promise this. Two big boxes are supposed to be added on

the south side toward my house which will not just change my view - looking against walls instead of trees and a deck - the boxes will also significantly reduce light and airspace on my doorsteps. My guest and living room facing north, as well as the small garden space between 3747 and 3749 will be boxed in by the planned extension.

To more than triple the existing footprint in a historic neighborhood that is already overdeveloped, turns this project into the most aggressive renovation that I have seen on my block in the 16 years I have been living here. I think that digging 25 feet into the ground for a 3 car garage and another unit on top of it, plus adding 2 big boxes in the back of the 140 year old unique house in order to live in more space, will ruin my quality of life and the charm of this historic neighborhood. Does the planning department really want to encourage developing 2300 square feet living space into 7100 on limited historic ground just to allow a developer to build his "dreamhouse"?

I will return to SF on December 5 and more than willing to voice my concerns in person.

Thank You Ingrid Eggers

www.germangems.com

Sucre, Richard (CPC)

From: Corrie Conrad < corrie.conrad@gmail.com>

Sent: Monday, January 05, 2015 4:16 PM

To: Sucre, Richard (CPC)
Cc: Daniel Conrad

Subject: Neighbor input from 3747 20th for the review of 3751-3753 20th

Hi Richard,

My family is the direct neighbor of the proposed renovations for 3751-3753 20th street. We learned from our neighbor Ingrid Eggers that the town hearing was moved from Dec 17th to January 21st. We're disappointed that the meeting was moved, as we'll be out of town on the 21st (we're gone that whole week).

I wanted to make sure you received and are aware of our concerns (see below). Additionally, I wanted to see if it might be possible to move the hearing to a date that might be able to attend? Is there a process for requesting that?

Please let us know if there's any additional information we can provide for you.

Thanks,

- Corrie

----- Forwarded message -----

From: Corrie Conrad < corrie.conrad@gmail.com>

Date: Tue, Nov 18, 2014 at 12:56 PM

Subject: Neighbor input from 3747 20th for the review of 3751-3753 20th

To: laura.lynch@sfgov.org

Cc: Daniel Conrad com, richard.sucre@sfgov.org

Laura,

Thanks for getting back to me today. I'm glad we were able to connect. As requested, here's a summary of our current concerns regarding the proposed plans for 3751-3753 20th street. I've copied my husband and also Rich Sucre, whose information you provided, so Rich is also aware of our concerns.

Laura/Rich please let me know what else we need to do and feel free to share this summary with others, if useful. I'd be happy to find time to meet in person, attend relevant meetings, etc.

Our current major concerns are:

- **Foundation:** What will be done to ensure our home's foundation remains strong and intact? (Particularly given the depth of the work proposed.)
 - What verification has or will occur? What about water runoff and how that might affect our foundation? What this will mean for us and how is our property is being taken into consideration, how will it be protected?

- We're aware that water runoff can be and has been an issue for the downhill home (in this case us) with other construction projects on our side of our block. My understanding is a neighbor a few houses up has to constantly pump water out of his garage due the impact of a neighboring project. We're concerned about the depth of the proposed work and it's potential impact on our home.
- **Light:** We're concerned about how the extension in the back will block light into our garden patio and into our home. We enjoy growing things in our back patio, and enjoy the sunlight on warm days outside and inside, when the rays come through our glass doors into the kitchen and dining area. We're worried about losing this.
- **Noise**: Our baby is and will continue to be cared for at home. His schedule currently involves 2 daily naps. We're concerned about the impact of the construction noise on him and our general well being while home.
- **Duration and scope:** We're generally in favor of improvements to homes in our neighborhood, but have been quite taken aback by the sheer size and scope of this proposed project. We're concerned about how long this will take (we heard that a garage project across the street took years, and this is bigger than that) and how long we would be living in the chaos and uncertainty of such a large project (since some of the impact on our home won't be known until construction starts, it seems the uncertainty could last awhile.)

Laura, you mentioned a geotech report, which I haven't seen. If you are able to email us a copy, we'd appreciate it.

Thanks for the work you do. I can only imagine how tough it is to be a city planner.

- Corrie

Corrie White Conrad
Twitter: @corrieconrad

Corrie White Conrad
Twitter: @corrieconrad

ABBREVIATIONS

ADDR	EVIATIONS	
& ABV. AC.T. ADJ. ADJ.C. AFF. ALL. ANOD. APPROX. ARCH. AXON.	AND AT ABOVE AR CONDITIONING ACOUSTIC CEILING TILE ADJUSTABLE ADJACENT ABOVE FINISHED FLOOR ALTERNATE ALJUNINUM ANODIZED APPROXIMATE ACCHITECTURAL AXONOMETRIC	(N) NAT. N.I.C. NO. # NOM. N.T.S. OBSC. O.C. O.D. O.H. OPER. OPP.
BD. B.J. BLDG. BLKG. B.O. B.P. BRZ. B.U.R.	BOARD BUTT-JOINT BUILDING BLOCKING BOTTOM OF BUILDING PAPER BRONZE BUILT-UP ROOF	PART. PERF. PL. P.L. P.LAM. PLAS. PLY.
CAB. CER. CHAN. C.I.P. C.L. CLG. CLG. CLG. CLG. CLG. CMU. CONC. CONT. CONT. CPT.	CABINET CEMENT CEMENT CERAMIC CHANNEL CAST-IN-PLACE CENTERLINE CLEAR CELING CLOSET CLEAR CONCRETE MASONRY UNIT COLUMN CONCRETE CONTINUOUS CARPET CENTER	PNT. PROP. PTD. PT. P.V. R. R. B. P. REF. REF. REFIN. REQD. REV. RM
DEPT. DET. D.F. DIA. DIM. DN. DR. DW. DWG.	DEPARTMENT DETAIL DOUGLAS FIR DIAMETER DIMENSION DOWN DOOR DISHWASHER DRAWING	R.O. RTD. R.W.L. S.C. SCHED. S.A SECT. S.E.D.
(E) EA. ELEV. ELECT. ENGR. EQ. EQPT. EXEC. EXP. EXT.	EXISTING EACH ELEVATION ELEVATION ELECTRICAL ENGINEER EQUIAL EQUIPMENT EXECUTIVE EXPANSION EXTERIOR	SHT. SHTG. SIM. S.L.D. S.M.D. S.P.D. S.P.E. S.S. S.S.D. STD. STL. STOR.
FAB. F.B.O. F.D. FIXT. F.C. F.O.F. F.O.C. FRM. FRMG. FT. FURR.	FABRIC FURNISHED BY OWNER FLOOR DRAIN FINISH FIXTURE FLOOR FINISHED OPENING FACE OF FINISH FACE OF STUD FACE OF CONCRETE FRAME FRAME FOOT OR FEET FURRING	STRUCT. SUSP. SYM. T.B.D. TEL. TEMP. TEMP. TF.WD. T&G. T.O. T.O.C. T.O.C.
GA. GALV. G.D. GEN. GL. GYP. G.W.B.	GAUGE GALVANIZED GARBAGE DISPOSAL GENERAL CLASS GYPSUM GYPSUM WALL BOARD	TRANS. TV. TYP. U.B.C. U.C. U.O.N. UTIL
H.B. H.C. HDWD. HT. HORIZ. HR. H.M. H.W.	HOSE BIB HOLLOW CORE HARDWOOD HEIGHT HORIZONTAL HOUR HOLLOW METAL HOT WATER	VAR. V.T. VEN. VERT. VEST. VI.F. VP.
I.D. IN. INSUL. INT.	INSIDE DIAMETER INCH INSULATION INTERIOR	W/C. WD. W/D
JAN. JT.	JANITOR JOINT	WIN. W.H. W/O
KIT.	KITCHEN	W.O. W.P. WT.
LAM, LAV, LOC, LTWT, LVL.	LAMINATE LAVITORY LOCATION LIGHTWEIGHT LEVEL	270
MAT. MAX. M.B. M.C. MECH. MEMB. MFR. MIN. MIR. MISC. MSRY. MTL.	MATERIAL MAXIMUM MOISTURE BARRIER MEDICINE CABINET MECHANICAL MEMBRANE MANUFACTURER MINIMUM MIRROR MISCELLANEOUS MASONRY MOUNTED METAL	

SYMBOLS

NEW
NATURAL
NOT IN CONTRACT
NUMBER
NUMBER
NOMINAL
NOT TO SCALE

OBSCURE
ON CENTER
OUTSIDE DIAMETER
OPPOSITE HAND
OPERABLE
OPENING
OPPOSITE

PARTITION
PERFORATED
PLATE
PLASTIC LAMINATE
PLASTIC LAMINATE
PLASTER
PLYMOOD.
PANEL
PAINT
PROPERTY
PAINTED
PRESSURE TREATED
PHOTOVOLTAIC

RADIUS
RISER
RESILIENT BASE
RESILIENT BASE
REFLECTED CEILIING PLAN
REFERENCE
REFRIGERATOR
REFINISH
REINEORCED

REFINISH REINFORCED REQUIRED REVISION/REVISED ROOM ROUGH OPENING RATED RAIN WATER LEADER


RAIN WATER LEADER
SOLID CORE
SCHEDULE
SOAP DISPENSER
SECTION
SEE ELECTRICAL DRAWINGS
SHEET
SHEATHING
SEE LANDSCAPE DRAWINGS
SEE MECHANICAL DRAWINGS
SEE PLUMBING DRAWINGS
SPECIFICATION
STAINLESS STEEL
STONG
STANDARD
STEEL
STONG
STONE
STORAGE
STRUCTURAL
STONE
STORAGE
STRUCTURAL
SUSPENDED
SYMMETRICAL

TREAD
TO BE DETERMINED
TELEPHONE
TELEPHONE
TEMPERED
TEMPORARY
TRANSPARENT FINISH
TRANSPARENT FINISH
TRANSPARENT FINISHED WOOD
TONGUE AND GROOVE
TOP OF CONCRETE
TOP OF CONCRETE
TOP OF WALL
TRANSLUSCENT
TELEVISION
TYPICAL

UNIFORM BUILDING CODE UNDER COUNTER UNLESS OTHERWISE NOTED UTILITY

VARIES
VINYL COMPOSITION TILE
VENEER
VERTICAL
VESTIBULE
VERIFY IN FIELD
VENEER PLASTER

WITH
WATER CLOSET
WOOD
WASHER/DRYER
WINDOW
WATER HEATER
WITHOUT
WHERE OCCURS
WATERPROOFING
WEIGHT

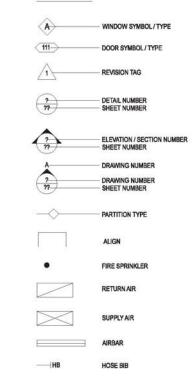

DIRECTORY

NAME ADDRESS EMAIL

MATAROZZI PELSINGER DESIGN+BUILD 355 11TH STREET, SUITE 200 SAN FRANCISCO, CA 94103 T 415.285.6930

VICINITY MAP



PROJECT SITE

PROJECT DATA

3751/3753 20TH STREET SAN FRANCISCO, CA 94110

BLOCK/LOT#

ZONING DISTRICT

OCCUPANCY GROUP

RESIDENTIAL UNITS -2 EXISTING (NO CHANGE)

TYPE OF CONSTRUCTION

HEIGHT LIMIT 40-X

SCOPE OF WORK

AN YERTICAL ADDITION BELOW (F) GRADE
(N) HORIZONTAL ADDITION @ REAR
(N) ELEVATOR
(N) CURB CUT & GARAGE DOOR
(N) CURB CUT & GARAGE DOOR
(N) DORNER WINDOWS
REPLACE (E) FRONT GABLE WINDOW WITH (N) WOOD WINDOW

PARCEL AREA 2,848 SQ.FT.

BUILDING AREA (GROSS)

-EXISITNG: 2,347 SQ.FT. -PROPOSED: 7,111 SQ.FT.

APPLICABLE BUILDING CODES

2013 CALIFORNIA BUILDING CODE (C.B.C.)
2013 CALIFORNIA BUILDING CODE (C.P.C.)
2013 CALIFORNIA MECHANICAL CODE (C.M.C.)
2013 CALIFORNIA ELECTRICAL CODE (C.B.C.)
2013 CALIFORNIA ELECTRICAL CODE (C.B.C.)
2013 CAL GREEN BUILDING CODE (CALGREEN)
2013 SAN FRANCISCO AMENOMENTS TO C.B.C,
C.P.C., C.M.C, C.E.C., AND CALGREEN

SHEET INDEX

ARCHITECTURAL

ARCHITECTURAL
A0.1 - PROJECT INFORMATION
A0.2 - PHOTOS- NORTH & SOUTH STREET FACADES (BLOCK)
A0.3 - PHOTOS- SUBJECT PROPERTY & NEIGHBORS
A0.38 - PHOTOS - NEIGHBORS
A0.4 - ARTICLE 10 DEMOLITION CALCULATIONS
A0.5 - PRE-APPLICATION MEETING INFO
A0.6 - TREE PLANTING AND PROTECTION CHECKLIST

C.0 - SURVEY

A1.1 - SITE PLANS - EXISTING & PROPOSED

A3.1 - SECTION - NORTH-ISOUTH, EXISTING
A3.2 - SECTION - NORTH-ISOUTH, PROPOSED
A3.3 - (UNUSED)
A3.4 - ELEVATION - NORTH, EXISTING
A3.5 - ELEVATION - NORTH, PROPOSED
A3.6 - ELEVATION - SOUTH, EVISTING
A3.7 - ELEVATION - SOUTH, PROPOSED
A3.8 - ELEVATION - EAST, EVISTING
A3.9 - ELEVATION - EAST, PROPOSED
A3.10 - ELEVATION - EAST, EXISTING
A3.11 - ELEVATION - WEST, EXISTING
A3.11 - ELEVATION - WEST, PROPOSED



3751 / 3753 20th STREET

3751 20TH STREET, SAN FRANCISCO, CA,

13045.70

JOR

SITE PERMIT


11.04.2014

REVISION:

SHEET TITLE:

COVER SHEET

SHEET NUMBER:

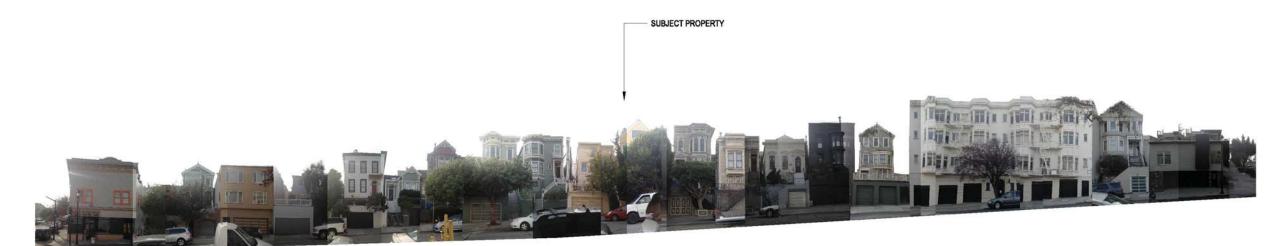

20TH STREET - SOUTH SIDE NOT TO SCALE



20TH STREET - NORTH SIDE NOT TO SCALE

355 11TH STREET, SUITE 200 SAN FRANCISCO CA 94103 T 415.285.6930 F 415.285,7266 WWW.MATPELBUILDERS.COM

MATAROZZI PELSINGER DESIGN + BUILD

2

3751 / 3753 20th STREET

3751 20TH STREET, SAN FRANCISCO, CA, 94110

13045.70

SITE PERMIT

10.2.2014

REVISION:

SHEET TITLE:

PHOTOGRAPHS: NORTH & SOUTH 20TH STREET

SHEET NUMBER:



VIEW FROM REAR OF SUBJECT PROPERTY

NOT TO SCALE

SUBJECT PROPERTY



SUBJECT PROPERTY

SUBJECT PROPERTY & ADJACENT NEIGHBORS - REAR NOT TO SCALE

SUBJECT PROPERTY

SUBJECT PROPERTY & ADJACENT NEIGHBORS - FRONT NOT TO SCALE

355 11TH STREET, SUITE 200 SAN FRANCISCO CA 94103 T 415.285.6930 F 415.285,7266 WWW.MATPELBUILDERS.COM MATAROZZI PELSINGER DESIGN + BUILD



3751 / 3753 20th STREET

13045.70

SITE PERMIT

3751 20TH STREET, SAN FRANCISCO, CA, 94110

10.2.2014

REVISION:

SHEET TITLE:

PHOTOGRAPHS: SUBJECT PROPERTY FRONT & REAR


SHEET NUMBER:







WEST NEIGHBOR - PROPERTY LINE WINDOWS NOT TO SCALE

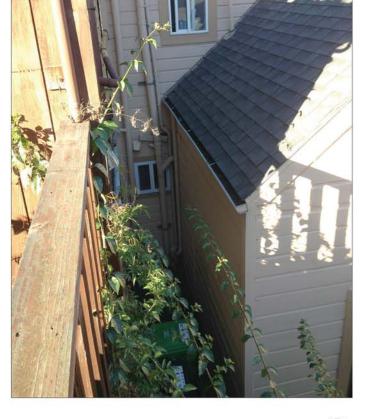

EAST NEIGHBOR - REAR NOT TO SCALE

355 11TH STREET, SUITE 200 SAN FRANCISCO CA 94103 T 415.285.6930 F 415.285,7266 WWW.MATPELBUILDERS.COM MATAROZZI PELSINGER DESIGN + BUILD



3751 / 3753 20th STREET

13045.70

SITE PERMIT

3751 20TH STREET, SAN FRANCISCO, CA, 94110

11.04.2014

SHEET TITLE:

PHOTOGRAPHS: NEIGHBORS

SHEET NUMBER:

A0.3B



NORTH ELEVATION, (E)

SCALE: 1'-0" = 1/8"

WEST ELEVATION, (E)

SCALE: 1'-0" = 1/8"

Internal Structural Walls and Floorplates, Removal (Limit = 75%):							
Element	Total Area	Removed Area	% Removed				
1st Floor Walls	1067.04	1067.04	100.0%				
1st Floor Plate	960	776	80.8%				
2nd Floor Walls	720.5	720.5	100.0%				
2nd Floor Plate	836	200.5	24%				
3rd Floor Walls	0	0	0%				
3rd Floor Plate	650.4	18	3%				
Roof	N/A	N/A	N/A				
Total:	4233.94	2782.04	65.7%				

ARTICLE 10 DEMOLITION CALCULATIONS

355 11TH STREET, SUITE 200 SAN FRANCISCO CA 94103 T 415.285.6930 F 415.285.7286 WWW.MATPELBUILDERS.COM MATAROZZI PELSINGER DESIGN + RIIII P



3751 / 3753 20th STREET

13045.70

SITE PERMIT

10.2.2014

REVISION:

SHEET TITLE: ARTICLE 10: DEMOLITION CALCULATIONS

SHEET NUMBER:

Alboard for Pre-Application Meeting

Affidavit for Pre-Application Meeting

Alkalad for Pre-Application Meeting

Pre-Application Meeting Sign-in Sheet	
Meeting Date: 3/25/2014 Meeting Time: 6pm Meeting Address; 3751 20th Street, San Francisco, CA 94110 Project Address; 3751 20th Street, San Francisco, CA 94110 Property Owner Name: Justin McBaine Project Sponsor/Representative: Shane Curnyn, Matarozzi Pelsinger Design + Build	
Please print your name below, state your address and/or affiliation, with a neighborhood gro your phone number. Providing your name below does not represent support or opposition is for documentation purposes only.	oup, and provide to the project; it
NAMEJORGANIZATION ADDRESS PHONE: EMAIL 1. LINGSHY Kefauren 3739 20th St. Liberty allowe 2. Virginia Wichigun 15th Liberty allowe 3. Injin Eggas 3749 20th St. 4. PATM GOODE 3750 20th St. Pja	send Plans en@sbcglobal ivet of
5	
6.	
7	E1
8	п
9.	(1)
10	
11.	0
12.	ш
13.	
14.	
15.	⊸ □
16.	П
17.	
18.	.0

feeting Date: 3/25/2014 feeting Time: 6:00pm feeting Address: 3751 20th St., San Francisco, CA 9 roject Address: 3751 20th St., San Francisco, CA 94 roperty Owner Name: Justin McBaine	4110
leeting Time: 6:00pm leeting Address: 3751 20th St., San Francisco, CA 9 roject Address: 3751 20th St., San Francisco, CA 94	4110
roject Address: 3751 20th St., San Francisco, CA 94	4110
ronarty Owner Name: Justin McBaine	110
roject Sponsor/Representative: Shane Curnyn, Matz	rozzi Pelsinger Design + Build
lease summarize the questions/comments and your bace below. Please state if/now the project has been	response from the Pre-Application meeting in the modified in response to any concerns.
ruestion/Concern #1 by (name of concerned neighbo agrid Eggers (3749 20th St.): The construction pha	r/neighborhood group):
ngrid Eggers (3749 20th St.): The construction pha usiness.	se of the project will negatively effect my Airbnb
roject Spansor Response: le intend to do everything within our power to mi	itigate the effect of construction on 3749. If there
re specific concerns, please let us know so we can	
igrid Eggers (3749 20th St.): The rear addition seen the fact that my unit is at the rear of our lot.	ns larger than what Planning would allow given
the rock trial triy trial 15 of the real of our for	
roject Sponsor Response: /e have met with Planning twice and have confirm	
mensions. Pushing the Pop-Out to the west will n	equire a variance, but we are prepared to pursue
imensions. Pushing the Pop Out to the west will ruls in order to provide 3749 with a more generous	equire a variance, but we are prepared to pursue
imensions. Pushing the Pop-Out to the west will rule in order to provide 3749 with a more generous	equire a variance, but we are prepared to pursue
mensions. Pushing the Pop-Out to the west will n	equire a variance, but we are prepared to pursue
imensions. Pushing the Pop-Out to the west will rule in order to provide 3749 with a more generous	equire a variance, but we are prepared to pursue
mensions. Pushing the Pop-Out to the west will rules in order to provide 3749 with a more generous tuestion/Concern #3:	equire a variance, but we are prepared to pursue
imensions. Pushing the Pop-Out to the west will rule in order to provide 3749 with a more generous	equire a variance, but we are prepared to pursue
mensions. Pushing the Pop-Out to the west will rules in order to provide 3749 with a more generous tuestion/Concern #3:	equire a variance, but we are prepared to pursue
mensions. Pushing the Pop-Out to the west will rules in order to provide 3749 with a more generous tuestion/Concern #3:	equire a variance, but we are prepared to pursue
mensions. Pushing the Pop-Out to the west will rules in order to provide 3749 with a more generous tuestion/Concern #3:	equire a variance, but we are prepared to pursue
mensions. Pushing the Pop-Out to the west will rolls in order to provide 3749 with a more generous tuestion/Concern #3:	equire a variance, but we are prepared to pursue
mensions. Pushing the Pop-Out to the west will rules in order to provide 3749 with a more generous tuestion/Concern #3:	equire a variance, but we are prepared to pursue
mensions. Pushing the Pop-Out to the west will rolls in order to provide 3749 with a more generous tuestion/Concern #3:	equire a variance, but we are prepared to pursue
mensions. Pushing the Pop-Out to the west will rolls in order to provide 3749 with a more generous tuestion/Concern #3:	equire a variance, but we are prepared to pursue connection to the mid-block open space.

Affidavit of Conducting a Pre-Application	Meeting,
Sign-in Sheet and Issues/Responses sub	mittal

1, Justin McBaine , do hereby declare as follows:

- I have conducted a Pre-Application Meeting for the proposed new construction or alteration prior to submitting any entitlement (Building Permit, Variance, Conditional Use, etc.) in accordance with Planning Commission Pre-Application Policy.
- The meeting was conducted at 3751 20th Street, San Francisco, CA 94110 (location/address) on 3/25/2014 (date) from 6pm-7pm (time).

 (in time).
- I have included the mailing list, meeting initiation, sign-in sheet, issue/response summary, and reduced plans with the entitlement Application. I understand that I am responsible for the accuracy of this information and that erroneous information may lead to suspension or revocation of the permit.
- 1 have prepared these materials in good faith and to the best of my ability.

I declare under penalty of perjury under the laws of the State of California that the foregoing is true and

, 20 14 IN SAN FRANCISCO.

EXECUTED ON THIS DAY, 3/25

Justin McBaine

3751 20th Street, San Francisco, CA 94110

MATAROZZI PELSINGER DESIGN + BUILD

355 11TH STREET, SUITE 200 SAN FRANCISCO CA 94103 T 415.285.8930 F 415.285,7266 WWW.MATPELBUILDERS.

3751 / 3753 20th STREET

3751 20TH STREET, SAN FRANCISCO, CA, 94110

13045.70

SITE PERMIT

11.04.2014

SHEET TITLE:

PLANNING PRE-APPLICATION MEETING INFO

REQUIRED CHECKLIST FOR **Tree Planting** and Protection

1. Applicant Information

CONTACT FOR PROJECT INFORMATION		
Justin McBaine		
ADDRESS	TELEPHONE	
Matarozzi Pelsinger Builders	(415) 466-8239	
355 11th St., Ste. 200	EMAL	
San Francisco, CA, 94103	jtmcb@yahoo.com	

2. Location and Classification of Property

XOSS ATREETS			
20th & Do	lores		
ASSESSORS SLI	DOKLOT -	LENSTH OF ALL LOT PHONTAGE(S):	ZONNA DISTRICT
3607	/ 066	25'	RH-2

3. Scope of Project

Requirements for new street trees and tree protection apply to the types of projects identified in the chart belor Please check all boxes which apply to your project. If no boxes are checked, you do not need to complete this f

	1				
	DEVELOPMENT PEATURES				
	construction of a rew liquiding				
	refooallon of a fulliding				
	painting or repairing more than 200 square feet of the front settleds.				
(X)	addition of gross floor axes (GFA) equal to 20% or more of the GFA of the existing building				
	addition of a new dwalling unit				
(X)	addition of one or more perking spaces				
X	addition of a garage				

4. Disclosure of Existing Protected Trees

Only the following specific types of trees require protection under the Public Works Code: Street Trees, Significant Trees and Landmark Trees. These trees are collectively known as "Protected Trees." In the following table, please indicate the presence or lack thereof of such on, over, or adjacent to the pared containing the proposed construction.

SIGNIFICANT TREES		
any portion of its trunk within 10	is planted on the subject property (i.e. outside of the public feet of the public right-of-way that has (a) a diameter at brea height in excess of twenty feet OR (c) a canopy in excess of	st height (DBH)
CHECK ALL BOXES THAT APPLY AND INDICATE GUANTITY OF EACH TREE TYPE. IF APPROPRIATE.	Significant Tree(s) exist on the subject property	atv
If you are unable of the boundary of the public opin-of-way, contact DPV's Bureau of Street Use and Magping. Please note that the public	Significant Tree(s) exist on any adjacent property	CTY
ight of way may be wider than the sidewalk.	X There are no Significant Trees on or adjacent to the su	bject property.

OHECK ALL BOXES THAT APPLY AND INDICATE QUANTITY OF	☐ Landmark Trees exist on the subject property ☐					
EACH TREE TYPE, IF APPROPRIATE	Landmark Trees exist on the adjac	QTY				
If you have questions about the presence of Landmark Trees, pieces consult with CFW or visit serve above originate.	Landmark Trees exist on any adjacent property					
	🗵 There are no Landmark Trees on or adjacent to the subject property.					
	COMPLETE LIST OF LANGMARK TREES AS OF SUMM	IER 2012				
	the More Owner or parent for 1801 Book Street	Sistrian proper at Trind St. and W.	pentle Breekin the nedler.			
	Flamed papertielt at 1701 Franklin Street	Gweet Stop at 555 Bulliery Street				
	New Zealand Christman Tree of 1221 Storyon Street	All Canally Island Calls Paints In the carrier strand on Dishares Str				
	19 Carrey Island Date Falms in Oversida 81 median west of Int St.	Text Painte protection accounts 700 Dollares St & 1546 Dollares				
	Gualitium Petro in the median proces from 1606-1050 Delivers SI	Coeff he call in the business of 20-26 Recomment Place				
	Qualitative Females the median across from 1606-1050 December St.		Constitue calco the bellows of 4124 23rd Street			
	California Indicapa in the header across from 1004 (050 California II)	Coathe ok tithe baltons if #	24 23rd Street			
		Cost he call to the heatquist of # Size Edeberg new Princetton of				
	California bulkeya in Parlamiyani of 750 SBIN Avenue		Federat & Denial Heights Str			
	California hudwyner Periadrigani et 73038th Beense Teo Howerry Ant at the Same Library et 500 Contand Sawet	Sin Edebergines Edenation of	Fuluren & Burnal Heighte Str r 2520 Vallejo Street			

TREET TREES							
"Street Tree" is any tree growing within the public right-of-way (e.g. sidewalk) that is not also a Landmark Tree.							
HECK THE BOX THAT APPLIES AND ICICATE GUARTITY IF APPROPRIATE.	[X] Street Trees exist adjacent to the subject property	gre	1				
ingenthese of some all traves in the public right-	There are no Street Trees adjacent to the present						

5. Impact of Project on Existing Protected Trees

If your responses above indicate that any Protected Tree(s) exist on, over or adjacent to the subject property, please check the applicable boxes, below:

BOX 1
The project will not remove or have any other impact on Protected Trees, as follows: No construction-related activity whatsoever will occur within the displine of any Significant Tree or Street Tree. This includes, but is not limbed to, the following: (1) No grading or exexuation will take place within the dripline of any Significant Tree or Street Tree, (2) No construction staging and/or storage of materials and/or equipment will occur within the dripline of any Significant Tree or Street Tree, (2) No construction staging and/or storage of materials and/or equipment will occur within the dripline of any Significant Tree or Street Tree, (3) No discounties of train and/or liquide (such as project waste-water) will take place within the basin or dripline of any Significant Tree or Street Tree.

If you have checked this box, a Tree Protection Plan is not required.

BOX 2 The project involves the removal of one or more Protected Trees. A permit from DPW is required in order to remove any Protected Tree. The Planning Department will not approve a building permit for a project which involves the removal of a Protected Tree unless DPW has first reviewed the proposal and found it to be consistent with applicable rules and regulations.

If you have checked this box, a Tree Protection Plan is not required, however you must provide evidence to the Planning Department that DPW has reviewed the removal request and found it to be "approvable."

BOX 3 The project may have an impact on one or more Protected Trees which are not proposed for removal, as follows: Ether (1) any construction-related activity, no matter how minor, is planned or is reasonably foreseeable to occur within the dripline of a Significant Tree or a Street Tree or (2) regardless of the location of construction activity, the property contains a Landmark Tree.

If you have checked this box, a Tree Protection Plan must be submitted to the Department of Public Works Bureau of Urban Forestry prior to the commencement of any construction activity,

Such plan must meet the following minimum standards:

- The Tree Protection Plan must be developed by an International Society of Arboriculture (ISA) Certified Arborist.
- The project sponsor must submit a written declaration that the protections specified in the Tree Protection Plan will be completely in place prior to the start of any construction, demolition, or grading.
- √ Full-size site plans submitted along with the associated construction project must clearly indicate Full-size aside plans submitted along with the associated construction project must clearly indict the street, carry, sidewalk, drivway, structure(s), and the locations of all Protected Trees and non-protected trees. Protected Trees must also be a hown to include accurate tree height plans must graphically depict implementation for all measures called for in the Tee Protection Plans Additionally, the Tree Protection Plans held along with the written destination must be resproduced on full-size plans.

6. Calculation of Number of New Required Street Trees

One street tree is required for each 20 feet of street frontage of the subject property, with fractions of 0.5 rounded up, however credit is given for existing street trees. Please complete the table below to determine the number of street trees required for your project. In on street trees are required, please skip to the Applicant's Affaidant at the end of this form and once signed, return it to the Planning Department along with your Building Permit Application or other application.

COMMINED LENGTH OF ALL STREET FRONTAGES		CING PLOURIEN				W.V.S NUMBER DESTING TREES		NUTSTANT THE REQUIRENT
25'	+	20'	-	1	(operan)	1	-	. 0

Unless site conditions physically prevent the planting of a street tree, a waiver or modification of street free requirements is available only under extremely limited circumstances and only outside of Residential Districts (i.e. RH, RM, RTO, RED). Be aware that even when available, an in-kind improvement or in-lieu payment is required for every such waiver. Please contact the Planning Department for information regarding the salver process.

7. Applicable Requirements for New Street Trees:

The Planning Department has developed three distinct 'Tree Schedules' to aid in the implementation of the Planning Code's street tree requirements. The particular Tree Schedule applicable to your project will depend on the zoning district in which your property is located, the scope of your project, and the type of authorization that your project requires. In general terms, Tree Schedule A applies to small-scale projects in residential or industrial zoning districts. Tree Schedule B applies to moderate-scale projects or projects in commercial or mixed-use zoning districts, and Tree Schedule C applies to larger projects. In the following chart, please check the applicable box based on the characteristics

	THEE	PRO	JECT CHARACTERISTICS			
The project is located in a Recidential (RH, RM, RTO, RED), Industrial (M) or Productic Zoning District and does not involve a Flanned Unit Development (FUD). A PUD is a speak the Planning Commission that applies only to major peoples thanking large properties.				ed Unit Development (PUD). A PUD is a special authorization granted by		
		1.	The project is located in a RH. RM	A, RT	D, RED, M or PDR Zoning District and Involves a PUD	
		OR				
	В	2.	The project is located outside of an RH. RM, RTO, RED, M or PDR Zoning Desict and meets neither OR one of the following criteria, but not both:	4	It is located on a percel that contains (1) more than 1/2-ecre in total oran or (2) more than 250 feet of total street frontage or (3) street frontage which spans the entire block face between the nearest two intersections.	
				V	It involves (1) the construction of a new building or (2) the addition of more than 20% of the gross floor area of the existing building or (3) a change of use of more than 50% of the existing square footage of the building.	
	С		project is located outside of an Ri dule B(2), above.	H, PA	f, RTO, RED, M or PDR Zoning District and meets both criteria of Tree	

	TREE SCHED	ULE A	
	REQUIREMENT	SPECIFICATION	
1	Location	either in the public right of-way (e.g. s (Sewell) adjacent to the properly or within an unfoultiere at the front of the property.	
1	Size	ninnum at 56-inch beautite	

either in the public right of way je.g. sidewide sopport to the property or within an unbuilt area at the first of the property Applicant's Affidavit Thereby attest under penalty of perjury that the information I have entered on this document is true and correct to the best of my have belogs, and that I have read and understood this form, and that I am the property owner or authorized agest of the property correct, insultar with the property and able the provide accurate and complete information in mexic. The undersigned agrees is the conditions of this form. I understand that knowingly or negligently providing take or unidenaling information in response to finit disclosure requirement may lead to denial or recisions of my permit or other authorization and my obstitute a violation of the Sno Faccion Maniegal Code, which can lead to criminal and/or viol legal action and the imposition of the snow of the imposition of the Sno Faccion Maniegal Code, which can lead to criminal and/or viol legal action and the imposition of the Sno Faccion Maniegal Code, which can lead to criminal and/or viol legal action and the imposition of the snow of the imposition of the snow of the properties of the criminal and/or violation of the snow of the imposition of the snow of the conditions of the snow of the conditions of the snow o (415) 466-8239 jtmcb@yahoo.com

Planning Department Determination

DULDING PERMIT LOAGE SO		
NAMA DATED		
New Street Trees	New street trees are not required as part of this project.	
	Street Trees are required as part of this project.	
	Number of new street trees required:	
	Applicable Tree Schedule: A D B D C	
	Compliance with as-of-right requirements shown on pix 178. In the second of the second	HA VER APPROVED:
Existing Tree	A Tree Protection Plan is not required: Box 1 or Box 2 in 1	Section 5 has been marked
Protection	A Time Protection Plan is required: Box 3 in Section 5 has	been marked.
Existing Tree	☐ No Protected Trees are proposed for removal.	
Removal	One or more Protected Trees are proposed for removal.	
STAFF TO SESP UNLESS A W	AVER OR MODIFICATION HAS BEEN APPROVED, IN WHICH CASE ZA MONATU	W IS RECURRED

Staff Checklist

- The applicant has completed this entire checklist including the affidavit on the preceding page.
- If street trees are required, a building permit cannot be approved until the applicant provides evidence from DPW that the required planting permit can be issued.
- If Protected Trees are proposed for removal, a building permit cannot be approved until the applicant provides evidence from DPW that tree removal permits can be issued.
- If a Tree Protection Plan is required, the applicant has been informed verbally and/or in writing of his or her obligation to submit one directly to DPW prior to the commencement of construction.
- Once signed, a copy of this checklist has been returned to the applicant. The original has been included in the project file or, if processed over-the-counter, it has been routed upstairs for scanning by support staff.

200 SAN FRANCISCO CA 94103 7266 WWW.MATPELBUILDERS MATAROZZI PELSINGER DESIGN + BUILD

355 11TH STREET, SUITE T 415.285.



3751 / 3753 20th STREET


13045.70

SITE PERMIT

11.04.2014

SHEET TITLE:

TREE PLANTING & **PROTECTION** CHECKLIST

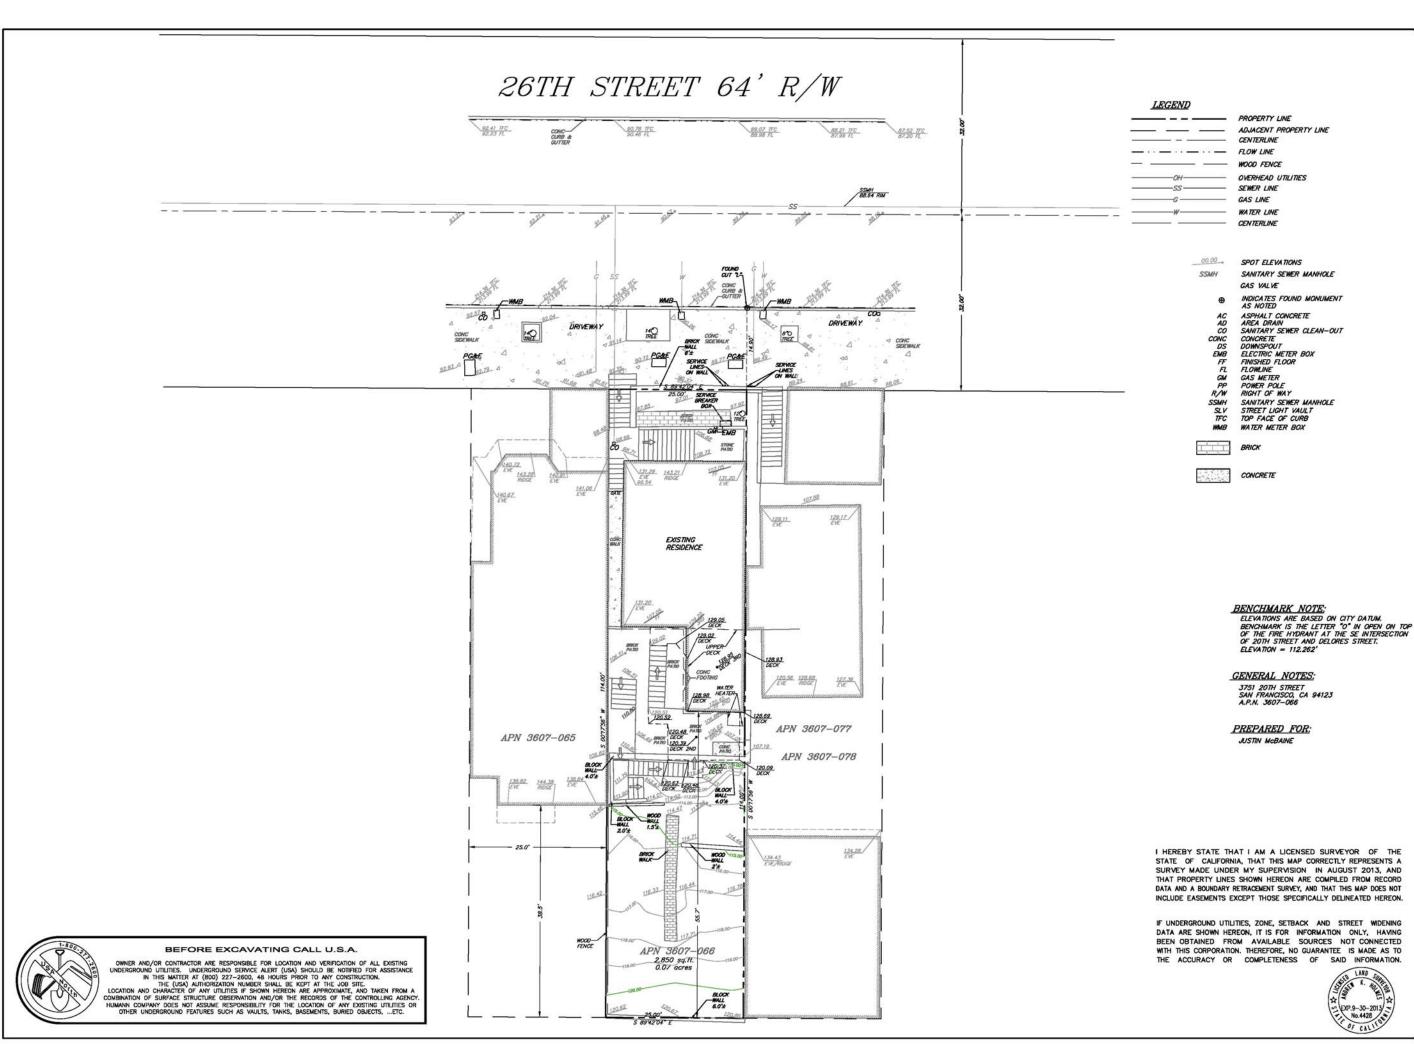

TOPOGRAPHIC SURVEY
751 20TH STREET

GIY AND COUNTY OF SAN FRANCISCO

triod/holmes osoc.
civil engineering public worke land development
BRADNITURE IN 1878 334-337

Triol/Normal Associate
All Rights Reserved. If
Disconvent is intended of
for the on the Project
Specified in the 17the Site
Any Reproduction of to
Disconvent, Billious the
Expressed Ritten Cossess
Triol/Normal, at Prohibit
REMISIONS


DATE 08/15/13


BCALE 1"=8'

DRAWN MN

09-1561 09-1571 TOPO

09-1571 T

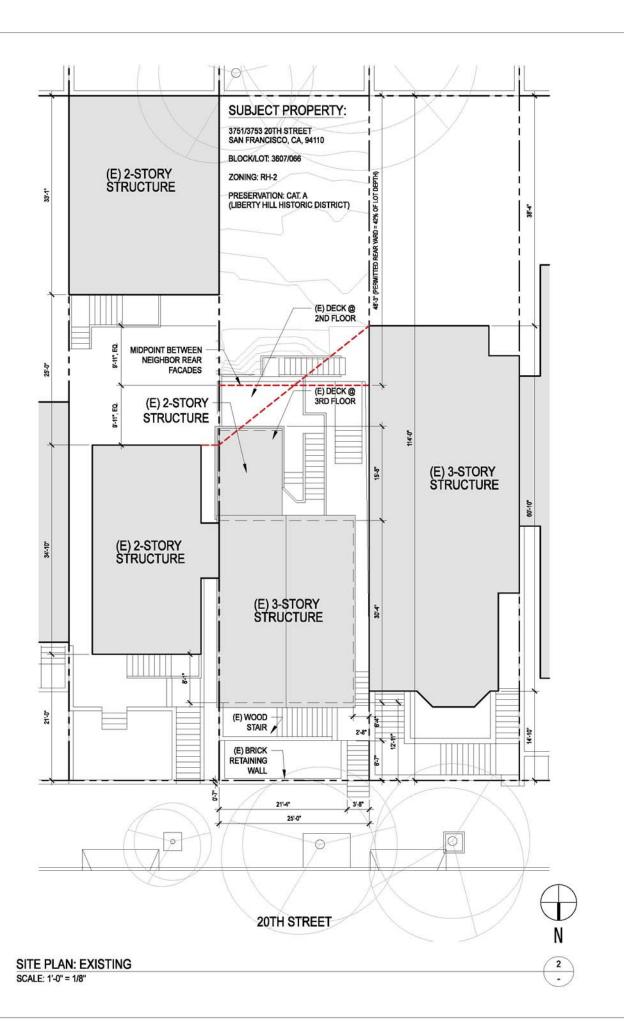

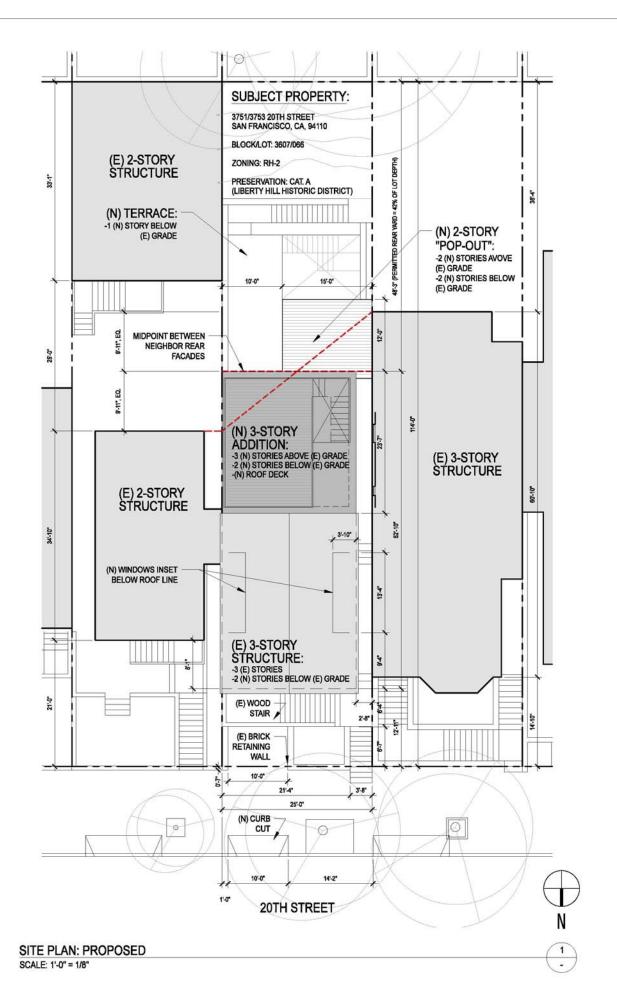

355 11TH STREET, SUITE 200 SAN FRANCISCO CA 94103 T 415.285.6930 F 415.285.7286 WWW.MATPELBUILDERS.COM

MATAROZZI PELSINGER DESIGN + BUILD



3751 / 3753 20th STREET

3751 20TH STREET, SAN FRANCISCO, CA, 94110

13045.70

SITE PERMIT


10.28.2014


REVISION:


SHEET TITLE:


SITE PLAN: EXISTING & PROPOSED


SHEET NUMBER:

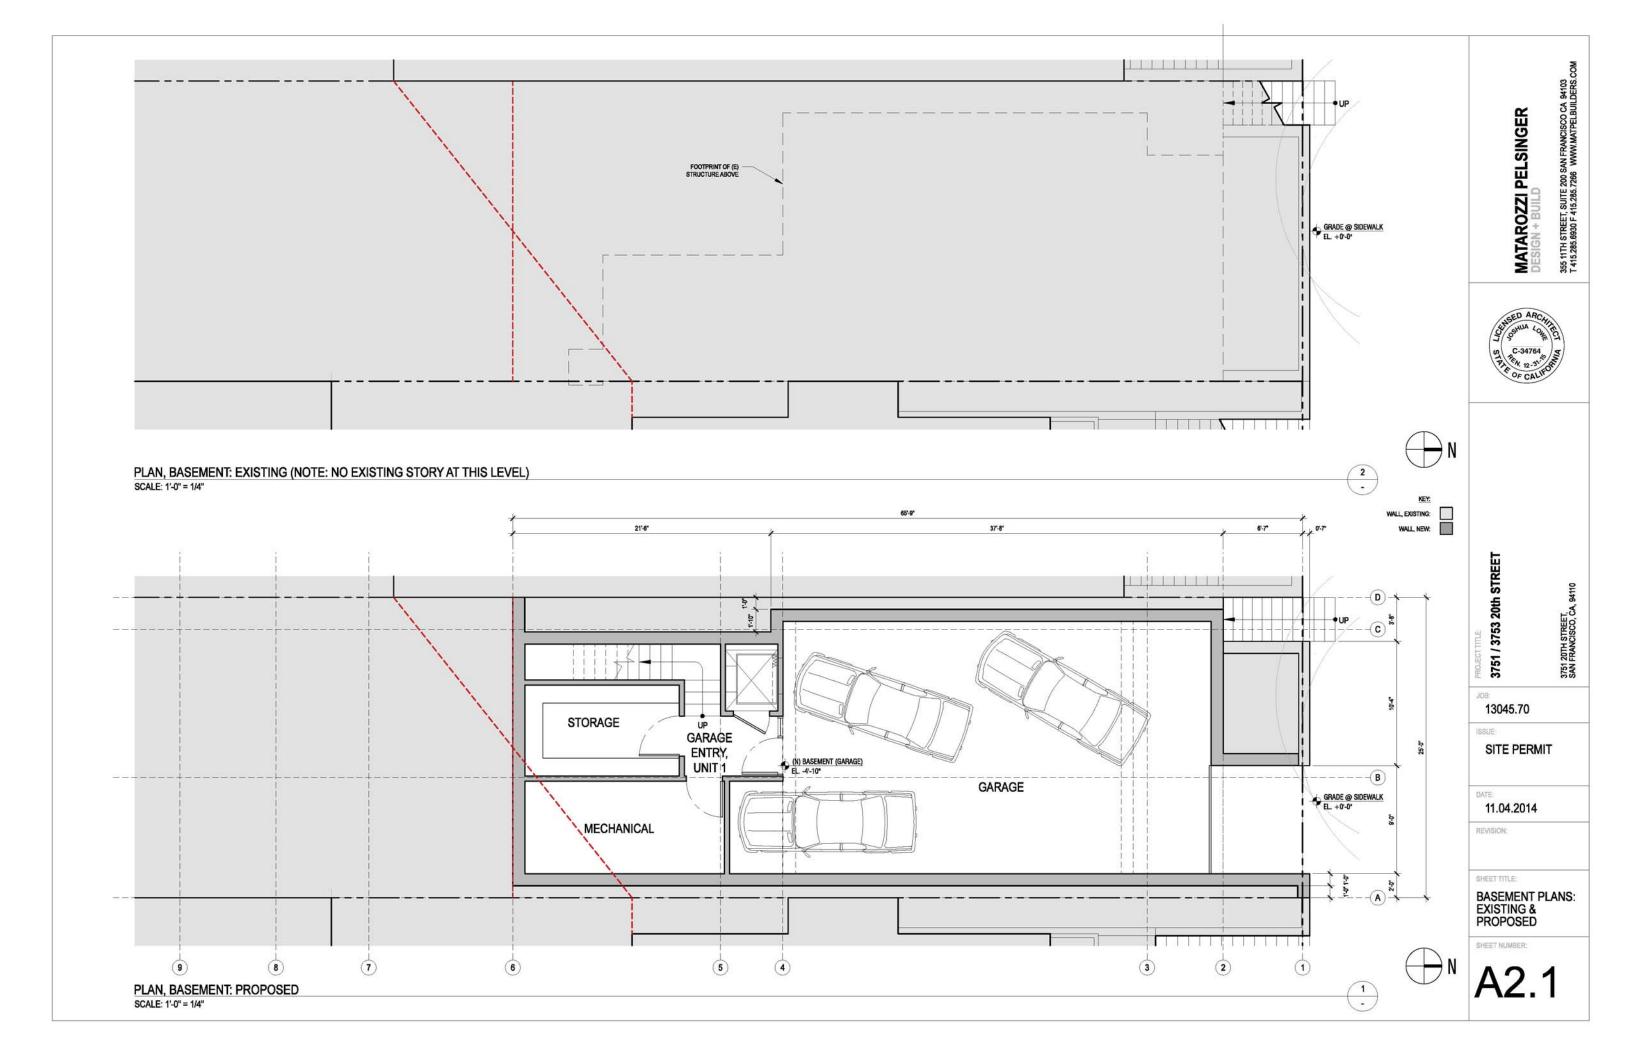


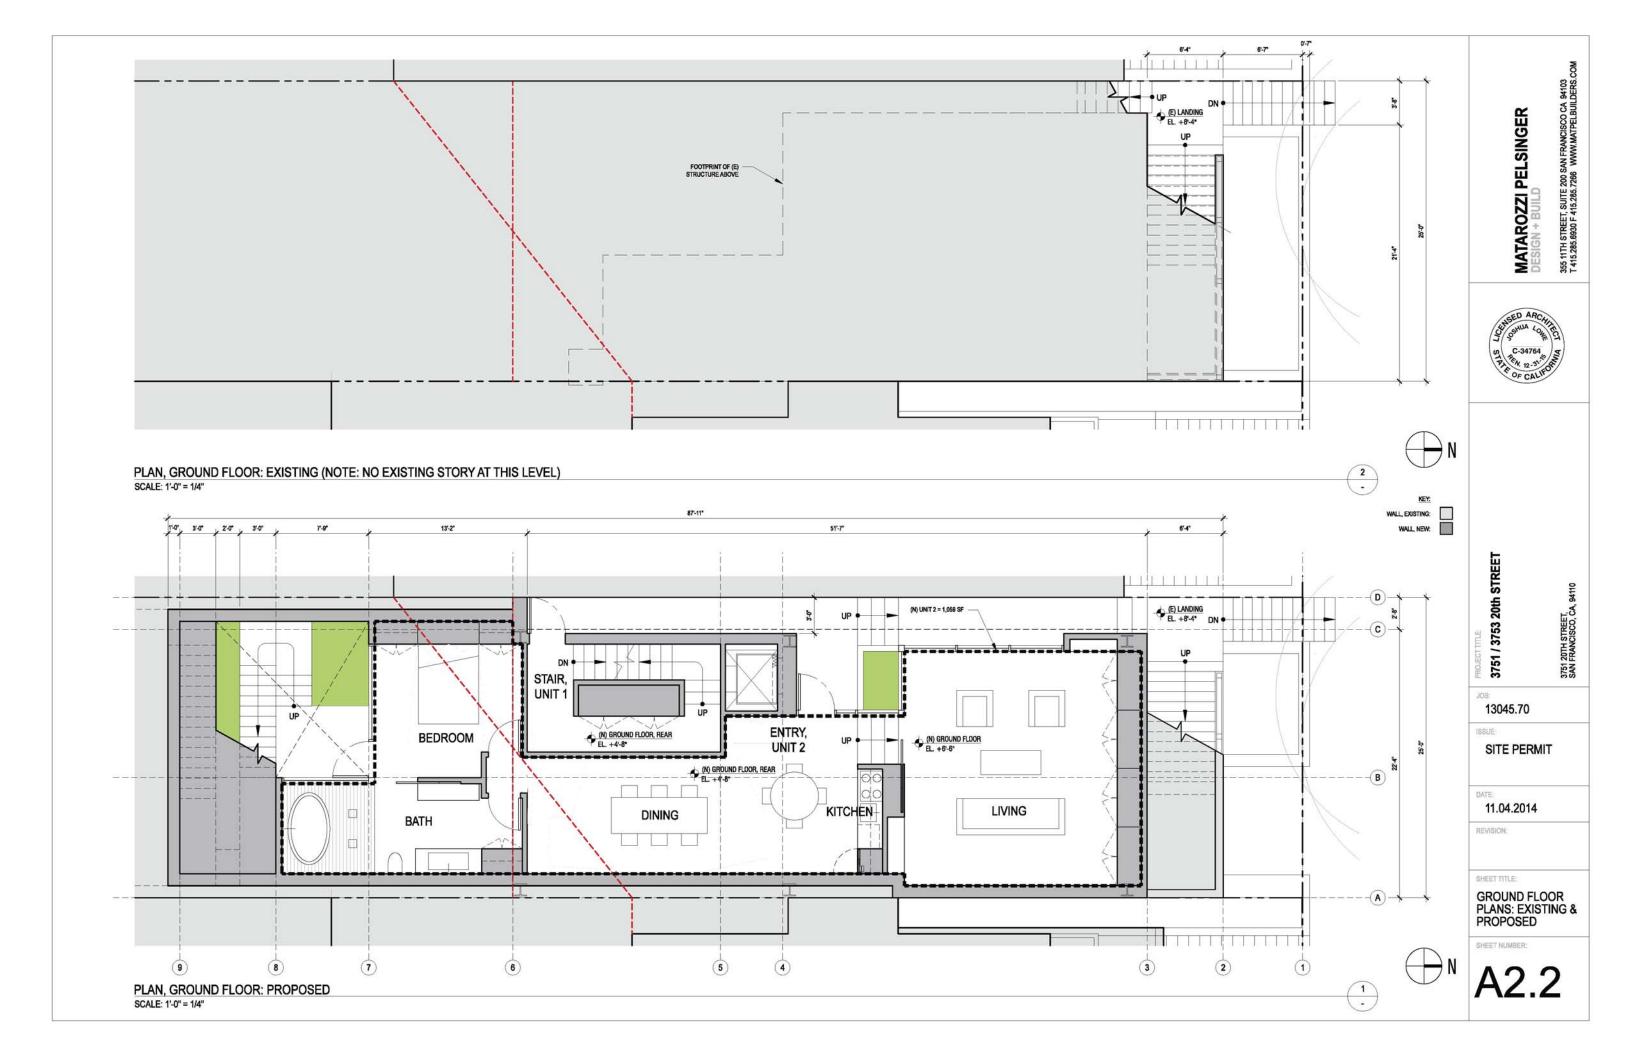


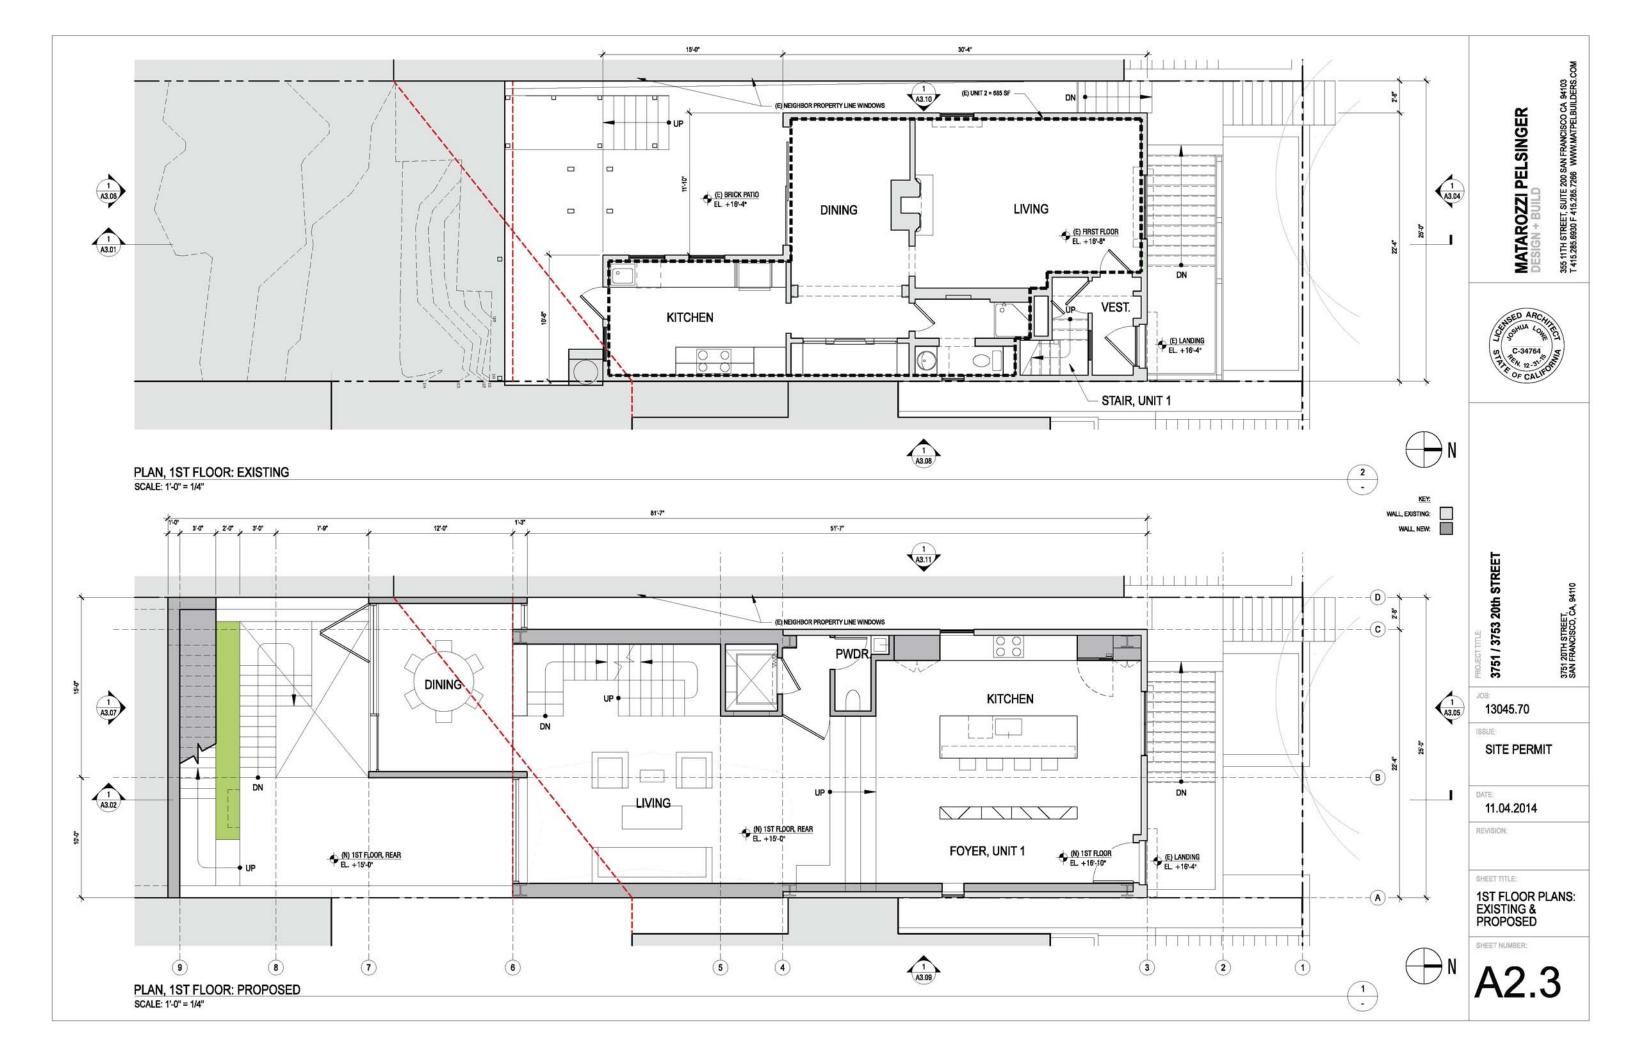


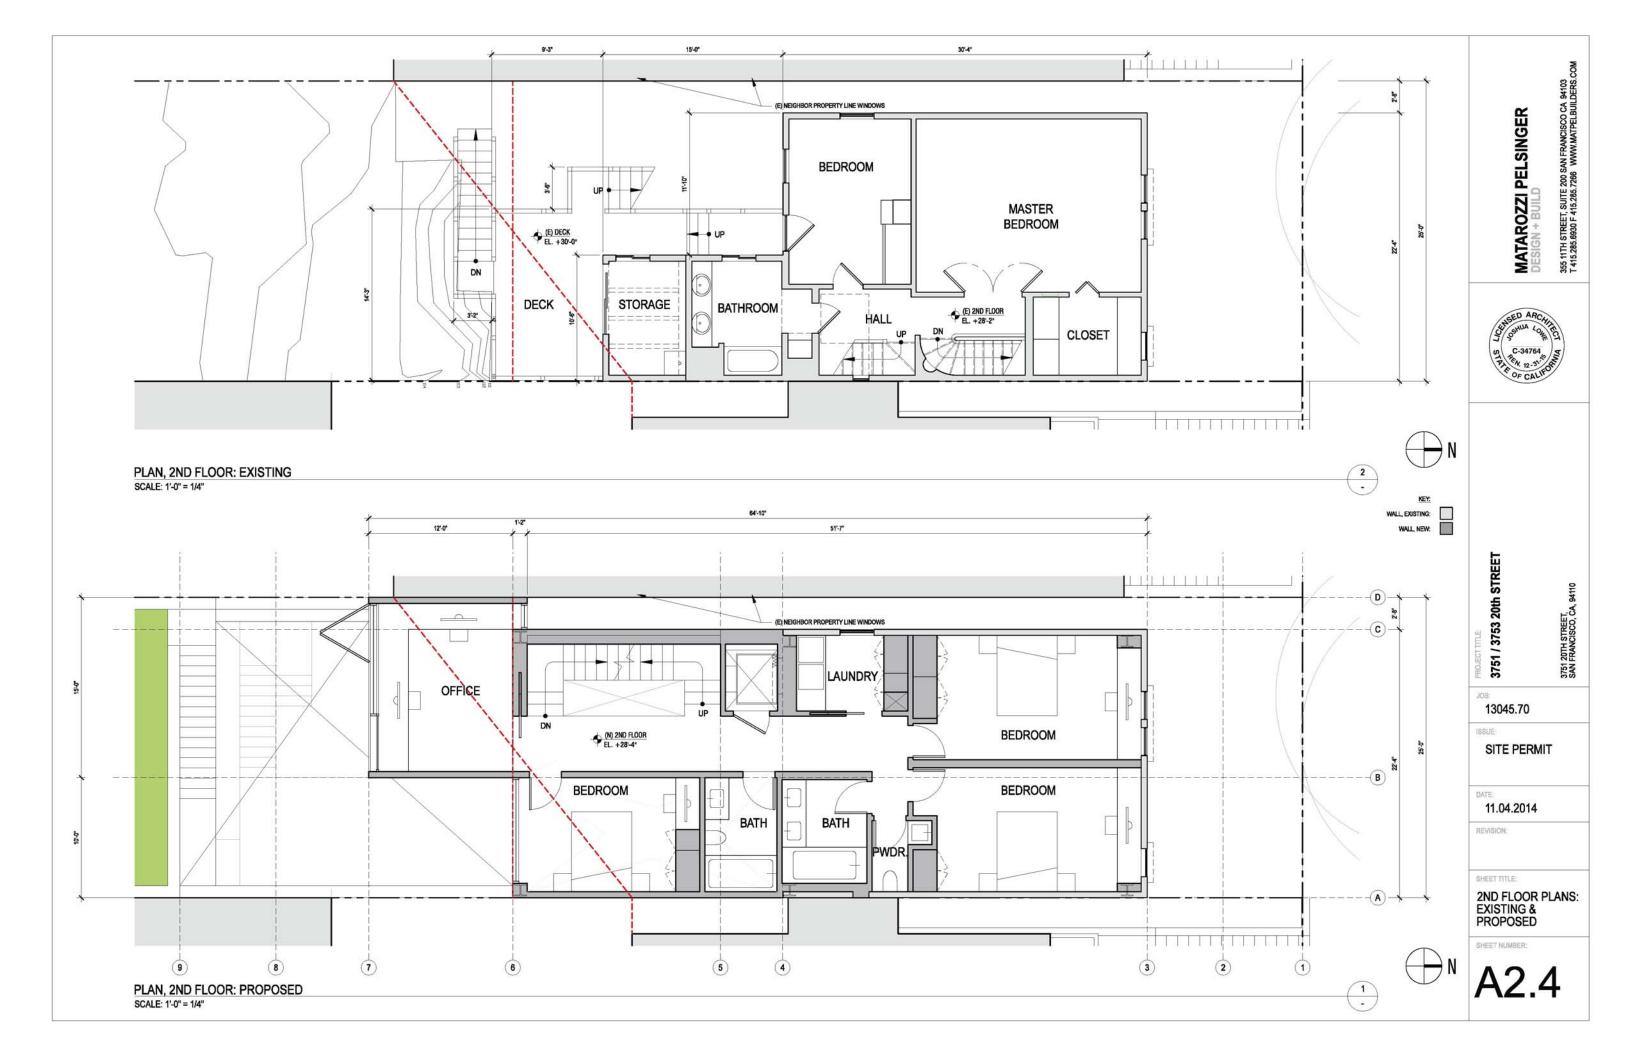


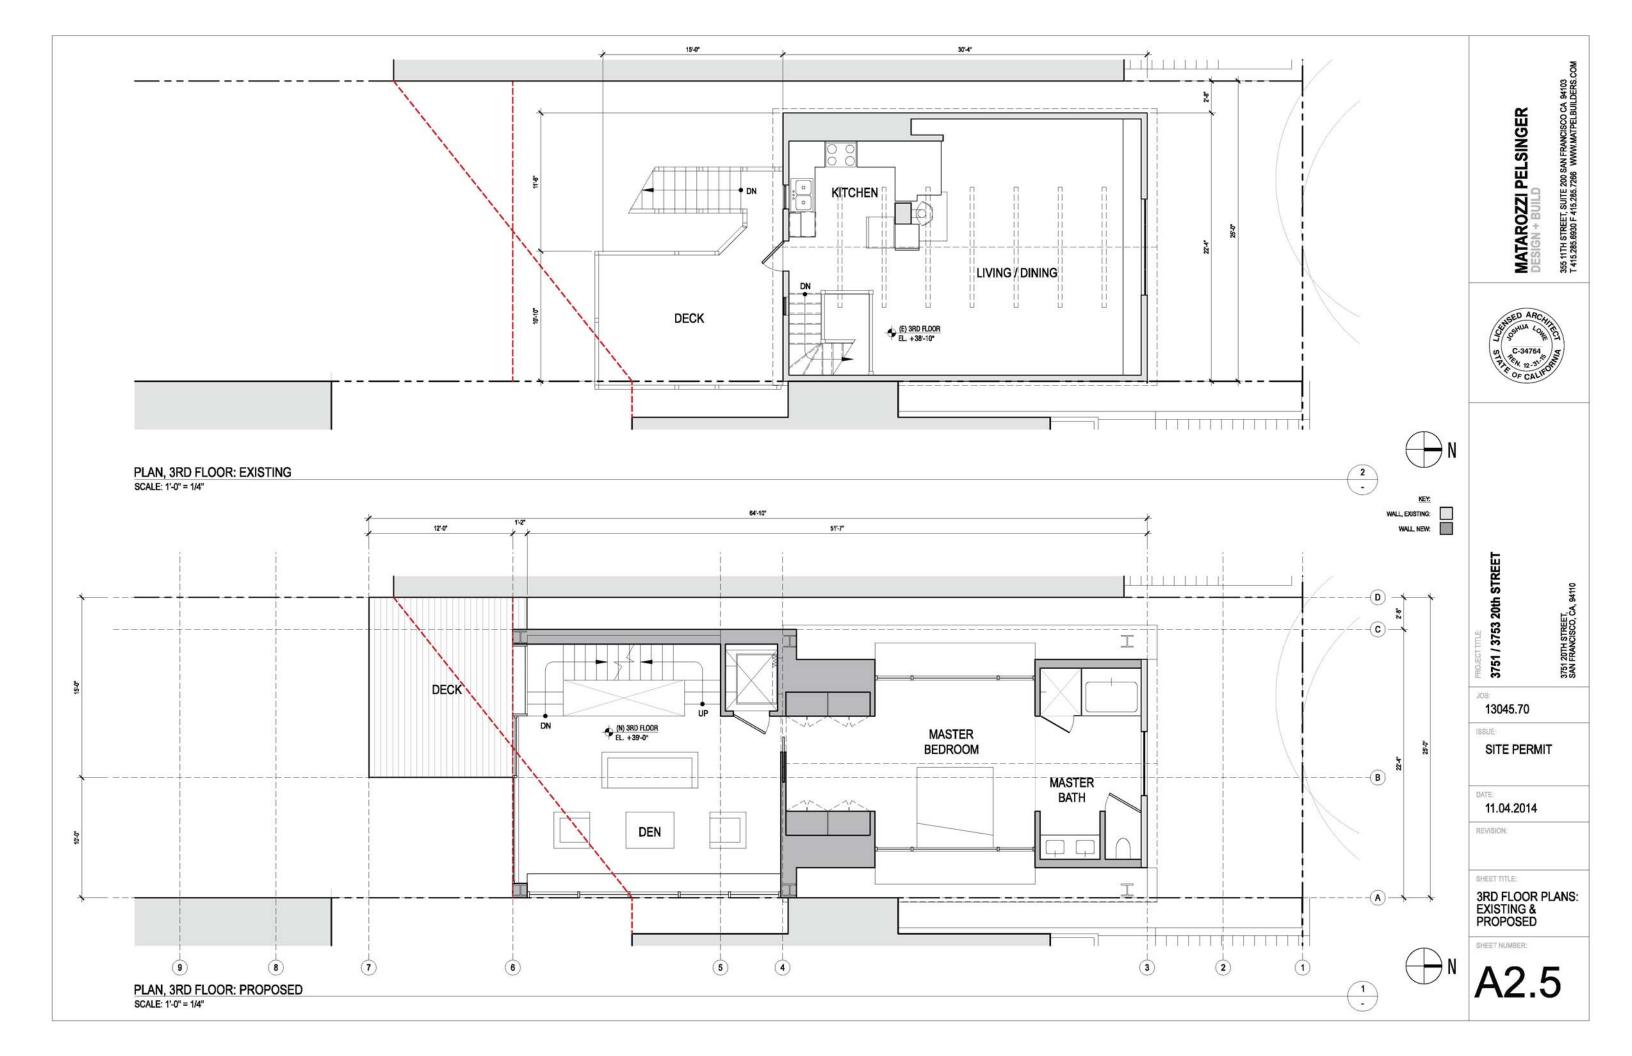

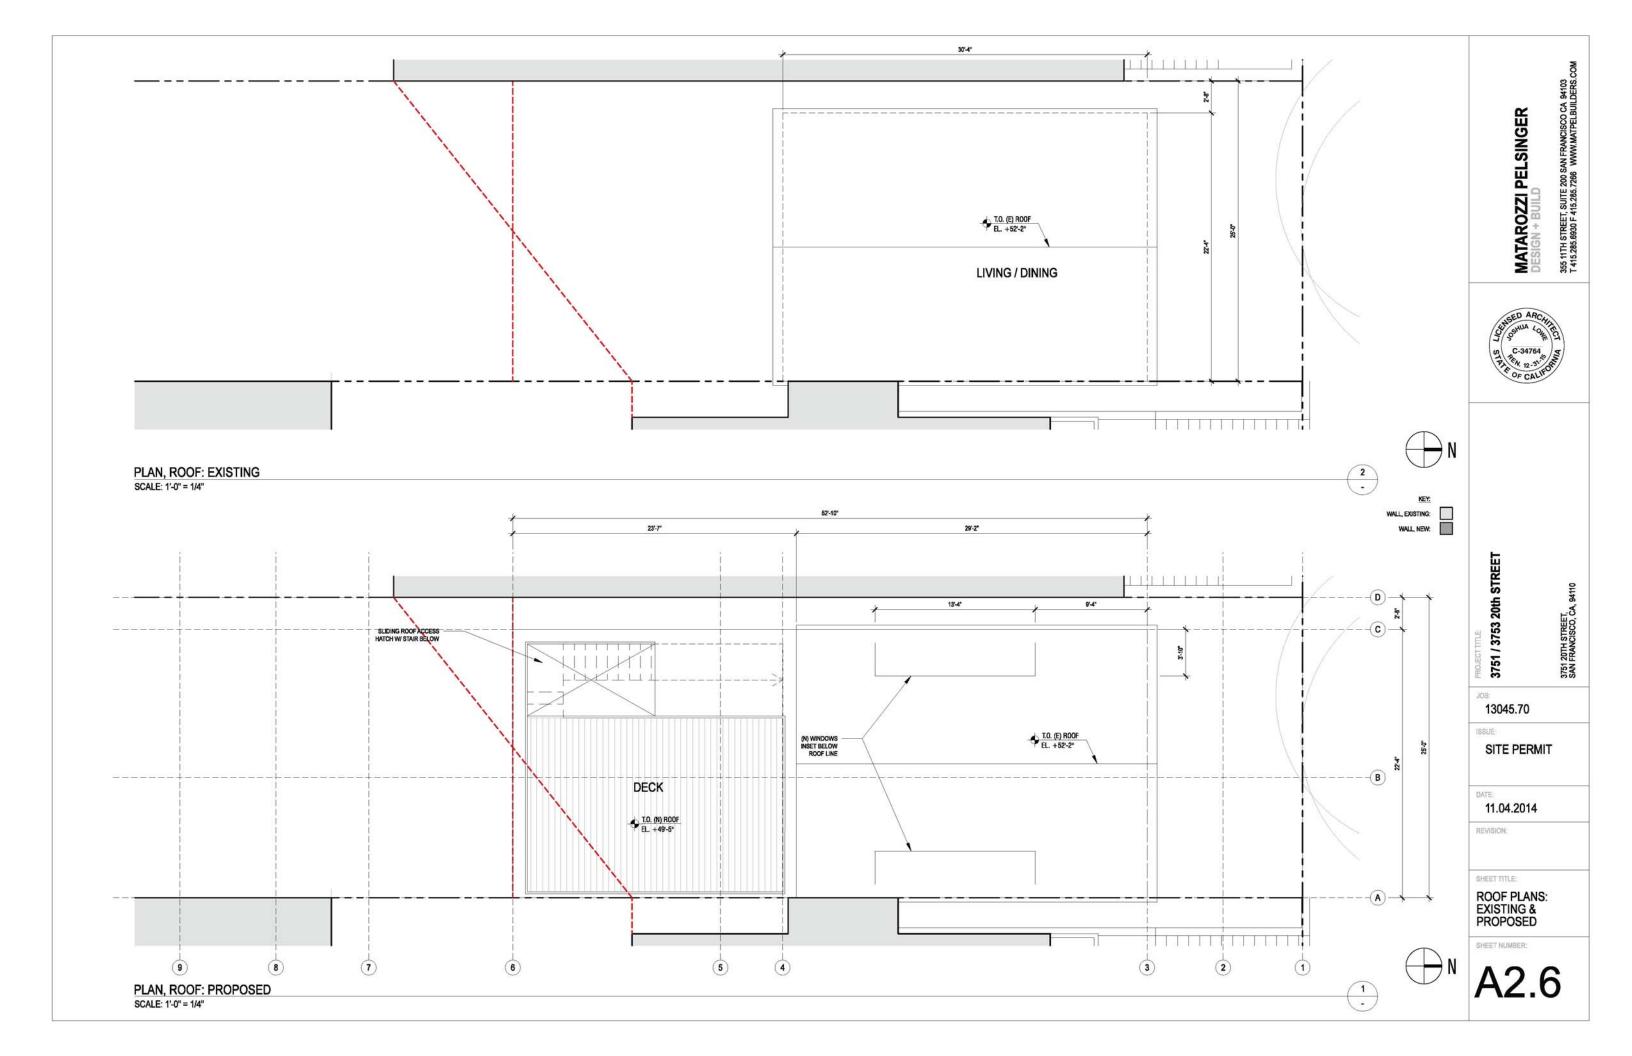

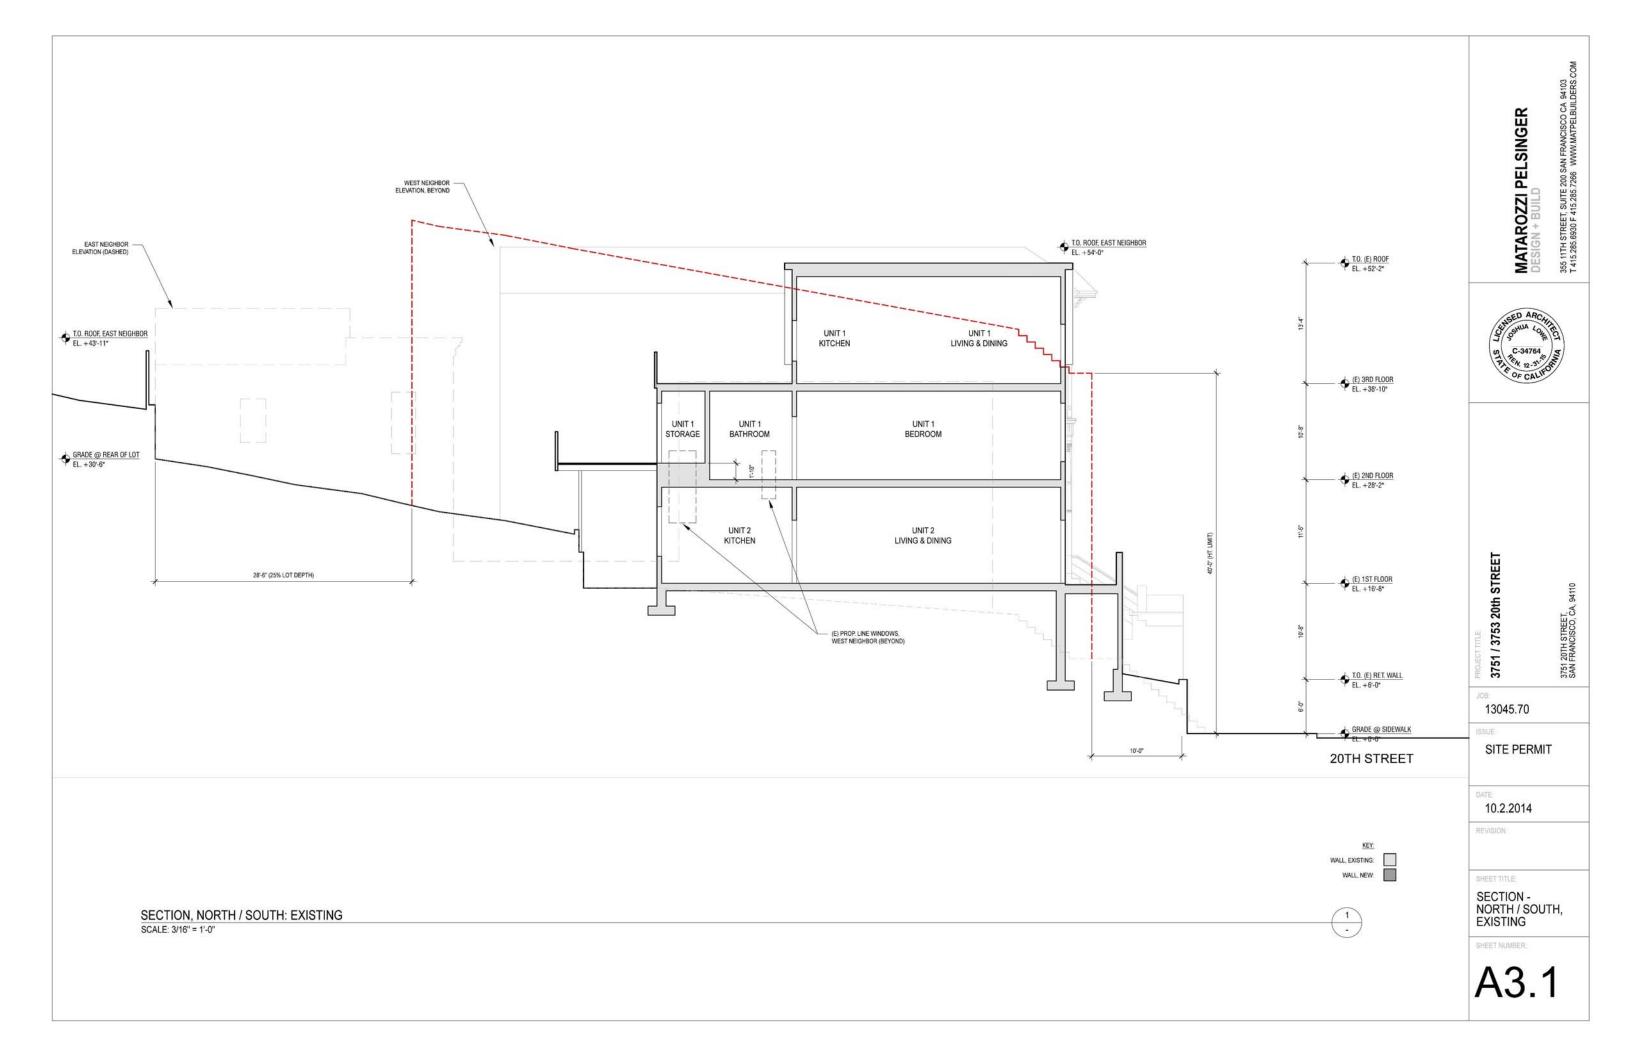

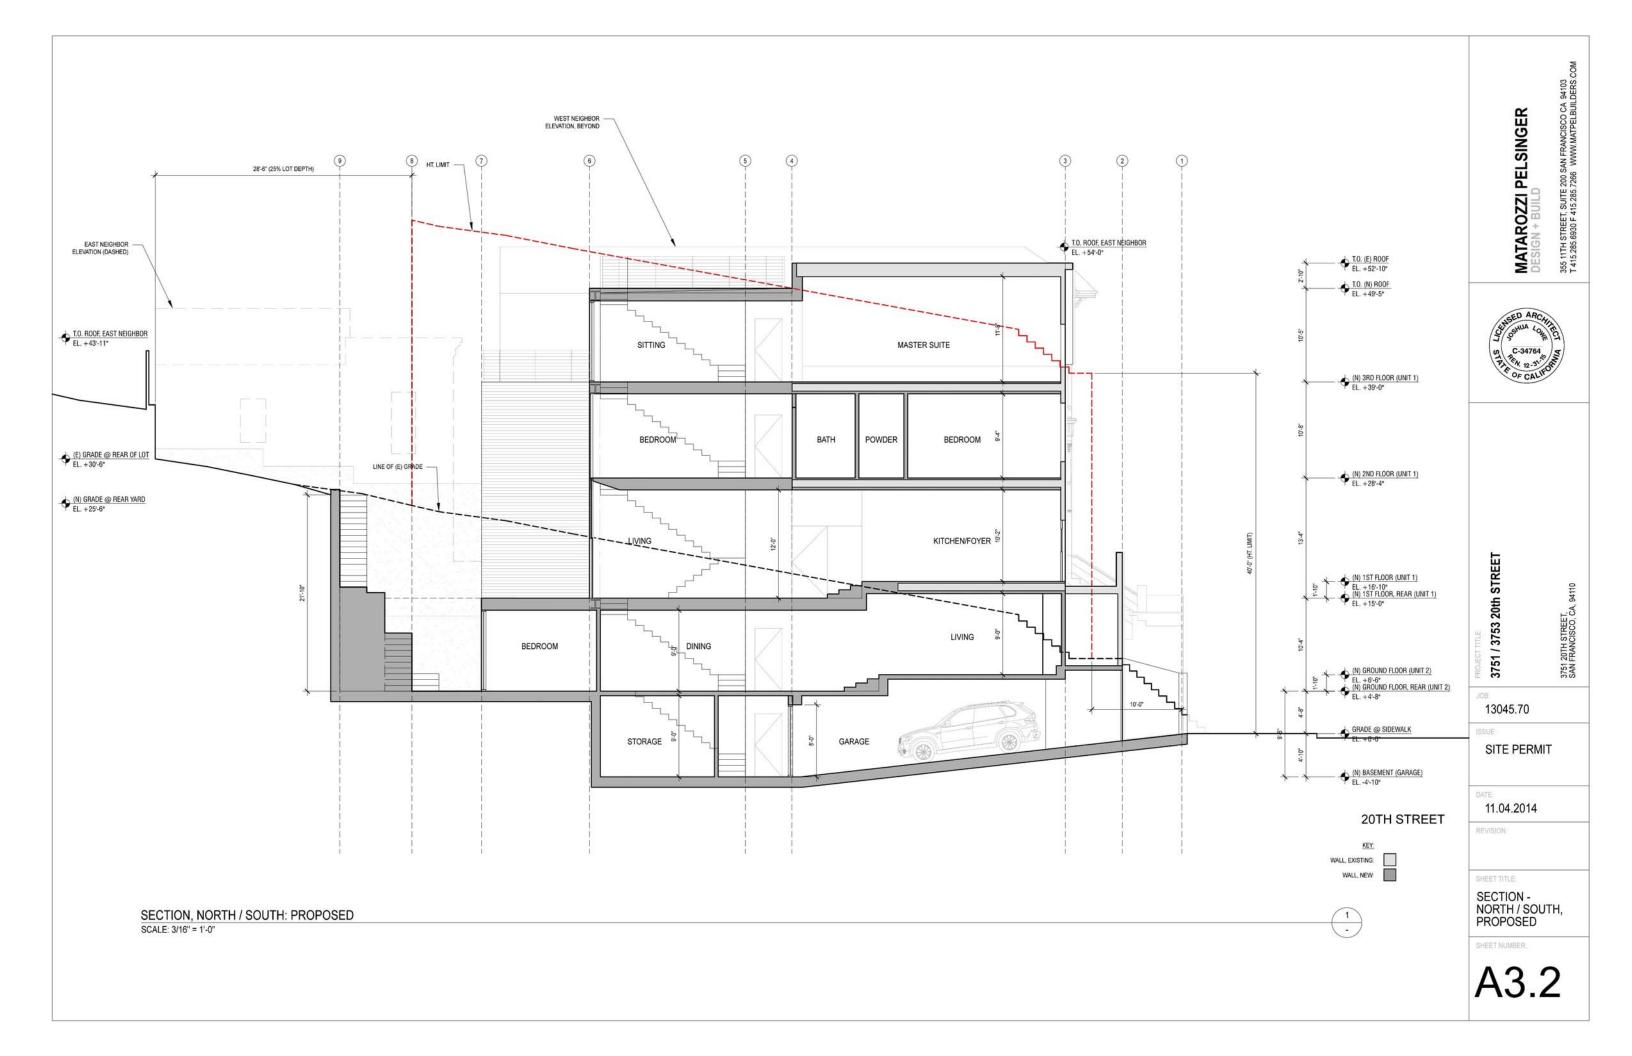

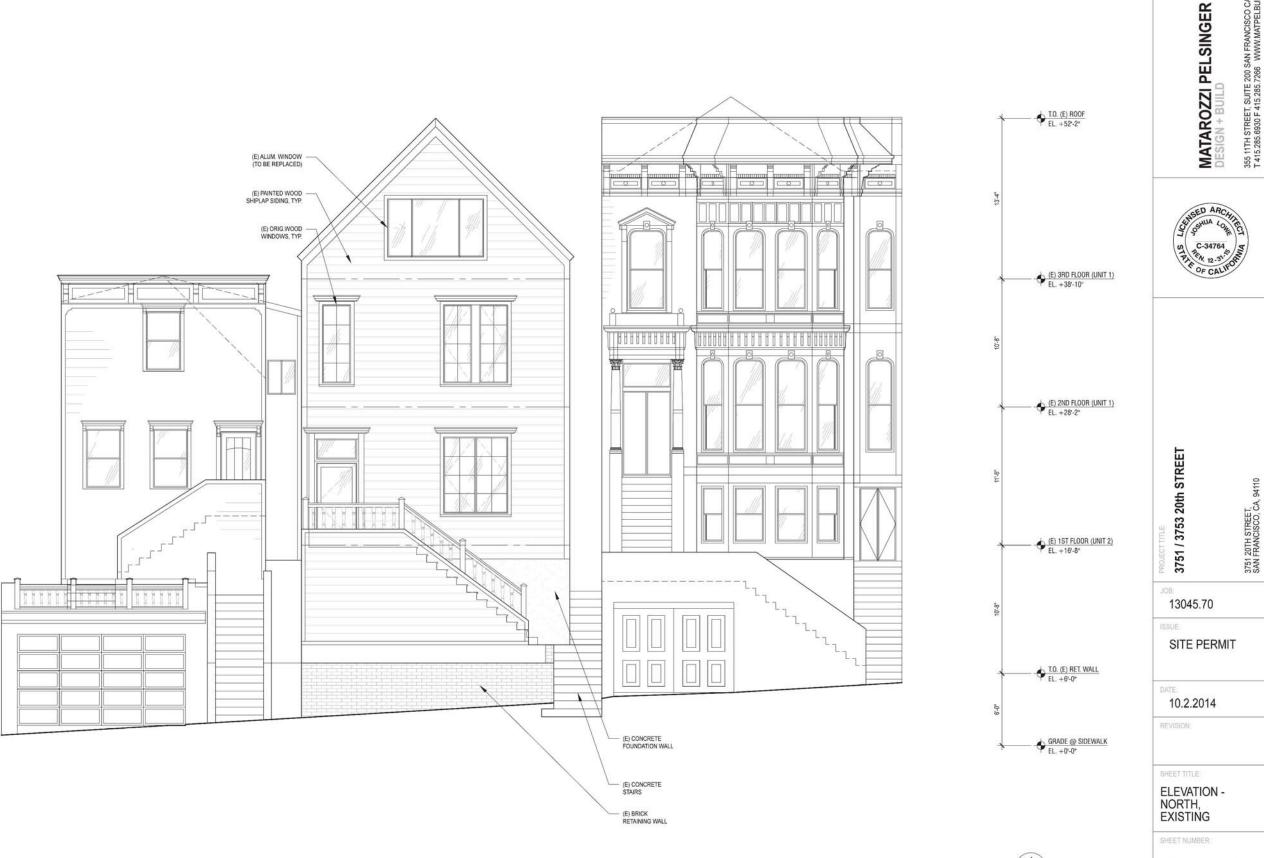


ELEVATION, NORTH: EXISTING

SCALE: 1/4" = 1'-0"

355 11TH STREET, SUITE 200 SAN FRANCISCO CA 94103 T 415.285.6930 F 415.285,7266 WWW.MATPELBUILDERS.COM

A3.4



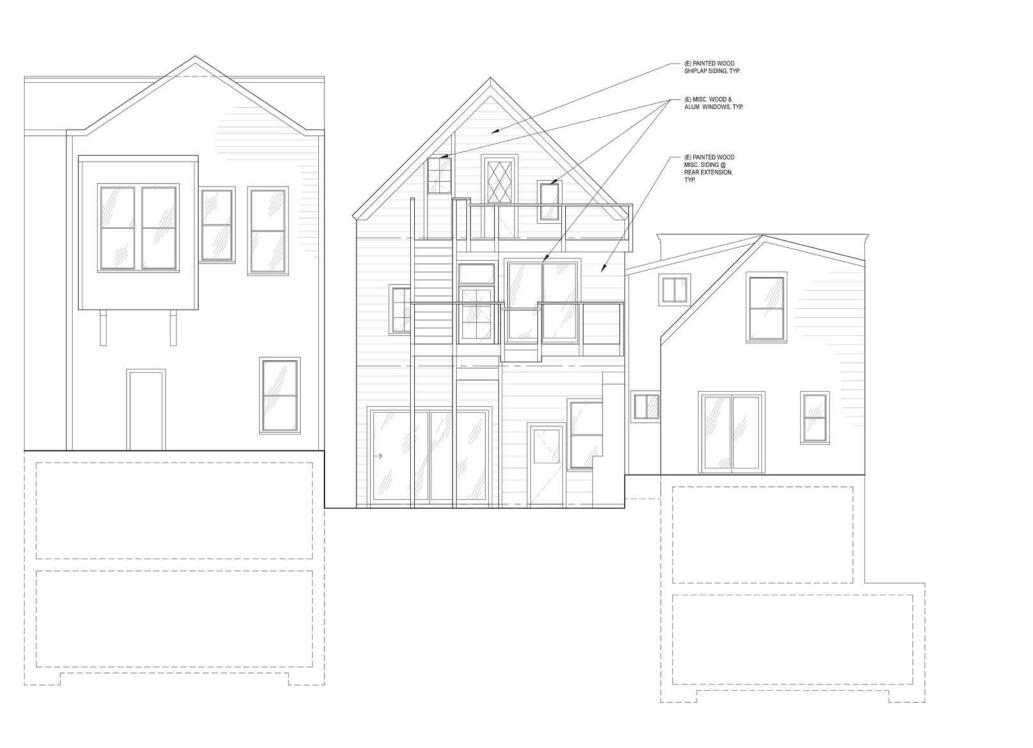

T.O. (E) ROOF EL. +52'-2" (E) 3RD FLOOR (UNIT 1) EL. +38'-10" (E) 2ND FLOOR (UNIT 1) EL. +28'-2" (E) 1ST FLOOR (UNIT 2) EL. +16'-8" T.O. (E) RET. WALL EL. +6"-0" GRADE @ SIDEWALK EL. +0"-0"

3751 / 3753 20th STREET
3751 20TH STREET,
SAN FRANCISCO, CA, 94110

13045.70


SITE PERMIT

10.2.2014

ELEVATION -SOUTH, EXISTING

SHEET NUMBER

A3.6

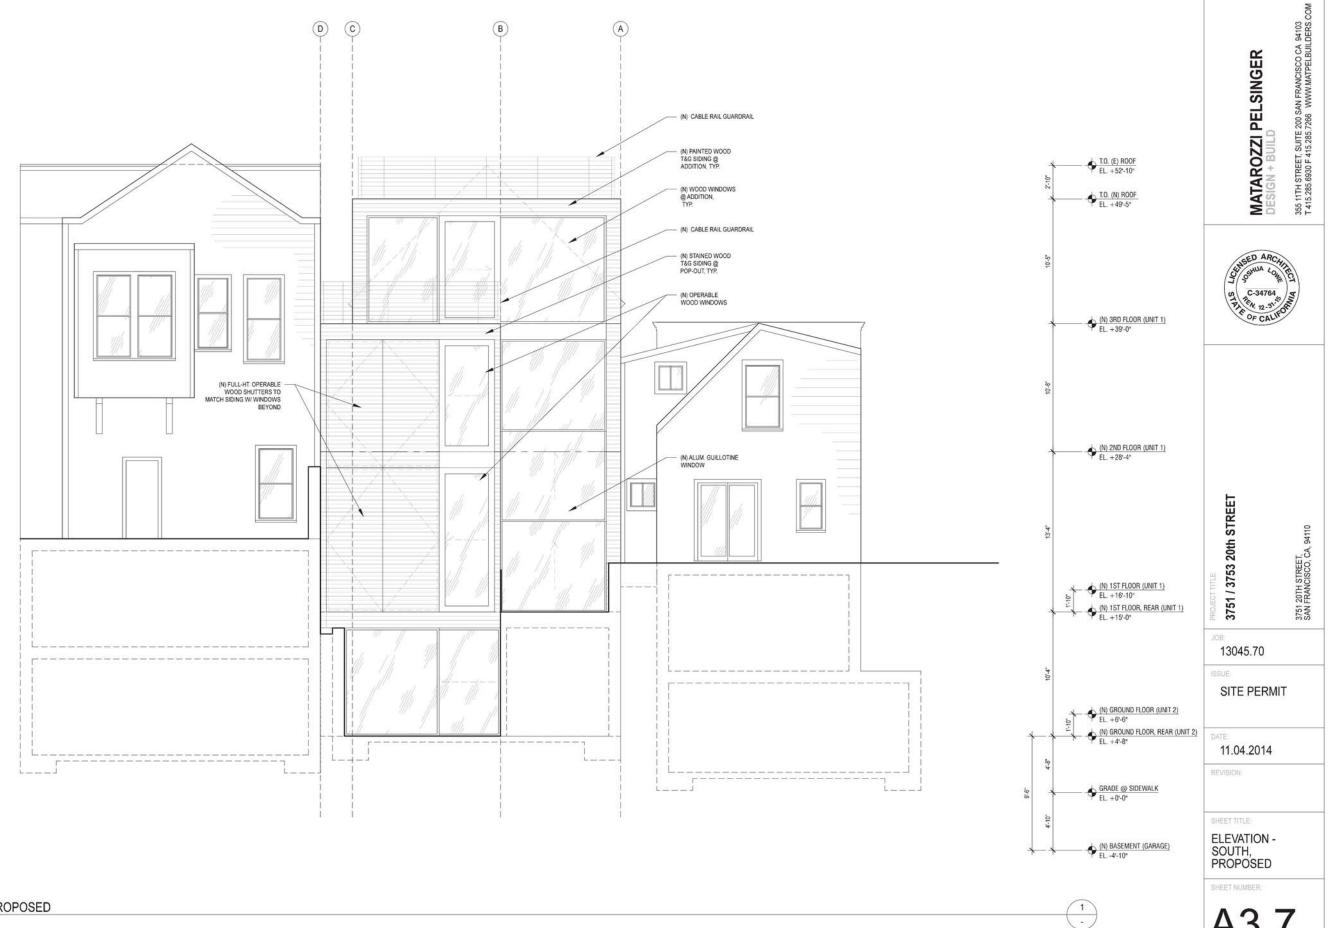

ELEVATION, SOUTH: PROPOSED

SCALE: 1/4" = 1'-0"

A3.7

