

SAN FRANCISCO PLANNING DEPARTMENT

Discretionary Review Abbreviated Analysis

HEARING DATE: SEPTEMBER 27, 2018

1650 Mission St. Suite 400 San Francisco. CA 94103-2479

Reception:

415.558.6378

Fax:

Planning Information:

415.558.6409

415.558.6377

Date: September 13, 2018 Case No.: 2017-003314DRP

Project Address: 180 Vienna Permit Application: 2016.0114.7155

RH-1 [Residential House, One-Family] Zoning:

40-X Height and Bulk District

Block/Lot: 5958/016 Project Sponsor: Derek Vinh

ICE Design

South Spruce Avenue Ste K South San Francisco, CA 94080

Staff Contact: David Winslow - (415) 575-9159

David.Winslow@sfgov.org

Do not take DR and approve as proposed *Recommendation:*

PROJECT DESCRIPTION

The project consists of a 1,246 s.f. horizontal rear addition to an existing 1,010 s.f. 1-story single-family house. (2-stories plus basement at the rear)

SITE DESCRIPTION AND PRESENT USE

The site is a 25' x 100' down sloping lot with an existing 1-story, single family house built in 1904.

SURROUNDING PROPERTIES AND NEIGHBORHOOD

This block of Vienna Street consists of 1- and 2- wood and stucco clad houses.

BUILDING PERMIT NOTIFICATION

ТҮРЕ	REQUIRED PERIOD	NOTIFICATION DATES	DR FILE DATE	DR HEARING DATE	FILING TO HEARING TIME
311 Notice	30 days	May 7, 2018 – June 6, 2018	06.4. 2018	09.27. 2018	115 days

HEARING NOTIFICATION

TYPE	REQUIRED PERIOD	REQUIRED NOTICE DATE	ACTUAL NOTICE DATE	ACTUAL PERIOD
Posted Notice	10 days	September 17, 2018	September 17, 2018	10 days
Mailed Notice	10 days	September 17, 2018	September 17, 2018	10 days

PUBLIC COMMENT

	SUPPORT	OPPOSED	NO POSITION
Adjacent neighbor(s)	0	0	0
Other neighbors on the			
block or directly across	0	0	0
the street			
Neighborhood groups	0	0	0

ENVIRONMENTAL REVIEW

The Department has determined that the proposed project is exempt/excluded from environmental review, pursuant to CEQA Guideline Section 15301 (Class One - Minor Alteration of Existing Facility, (e) Additions to existing structures provided that the addition will not result in an increase of more than 10,000 square feet).

DR REQUESTOR

Frank Tool, of 170 Vienna, the adjacent neighbor to the North of the proposed project.

DR REQUESTOR'S CONCERNS AND PROPOSED ALTERNATIVES

- 1. Impacts to light. The project would block light to the DR requestor's home and rear yard.
- **2. Scale at mid-block open space.** The project does not fit with immediate scale or context of the adjacent neighboring buildings or the broader mid-block pattern.
- 3. Parking demand due to an influx of new tenants.

See attached Discretionary Review Application, dated June 4, 2018.

PROJECT SPONSOR'S RESPONSE TO DR APPLICATION

The sponsor has complied with the Residential Design Guidelines (RDGs) enumerated below, in relation to the DR requestor's issues related to light and privacy, and scale of the building at the mid-block open space.

See attached Response to Discretionary Review, dated June 27, 2018.

RESIDENTIAL DESIGN TEAM REVIEW

1. Regarding the Residential Design Guideline "Articulate the building to minimize impacts on light and privacy to adjacent properties" (pages 16-17), the extension and height combined with

- the setback masses the building in a way that ameliorates impacts to light and air to both the adjacent neighboring properties, and complies with the intent of the guideline.
- 2. Regarding the Residential Design Guideline "Design the height and depth of the building to be compatible with the existing building scale at the mid-block open space. " The addition extends 17' from the DR requestor's existing rear wall and is set back 5' from the adjacent (DR requestor's) property to the North, and complies with the intent of the guideline.
- 3. Future parking demand based is speculative and not an Residential Design issue.

RECOMMENDATION:

Do not take DR and approve project as proposed

Attachments:


Block Book Map
Sanborn Map
Zoning Map
Aerial Photographs
Context Photographs
Section 311 Notice
CEQA Determination
DR Application
Response to DR Application dated June 27, 2018
Reduced Plans
3-D representations

Exhibits

Parcel Map

PERU

AVE.

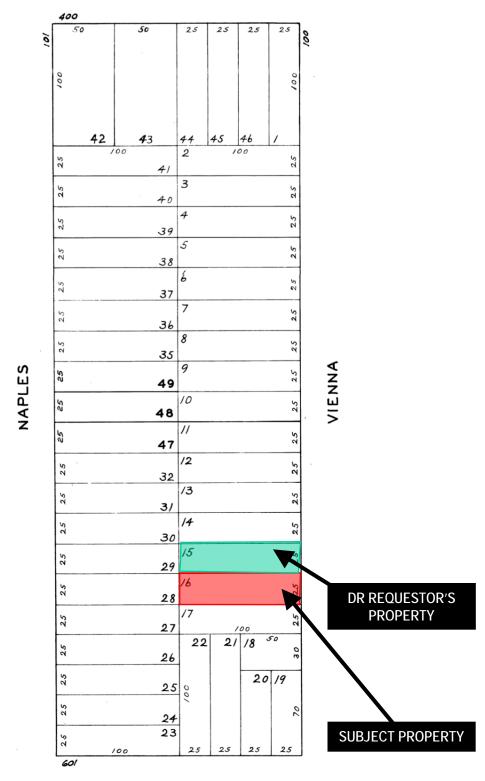


AVALON

AVE.




Sanborn Map*

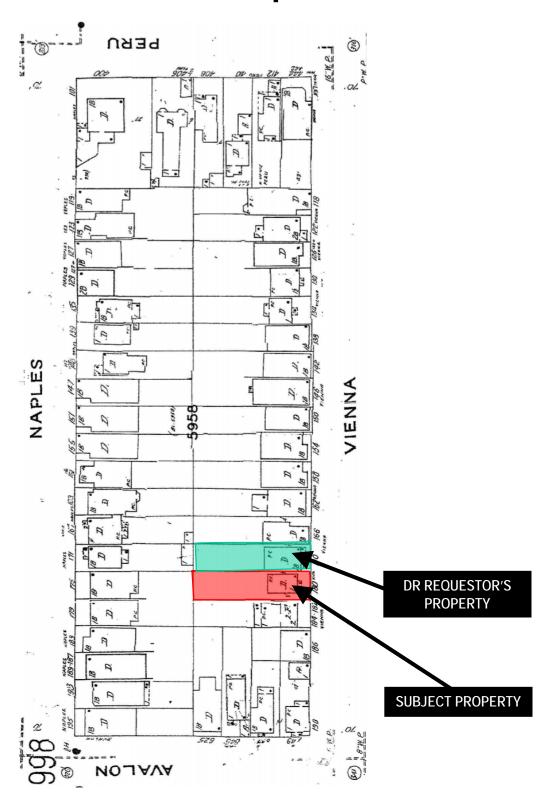

*The Sanborn Maps in San Francisco have not been updated since 1998, and this map may not accurately reflect existing conditions.



Zoning Map

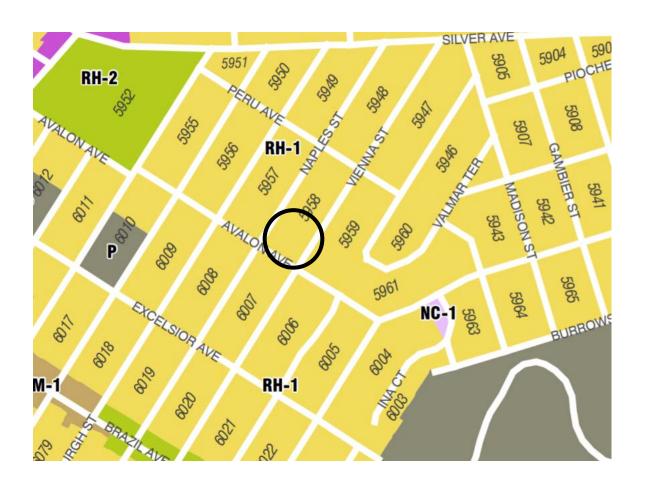










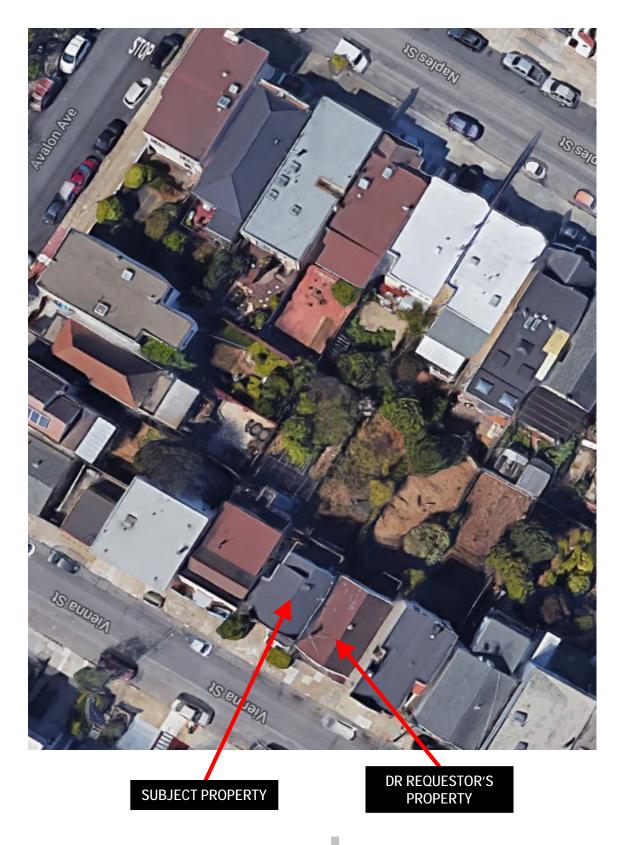








Site Photo

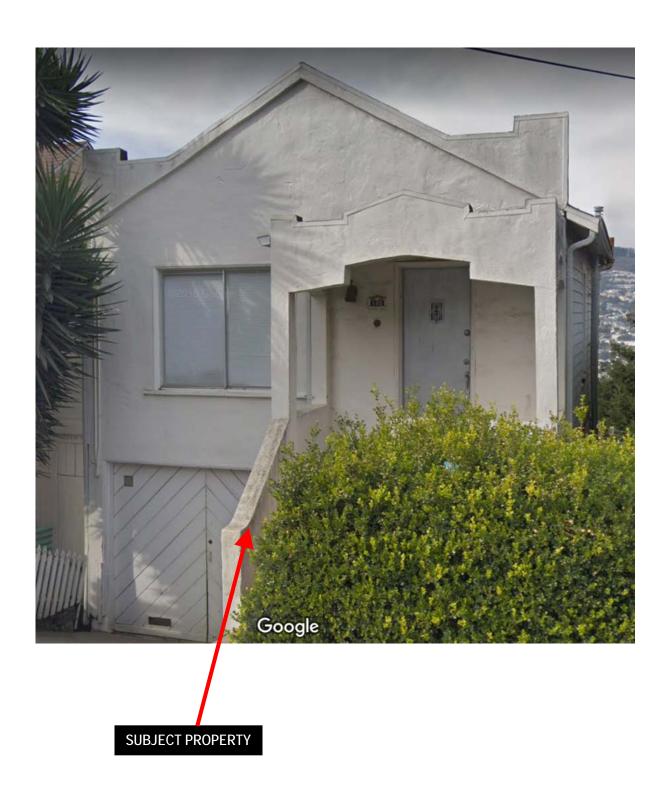

1650 Mission Street Suite 400 San Francisco. CA 94103

NOTICE OF BUILDING PERMIT APPLICATION (SECTION 311)

On **January 14**, **2016**, the Applicant named below filed Building Permit Application No. **2016.01.14.7155** with the City and County of San Francisco.

PROJ	PROJECT INFORMATION		APPLICANT INFORMATION		
Project Address:	180 Vienna Street	Applicant:	Derek Vinh, ICE Design		
Cross Street(s):	Avalon & Peru Avenues	Address:	90 South Spruce Avenue, Ste K		
Block/Lot No.:	5958/016	City, State:	South San Francisco, CA 94080		
Zoning District(s):	RH-1 / 40-X	Telephone:	(650) 741-6968		
Record No.:	2016-003314PRJ	Email:	info@icedesigninc.com		

You are receiving this notice as a property owner or resident within 150 feet of the proposed project. You are not required to take any action. For more information about the proposed project, or to express concerns about the project, please contact the Applicant listed above or the Planner named below as soon as possible. If you believe that there are exceptional or extraordinary circumstances associated with the project, you may request the Planning Commission to use its discretionary powers to review this application at a public hearing. Applications requesting a Discretionary Review hearing must be filed during the 30-day review period, prior to the close of business on the Expiration Date shown below, or the next business day if that date is on a week-end or a legal holiday. If no Requests for Discretionary Review are filed, this project will be approved by the Planning Department after the Expiration Date.

Members of the public are not required to provide personal identifying information when they communicate with the Commission or the Department. All written or oral communications, including submitted personal contact information, may be made available to the public for inspection and copying upon request and may appear on the Department's website or in other public documents.

	PROJECT SCOPE	
☐ Demolition	□ New Construction	✓ Alteration
☐ Change of Use	☐ Façade Alteration(s)	☐ Front Addition
✓ Rear Addition	✓ Side Addition	□ Vertical Addition
PROJECT FEATURES	EXISTING	PROPOSED
Building Use	Residential	Residential
Front Setback	8 feet – 2 inches	No Change
Side Setbacks	8 inches / 1 foot – 6 inches	No Change
Building Depth	35 feet (to rear stairs/deck)	62 feet – 7 inches
Rear Yard	56 feet – 10 inches	29 feet – 3 inches
Building Height	20 feet – 0 1/2 inches (midpoint of sloped roof)	No Change
Number of Stories	2	2 + basement
Number of Dwelling Units	1	No Change
Number of Parking Spaces	1	No Change
	PROJECT DESCRIPTION	

The project proposes to construct a side/rear addition which includes basement level excavation for additional habitable space and interior remodeling to an existing 2-story single-family dwelling. No façade changes are proposed. See attached plans.

The issuance of the building permit by the Department of Building Inspection or the Planning Commission project approval at a discretionary review hearing would constitute as the Approval Action for the project for the purposes of CEQA, pursuant to Section 31.04(h) of the San Francisco Administrative Code.

For more information, please contact Planning Department staff:

Planner: Nancy Tran

Telephone: (415) 575-9174 Notice Date: 5/7/18 E-mail: nancy.h.tran@sfgov.org Expiration Date: 6/6/18

CEQA Categorical Exemption Determination

PROPERTY INFORMATION/PROJECT DESCRIPTION

Proje	ct Address		Block/Lot(s)
180 V	IENNA ST		5958/016
Case	No.		Permit No.
2016-	003314ENV		201601147155
Ad	ldition/	Demolition (requires HRE for	New
	teration	Category B Building)	Construction
Proje	ct description for	Planning Department approval.	
Horizo	ontal addition at th	e rear of property. Excavation to create a new bas	ement. Total addition will be
appro	ximately 2,752 squ	uare feet.	
1			
STE	P 1: EXEMPTIC	ON CLASS	
		ON CLASS applies, an Environmental Evaluation Application	on is required.*
	: If neither class a	applies, an Environmental Evaluation Application appli	-
	c: If neither class a Class 1 - Existin use under 10,000 Class 3 - New C	applies, an Environmental Evaluation Application appli	ions under 10,000 sq. ft.; change of
*Note	Class 1 - Existing use under 10,000 Class 3 - New Coulding; comme	applies, an Environmental Evaluation Application ag Facilities. Interior and exterior alterations; addit 0 sq. ft. onstruction. Up to three new single-family resider rcial/office structures; utility extensions	ions under 10,000 sq. ft.; change of nces or six dwelling units in one
*Note	Class 1 - Existing use under 10,000 Class 3 - New Couilding; comme Class 32 - In-Fil 10,000 sq. ft. an	applies, an Environmental Evaluation Application ag Facilities. Interior and exterior alterations; addit 0 sq. ft. onstruction. Up to three new single-family resider recial/office structures; utility extensions I Development. New Construction of seven or mod meets the conditions described below:	ions under 10,000 sq. ft.; change of nces or six dwelling units in one re units or additions greater than
*Note	Class 1 - Existing use under 10,000 Class 3 - New Coulding; comme Class 32 - In-Fil 10,000 sq. ft. an (a) The project is	applies, an Environmental Evaluation Application ag Facilities. Interior and exterior alterations; addit 0 sq. ft. onstruction. Up to three new single-family resider reial/office structures; utility extensions I Development. New Construction of seven or mod meets the conditions described below: se consistent with the applicable general plan designation.	ions under 10,000 sq. ft.; change of nces or six dwelling units in one re units or additions greater than nation and all applicable general plan
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*Note	Class 1 - Existing use under 10,000 Class 3 - New Comme Class 32 - In-Fill 10,000 sq. ft. and (a) The project is policies as well as (b) The propose substantially sur (c) The project se (d) Approval of the water quality.	applies, an Environmental Evaluation Application and Facilities. Interior and exterior alterations; addit 0 sq. ft. onstruction. Up to three new single-family resider roial/office structures; utility extensions I Development. New Construction of seven or mode meets the conditions described below: so consistent with the applicable general plan designas with applicable zoning designation and regulation development occurs within city limits on a project rounded by urban uses. Site has no value as habitat for endangered rare or the project would not result in any significant effects.	ions under 10,000 sq. ft.; change of nces or six dwelling units in one re units or additions greater than nation and all applicable general plan ons. It site of no more than 5 acres threatened species. Is relating to traffic, noise, air quality, or
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STEP 2: CEQA IMPACTS

TO BE COMPLETED BY PROJECT PLANNER

If any b	ox is checked below, an Environmental Evaluation Application is required.			
	Air Quality: Would the project add new sensitive receptors (specifically, schools, day care facilities, hospitals, residential dwellings, and senior-care facilities within an Air Pollution Exposure Zone? Does the project have the potential to emit substantial pollutant concentrations (e.g., backup diesel generators, heavy industry, diesel trucks, etc.)? (refer to EP_ArcMap > CEQA Catex Determination Layers > Air Pollution Exposure Zone)			
	Hazardous Materials: If the project site is located on the Maher map or is suspected of containing hazardous materials (based on a previous use such as gas station, auto repair, dry cleaners, or heavy manufacturing, or a site with underground storage tanks): Would the project involve 50 cubic yards or more of soil disturbance - or a change of use from industrial to residential? If yes, this box must be checked and the project applicant must submit an Environmental Application with a Phase I Environmental Site Assessment. Exceptions: do not check box if the applicant presents documentation of enrollment in the San Francisco Department of Public Health (DPH) Maher program, a DPH waiver from the Maher program, or other documentation from Environmental Planning staff that hazardous material effects would be less than significant (refer to EP_ArcMap > Maher layer).			
	Transportation: Does the project create six (6) or more net new parking spaces or residential units? Does the project have the potential to adversely affect transit, pedestrian and/or bicycle safety (hazards) or the adequacy of nearby transit, pedestrian and/or bicycle facilities?			
	Archeological Resources: Would the project result in soil disturbance/modification greater than two (2) feet below grade in an archeological sensitive area or eight (8) feet in a non-archeological sensitive area? (refer to EP_ArcMap > CEQA Catex Determination Layers > Archeological Sensitive Area)			
	Subdivision/Lot Line Adjustment: Does the project site involve a subdivision or lot line adjustment on a lot with a slope average of 20% or more? (refer to EP_ArcMap > CEQA Catex Determination Layers > Topography)			
	Slope = or > 20%: Does the project involve any of the following: (1) square footage expansion greater than 1,000 sq. ft. outside of the existing building footprint, (2) excavation of 50 cubic yards or more of soil, (3) new construction? (refer to EP_ArcMap > CEQA Catex Determination Layers > Topography) If box is checked, a geotechnical report is required.			
	Seismic: Landslide Zone: Does the project involve any of the following: (1) square footage expansion greater than 1,000 sq. ft. outside of the existing building footprint, (2) excavation of 50 cubic yards or more of soil, (3) new construction? (refer to EP_ArcMap > CEQA Catex Determination Layers > Seismic Hazard Zones) If box is checked, a geotechnical report is required.			
	Seismic: Liquefaction Zone: Does the project involve any of the following: (1) square footage expansion greater than 1,000 sq. ft. outside of the existing building footprint, (2) excavation of 50 cubic yards or more of soil, (3) new construction? (refer to EP_ArcMap > CEQA Catex Determination Layers > Seismic Hazard Zones) If box is checked, a geotechnical report will likely be required.			
	boxes are checked above, GO TO STEP 3. If one or more boxes are checked above, an ronmental Evaluation Application is required, unless reviewed by an Environmental Planner.			
	ments and Planner Signature (optional): Laura Lynch			
Arch	eo Review, no effects			

STEP 3: PROPERTY STATUS - HISTORIC RESOURCE TO BE COMPLETED BY PROJECT PLANNER PROPERTY IS ONE OF THE FOLLOWING: (refer to Parcel Information Map) Category A: Known Historical Resource. GO TO STEP 5. Category B: Potential Historical Resource (over 45 years of age). GO TO STEP 4. Category C: Not a Historical Resource or Not Age Eligible (under 45 years of age). GO TO STEP 6. STEP 4: PROPOSED WORK CHECKLIST TO BE COMPLETED BY PROJECT PLANNER Check all that apply to the project. 1. Change of use and new construction. Tenant improvements not included. 2. Regular maintenance or repair to correct or repair deterioration, decay, or damage to building. 3. Window replacement that meets the Department's Window Replacement Standards. Does not include storefront window alterations. 4. Garage work. A new opening that meets the Guidelines for Adding Garages and Curb Cuts, and/or replacement of a garage door in an existing opening that meets the Residential Design Guidelines. 5. Deck, terrace construction, or fences not visible from any immediately adjacent public right-of-way. 6. Mechanical equipment installation that is not visible from any immediately adjacent public right-of-way. 7. Dormer installation that meets the requirements for exemption from public notification under Zoning Administrator Bulletin No. 3: Dormer Windows. 8. Addition(s) that are not visible from any immediately adjacent public right-of-way for 150 feet in each direction; does not extend vertically beyond the floor level of the top story of the structure or is only a single story in height; does not have a footprint that is more than 50% larger than that of the original building; and does not cause the removal of architectural significant roofing features. Note: Project Planner must check box below before proceeding. Project is not listed. GO TO STEP 5. Project does not conform to the scopes of work. GO TO STEP 5. Project involves four or more work descriptions. GO TO STEP 5. Project involves less than four work descriptions. GO TO STEP 6. STEP 5: CEQA IMPACTS - ADVANCED HISTORICAL REVIEW TO BE COMPLETED BY PROJECT PLANNER Check all that apply to the project. 1. Project involves a known historical resource (CEQA Category A) as determined by Step 3 and conforms entirely to proposed work checklist in Step 4. 2. Interior alterations to publicly accessible spaces. 3. Window replacement of original/historic windows that are not "in-kind" but are consistent with existing historic character. 4. Façade/storefront alterations that do not remove, alter, or obscure character-defining features.

5. Raising the building in a manner that does not remove, alter, or obscure character-defining

6. Restoration based upon documented evidence of a building's historic condition, such as historic

中文詢問請電: 415.575.9010

Para información en Español llamar al: 415.575.9010 Para sa impormasyon sa Tagalog tumawag sa: 415.575.9121

photographs, plans, physical evidence, or similar buildings.

features.

	Addition(s), including mechanical equipment that are mir and meet the Secretary of the Interior's Standards for Reha.	, , ,	
	8. Other work consistent with the Secretary of the Interior Properties (specify or add comments):		
	9. Other work that would not materially impair a historic dist	strict (specify or add comments):	
	(Requires approval by Senior Preservation Planner/Preserv	vation Coordinator)	
	10. Reclassification of property status . (Requires approva Planner/Preservation	ral by Senior Preservation	
	Reclassify to Category A	Reclassify to Category C	
	a. Per HRER dated (attach	th HRER)	
	b. Other (specify):		
	Note: If ANY box in STEP 5 above is checked, a Prese	ervation Planner MUST check one box below.	
	Further environmental review required. Based on the information Environmental Evaluation Application to be submitted. GO		
	Project can proceed with categorical exemption review. The Preservation Planner and can proceed with categorical exemption Planner and can proceed with categorical exemption.		
Comm			
Comm	Preservation Planner and can proceed with categorical exer		
	Preservation Planner and can proceed with categorical exer		
Preser ——————————————————————————————————	Preservation Planner and can proceed with categorical exerents (optional):	emption review. GO TO STEP 6.	
Preser ——————————————————————————————————	Preservation Planner and can proceed with categorical exerents (optional): vation Planner Signature: EP 6: CATEGORICAL EXEMPTION DETERMINATION BE COMPLETED BY PROJECT PLANNER Further environmental review required. Proposed project	emption review. GO TO STEP 6.	
Preser ——————————————————————————————————	Preservation Planner and can proceed with categorical exerents (optional): vation Planner Signature: EP 6: CATEGORICAL EXEMPTION DETERMINATION BE COMPLETED BY PROJECT PLANNER	emption review. GO TO STEP 6.	
Preser ——————————————————————————————————	Preservation Planner and can proceed with categorical exerents (optional): vation Planner Signature: EP 6: CATEGORICAL EXEMPTION DETERMINATION BE COMPLETED BY PROJECT PLANNER Further environmental review required. Proposed project (check all that apply): Step 2 - CEQA Impacts Step 5 - Advanced Historical Review	ION t does not meet scopes of work in either	
Preser ——————————————————————————————————	Preservation Planner and can proceed with categorical exerents (optional): vation Planner Signature: P 6: CATEGORICAL EXEMPTION DETERMINATION BE COMPLETED BY PROJECT PLANNER Further environmental review required. Proposed project (check all that apply): Step 2 - CEQA Impacts Step 5 - Advanced Historical Review STOP! Must file an Environmental Evaluation Application	ION t does not meet scopes of work in either	
Preser ——————————————————————————————————	Preservation Planner and can proceed with categorical exerents (optional): vation Planner Signature: EP 6: CATEGORICAL EXEMPTION DETERMINATION BE COMPLETED BY PROJECT PLANNER Further environmental review required. Proposed project (check all that apply): Step 2 - CEQA Impacts Step 5 - Advanced Historical Review	ION I does not meet scopes of work in either on. It is categorically exempt under CEQA.	
Preser ——————————————————————————————————	Preservation Planner and can proceed with categorical exerents (optional): vation Planner Signature: P 6: CATEGORICAL EXEMPTION DETERMINATION BE COMPLETED BY PROJECT PLANNER Further environmental review required. Proposed project (check all that apply): Step 2 - CEQA Impacts Step 5 - Advanced Historical Review STOP! Must file an Environmental Evaluation Application No further environmental review is required. The project There are no unusual circumstances that would result in effect. Project Approval Action:	ION It does not meet scopes of work in either Ion. It is categorically exempt under CEQA. In a reasonable possibility of a significant Signature:	
Preser ——————————————————————————————————	Preservation Planner and can proceed with categorical exerents (optional): vation Planner Signature: P 6: CATEGORICAL EXEMPTION DETERMINATION BE COMPLETED BY PROJECT PLANNER Further environmental review required. Proposed project (check all that apply): Step 2 - CEQA Impacts Step 5 - Advanced Historical Review STOP! Must file an Environmental Evaluation Application No further environmental review is required. The project There are no unusual circumstances that would result in effect. Project Approval Action: Building Permit	ION It does not meet scopes of work in either Ion. It is categorically exempt under CEQA. In a reasonable possibility of a significant Signature: Laura Lynch	
Preser ——————————————————————————————————	Preservation Planner and can proceed with categorical exerents (optional): vation Planner Signature: P 6: CATEGORICAL EXEMPTION DETERMINATION BE COMPLETED BY PROJECT PLANNER Further environmental review required. Proposed project (check all that apply): Step 2 - CEQA Impacts Step 5 - Advanced Historical Review STOP! Must file an Environmental Evaluation Application No further environmental review is required. The project There are no unusual circumstances that would result in effect. Project Approval Action:	ION It does not meet scopes of work in either In a reasonable possibility of a significant Signature: Laura Lynch 02/20/2018	

STEP 7: MODIFICATION OF A CEQA EXEMPT PROJECT

TO BE COMPLETED BY PROJECT PLANNER

In accordance with Chapter 31 of the San Francisco Administrative Code, when a California Environmental Quality Act (CEQA) exempt project changes after the Approval Action and requires a subsequent approval, the Environmental Review Officer (or his or her designee) must determine whether the proposed change constitutes a substantial modification of that project. This checklist shall be used to determine whether the proposed changes to the approved project would constitute a "substantial modification" and, therefore, be

PROPERTY INFORMATION/PROJECT DESCRIPTION

Proje	ect Address (If different than fron	t page)	Block/Lot(s) (If different than front page)
180 V	/IENNA ST		5958/016
Case	No.	Previous Building Permit No.	New Building Permit No.
2016-	003314PRJ	201601147155	
Plans	s Dated	Previous Approval Action	New Approval Action
		Building Permit	
	fied Project Description:	CONSTITUTES SUBSTANTIAL MODIF	ICATION
	pared to the approved project, w		- IOATION
Com		· •	
igert	Result in expansion of the bui	lding envelope, as defined in the Planning	Code;
	Result in the change of use th Sections 311 or 312;	at would require public notice under Planni	ng Code
	Result in demolition as define	d under Planning Code Section 317 or 1900	D5(f)?
		ented that was not known and could not have rmination, that shows the originally approve ption?	
If at I	east one of the above boxes is	checked, further environmental review i	s required.
DET	ERMINATION OF NO SUBSTA	NTIAL MODIFICATION	
	The proposed modification wo	ould not result in any of the above changes.	
approv	al and no additional environmental revi	ons are categorically exempt under CEQA, in accord ew is required. This determination shall be posted on the applicant, City approving entities, and anyone re-	n the Planning
Plan	ner Name:	Signature or Stamp:	



DISCRETIONARY REVIEW APPLICATION

2016-003314DRP

RECEIVED

JUN 0 4 2018

CITY & COUNTY OF S.F. PLANNING DEPARTMENT PIC

Name: Frank Tool			. 1	
Address:	170 Vienna St, San Francisco CA, 94112		Email Address: frankdtool@gmail.com	
170 Vicinia St, San Trancist		Telephone:	415 573 7428	
Applicant Information (if applicable)				
Name: Derek Vinh			Same as above	
Company/Organization: ICE Design				
Address: 90 South Spruce Ave, Ste K, South S	San Erangisco CA 94080	Email Address:	info@icedesigninc.com	
90 South Spruce Ave, Sie K, South S	san Flancisco, CA 94000	Telephone:	650 741 6968	
Please Select Billing Contact:	☐ Owner	☐ Applicant	Other (see below for details)	
		••	Phone: 415 573 7428	
Name: Frank Tool En	nail: frankdtool@gr	nail.com ☐ Applicant	Phone: 413 373 7423	
Please Select Primary Project Conta			_	
			☐ Billing	
Please Select Primary Project Conta Property Information		☐ Applicant	☐ Billing	
Please Select Primary Project Conta Property Information Project Address: 180 Vienna St Plan Area:		☐ Applicant	☐ Billing	
Please Select Primary Project Conta Property Information Project Address: 180 Vienna St	ct:	Applicant Block/Lot(s): - ect and its purp	☐ Billing 5958/016 ose. Please state which section(s) of the izations or changes to the Planning Code o	
Property Information Project Address: 180 Vienna St Plan Area: Project Description: Please provide a narrative project description to Planning Code from which you are requesting Zoning Maps if applicable. "side/rear addition which includes be	ct:	Applicant Block/Lot(s): - ect and its purp	☐ Billing 5958/016 ose. Please state which section(s) of the izations or changes to the Planning Code o	
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Project Details:				
☐ Change of Use	☐ New Construction	☐ Demolition	☐ Facade Alterations	☐ ROW Improvement
Additions	Legislative/Zoning Changes uction Cost:	Lot Line Adjustn	nent-Subdivision 🗌 O	ther
	Special Needs			
Non-Residential:	☐ Formula Retail ☐ ☐ Financial Service ☐	Medical Cannabis Disp Massage Establishme	. —	aphernalia Establishment
Related Building P	ermits Applications	···		
Building Permit Applica	ations No(s): 2016.01.14.715	5	• • • • • • • • • • • • • • • • • • • •	

ACTIONS PRIOR TO A DISCRETIONARY REVIEW REQUEST

In reviewing applications for Certificate of Appropriateness the Historic Preservation Commission, Department staff, Board of Appeals and/or Board of Supervisors, and the Planning Commission shall be governed by *The Secretary of the Interior's Standards for the Treatment of Historic Properties* pursuant to Section 1006.6 of the Planning Code. Please respond to each statement completely (Note: Attach continuation sheets, if necessary). Give reasons as to *how* and *why* the project meets the ten Standards rather than merely concluding that it does so. IF A GIVEN REQUIREMENT DOES NOT APPLY TO YOUR PROJECT, EXPLAIN WHY IT DOES NOT.

PRIOR ACTION	YES	NO
Have you discussed this project with the permit applicant?		
Did you discuss the project with he Planning Department permit review planner?	/	
Did you participate in outside mediation on this case? (including Community Boards)		

CHANGES MADE TO THE PROJECT AS A RESULT OF MEDIATION

If you have discussed the project with the applicant, planning staff or gone through mediation, please attach a summary of the result, including any changes that were made to the proposed project.

I contacted Community Boards, discussed tenative mediation dates, then twice called and spoke with the applicant and requested the applicant to participate in mediation. I never received a call back from the applicant, thus was unable to set up mediation.

DISCRETIONARY REVIEW REQUEST

In the space below and on seperate paper, if necessary, please present facts sufficient to answer each question.

- What are the reasons for requesting Discretionary Review? The project meets the minimum standards of the Planning Code.
 What are the exceptional and extraordinary circumstances that justify Discretionary Review of the project? How does the
 project conflict with the City's General Plan or the Planning Code's Priority Policies or Residential Design Guidelines? Please
 be specific and site specific sections of the Residential Design Guidelines.
- 1. The project would block light from entering my home, as well as shading my entire backyard, contravening Planning Code Section 101, and RDG Section III., Site Design.
- 2. The project does not fit in with either the immediate context nor the broader neighborhood context, nor the block pattern, as neighboring house all have significantly shorter building depth, RDG Section II., Neighborhood Character.
- 3. Despite the projects application stating residential use, the property has been vacant for at least the last 2 years, and many neighbors are also concerned that our already limited parking situation will further deteriorate with a likely influx of tenants.
- The Residential Design Guidelines assume some impacts to be reasonable and expected as part of construction. Please explain how this project would cause unreasonable impacts. If you believe your property, the property of others or the neighborhood would be adversely affected, please state who would be affected, and how.

Please see above. My property, light, and the neighborhood character would all be affected. I have discussed the project with several neighbors and I believe that the owners of at least the following properties all have concerns regarding the project: 175 Naples St, 166 Vienna St, 171 Vienna St, 179 Vienna St, and myself at 170 Vienna St.

3. What alternatives or changes to the proposed project, beyond the changes (if any) already made would respond to the exceptional and extraordinary circumstances and reduce the adverse effects noted above in question #1?

Any renovation that did not violate the block pattern, block sunlight to my own home or yard, or lend itself to further parking difficulties. For instance, renovating on the existing footprint of the property.

APPLICANT'S AFFIDAVIT

Under penalty of perjury the following declarations are made:

- a) The undersigned is the owner or authorized agent of the owner of this property.
- b) The information presented is true and correct to the best of my knowledge.
- c) Other information or applications may be required.

TO Fil Tool		Frank Tool	
Signature		Name (Printed)	
neighbor	415 573 7428	frankdtool@gmail.com	:ر
Relationship to Project Phone (i.e. Owner, Architect, etc.)		Email	
APPLICANT'S SIT	E VISIT CONSENT FOR	M	
I herby authorize City and Cour interior and exterior accessible.		onduct a site visit of this property, making	all portions of the
10 Fal	Fool	Frank Tool	
Signature		Name (Printed)	
6/3/18		•	

For Department Use Only				7 8 8 m
Application received	by Planning Department:	S on		
		Date:		
By:		Date		

Date

DISCRETIONARY REVIEW (DRP)





SAN FRANCISCO PLANNING DEPARTMENT

1650 MISSION STREET, SUITE 400 SAN FRANCISCO, CA 94103-2479 MAIN: (415) 558-6378 SFPLANNING.ORG

Project Information	Pro	iect	Inforn	natior
----------------------------	-----	------	--------	--------

Property Address: 180 VIENNA STREET Zip Code: 94112

Building Permit Application(s): 2016.01.14.7155

Record Number: Assigned Planner:

Project Sponsor

Name: DEREK VINH Phone: (650) 741-6968

Email: INFO@ICEDESIGNINC.COM

Required Questions

 Given the concerns of the DR requester and other concerned parties, why do you feel your proposed project should be approved? (If you are not aware of the issues of concern to the DR requester, please meet the DR requester in addition to reviewing the attached DR application.)

THE PROJECT IS CURRENTLY IN COMPLIANCE WITH PLANNING CODE SECTION 260(a)(2) TO DETERMINE THE ALLOWABLE HEIGHT. THE BUILDING DEPTH AT THE 1ST AND 2ND FLOORS IS NO GREATER THAN 12 FEER BEYOND THE AVERAGE OF ADJACENT PROPERTIES WHILE MAINTAINING THE PROPOSED 5 FEET SET BACKS. WHICH IS CONSISTENT WITH RDG PAGES 25-27.

2. What alternatives or changes to the proposed project are you willing to make in order to address the concerns of the DR requester and other concerned parties? If you have already changed the project to meet neighborhood concerns, please explain those changes and indicate whether they were made before or after filing your application with the City.

CHANGES ARE MADE THROUGHOUT THE REVIEWING PROCESS. PROJECT IS CONSISTENT WITH PLANNING CODE AND THE RDG.

3. If you are not willing to change the proposed project or pursue other alternatives, please state why you feel that your project would not have any adverse effect on the surrounding properties. Include an explaination of your needs for space or other personal requirements that prevent you from making the changes requested by the DR requester.

PROJECT DESIGN WITH NEIGHBORING RESIDENCES IN MIND. BOTH SIDE SET BACKS ARE TO ALLOW NATURAL SUNLIGHTS TO ADJACENT RESIDENCES. PROPERTY OWNER NEED SPACE TO RAISE HIS YOUNG CHILDEN.

Project Features

Please provide the following information about the project for both the existing and proposed features. Please attach an additional sheet with project features that are not included in this table.

	EXISTING	PROPOSED
Dwelling Units (only one kitchen per unit - additional kitchens count as additional units)	1	1
Occupied Stories (all levels with habitable rooms)	2	2
Basement Levels (may include garage or windowless storage rooms)	0	1
Parking Spaces (Off-Street)	1	1
Bedrooms	1	5
Height	22'8"	22'8"
Building Depth	35'	62'7"
Rental Value (monthly)	N/A	N/A
Property Value	N/A	N/A

I attest that the above information is true to the best of my knowledge.

Signature:	Date: 6/27/18
Printed Name: DEREK VINH	□ Property Owner☑ Authorized Agent

If you have any additional information that is not covered by this application, please feel free to attach additional sheets to this form.

ABBREVIATIONS

LAV.

MAX

M.C.

MIN.

MIR.

MISC

MTL.

MDF

N.I.C. NO.

N.T.S.

O.C.

O.D.

O.D.

OPNG.

OPP

'N' OR (N)

MECH

LT.

LAVATORY

MAXIMUM

MINIMUM

MIRROR

NUMBER

ON CENTER

OPENING

OPPOSITE

NOT TO SCALE

MECHANICAL

MEDICINE CARINET

MISCELLANEOUS

NOT IN CONTRACT

OUTSIDE DIAMETER

OVERELOW DRAIN

MEDIUM DENSITY FIBERBOARD

LIGHT

PERF PERFORATED ARV AROVE P.G. PAINT GRADE A.D. AREA DRAIN PLATE ADJ. ADJUSTABLE PLYWOOD A.F.F ABOVE FINISH FLOOR PAIR BD. BOARD PT. POINT BEL. BELOW RADIUS BLK. BLOCK RFF. REFRIGERATOR BLKG. BLOCKING REINFORCED RFINE ВМ. RΕΔΜ ROOF DRAIN R.D. BY OTHERS B.O. REQUIRED REQ'D BOT. воттом RESIL RESILIENT BSMT BASEMENT RET. RETAINING CAB. CABINET C.B. CATCH BASIN R.O. ROUGH OPENING CEM. CEMENT C.I. CAST IRON SCHEDULE SCHED CLG. CEILING SHWR SHOWER CLO. CLR. CLOSET SHT. SHEET CLEAR SHTH SHEATHING CONC CONCRETE SIM. SIMILAR CONT. CONTINUOUS S.D. SMOKE DETECTOR CNTR. COUNTER SPEC. SPECIFICATION CTR. CENTER DRYFR S.L.D SEE LANDSCAPE DRAWINGS DBL. DOUBLE S.S. STAINLESS STEEL DET. DETAIL SEE STRUCTURAL DRAWINGS S.S.D. DIA. DIM. DIAMETER STD. STANDARD DIMENSION STI STEEL DISP. DISPOSAL STOR STORAGE D.W. DISH WASHER SYMMETRICAL SYM. DR. DOOR TREAD D.S. DOWN SPOUT TBD. TO BE DESIGNED DWG. DRAWING TEL. DRWR. DRAWER T&G TONGUE AND GROOVE 'E' OR (E) EXISTING TYP. TYPICAL T.O. TOP OF ELEVATION T.O.S TOP OF SLAB ELEC DLECTRICAL LINLESS OTHERWISE NOTED II O N EQ. FOLIAL VERTICAL VERT. EXPANSION EXP. VESTIBULE VEST FURNACE VERIFY IN FIELD V.I.F. F.D. FLOOR DRAIN WASHER FDN. FOUNDATION FIN. FINISH WATER HEATER F.F.E FINISH FLOOR ELEVATION WATER CLOSET FINISH CEILING ELEVATION F.F.C. WD. WOOD FLR. FLOOR W.I. WROUGHT IRON F.O.C. FACE OF CONCRETE WIC WALK-IN CLOSET FT. FOOT OR FEET W/O WITHOUT FTG. **FOOTING** WHERE OCCURS W.O. FURRING FURR WATERPROOF WP. G.B. GRAB BAR WT WEIGHT GLASS GL. ANGLE GRND. GROUND GRD. GRADE DIAMETER GYP. GYPSUM POUND OF NUMBER H.B. HOSE BIB HDWD HARDWOOD HORIZ. HORIZONTAL HGT. HEIGHT INSIDE DIAMETER ΙD INSULATION INSUL INTERIOR INT. JOINT KIT. KITCHEN LAM. LAMINATE

GENERAL NOTES

- ALL CONSTRUCTION TO CONFORM TO 2013 CALIFORNIA BUILDING, ELECTRICAL, MECHANICAL, AND PLUMBING CODES AND ALL OTHER STATE, COUNTY, AND CITY ORDINANCE AND REGULATIONS PERTAINING HERETO.
- CONTRACTOR SHALL EXAMINE AND VERIFY EXISTING CONDITIONS OF THE JOB SITE. ANY DISCREPANCY BETWEEN DRAWINGS AND EXISTING CONDITIONS SHALL BE RECORDED AND REPORTED WITH A SUBMITTAL COPY TO THE ARCHITECT FOR RESOLUTION PRIOR TO COMMENCEMENT OF WORK, ALL EXISTING CONDITION DIMENSIONS PROVIDED BY OWNER AND ARE NOT VERIFIED BY SURVEYOR OR ARCHITECT
- DO NOT SCALE THE DRAWINGS
- PERFORM EXCAVATION AND FOUNDATION WORK IN CONFORMANCE WITH THE REQUIREMENTS OF THE SOILS REPORTS
- ALL DIMENSIONS ARE TO THE FACE OF OF STUD, FACE OF CONCRETE, OR FACE OR FRAMING UNLESS NOTES OTHERWISE.
- COMPLY WITH CERTIFICATION REQUIREMENTS OF THE CALIFORNIA ENERGY COMMISION FOR MECHANICAL EQUIPMENT, PLUMBING TRIM AND FITTINGS, WATER HEATERS, FURNACES, AND APPLIANCES.
- INSTALL ALL MATERIALS, EQUIPMENT, FIXTURES, AND APPLIANCES IN CONFORMANCE WITH THE REQUIREMENTS AND RECOMMENDATIONS OF THE MANUFACTURER AND THE REQUIREMENTS OF ALL APPLICABLE CODES.
- ALL SITE-CONSTRUCTED DOORS, SKYLIGHTS, AND WINDOWS, INCLUDING BUT NOT LIMITED TO FIELD MANUFACTURED DOORS, SKYLIGHTS, AND WINDOWS SHALL BE CAULKED BETWEEN THE DOOR, SKYLIGHTS, OR WINDOW AND THE BUILDING, AND SHALL BE WEATHER-STRIPPED.
- ALL WOOD, INCLUDING POSTS WITHIN 6" OF GROUND TO BE PRESSURE TREATED, FOR SILL PLATES, SLEEPERS OR BLOCKING IN CONTACT WITH CONCRETED OR MASONRY FOUNDATIONS PER C.B.C. 2306.4
- VERIFY EXACT LOCATION OF PLUMBING AND PIPING WITH THE PLUMBING SUBCONTRACTOR, BRING ANY INCONSISTENCIES TO THE ATTENTION OF THE ARCHITECT BEFORE PROCEEDING WITH THE WORK.
- VERIEV EXACT LOCATION OF MECHANICAL EQUIPMENT, DUCTS, GRILLES, REGISTERS, FLUES, AND VENTS WITH THE MECHANICAL SUBCONTRACTOR.
- MECHANICAL, HVAC WORK TO BE DESIGN-BUILD AND UNDER SEPARATE PERMIT
- ELECTRICAL WORK TO BE DESIGN-BUILD AND UNDER SEPARATE PERMIT.
- PLUMING WORK TO BE DESIGN-BUILD AND UNDER SEPARATE PERMIT. THE CONTRACTOR SHALL PROVIDE THE BUILDING OWNER WITH THE LIST OF
- HEATING, COOLING, AND LIGHTING SYSTEMS FEATURES, MATERIALS, COMPONENTS AND DEVICES IN THE BUILDING AND INSTRUCTIONS ON HOW TO
- AFTER INSTALLING THE WALL AND CEILING INSULATION THE INSTALLER SHALL POST IN A CONSPICUOUS LOCATION IN THE BUILDING A CERTIFICATED SIGHED. BY THE INSTALLER STATING THE INSTALLATION IS CONSISTENT WITH THE PLANS. THE CERTIFICATE SHALL ALSO STATE THE MANUFACTURER'S NAME, MATERIAL IDENTIFICATION, AND INSTALLED R-VALUE.
- THE CENTER OF RECEPTACLES/OUTLETS SHALL BE MOUNTED NOT LESS THAN
- LIGHT SWITCHES, ELECTRICAL OUTLETS, THERMOSTATS, AND OTHER ENVIRONMENTAL CONTROLS SHALL NOT BE LESS THAN 15" OR MORE THAN 48"
- STRUCTURAL OBSERVATION SHALL BE REQUIRED BY THE [X] ARCHITECT OR [X] ENGINEER FOR STRUCTURAL CONFORMANCE TO THE APPROVED PLANS.
- CONTRACTOR SHALL BE RESPONSIBLE FOR FILING/RECEIVING OF ALL REQUIRED

DRAWING LEGEND:	SYMBOLS
EXISTING WALL TO REMAIN	SECTION NO.
EIIII EXISTING WALL TO BE REMOVED	SHEET NO.
NEW WALL	1 DETAIL
1 HR. RATED WALL	A-1 SHEET NO.
WALL WITH R13 INSULATION KEY NOTES	KEY NOTES NO.
,	



PROJECT DATA

OWNER BUO NENG CHEN ADDRESS: 180 VIENNA STREET, SAN FRANCISCO, CA 94112

LOT/BLOCK 016/5958 ZONING DISTRICT: OCCUPANCY:

CONSTRUCTION TYPE: TYPE V NON-RATED SPRINKLERED: NOT REQUIRED LOT AREA: 2.495 SQ. FT. CAR PARKING SPACE: (E)1 . (N)1 BICYCLE PARKING SPACE: (F)0.(N)1

SCOPE OF WORK: HORIZONTAL ADDITION

		<u> </u>	
FLOOR AREA:	EXISTING	ADDITION	PROPOSED
BASEMENT	0 S.F	457 S.F.	457 S.F
1ST FLOOR(GARAGE INCLUDED)	485 S.F.	413 S.F.	898 S.F.
2ND FLOOR	525 S.F.	375 S.F.	900 S.F.
TOTALS	1,010 S.F.	1,245 S.F.	2,255 S.F.

GOVERNING CODES

2013 CALIFORNIA BUILDING CODE (W/ SAN FRANCISCO AMENDMENT)

2013 CALIFORNIA MECHANICAL CODE

2013 CALIFORNIA PLUMBING CODE 2013 CALIFORNIA ELECTRICAL CODE

2013 CALIFORNIA FIRE CODE 2013 CALIFORNIA RESIDENTIAL CODE

2013 CALIFORNIA GREEN BUILDING STANDARDS CODE

WATER CONSERVATION REQUIREMENT

2013 CALIFORNIA ENERGY CODE

1. WATER CLOSET WITH A FLOW RATE IN EXCESS OF 1.6 GPF WILL NEED TO BE REPLACED WITH WATER CLOSETS WITH A MAXIMUM FLOW RATE OF 1.28 GPF. 2. SHOWER HEADS WITH A FLOW RATE GREATER THAN 2.5 GPM WILL NEED TO BE REPLACED WITH A MAXIMUM 2.0 GPM SHOWER HEAD.

3. LAVATORY AND KITCHEN FAUCETS WITH A FLOW RATE GREATER THAN 2.2 GPM WILL NEED TO BE REPLACED WITH A FAUCET WITH MAXIMUM FLOW RATE OF 1.5 GPM (OR 1.8 GPM FOR KITCHEN FAUCETS).

WALLS ENCLOSING CONDITIONED SPACE

R-VALUES ON THE PLAN VIEW SHALL MATCH THE R-VALUES ON CF-1R FORM. VALUES SHALL BE: (FOR PRESCRIPTIVE PACKAGE D. CE-1R FORMS)

R-13 IN 2x4 STUDS

R-19 IN 2x6 STUDS

R-22 IN 2x8 STUDS R-30 IN 2x10 STUDS

R-38 IN 2x12 STUDS

OR SPECIFY THE R-VALUE ON THE COMPUTER GENERATED CF-1R FORM (PERFORMANCE METHOD) (CNC STD 151 (f) 1 & TABLES 151-B, C OR D AND REFERENCE APPENDICES TABLE 4.3.1).

CEILINGS BETWEEN GARAGE AND ROOMS ABOVE, AND AT FLOORS WITH CRAWL SPACES

R-VALUES ON THE PLAN VIEW SHALL MATCH THE R-VALUES ON CF-1R FORM. VALUES SHALL BE: (FOR PRESCRIPTIVE PACKAGE D, CF-1R FORMS)

R-13 IN 2x4 JOISTS

R-19 IN 2x6 JOISTS R-22 IN 2x8 JOISTS

R-30 IN 2x10 JOISTS

B-38 IN 2x12 JOISTS

OR SPECIFY THE R-VALUE ON THE COMPUTER GENERATED CF-1R FORM (PERFORMANCE METHOD) (CNC STD 151 (f) 1 & TABLES 151-B, C OR D AND REFERENCE APPENDICES TABLE 4.3.1)

SHEET INDEX

A0.0 PROJECT DATA, DRAWING INDEX, DRAWING ABBREVIATIONS, SYMBOLS AND GENERAL NOTES

ARCHITECTURAL

A1.0 SITE PLANS & PHOTOGRAPHS

A2 0 FLOOR PLANS FLOOR PLANS A2 1

A2.2 ROOF PLANS

A3.0 FI EVATIONS

A3.1 ELEVATIONS

A3.2 ELEVATIONS

ELEVATIONS A3.3

A4.0 SECTIONS Δ/1 1

SECTIONS A5.0 SCHEDULE

RUO NENG CHEN 180 VIENNA STREET SAN FRANCISCO, CA 94112


PROJECT DATA, DRAWING INDEX **DRAWING** ABBREVIATIONS. SYMBOLS AND **GENERAL NOTES**

PROJECT ADDRESS:

180 VIENNA STREET SAN FRANCISCO, CA 94112 BLOCK/LOT: 5958/016

NOTES BY ⚠ NOPDR#2 171013 T.Y. ⚠ COMMENT 180330 ♠ COMMENT 180728

DATE 08/15/2014 scale AS NOTED DRAWN J.C. JOB 140314

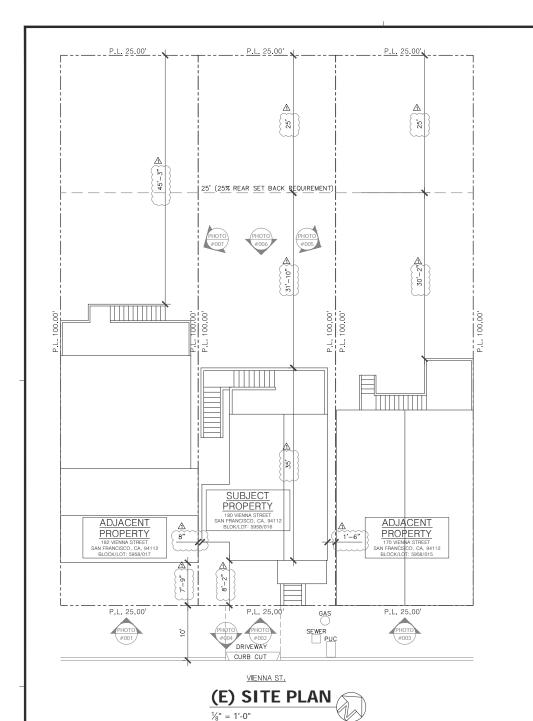

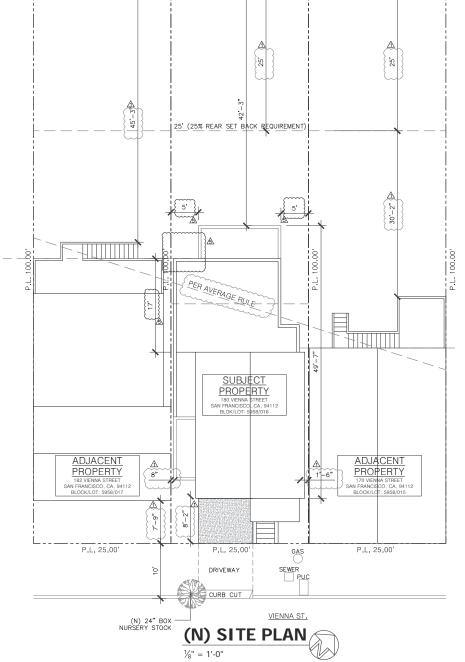






PHOTO #006



PHOTO #007

RUO NENG CHEN 180 VIENNA STREET SAN FRANCISCO, CA 94112

SITE PLANS & **PHOTOGRAPHS**

PROJECT ADDRESS:

180 VIENNA STREET SAN FRANCISCO, CA 94112 BLOCK/LOT: 5958/016



PHOTO #002





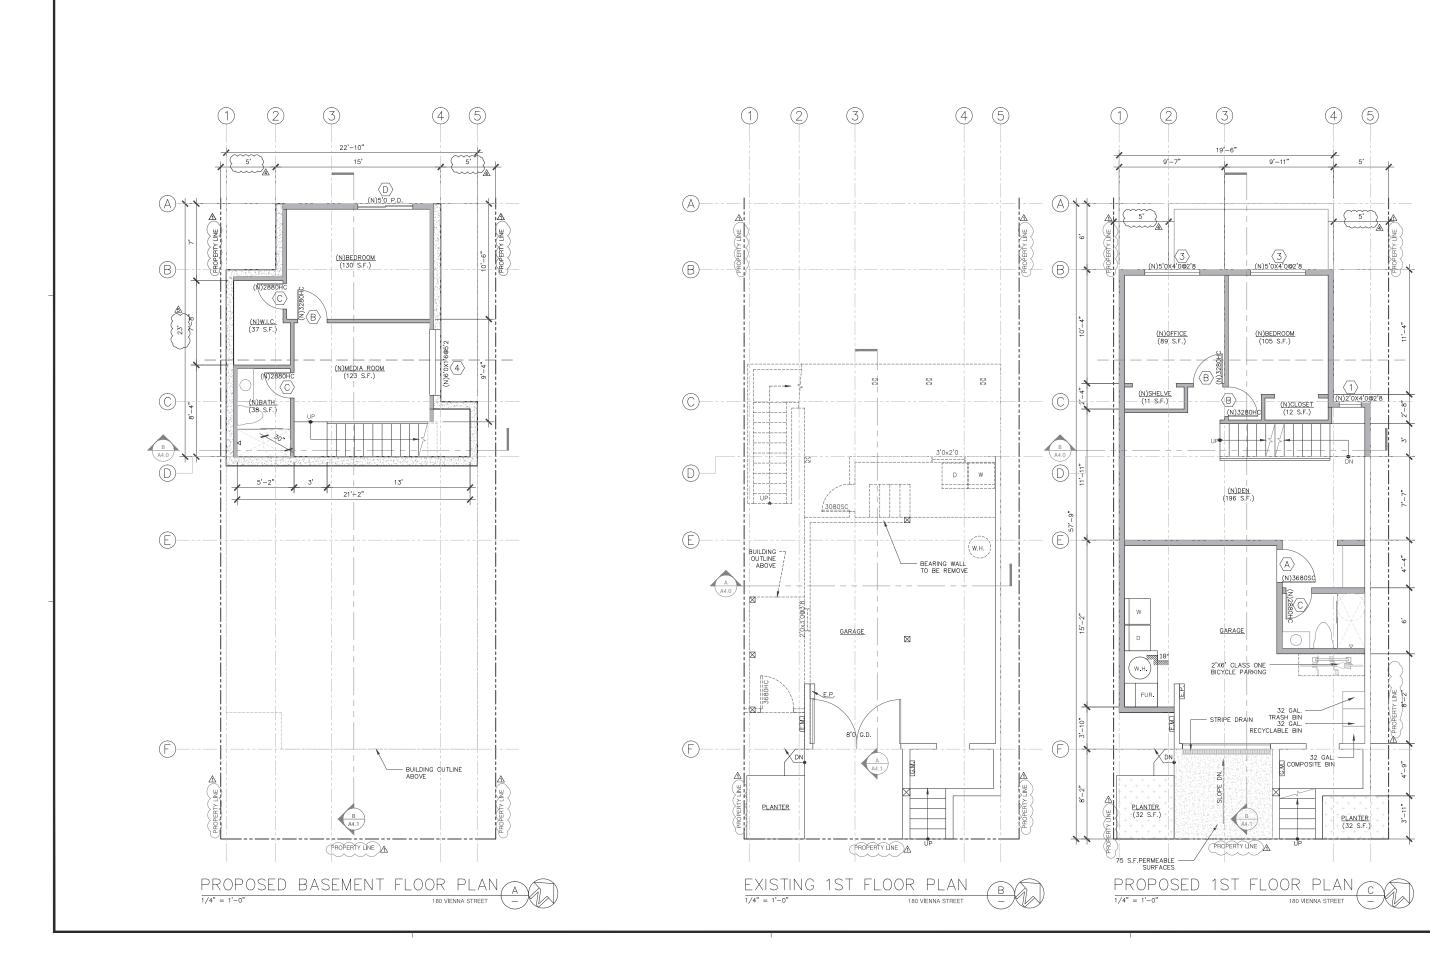


PHOTO #004

NOTES	BY
<u> </u>	T.Y.
<u></u> ★ COMMENT 171013	T.Y.
⚠ COMMENT 180330	T.Y.
⚠ COMMENT 180728	T.Y.
\triangle	
Δ	

DATE 08/15/2014
SCALE AS NOTED
DRAWN J.C. JOB 140314

A1.0



APPLICANT:
RUO NENG CHEN
180 VIENNA STREET
SAN FRANCISCO, CA 94112

SHEET TITLE:

FLOOR PLANS

PROJECT ADDRE

180 VIENNA STREET SAN FRANCISCO, CA 94112 BLOCK/LOT: 5958/016

NOTES	BY
<u> </u>	T.Y.
	T.Y.
⚠ COMMENT 180330	T.Y.
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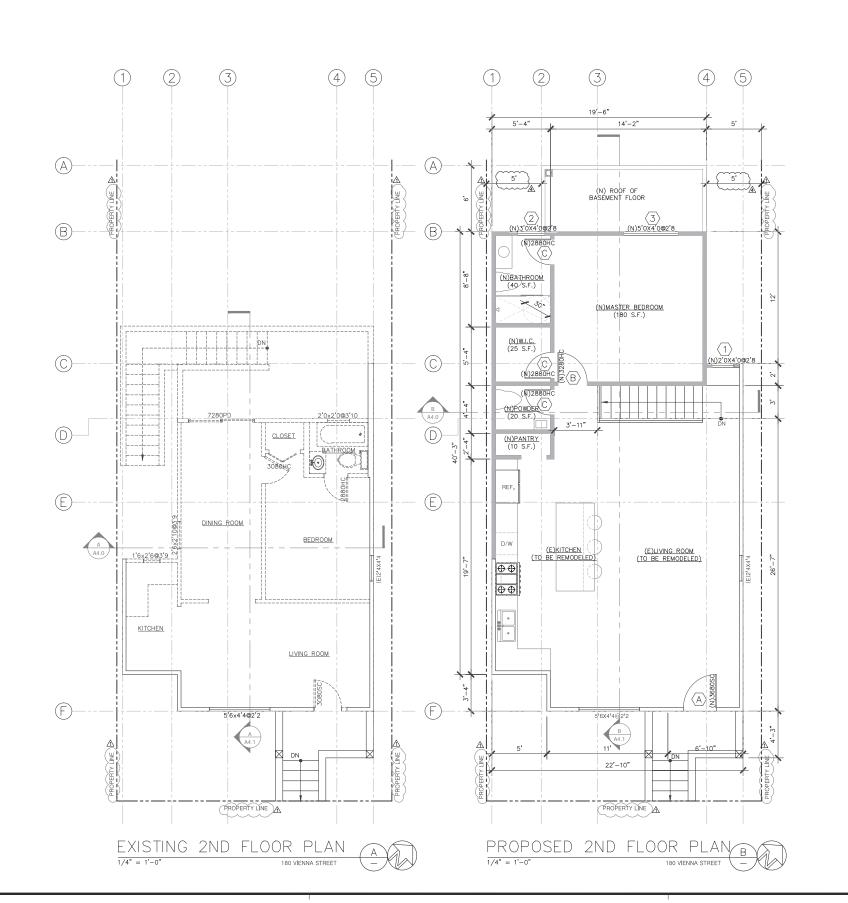
DATE 08/15/2014

SCALE AS NOTED

DRAWN J.C.

JOB 140314

A2.0



APPLICANT

RUO NENG CHEN 180 VIENNA STREET SAN FRANCISCO, CA 94112

CLICCT TITL

FLOOR PLANS

PROJECT ADDRESS:

180 VIENNA STREET SAN FRANCISCO, CA 94112 BLOCK/LOT: 5958/016

NOTES	BY
<u></u> NOPDR#2 171013	T.Y.
	T.Y.
⚠ COMMENT 180330	T.Y.
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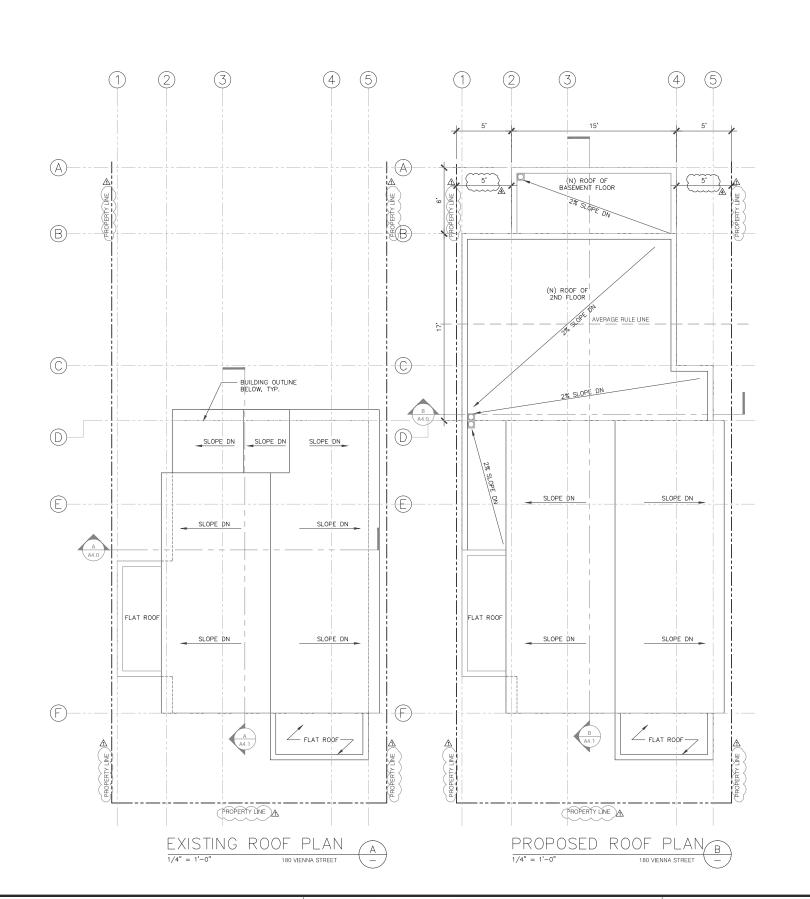
DATE 08/15/2014

SCALE AS NOTED

DRAWN J.C.

JOB 140314

A2.1



APPLICANT

RUO NENG CHEN 180 VIENNA STREET SAN FRANCISCO, CA 94112

CLICCT TITL

ROOF PLANS

PROJECT ADDRESS:

180 VIENNA STREET SAN FRANCISCO, CA 94112 BLOCK/LOT: 5958/016

NOTES	BY
<u>∧</u> NOPDR#2 171013	T.Y.
<u>★</u> COMMENT 171013	T.Y.
⚠ COMMENT 180330	T.Y.
<u>♠</u> COMMENT 180728	T.Y.
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DATE 08/15/2014

SCALE AS NOTED

DRAWN J.C.

JOB 140314

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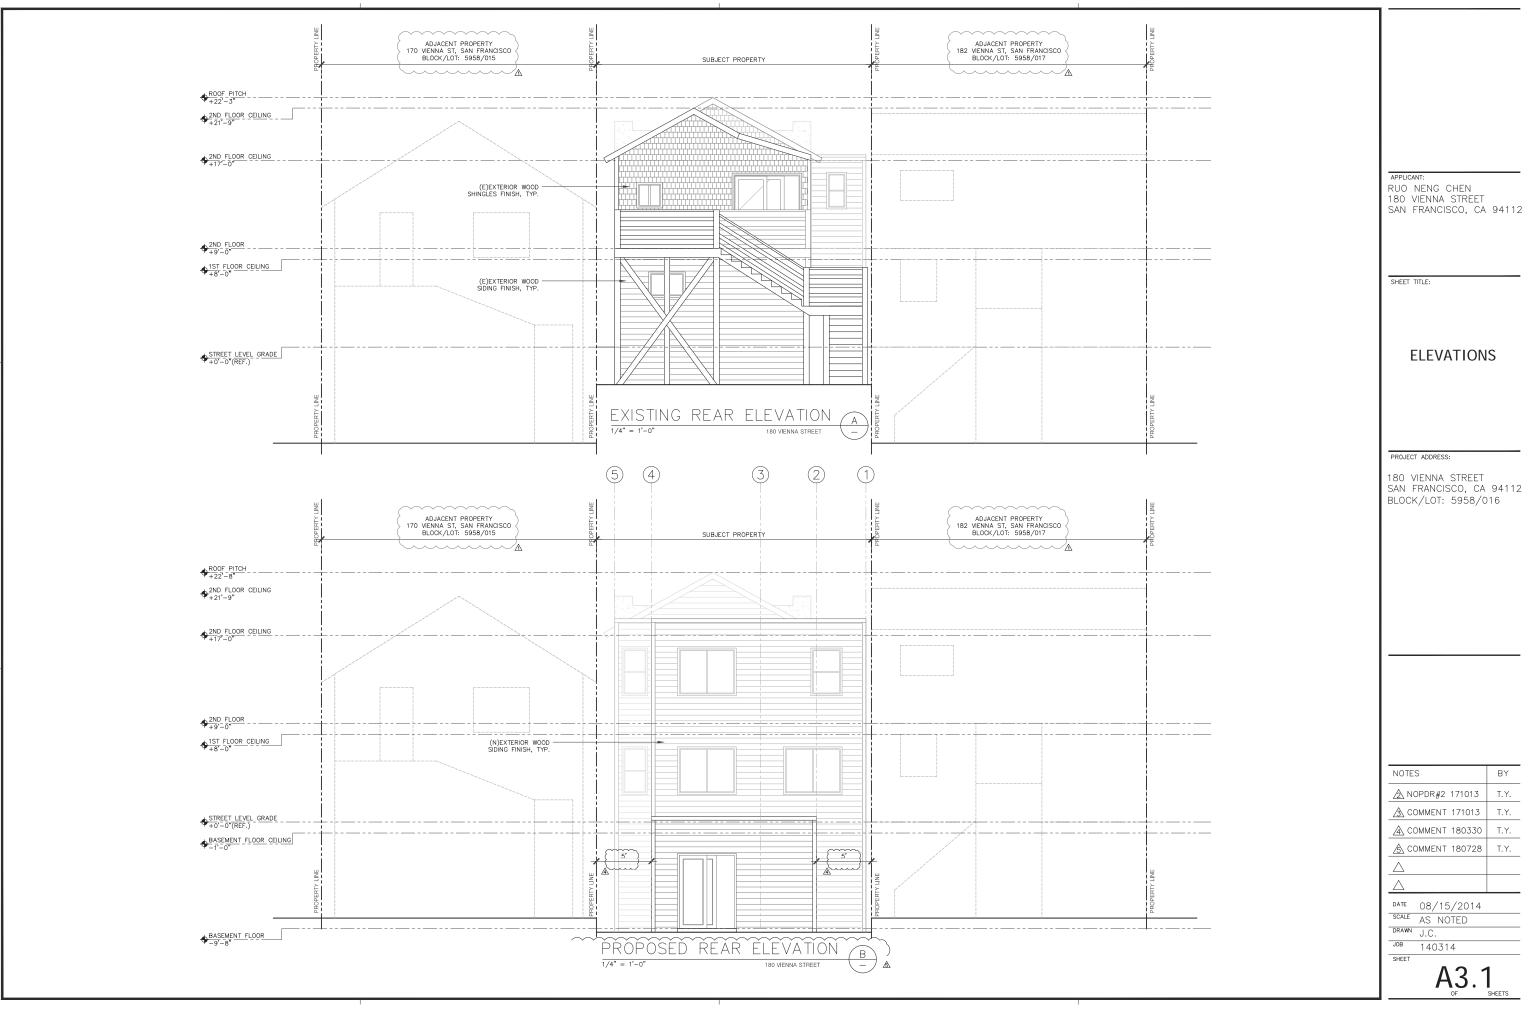


RUO NENG CHEN 180 VIENNA STREET SAN FRANCISCO, CA 94112

180 VIENNA STREET SAN FRANCISCO, CA 94112 BLOCK/LOT: 5958/016

NOTES	BY
<u>∧</u> NOPDR#2 171013	T.Y.
<u>★</u> COMMENT 171013	T.Y.
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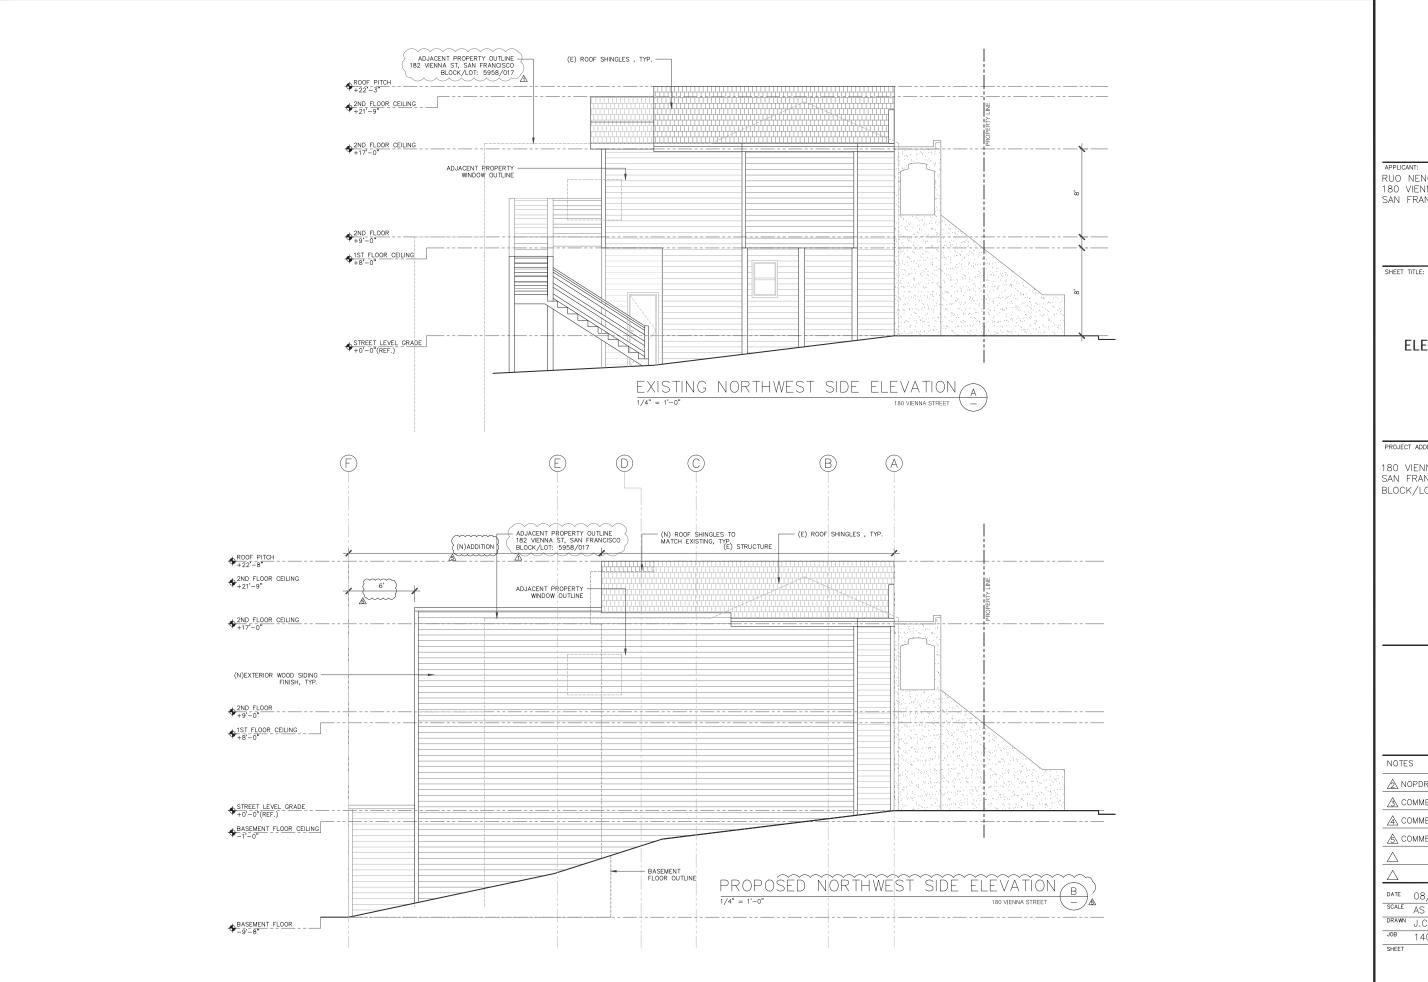
DATE 08/15/2014
SCALE AS NOTED
DRAWN J.C.



180 VIENNA STREET SAN FRANCISCO, CA 94112 BLOCK/LOT: 5958/016

NOTES	BY
<u></u> NOPDR#2 171013	T.Y.
	T.Y.
⚠ COMMENT 180330	T.Y.
⚠ COMMENT 180728	T.Y.
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D.T.	

DATE 08/15/2014



RUO NENG CHEN 180 VIENNA STREET SAN FRANCISCO, CA 94112

ELEVATIONS


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<u> </u>	T.Y.
<u>★</u> COMMENT 171013	T.Y.
⚠ COMMENT 180330	T.Y.
<u>♠</u> COMMENT 180728	T.Y.
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DATE 08/15/2014 SCALE AS NOTED

DRAWN J.C. JOB 140314



PPLICANT:

RUO NENG CHEN 180 VIENNA STREET SAN FRANCISCO, CA 94112

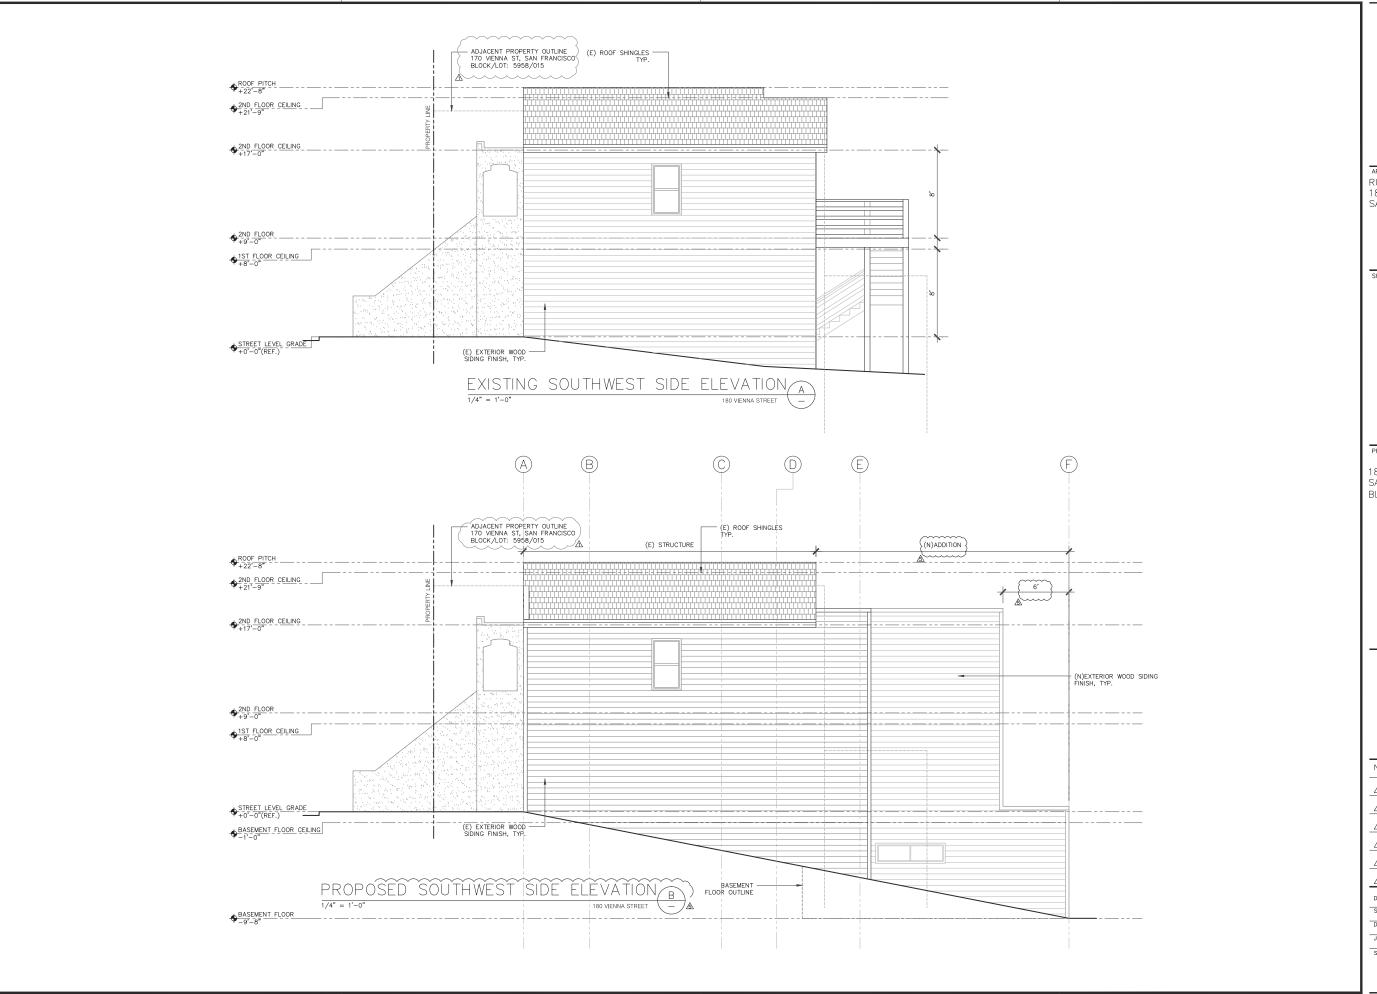SHEET TITLE:

ELEVATIONS

PROJECT ADDRESS:

180 VIENNA STREET SAN FRANCISCO, CA 94112 BLOCK/LOT: 5958/016


NOTES	BY
<u> </u>	T.Y.
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⚠ COMMENT 180330	T.Y.
<u>♠</u> COMMENT 180728	T.Y.
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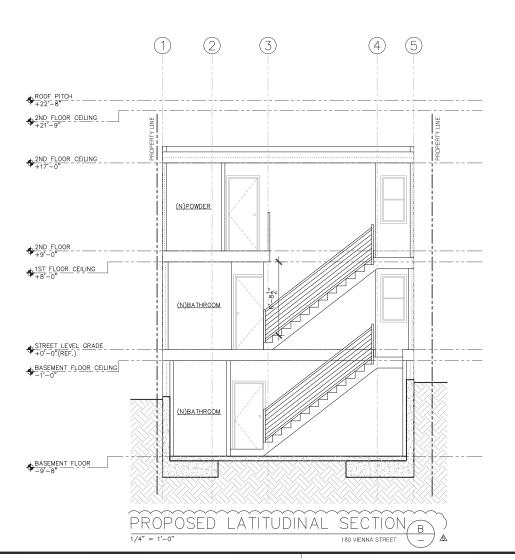
DATE 08/15/2014

SCALE AS NOTED

DRAWN J.C.

JOB 140314



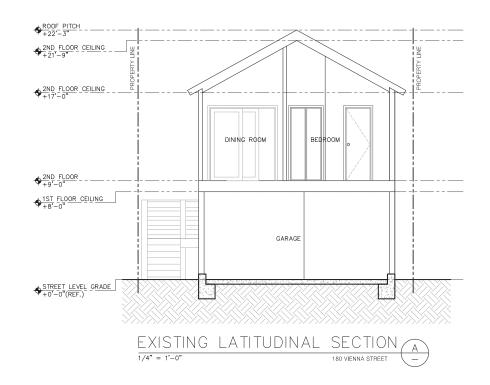

APPLICANT:
RUO NENG CHEN
180 VIENNA STREET
SAN FRANCISCO, CA 94112

SHEET TITLE:

SECTIONS

PROJECT ADDRESS:

180 VIENNA STREET SAN FRANCISCO, CA 94112 BLOCK/LOT: 5958/016

NOTES	BY
⚠ NOPDR#2 171013	T.Y.
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A COMMENT 180330	T.Y.
<u></u> COMMENT 180728	T.Y.
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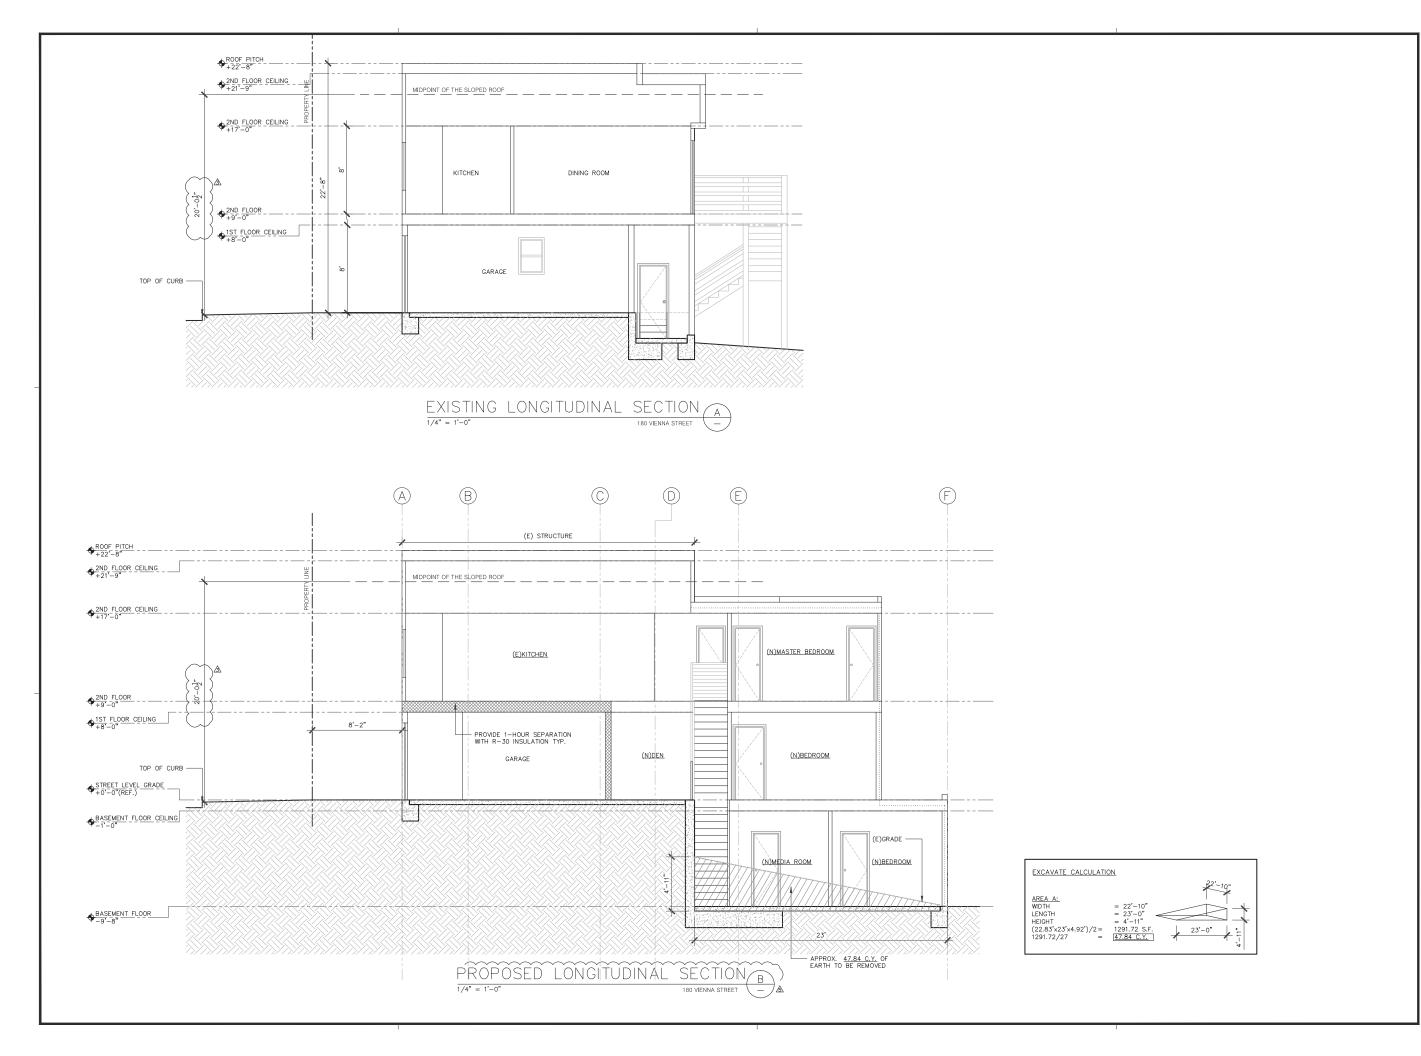
DATE 08/15/2014

SCALE AS NOTED

DRAWN J.C.

JOB 140314

A4.0



APPLICANT:

RUO NENG CHEN 180 VIENNA STREET SAN FRANCISCO, CA 94112

CHEET TITI

SECTIONS

PROJECT ADDRESS:

180 VIENNA STREET SAN FRANCISCO, CA 94112 BLOCK/LOT: 5958/016

NOTES	BY
<u></u> NOPDR#2 171013	T.Y.
⚠ COMMENT 171013	T.Y.
⚠ COMMENT 180330	T.Y.
⚠ COMMENT 180728	T.Y.
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DATE 08/15/2014	


DATE 08/15/2014


SCALE AS NOTED


DRAWN J.C.

JOB 140314


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- THRESHOLD AT DOORWAYS SHALL NOT EXCEED 0.75 INCH IN HEIGHT FOR SLIDING DOORS SERVING DWELLING UNITS OR 0.5 INCH FOR OTHER DOORS. THRESHOLD HEIGHT SHALL BE LIMITED TO 7.75 INCHES (RESIDENTIAL) WHEN THE DOOR IS AN EXTERIOR DOOR THAT IS NOT A COMPONENT OF THE REQUIRED MEANS OF EGRESS; THE DOOR, OTHER THAN AN EXTERIOR STORM OR SCREEN DOOR DOES NOT SWING OVER THE LANDING OR STEP.
- ALL EXTERIOR DOOR TO BE INSTALLED WITH WOOD TRIM, U.O.N

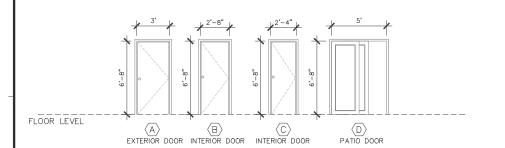

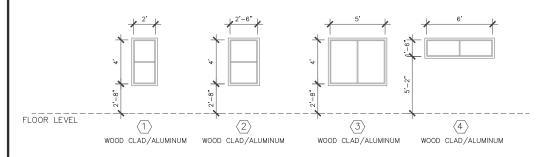APPLICANT

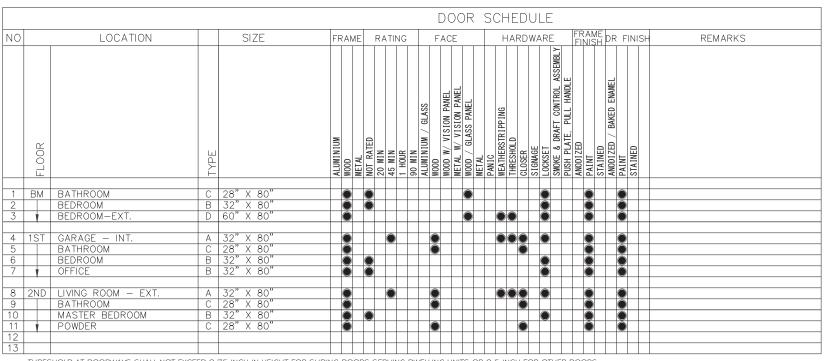RUO NENG CHEN 180 VIENNA STREET SAN FRANCISCO, CA 94112

SHEET TITLE:

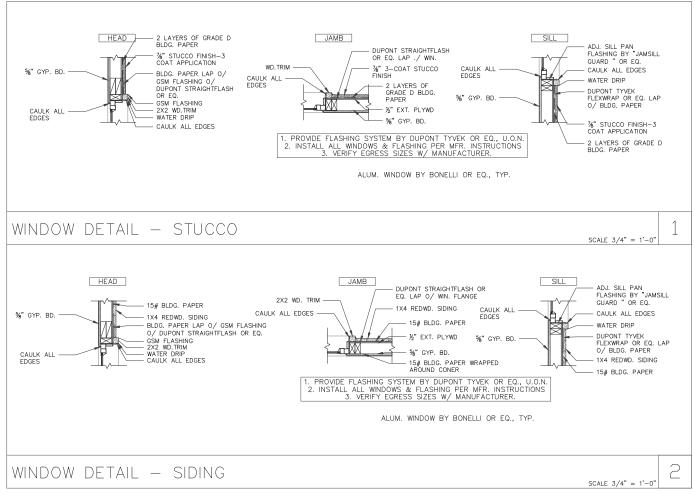SCHEDULE

PROJECT ADDRESS:

180 VIENNA STREET SAN FRANCISCO, CA 94112 BLOCK/LOT: 5958/016

NOTES	BY
<u> </u>	T.Y.
	T.Y.
⚠ COMMENT 180330	T.Y.
⚠ COMMENT 180728	T.Y.
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DATE 08/15/2014	

SCALE AS NOTED DRAWN J.C. JOB 140314

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