Memo to the Planning Commission

HEARING DATE: SEPTEMBER 28, 2017 CONTINUED FROM: FEBRUARY 23, APRIL 13, & JULY 6, 2017

 Date:
 September 21, 2017

 Case No.:
 2013.1330DRP

Project Address: 1900 MISSION STREET

Permit Application: 2015.07.08.0963

Zoning: Mission Street NCT (Neighborhood Commercial Transit) District

Mission Street Formula Retail Restaurant Subdistrict Mission Alcoholic Beverage Special Use Subdistrict

80-B Height and Bulk District

Block/Lot: 3554/001

Project Sponsor: Kevin Stephens Design

P. O. Box 31081

San Francisco, CA 94131

Staff Contact: Doug Vu – (415) 575-9120

Doug.Vu@sfgov.org

Recommendation: Do not take DR and approve the project as proposed.

BACKGROUND

The Project includes the demolition of an existing 1,690 square-foot light automotive repair shop and construction of a 75 feet tall, approximately 16,475 square-feet, seven-story building with basement that includes approximately 741 square-feet of ground floor commercial space and 15,734 square-feet of residential use for eleven two-bedroom dwelling units. Approximately 323 square-feet of private open space for two units, a 1,211 square-feet roof deck for common use, and a combined total of fourteen Class 1 and 2 bicycle parking spaces are also proposed. On July 20, 2016 (Case No. 2013.1330V), the Zoning Administrator considered a modification from the rear yard requirement because the Project complies with the criteria under Planning Code Section 134(e)(1).

On February 23, 2017, the Planning Commission considered a request for Discretionary Review (DR) of the proposed project at 1900 Mission Street (Case No. 2013.1330DRP) pursuant to Planning Code Section 312, which included the demolition of an existing 1,690 square-foot light automotive repair shop and construction of a 75 feet tall, 17,662 square-feet, seven-story building over a basement with 989 square-feet of ground floor commercial space and 16,673 square-feet of residential use for twelve dwellings and a combined 1,599 square feet of private and common open space.

The Planning Commission received testimony from the DR Requestor, Mr. Peter Papadopoulos, on behalf of Mission Economic Development Agency regarding the Project's compliance with General Plan and Planning Code Priority Policy #1 to preserve neighborhood-serving retail uses by replacing the existing automotive repair shop with luxury housing. The DR Requestor stated the project should maintain the

1650 Mission St. Suite 400 San Francisco, CA 94103-2479

Reception: 415.558.6378

Fax:

415.558.6409

Planning Information: **415.558.6377** Production, Distribution & Repair (PDR) use and its jobs to remain in compliance with the Priority Policies. The DR Requestor also stated the Project was in conflict with the General Plan and Planning Code Priority Policy #2 to preserve existing housing and neighborhood character in order to protect the cultural and economic diversity of the Mission neighborhood, by replacing a long-standing automotive repair shop with luxury housing that would negatively impact the character of this working-class neighborhood and contribute to displacement impacts that threaten the Mission neighborhood community's cultural and economic diversity. After receiving public testimony, the Commission deliberated and continued this item to the public hearing on April 13, 2017, requiring the Sponsor to modify the Project to address light and privacy impacts to the adjacent property at 1906-1910 Mission Street, the building's fenestration and exterior materials to be more compatible, and the interior layout of the ground floor's retail space and dwelling unit. On April 13, 2017, the Sponsor requested the hearing be continued to June 15, 2017, and again to July 6, 2017 and September 23, 2017, to allow the Sponsor additional time to revise the Project as directed by the Commission.

CURRENT PROPOSAL

The Sponsor proposes the following modifications to the Project:

- A 27-ft. lightwell equal to 85 percent of the depth of the adjacent building's 31-ft. 9-in. lightwell
 has been added at the second floor and above to minimize light impacts to that adjacent
 building. This 27-ft. proposed depth is consistent with the design guideline used by the
 department for matching lightwells.
- The common roof deck has been set back 5-ft. from the building's south perimeter to reduce privacy impacts to the adjacent building.
- Private stair penthouses to the roof deck have been removed and replaced with common access
 penthouses that have the minimum required footprint and are sloped to reduce bulk and reduce
 privacy impacts to the adjacent building.
- The total area of glazing and size of windows have been reduced by 25 percent to increase the proportion of wall-to-window area that is more balanced and compatible with the neighborhood character.
- A ground floor commercial storefront with an improved fenestration pattern and architectural
 details including a bulkhead, pilasters and awnings to better define the ground floor and be
 more compatible with the neighborhood.
- Exterior materials such as troweled cement plaster, lap siding, ceramic tiles and black aluminum-framed windows that are appropriately applied to create a more unified and desirable visual appearance that maintains the character of this area of the Mission neighborhood.
- The relocation of interior stairs and reduction of the mezzanine area to improve the ground floor commercial space.
- The modifications above have reduced the number of dwelling units to eleven.

Memo to Planning Commission Hearing Date: September 28, 2017 CASE NO. 2013.1330DRP 1900 Mission Street

PUBLIC COMMENT

Since the Planning Commission considered this request for Discretionary Review on February 23, 2017, the Department has received six additional letters of support for the proposed project.

Under the Commission's pending DR Reform Legislation, this project <u>would</u> be referred to the Commission, as this project involves new construction on a vacant lot.

BASIS FOR RECOMMENDATION

- The Project complies with the Planning Code and advances the policies of the General Plan and Mission Area Plan.
- The Project is in an appropriate in-fill development that will eliminate a nonconforming use to add eleven new dwelling units to the City's housing stock and 741 square feet of commercial retail space in an area that encourages maximum development in keeping with neighborhood character.
- The Project fully respects the character of the adjacent neighborhood commercial, mixed use and residential neighborhoods.
- The Project is supportive of the City's transit first policies by providing no off-street parking and the appropriate number of bicycle parking spaces.
- The Project will include one permanently affordable on-site two-bedroom dwelling unit.
- The Project will fully utilize the Eastern Neighborhoods Area Plan controls and will pay the appropriate development impact fees
- There are no exceptional or extraordinary circumstances that would necessitate Discretionary Review or modification of the project.

RECOMMENDATION:

Do not take DR and approve the project as proposed.

Attachments:

Revised 09/19/2017 Project Plans Public Communication

DV: G:\Documents\DRP\1900 Mission Street_2013.1330DRP\Draft Docs\1900 Mission Street_09-28 CPC Memo.doc

From: Milo Trauss
To: Vu. Doug (CPC)
Subject: 1900 Mission St.

Date: Wednesday, May 17, 2017 2:37:04 PM

Hello,

Please support this project and approve it for construction.

It will bring badly needed housing to San Francisco. The only way to make "market rate" housing not synonymous with "luxury" is to build more of it. Additionally this proposal includes BMR units.

Commissioner Melgar's comments regarding this project that "poor people don't do large windows" is absurd!!! Large windows are great, every building should have them, and every resident regardless of income should be able to enjoy them.

Also, please notify me when this item will appear once again before the Planning Commission.

Thank you, Milo

Milo Trauss milotrauss@gmail.com 215-370-1225 From: Gavin Hayes
To: <u>Vu. Doug (CPC)</u>
Subject: 1900 Mission

Date: Tuesday, April 11, 2017 11:14:33 AM

Let's build it! We need this project and many more like it.

Best,

Gavin Hayes

From: Theodore Randolph
To: Vu, Doug (CPC)

Subject: Approve 1900 Mission St with no further delay

Date: Thursday, April 13, 2017 2:06:29 AM

Dear Mr. Vu,

The proposal for 1900 Mission would be a valuable addition to the neighborhood. The 8 2-bedroom apartments can be rented by small families, and the 4 1-bedroom apartments would relieve a small part of the pressure on the rest of the housing stock in the neighborhood. In addition, I believe that its scale, proposed mass, and not-boring-box style are a good fit for the neighborhood, and an example of smart growth near transit.

Signed, Theodore From: D Dewsnup
To: Vu, Doug (CPC)

Cc: Richards, Dennis (CPC); richhillissf@yahoo.com; planning@rodneyfong.com; Johnson, Christine (CPC); Koppel,

Joel (CPC); Melgar, Myrna (CPC); Moore, Kathrin (CPC)

Subject: I support 1900 Mission

Date: Tuesday, April 11, 2017 11:33:43 AM

Doug Vu Planner

San Francisco Planning Department

Dear Mr. Vu,

Here is my letter of support for the 1900 Mission Project.

My pro-housing friends and I who live in the City support creating both new affordable housing units and marketrate apartments/condos near freeways and arterial public transit hubs in the City and County of San Francisco.

We need to urgently address the housing shortage. The 1900 Mission Project address the housing shortage effectively and efficiently and located very near a BART station.

San Francisco has chronically under built affordable housing and apartments over the last 40 years driving rent prices skyward.

It's meaningless to say San Francisco is a "Sanctuary City" if we don't make room for new immigrants who are forced to pay \$3,500 a month for a one bedroom apartment to live currently in most SF neighborhoods due to the housing constraints imposed by car-loving Nimby's.

We need to bring rents down immediately and effectively.

Working together we can all bring rents down by building more affordable housing units and new construction apartments/ condos. With new construction of housing units it eliminates the need to evict from existing housing stock, it adds both community and neighborhood benefits to existing and future residents.

Density brings generational sustainable healthy green living to our neighborhoods combating global climate change and rising sea levels.

http://seattlebubble.com/blog/2017/01/12/huge-2017-apartment-boom-soften-housing-market/

In 2017 with the regime change at the Whitehouse we expect an influx of people moving to SF to be protected from bullying and discrimination. To them and us, San Francisco is a beacon of hope where basic human rights are protected.

In addition, starting in 2017 20% of San Francisco's baby boomer population are eligible to retire that will have a direct effect on the job market here in the City of all industries across the whole employer spectrum. 160,000 jobs will be available over the next 5 years open to newcomers from across the country and the entire world.

Both SF and the Bay Area have room enough for this new influx of newcomers that will desire to become permanent residents.

We need to immediately plan for the organic population growth of our beloved city and region.

http://www.bizjournals.com/sanfrancisco/news/2017/01/12/retirement-crisis-baby-boomers-aging-workforce.html? ana=e_du_prem&s=article_du&ed=2017-01-12&u=32322357774f2b02b2291a9c69d205&t=1484293917&j=77059281

My pro-housing friends and I reaffirm and support SF Planning wholeheartedly the SF 2014 Housing Element; An element of THE GENERAL PLAN OF THE CITY AND COUNTY OF SAN FRANCISCO.

Objective #12: Balance housing growth with adequate infrastructure that serves the City's growing population.

POLICY 12.1: Encourage new housing that relies on transit use and *environmentally sustainable patterns of movement*.

POLICY 12.3 Ensure new housing is sustainably supported by the City's public infrastructure systems.

Objective 13 Prioritize sustainable development in planning for and constructing new housing.

POLICY 13.1 Support "smart" regional growth that locates new housing close to jobs and transit. POLICY 13.3 Promote sustainable land use patterns that integrate housing with transportation in order to increase transit, pedestrian, and bicycle mode share.

Objective 1 Identify and make available for development adequate sites to meet the City's housing needs, especially permanently affordable housing.

POLICY 1.10 Support new housing projects, especially affordable housing, where households can easily rely on public transportation, walking and bicycling for the majority of daily trips.

Objective 4 Foster a housing stock that meets the needs of all residents across all life cycles.

POLICY 4.6 Encourage an equitable distribution of growth according to infrastructure and site capacity.

Issue 5: Remove Constraints to the Construction and Rehabilitation of Housing

Objective 10 Ensure a streamlined, yet thorough, and transparent decision-making process.

POLICY 10.2 Implement planning process improvements to both reduce undue project delays and provide clear information to support community review.

POLICY 10.3 Use best practices to reduce excessive time or redundancy in local application of CEQA.

POLICY 10.4 Support state legislation and programs that promote environmentally favorable projects.

I encourage the SF Planning Department and staff continue to adhere to the spirit and agreed upon SF 2014 Housing Element; An element of THE GENERAL PLAN OF THE CITY AND COUNTY OF SAN FRANCISCO, The 1900 Mission Project complies with on every level of planning code.

My pro-housing friends and I believe that San Francisco has always been, and should continue to be, an innovative and forward-looking city of immigrants from around the U.S. and the world. San Francisco is not full, and the Bay Area is definitely not full. It long has been a San Francisco traditional value since the early days of California of an inclusive vision of welcoming all new and potential residents. Anyone who desires to live in the City and the Bay Area should be able to not only afford housing but have a clear unobstructed path becoming a permanent resident of our local neighborhoods and community continuing urban core livability for future generations as older generations pass on from this life.

1900 Mission effectively fights climate change through density and adds community and neighborhood benefits to not only it's residents but also it's neighbors and visitors to the Mission.

1900 Mission is architecturally solid in design and structurally sound.

Please no more delays.

Sincerely,

Donald J. Dewsnup

SF Pro Housing Activist

From: Martin Bourqui
To: <u>Vu, Doug (CPC)</u>

Subject: In support of 1900 Mission Street

Date: Thursday, April 13, 2017 4:32:57 PM

Hi there,

I'd like to write a brief note in support of the 1900 Mission Street development. The SF Housing Action Coalition report card (http://www.sfhac.org/wp-content/uploads/2015/07/1900_Mission_Report_Card-.pdf) says it all better than I could, and we desperately need more housing in our housing-starved city. I hope you'll support this project.

Thanks, Martin From: John kim
To: <u>Vu, Doug (CPC)</u>

Subject: in support of 1900 Mission

Date: Tuesday, April 11, 2017 1:23:04 PM

Hi Mr. Vu

I am writing in support of 1900 Mission project. I think it would be great to have a residential area in place of an auto repair shop. I think by increasing the residential density of the area, it would bring improvement in the flow of people and a reduction in crime that has been apparent in the neighborhood. The design is appealing and I don't mind the amount of glass as I am sure it can be covered by drapes / shades to accomodate some of the comments of the neighbors. I live along South Van Ness and do feel that more buildings with residents in the area can provide additional source of comfort that the neighborhood may be safer as we have kids and the increased population will contribute to the tax base that can help with the local Marshall elementary school. Thanks for considering 1900 Mission Street

John Kim


johnvpkim@gmail.com

1900 MISSION STREET SAN FRANCISCO, CA 94103

APPLICABLE CODES

All construction, regard of details on plans, shall comply with:

- 1. 2013 California Building Code
- 2. 2013 California Plumbing Code
- 3. 2013 California Mechanical Code
- 4. 2013 California Electrical Code
- 5. 2013 California Building Energy Code
- 6. 2013 California Fire Code
- 7. 2013 Calfornia Green Building Standards

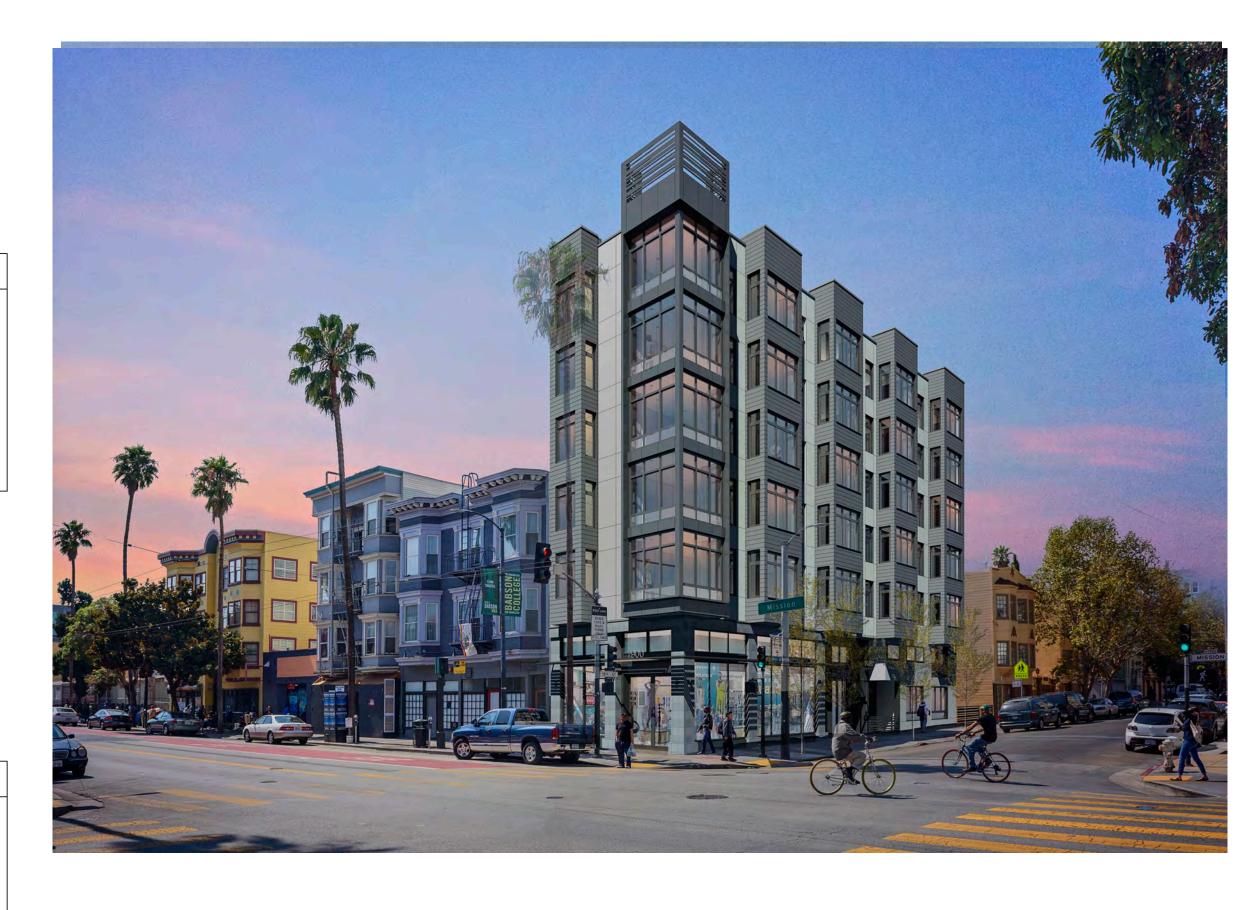

SCOPE OF WORK

New Construction of a 7 story multifamily residential building with ground floor retail, which entails:

- 1. Excavation for basement w/18 bike parking spots, unit storage, mechanical/electrical rooms, & lower level of ground floor unit (1A)
- 2. (1) Lobby
- 3. (1) Nine stop elevator and 2 fire stairwells
- 4. (1) Retail space with Mezzanine Level and (1) unisex accessible
- 5. (11) residential dwelling units: (11) two bedrooms, (1) laundry hook up per unit and (21) dwelling unit bathrooms
- 6. Roof deck with common and private areas
- Solar panel system on roof
- 8. HVAC System
- 9. Podium constuction w/6 stories of stick framing

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1684		1900		
	WIESE		CAPP ST	
SPARROW ST	WIESE ST	MISSION ST		ADAIR ST
450		1972	8	478
		BART-	2950 16TH ST	2900
N 3080		3004 16th Street Mission	16TH S1	50

SHEET INDEX

ARCHITECTURAL

A-0.00	COVER SHEET		
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SQUARE FOOTAGE ANALYSIS

BASEMENT, 1ST & MEZZANINE FLOOR EXITING PLANS

2ND-5TH, 6TH, 7TH FLOOR EXITING PLANS

SITE PLAN - EXISTING

SITE PLAN - PROPOSED

BASEMENT.1ST FLOOR PLANS A-1.02 MEZZANINE - 5TH FLOOR PLANS

6TH & 7TH FLOOR PLANS A-1.03

ROOF PLAN A-1.04

EAST & NORTH BUILDING ELEVATIONS

SOUTH & WEST BUILDING ELEVATIONS A-2.02

LONGITUDINAL BUILDING SECTION A-3.01

LONGITUDINAL BUILDING SECTION A-3.02

& E-W STAIRWAY SECTION

LATITUDINAL BUILDING SECTIONS A-3.03

MATERIAL BOARD (1) A-4.01 MATERIAL BOARD (2) A-4.02

STOREFRONT AND TYPICAL WINDOW SECTIONS

3D MODEL VIEW FROM INTERSECTION OF 15TH ST AND MISSION ST A-4.04

3D MODEL VIEW FROM SOUTH TO NORTH ON MISSION ST A-4.05

A-4.06 3D MODEL VIEW FROM WEST TO EAST ON 15TH STREET

LAND SURVEYOR

LS-1 **COVER SHEET**

LS-2 **EXISTING SITE SURVEY**

STRUCTURAL

GENERAL NOTES S-1.01

GENERAL NOTES CONT. S-1.01A S-2.00 LEVEL B1 FOUNDATION PLAN

LEVEL 1 FRAMING PLAN S-2.01

LEVEL 1 MEZZANINE FRAMING PLAN S-2.02

LEVEL 6 FRAMING PLAN

LEVEL 2 FRAMING PLAN S-2.03

S-2.04 LEVEL 3 FRAMING PLAN

S-2.05 LEVEL 4 FRAMING PLAN

LEVEL 5 FRAMING PLAN S-2.06

S-2.08 LEVEL 7 ROOF FRAMING PLAN

S-2.09 LEVEL 8 PENTHOUSE ROOF FRAMING PLAN

S-3.01 **BUILDING SECTION**

S-4.01 FOUNDATION DETAILS

TYPICAL CONCRETE PILE DETAILS S-4.02

PROJECT DIRECTORY

ARCHITECTURAL

S-2.07

KEVIN STEPHENS DESIGN GROUP 400 TREAT AVE SUITE I SAN FRANCISCO, CA 94110 KEVIN STEPHENS | P: 415-509-5661 kstephens@kevinstephensdesign.com

OWNER PRC SERIES 2, LLC 1730 SOLANO AVE BERKELEY, CA 94706

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STRUCTURAL NISHKIAN MENNINGER 600 HARRISON ST #110 SAN FRANCISCO, CA 94107 NATHAN MCBRIDE | P: 406-586-2739

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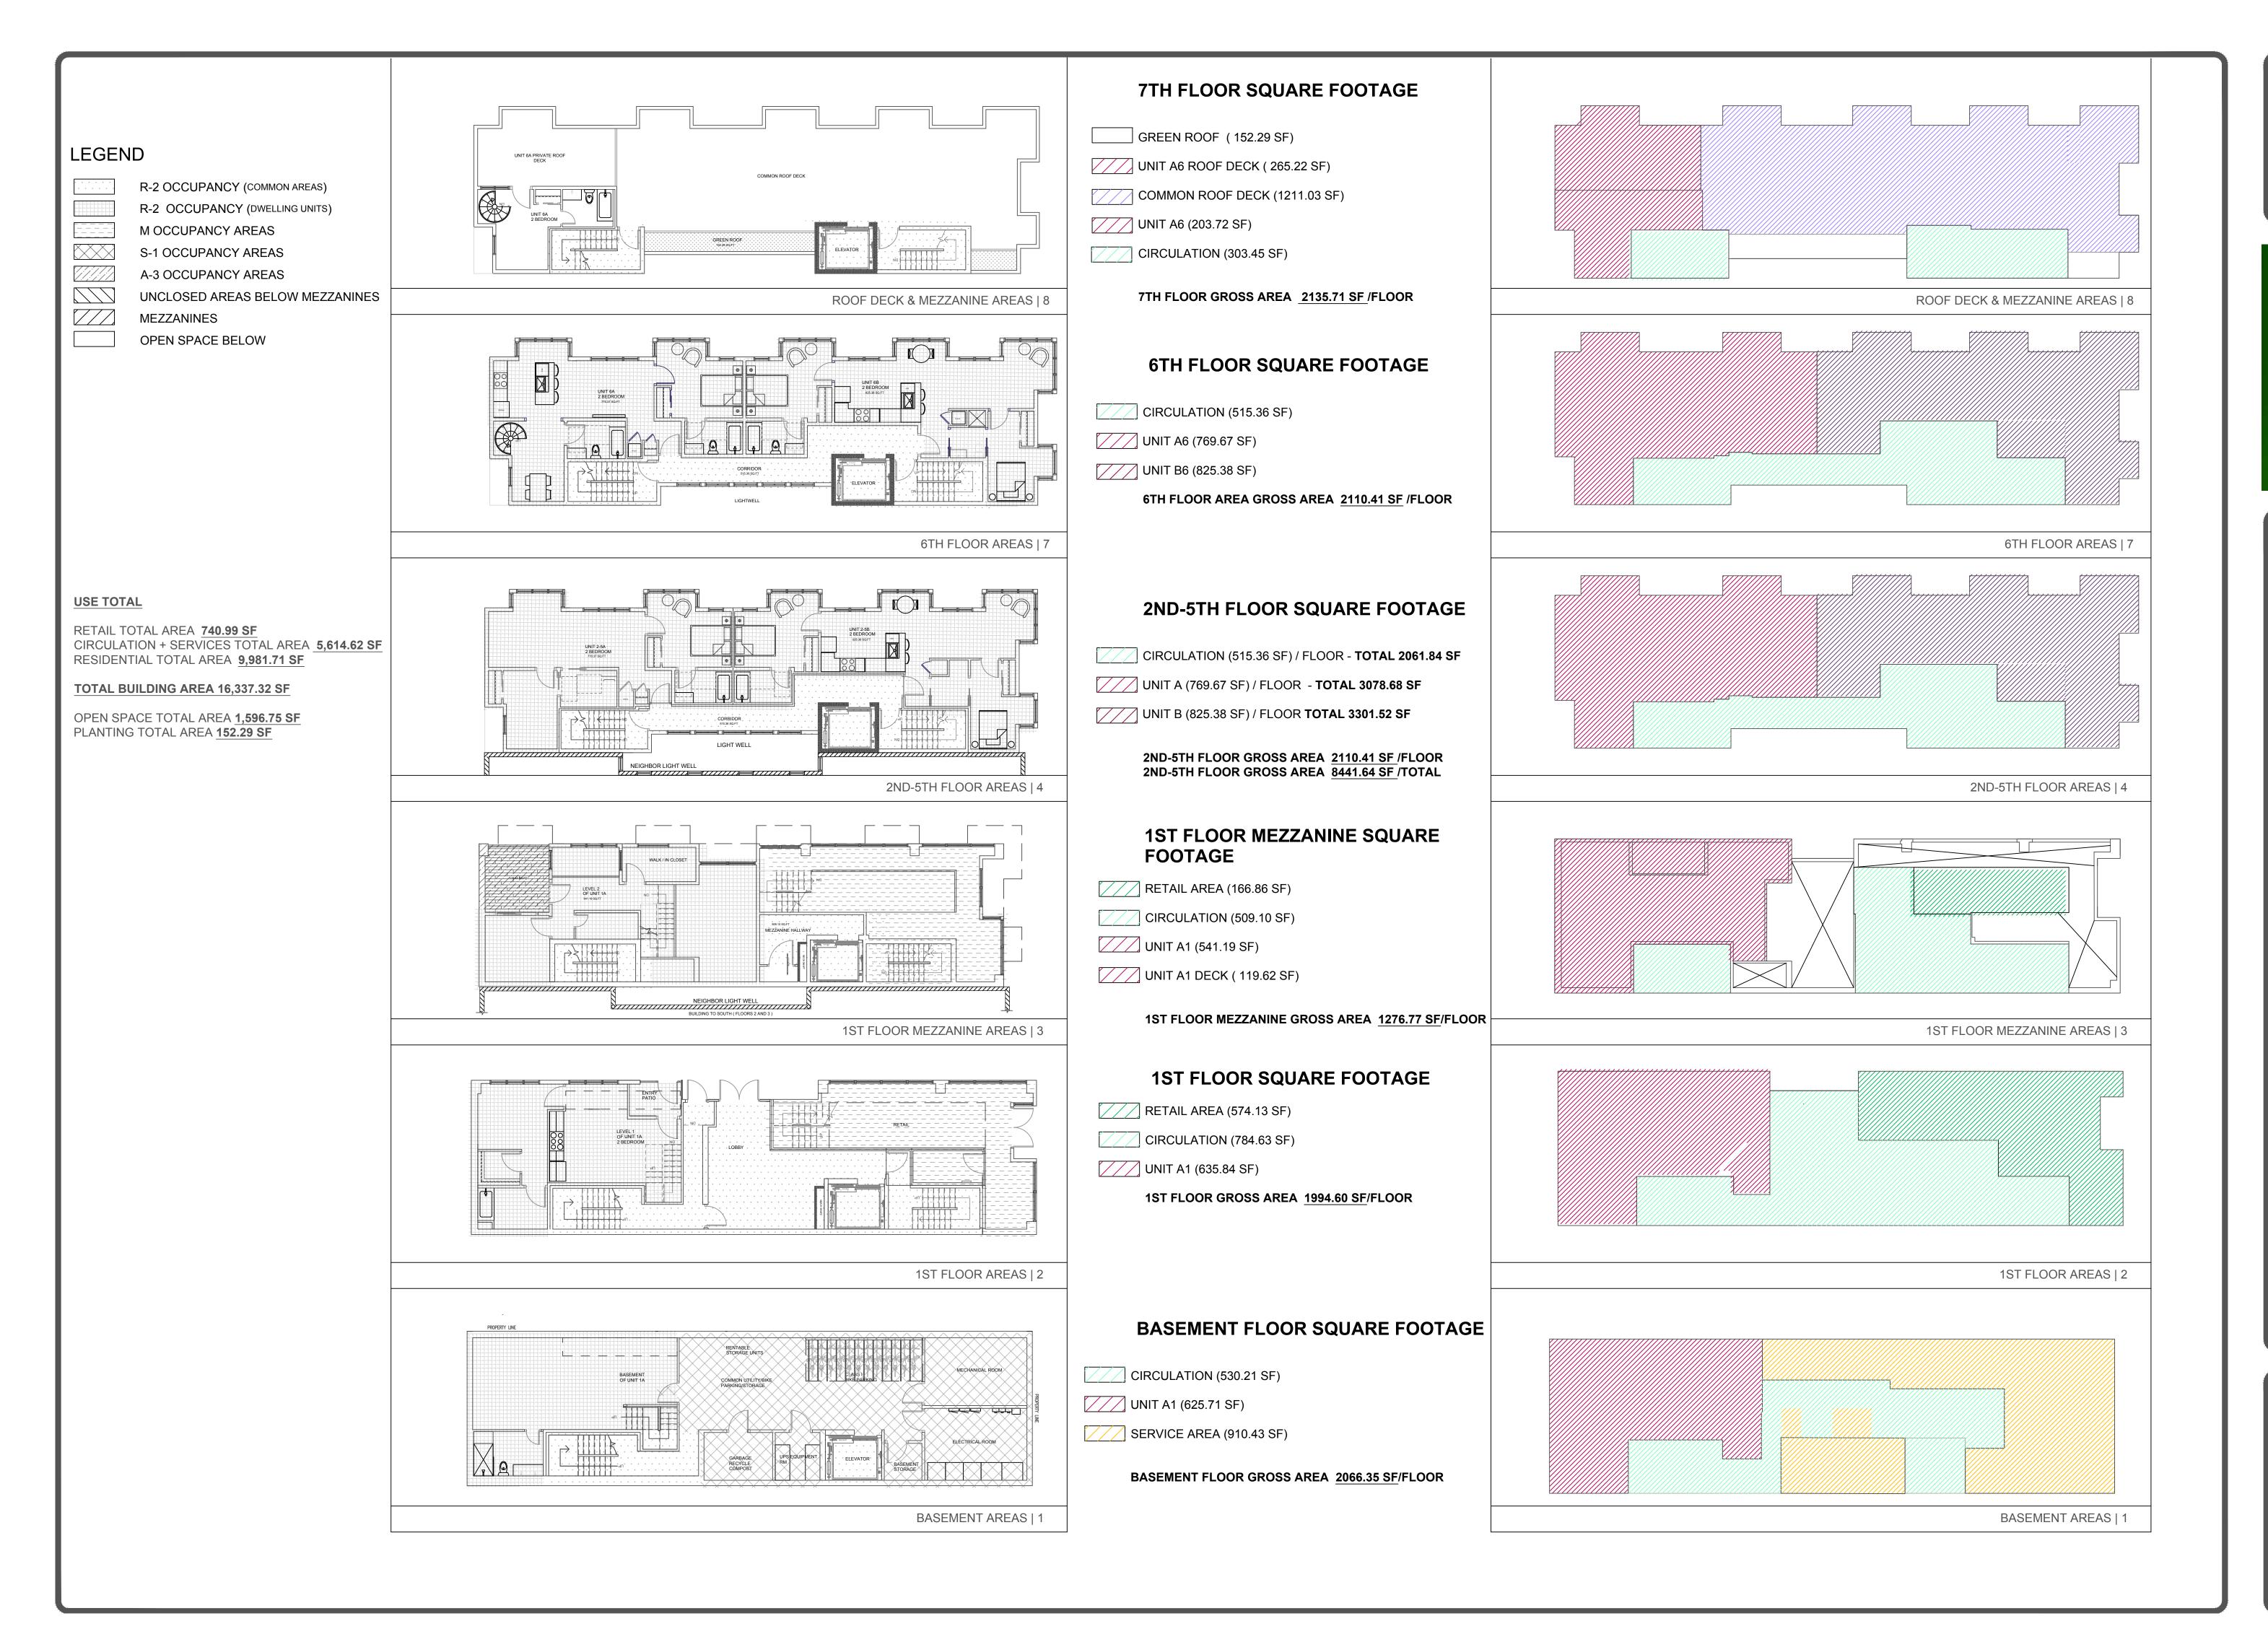
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BUILDING DATA Podium: Type IA / IIIB 1. Type of Construction: 7 + Basement + Retail Mezzanine 2. Number of Floors: 3. Lot Size: 2,064 sq ft 3554 / 001 4. Parcel Number: R-2 / M / S-1 / A-3 5. Occupancy Group: 74'-11" (81'-6" T.O. Elevator) 6. Building Height:



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1900 MISSION ST, SAN FRANCISCO

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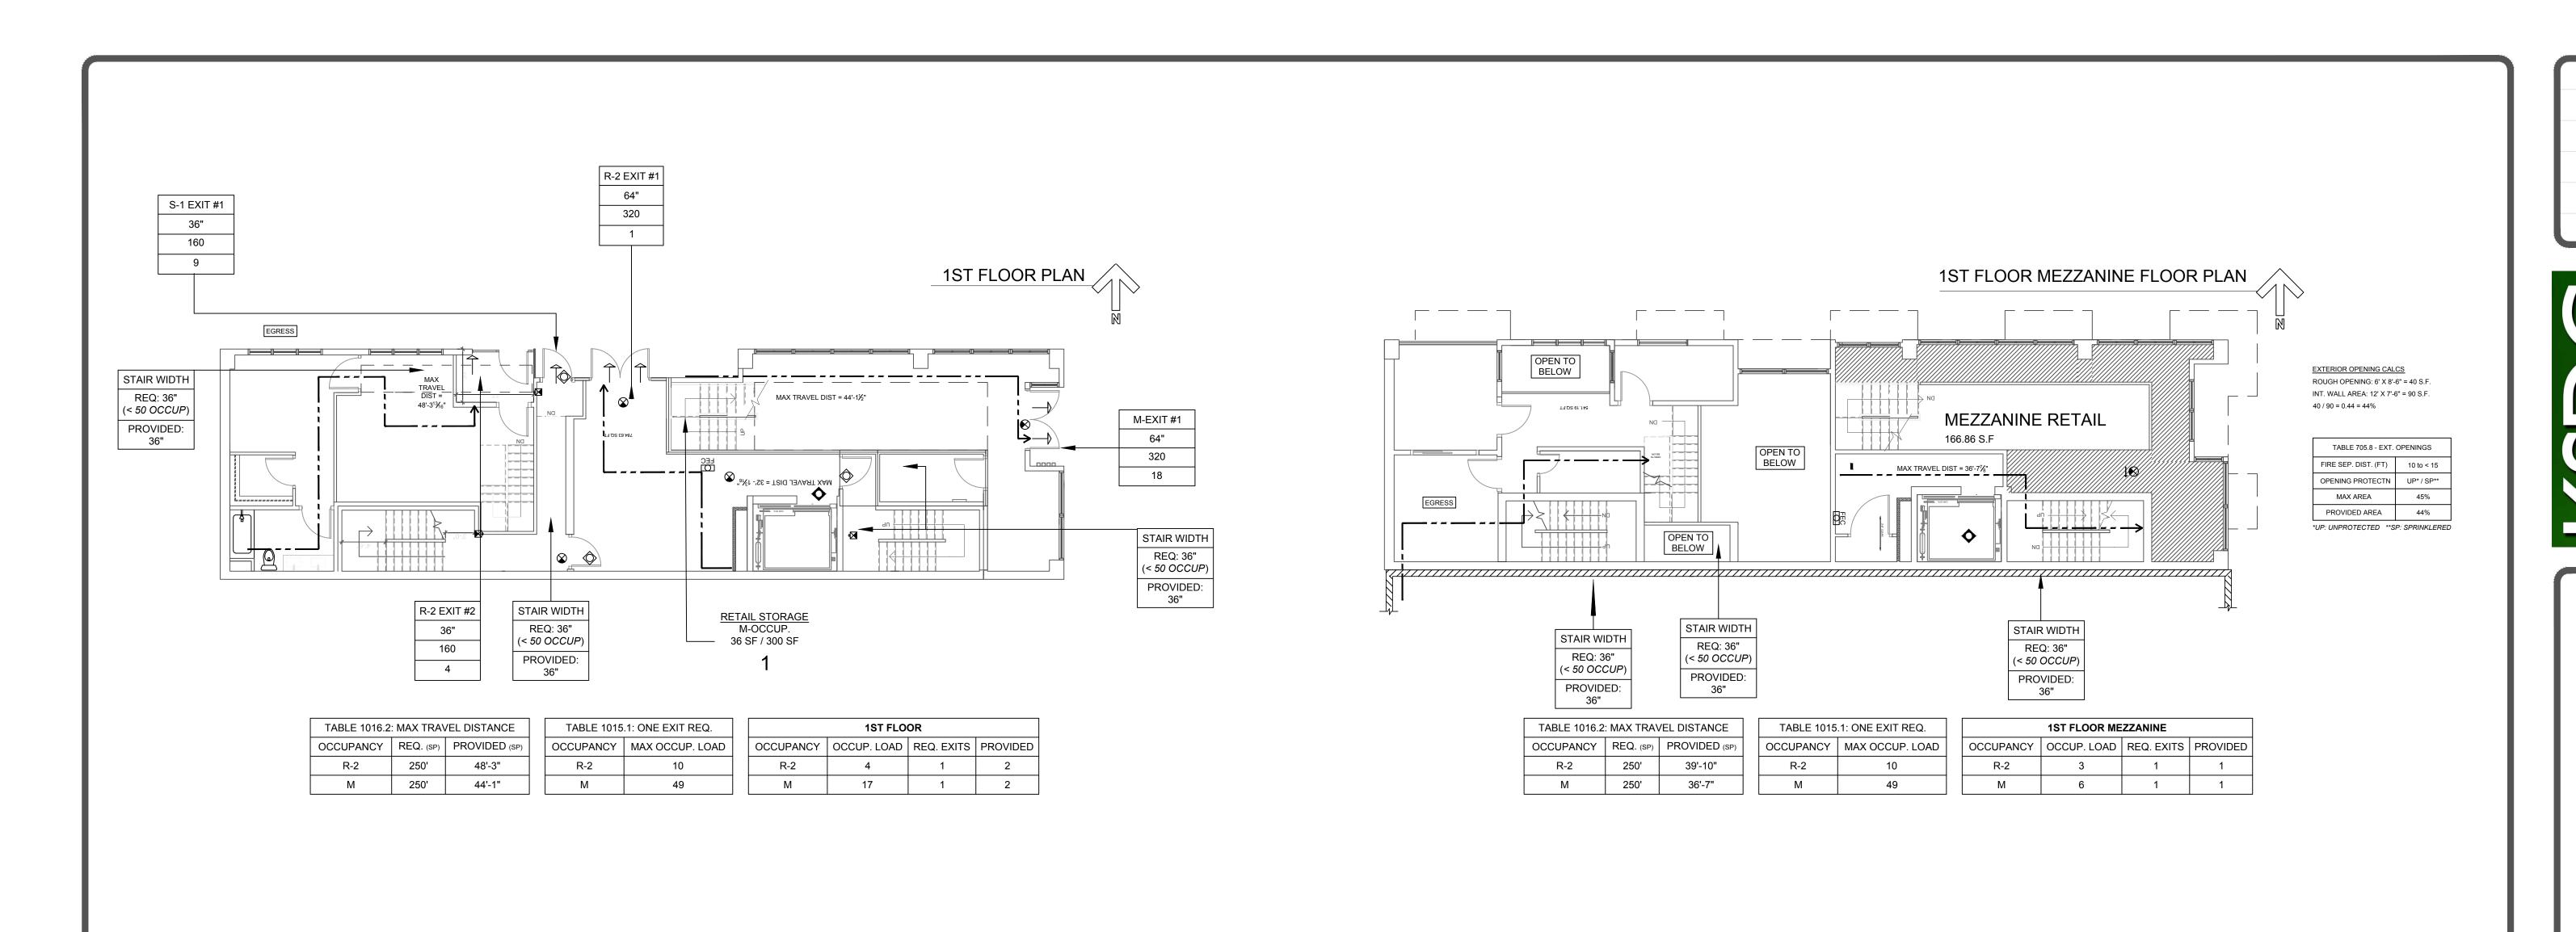
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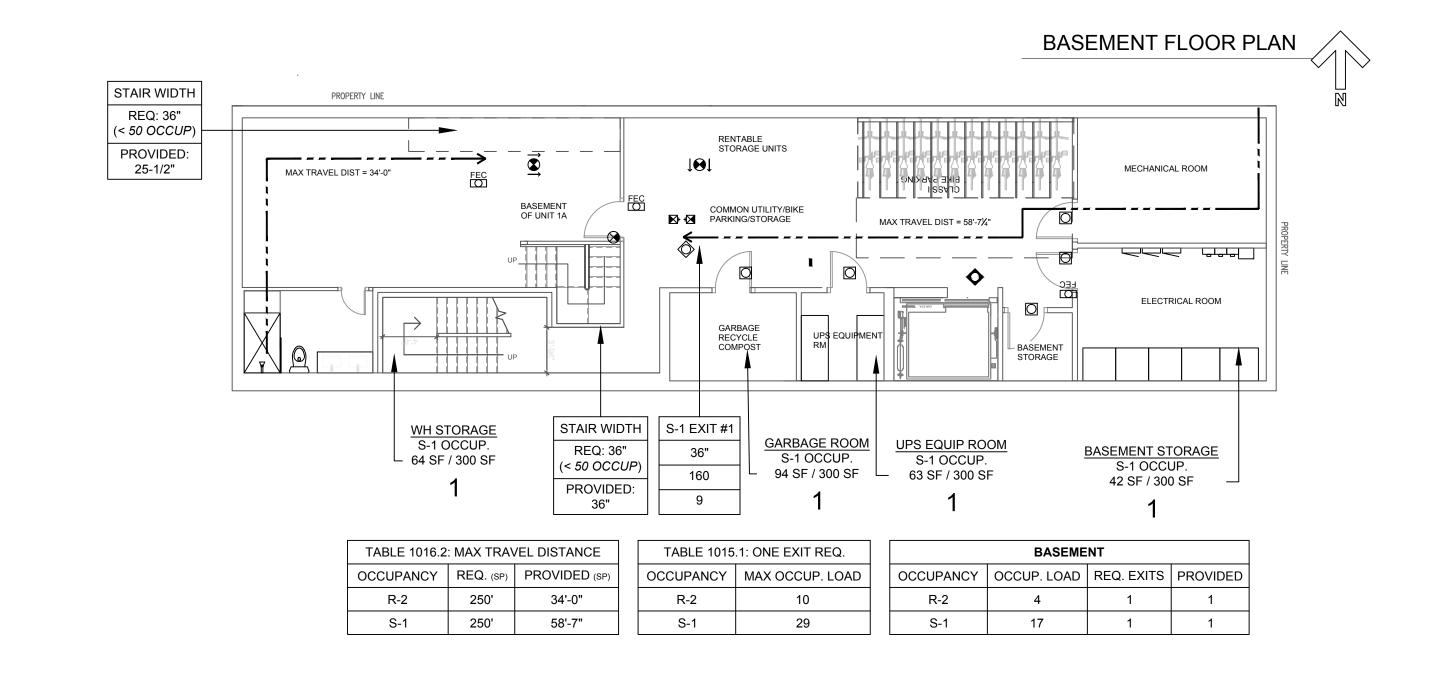
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EXIT PLAN LEGEND

OCCUPANT LOAD

ONLY.

36 SF / 300 SF — FLOOR AREA / OCCUP. PER S.F.

—— EMERGENCY EGRESS &

RESCUE OPENING AT SLEEPING ROOMS BELOW THE 4TH FLOOR

— FIRE EXTINGUISHER CABINET

DWELLING UNIT. MAX 48" A.F.F.

WITHIN 75 FT OF EACH

EXIT ACCESS

EXIT NUMBER

DOOR CAPACITY

ACTUAL USE

DOOR CLEAR WIDTH

STORAGE —— ROOM NAME

M-OCCUP. — OCCUPANCY

EGRESS ·

EXIT #1

32"

160

XX

EXIT SIGN - ILLUMINATED CLG MT, 2 SIDED DIRECT.

EXIT SIGN - ILLUWINALES
CLG MT, 1 SIDED DIRECT.
ARROW OPT. 7' A.F.F

FLOOR LEVEL EXIT SIGN-SELF-LUMINOUS, WALL MT

OPENING PROTECTIVE SYMBOLS

INDICATE FIRE RATING ASSEMB.

SELF-CLOSING 45 MIN RATED DOOR

SELF-CLOSING

AUTO CLOSING 90 MIN RATED DOOR

90 MIN RATED DOOR

THE FOLLOWING SYMBOLS

OPENG'S W/O SYMBOLS ARE

NOT REQ. TO BE PROTECTED. SELF-CLOSING SELF-CLOSII.C 20 MIN RATED DOOR

ARROW OPT. 7' A.F.F

EXIT SIGN - ILLUMINATED





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EXIT PLAN LEGEND

1 — OCCUPANT LOAD

EGRESS — EMERGENCY EGRESS &

ONLY.

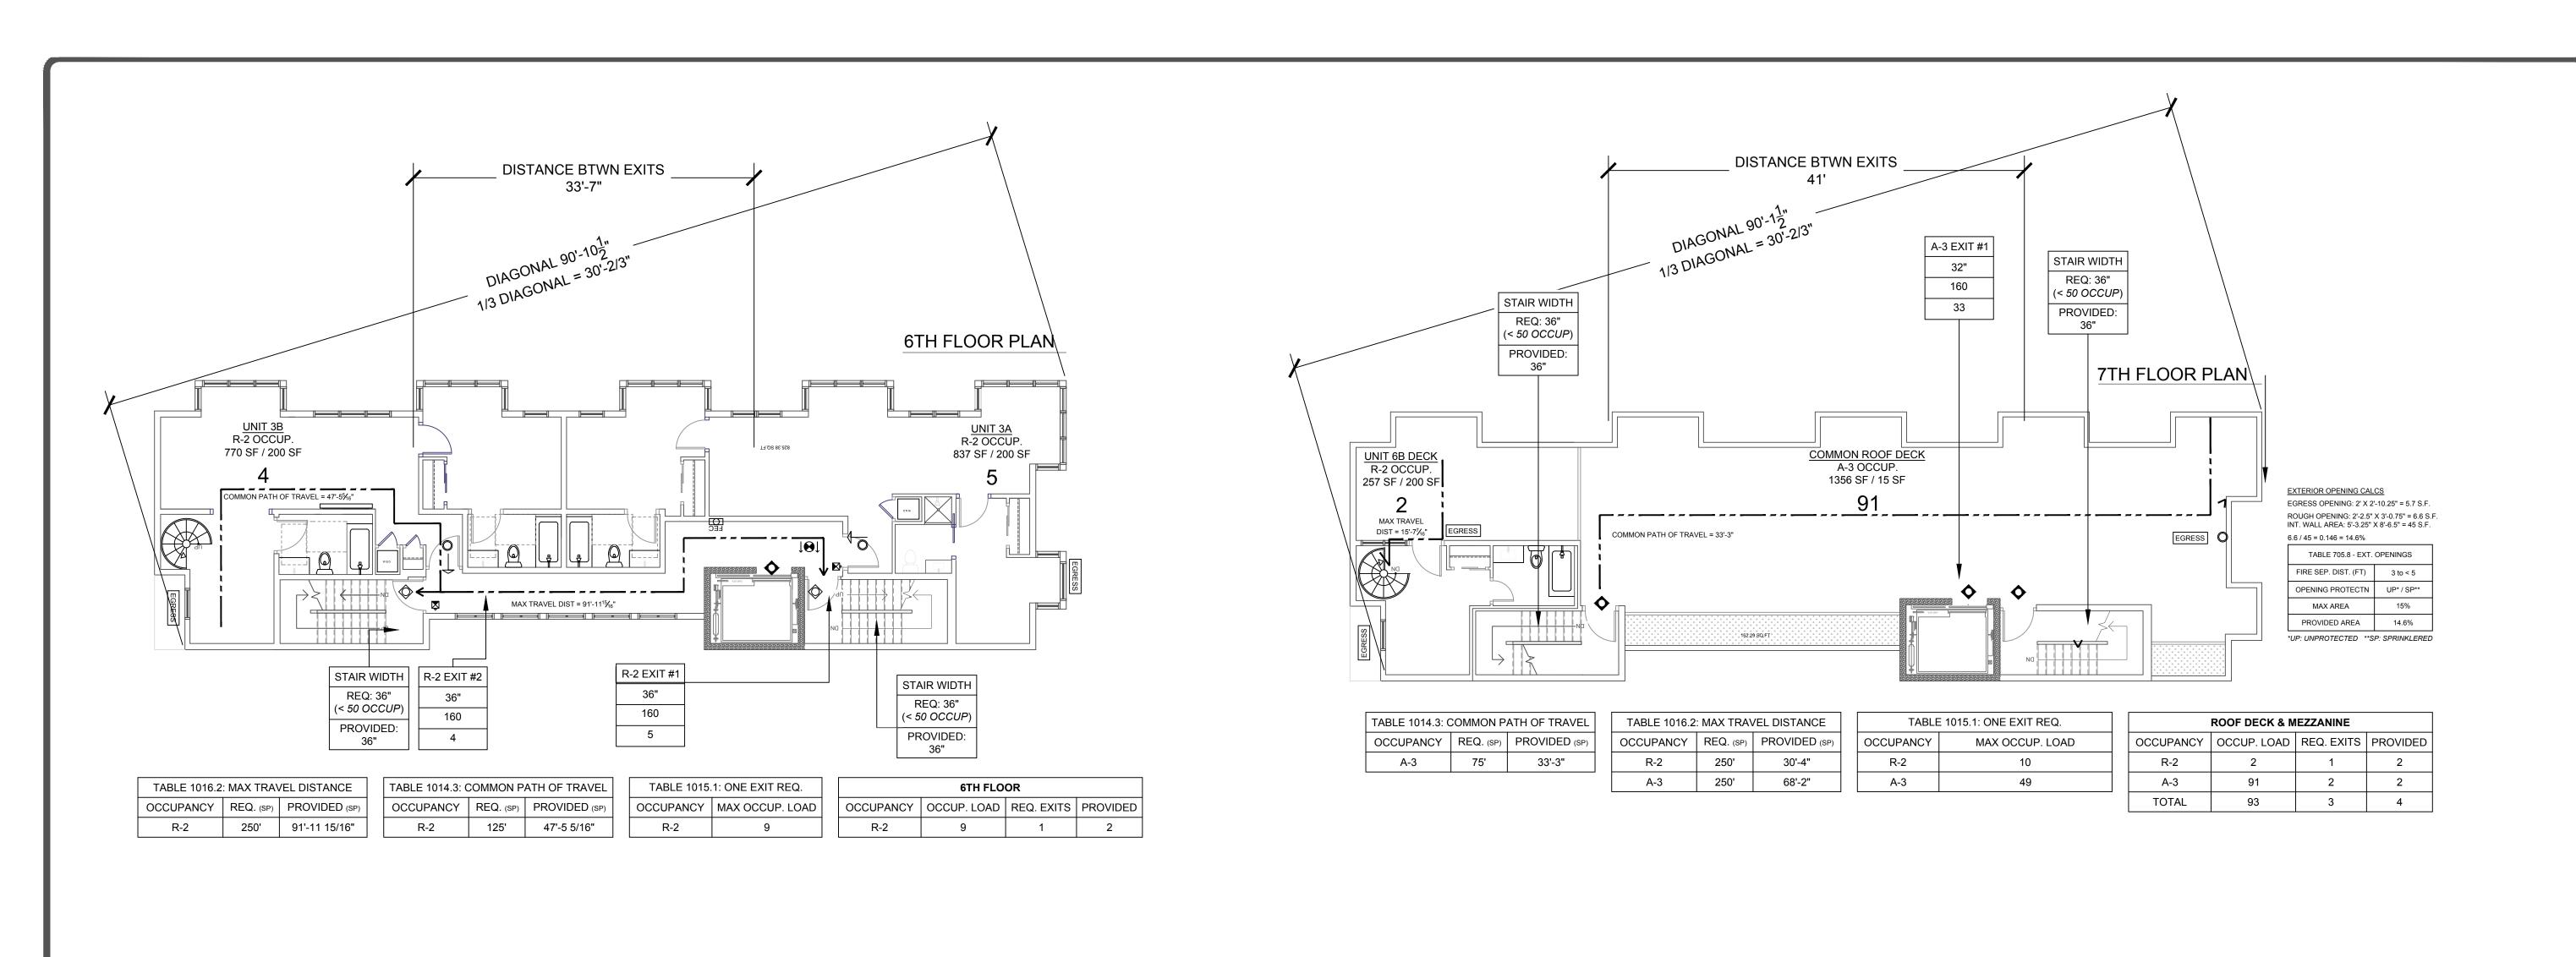36 SF / 300 SF — FLOOR AREA / OCCUP. PER S.F.

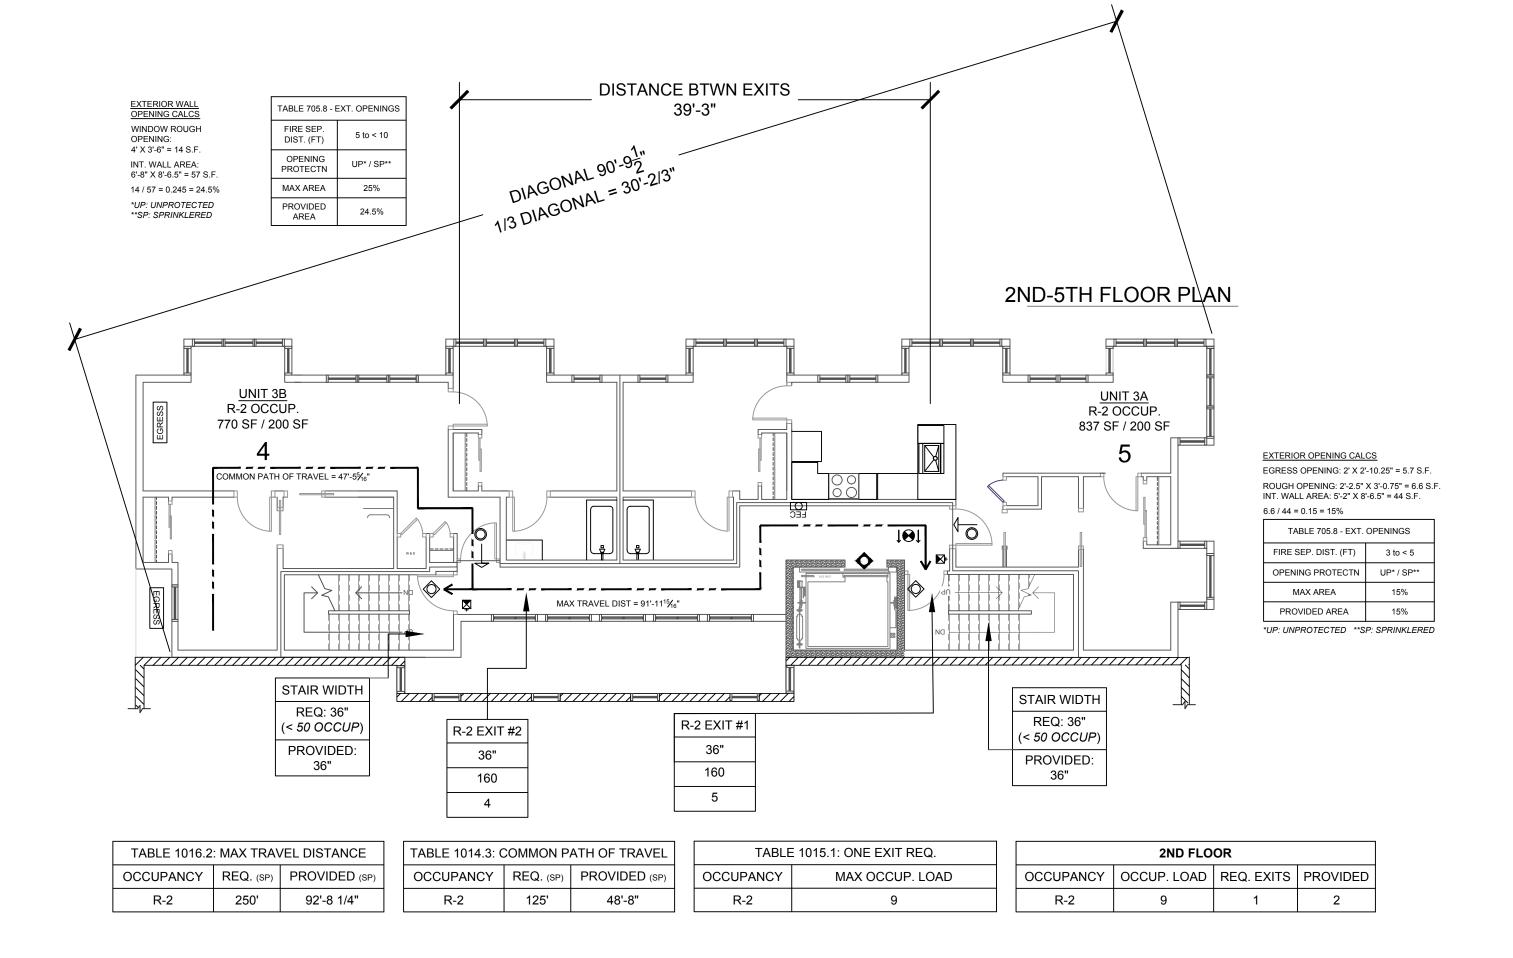EXIT ACCESS

EXIT NUMBER

DOOR CAPACITY

ACTUAL USE

DOOR CLEAR WIDTH

RESCUE OPENING AT SLEEPING ROOMS BELOW THE 4TH FLOOR

DWELLING UNIT. MAX 48" A.F.F.

—— FIRE EXTINGUISHER CABINET

WITHIN 75 FT OF EACH

STORAGE —— ROOM NAME M-OCCUP. —— OCCUPANCY

EXIT #1

32"

160

XX

EXIT SIGN - ILLUMINATED
CLG MT, 2 SIDED DIRECT.

EXIT SIGN - ILLUMINATED

CLG MT, 1 SIDED DIRECT.

ARROW OPT 7' A F.F.

+ FLOOR LEVEL EXIT SIGN-SELF-LUMINOUS, WALL MT

OPENING PROTECTIVE SYMBOLS

INDICATE FIRE RATING ASSEMB.

THE FOLLOWING SYMBOLS

OPENG'S W/O SYMBOLS ARE

NOT REQ. TO BE PROTECTED. SELF-CLOSING

O SELF-GLOGING 20 MIN RATED DOOR

SELF-CLOSING 45 MIN RATED DOOR

SELF-CLOSING

AUTO CLOSING 90 MIN RATED DOOR

90 MIN RATED DOOR

ARROW OPT. 7' A.F.F

ARROW OPT. 7' A.F.F

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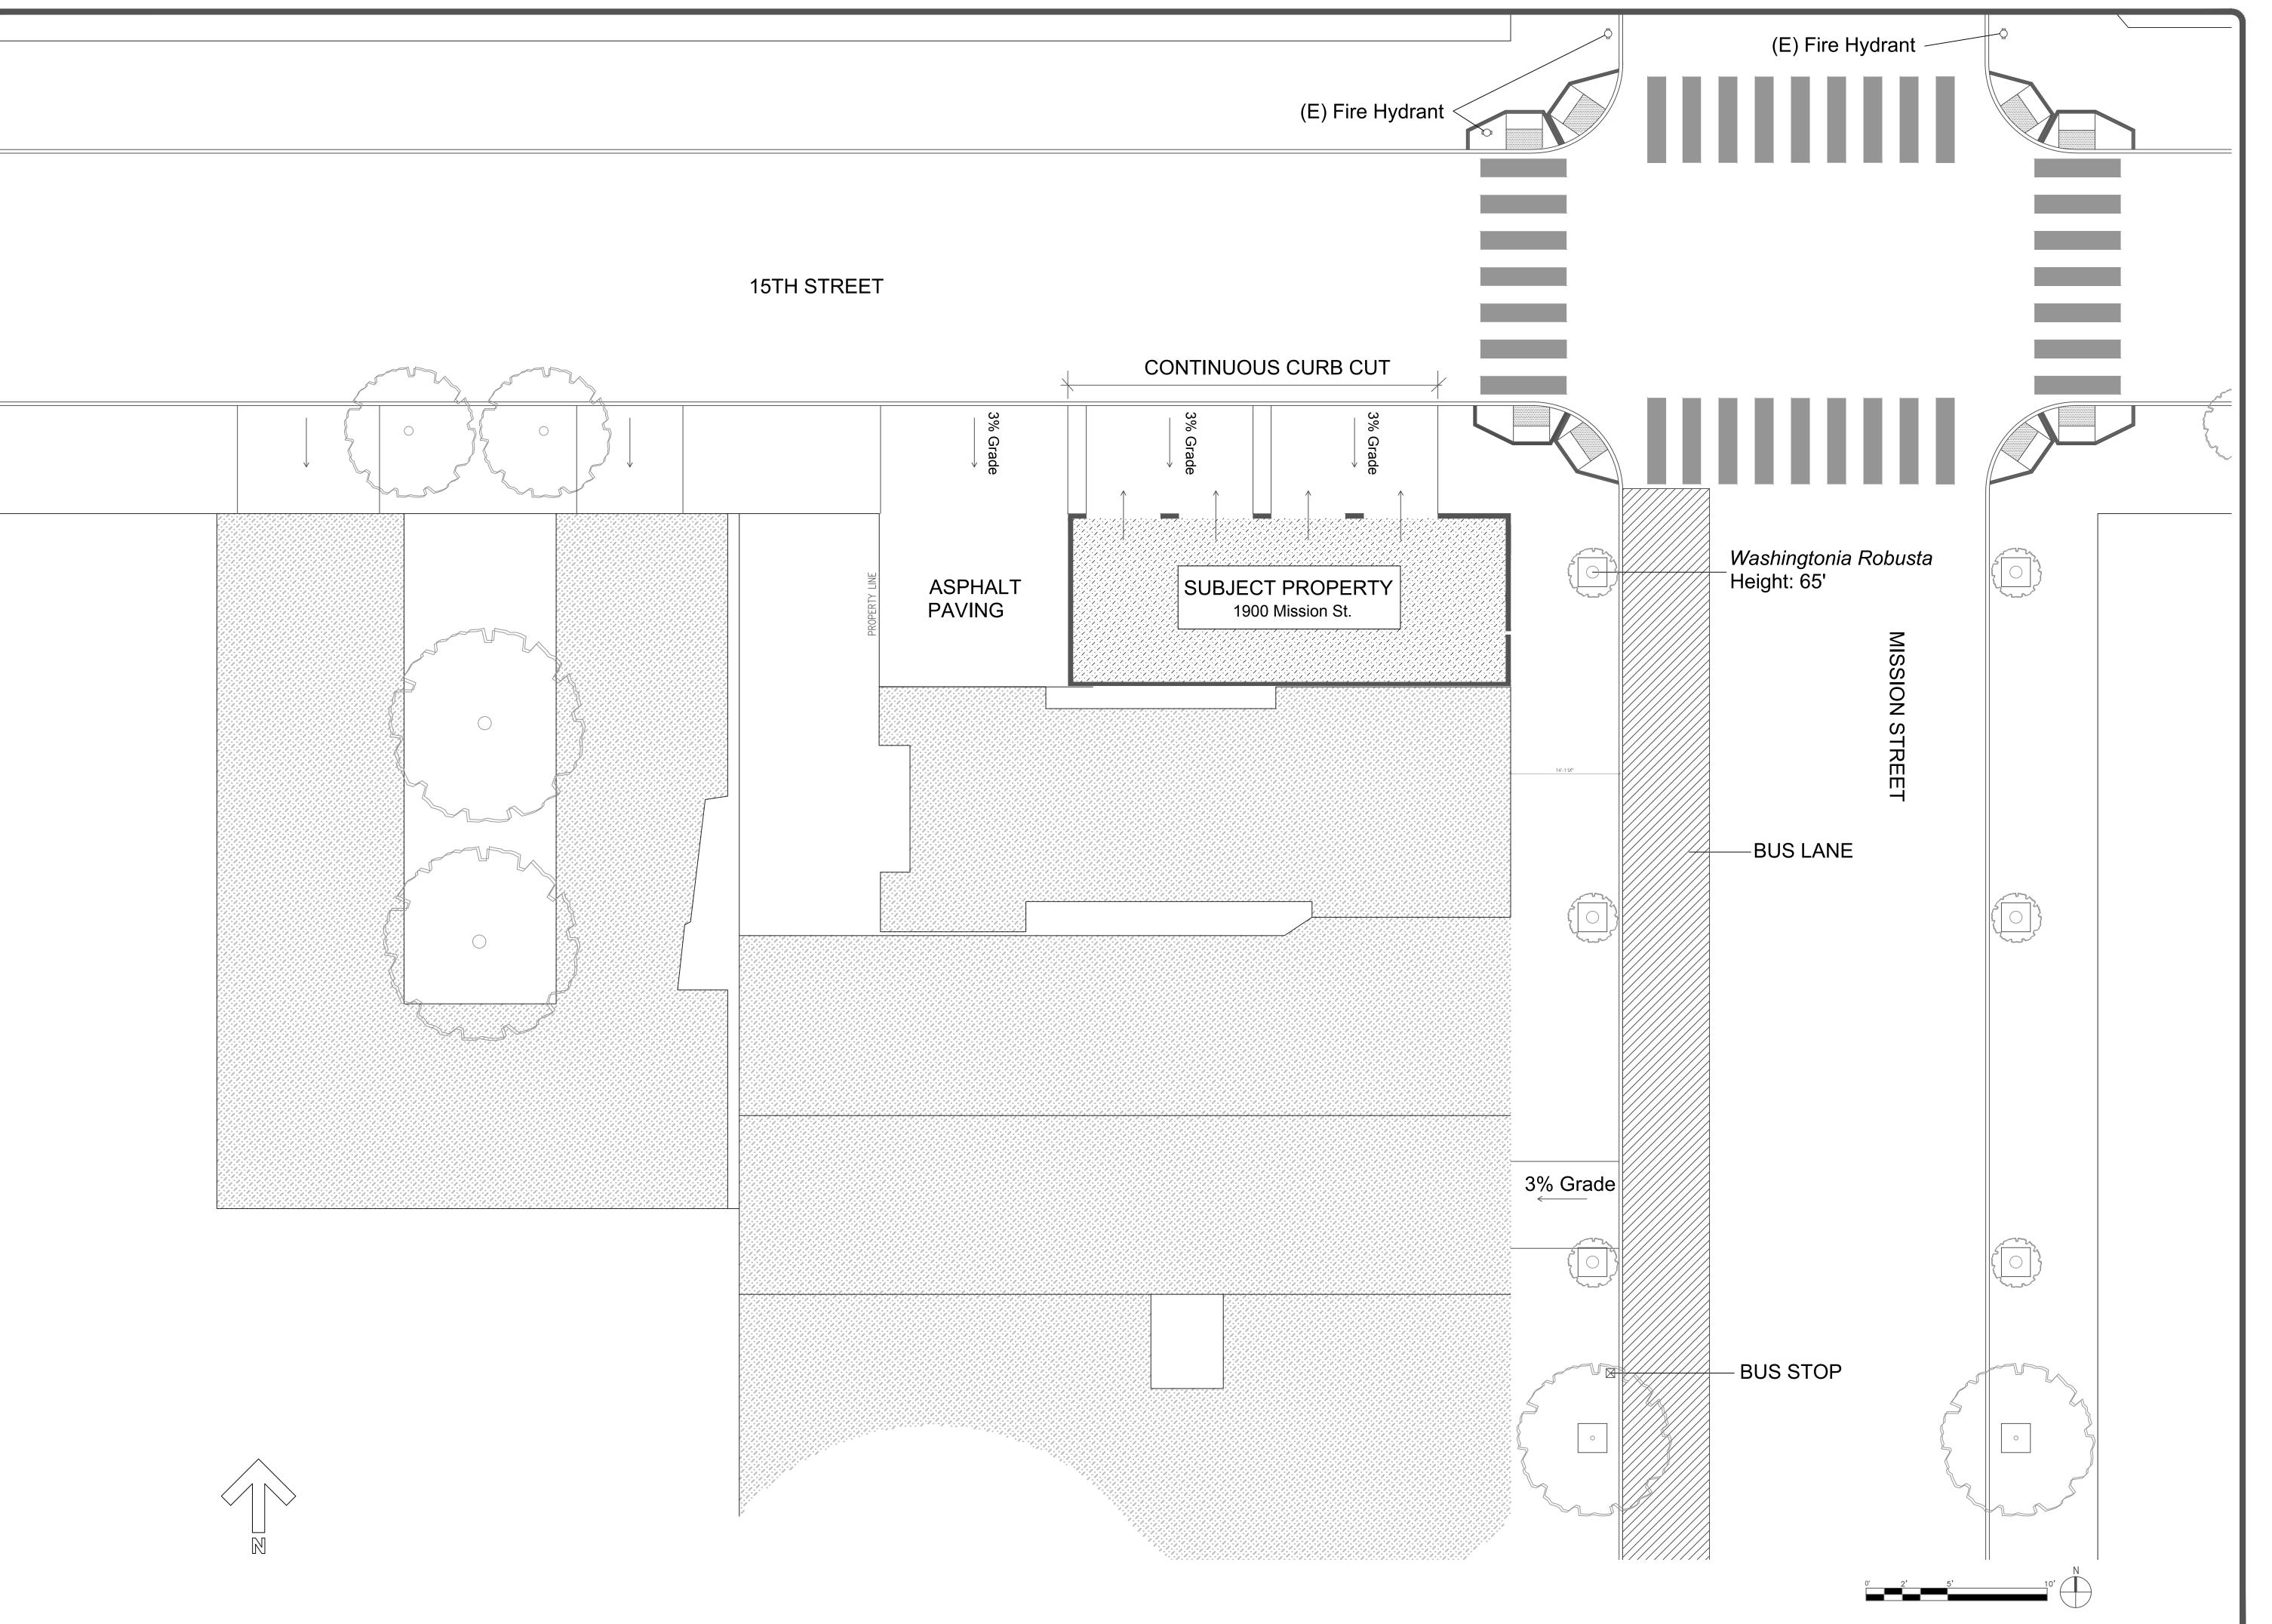



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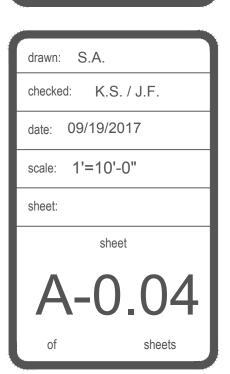
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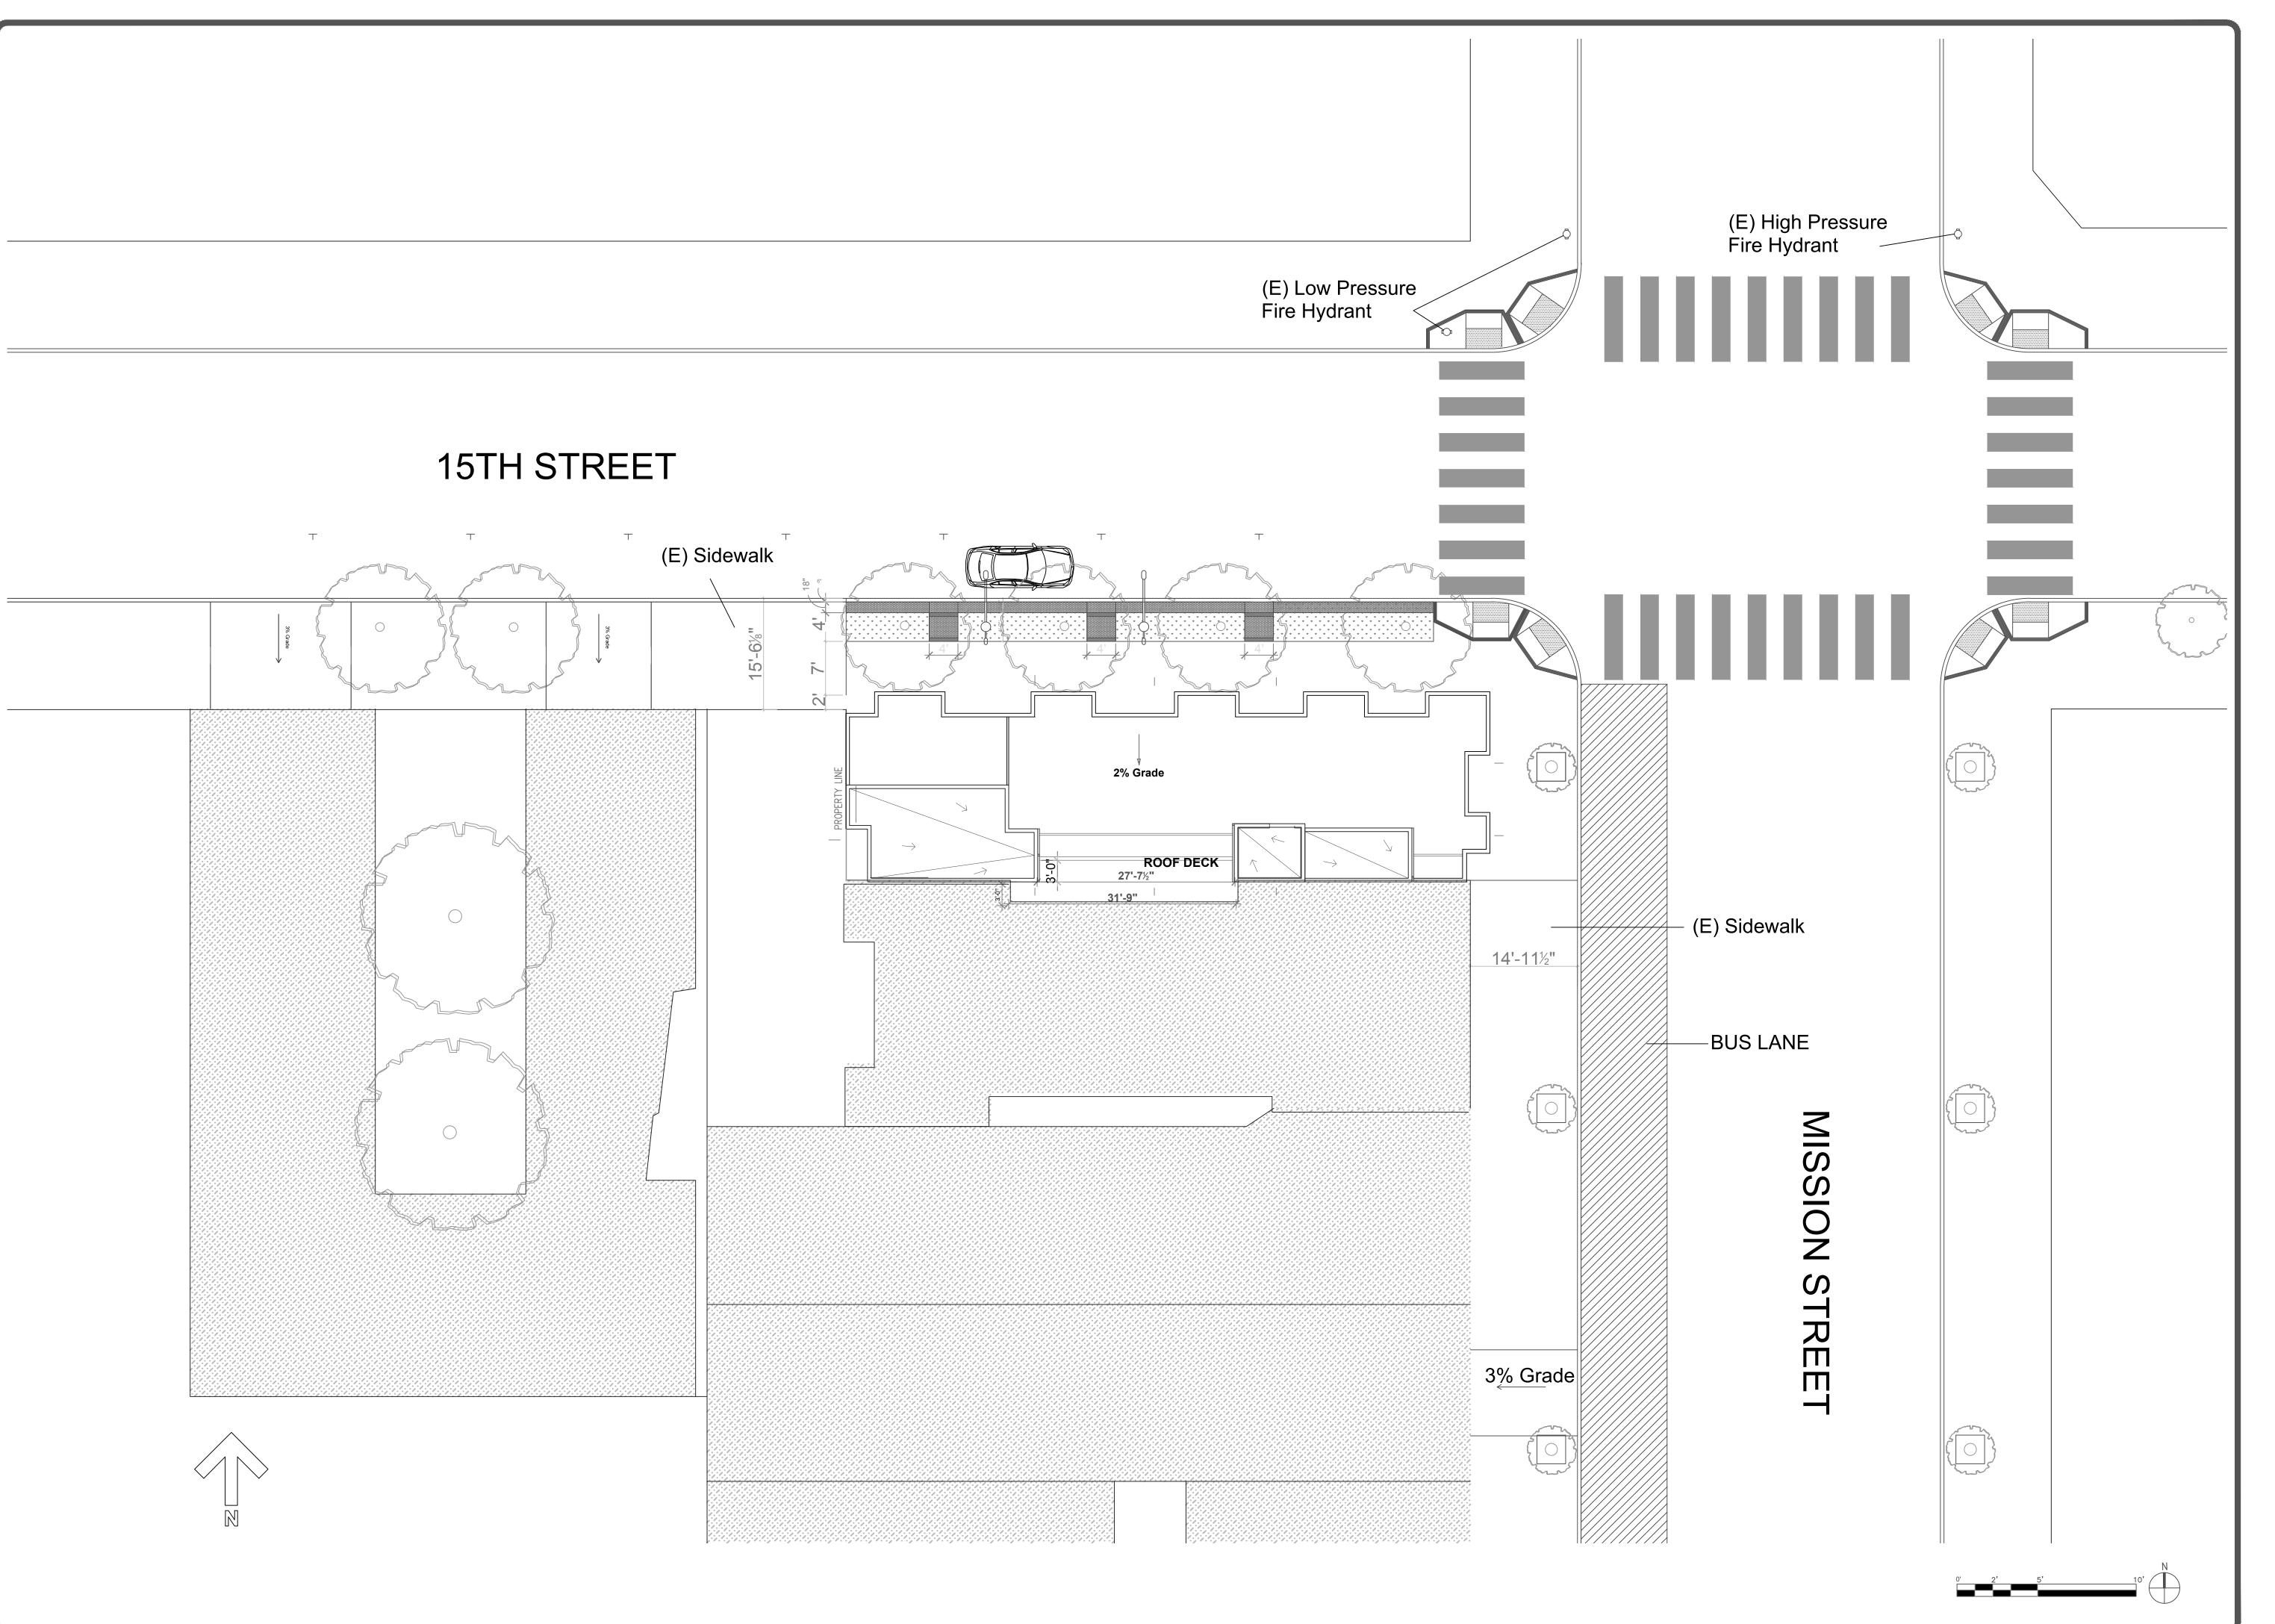







1900 MISSION ST, SAN FRANCISCO, C. SITE PLAN - EXISTING



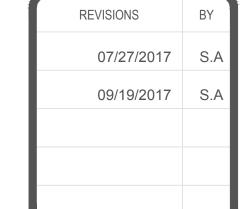

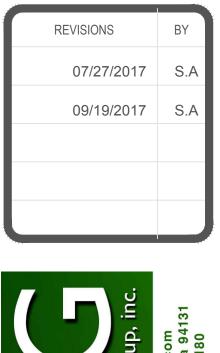



1900 MISSION ST, SAN FRANCISCO, C SITE PLAN - PROPOSED

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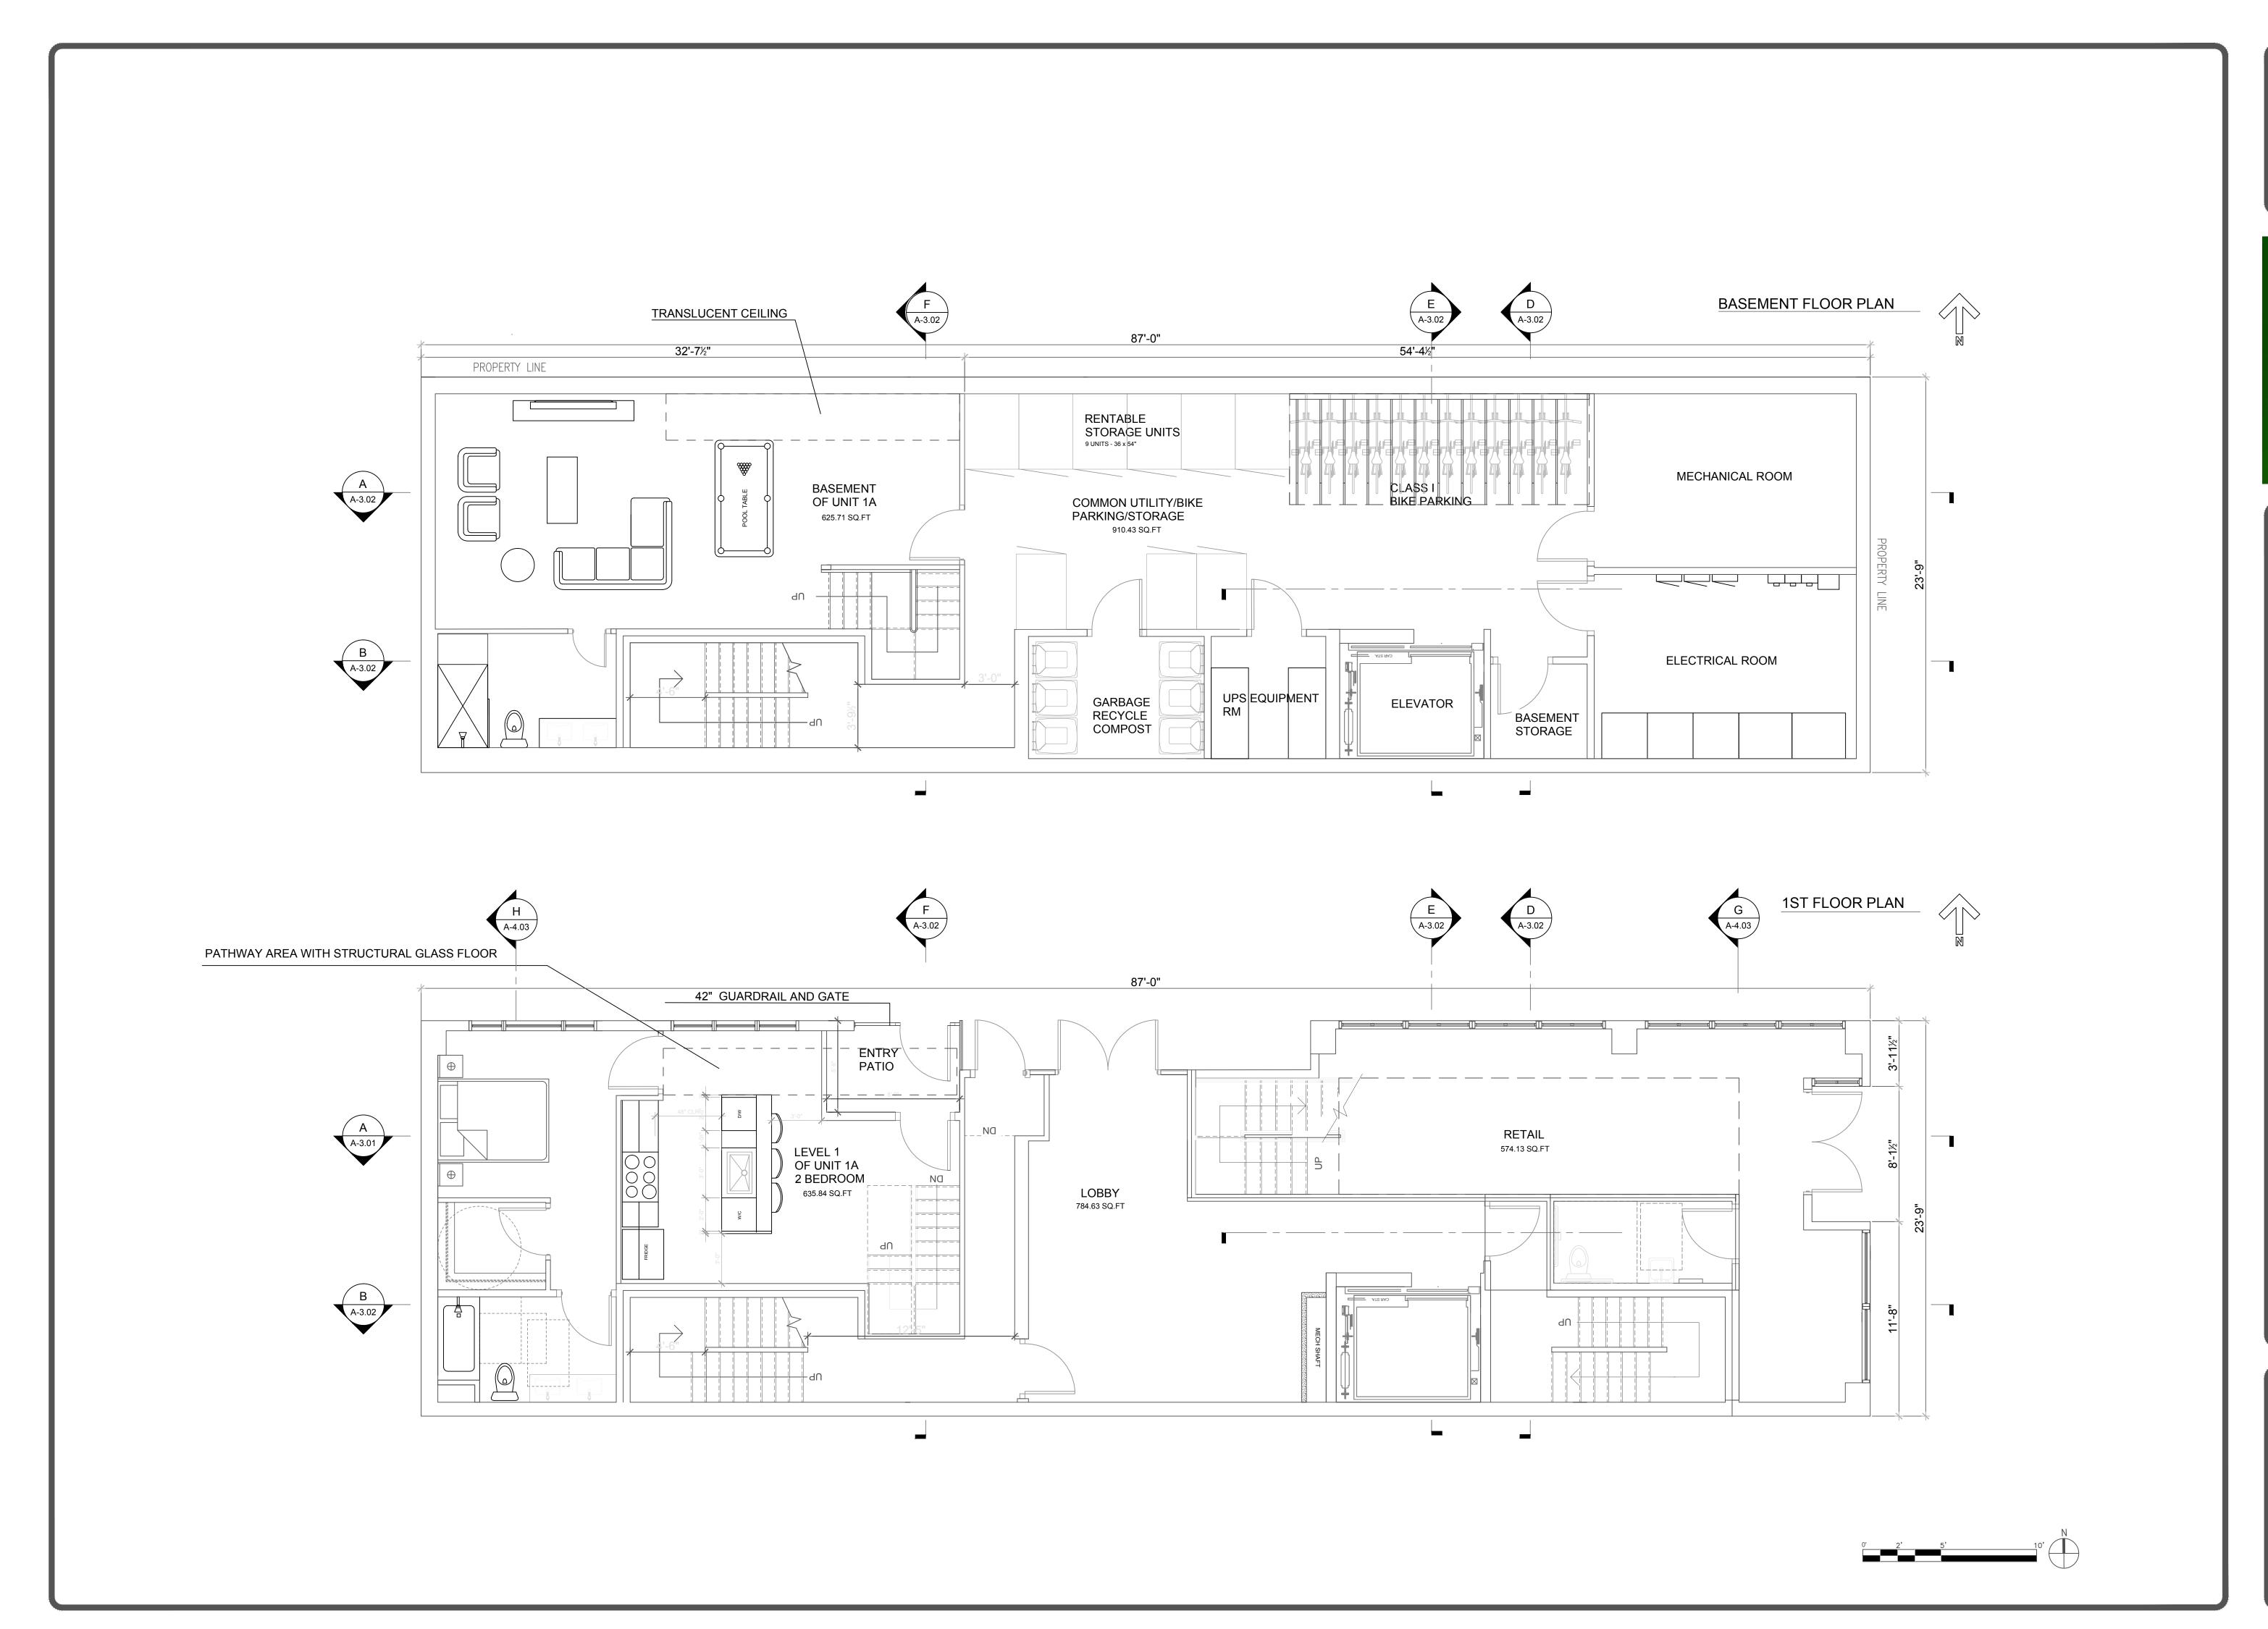
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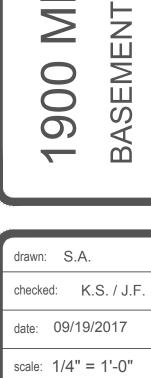
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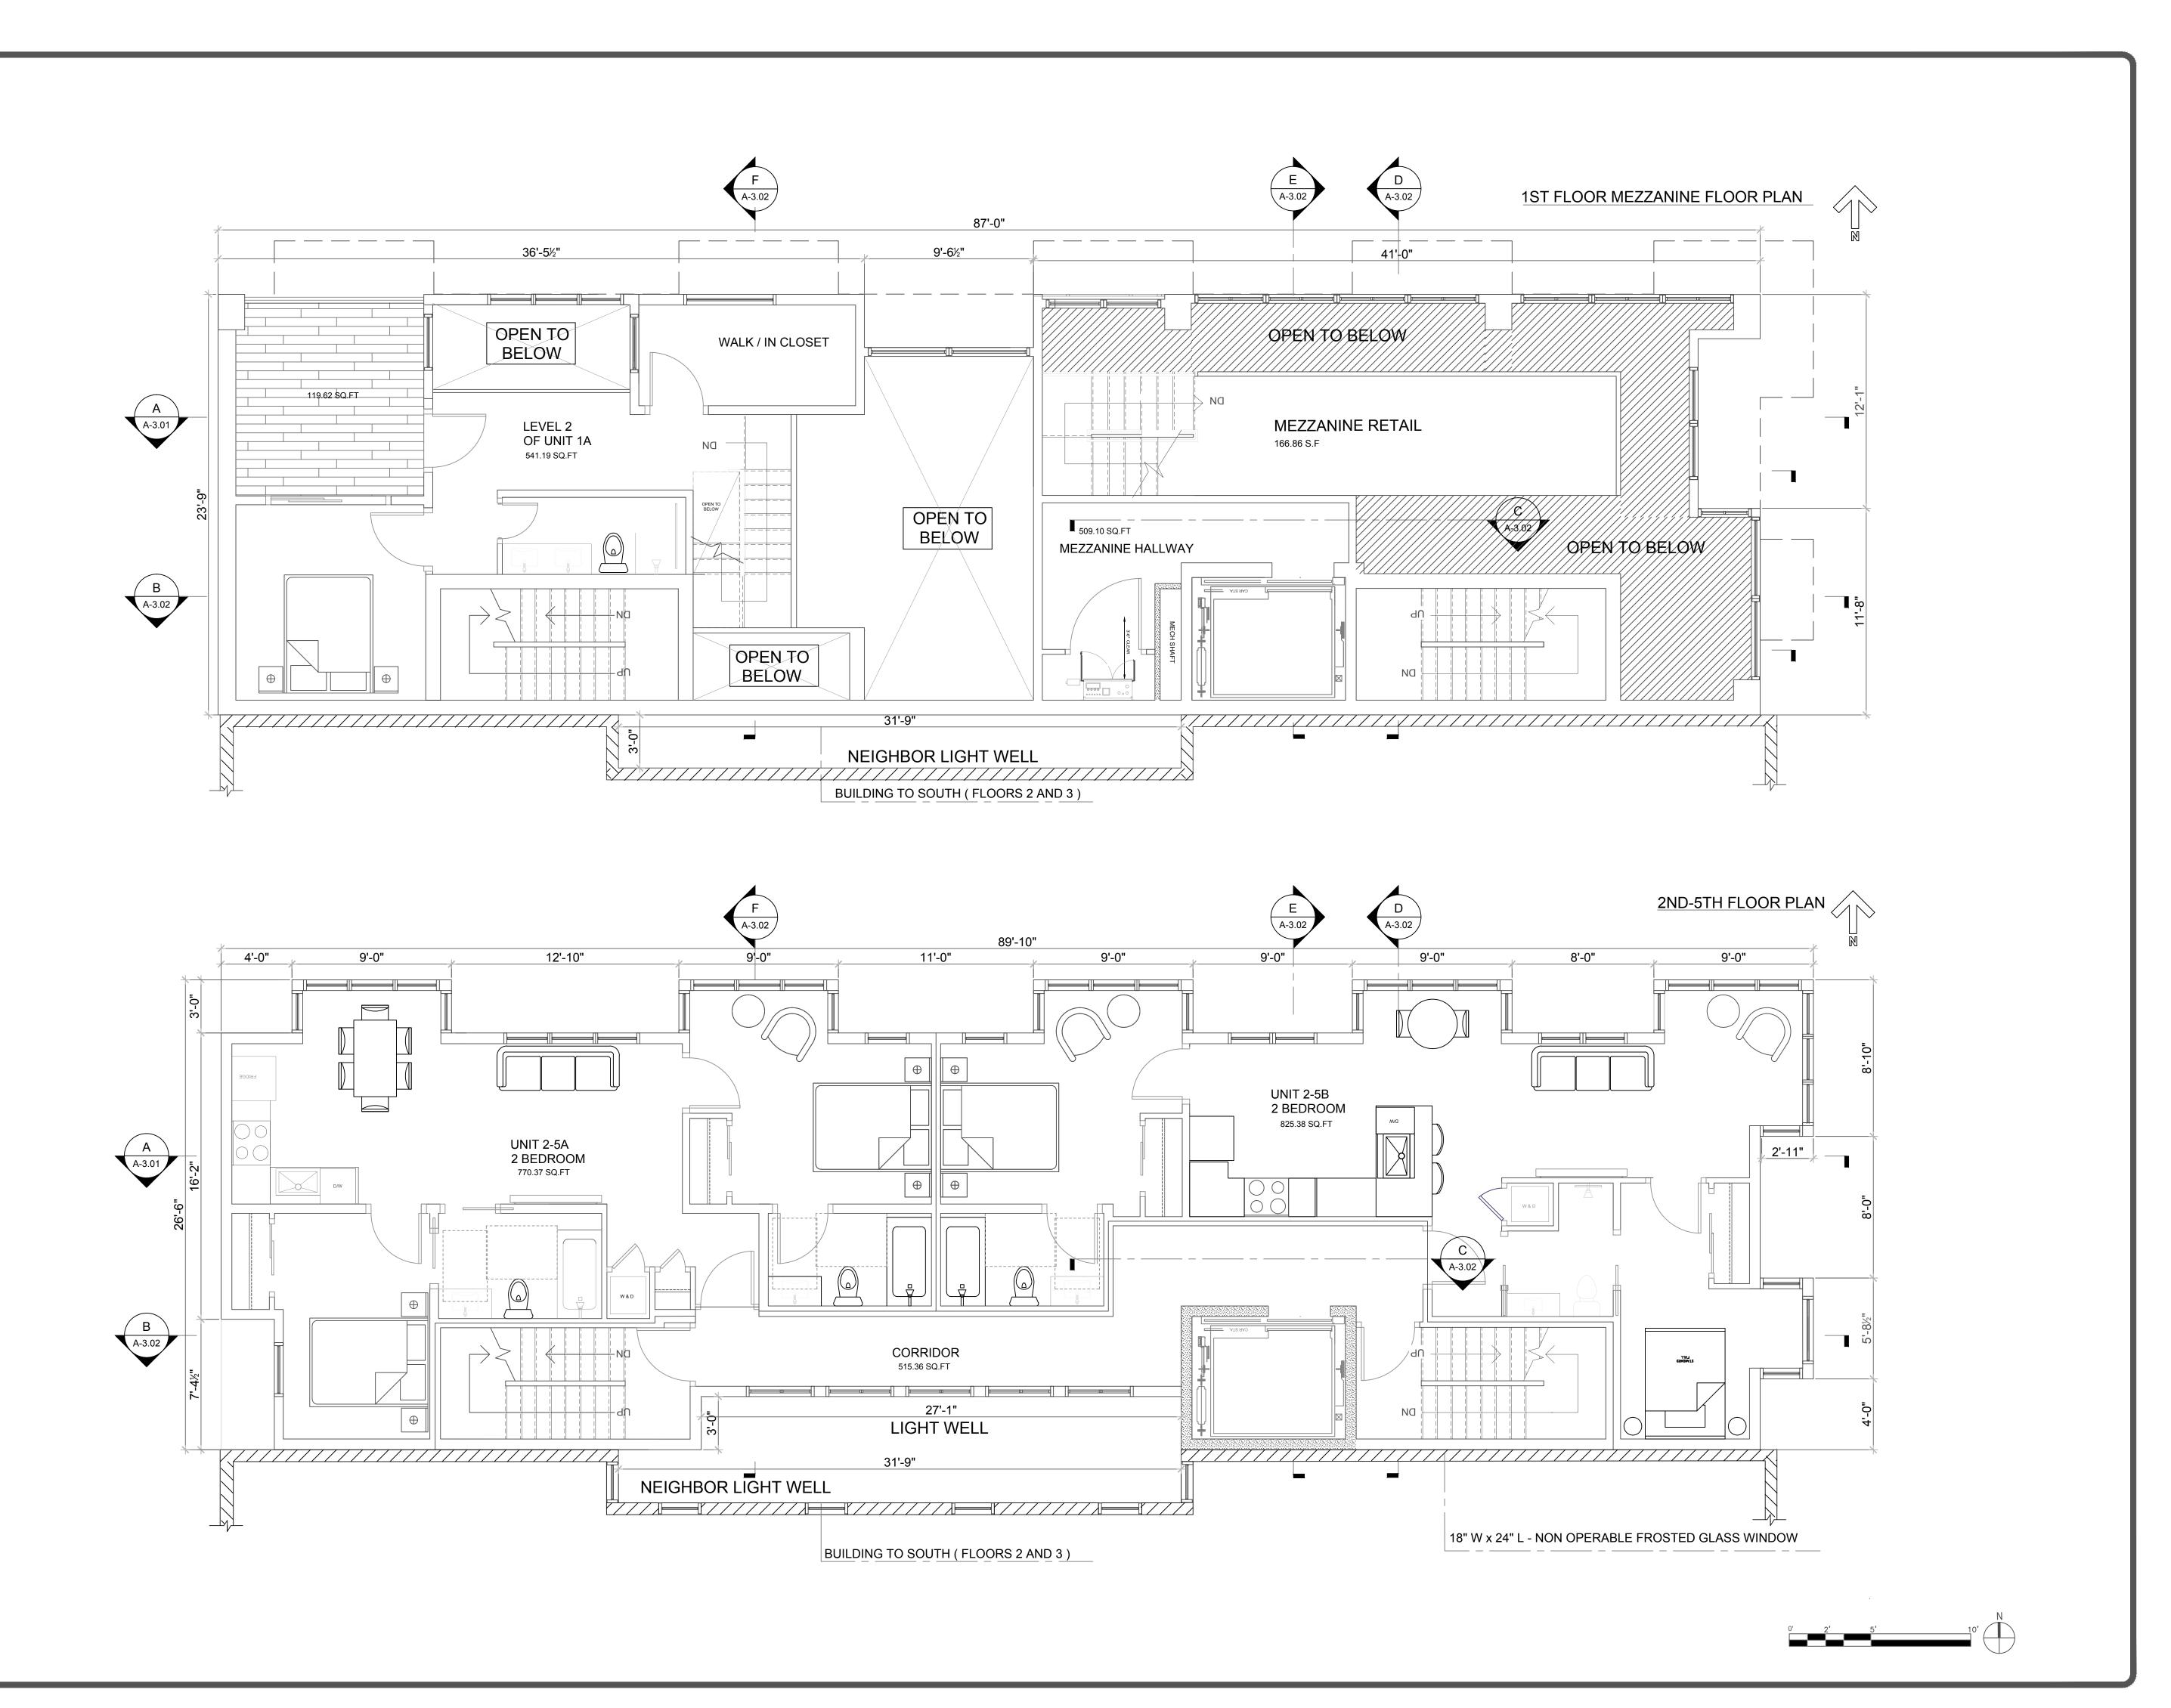
900 MISSION ST, SAN FRANCISCO, CA ASEMENT & 1ST FLOOR PLANS

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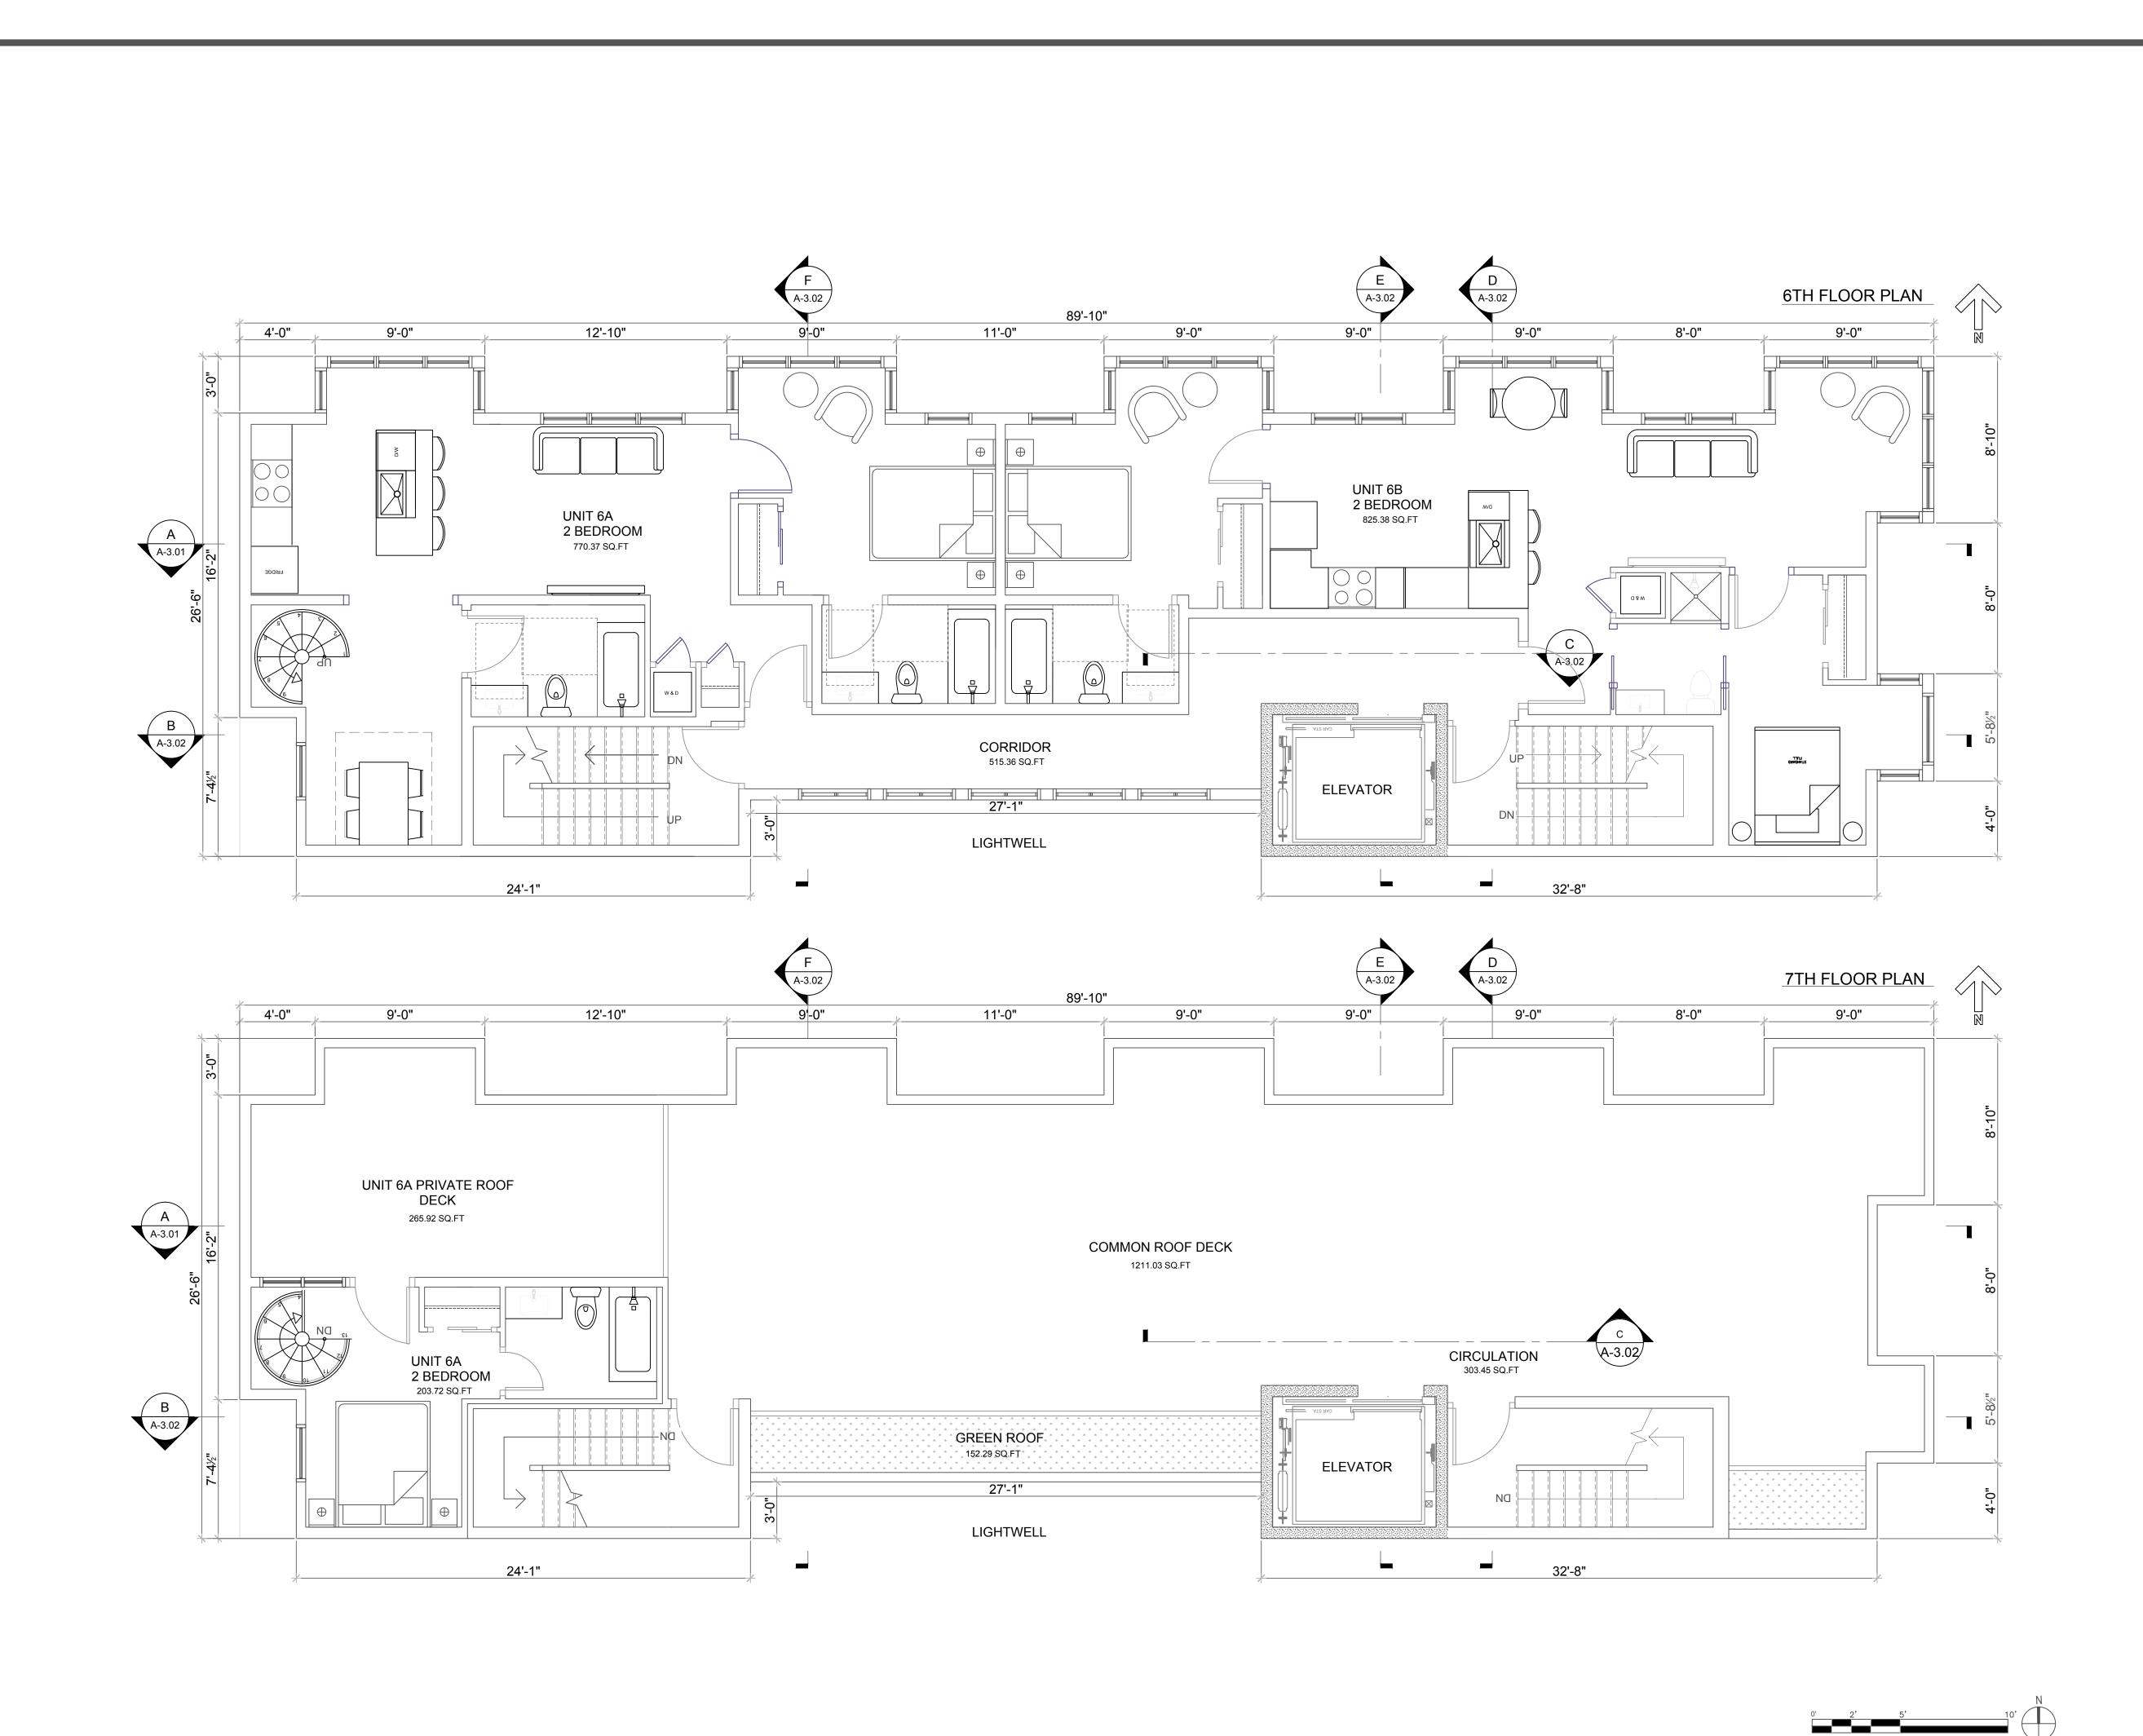


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300 MISSION ST, SAN FRANCISCO, CA H & 7TH FLOOR PLANS



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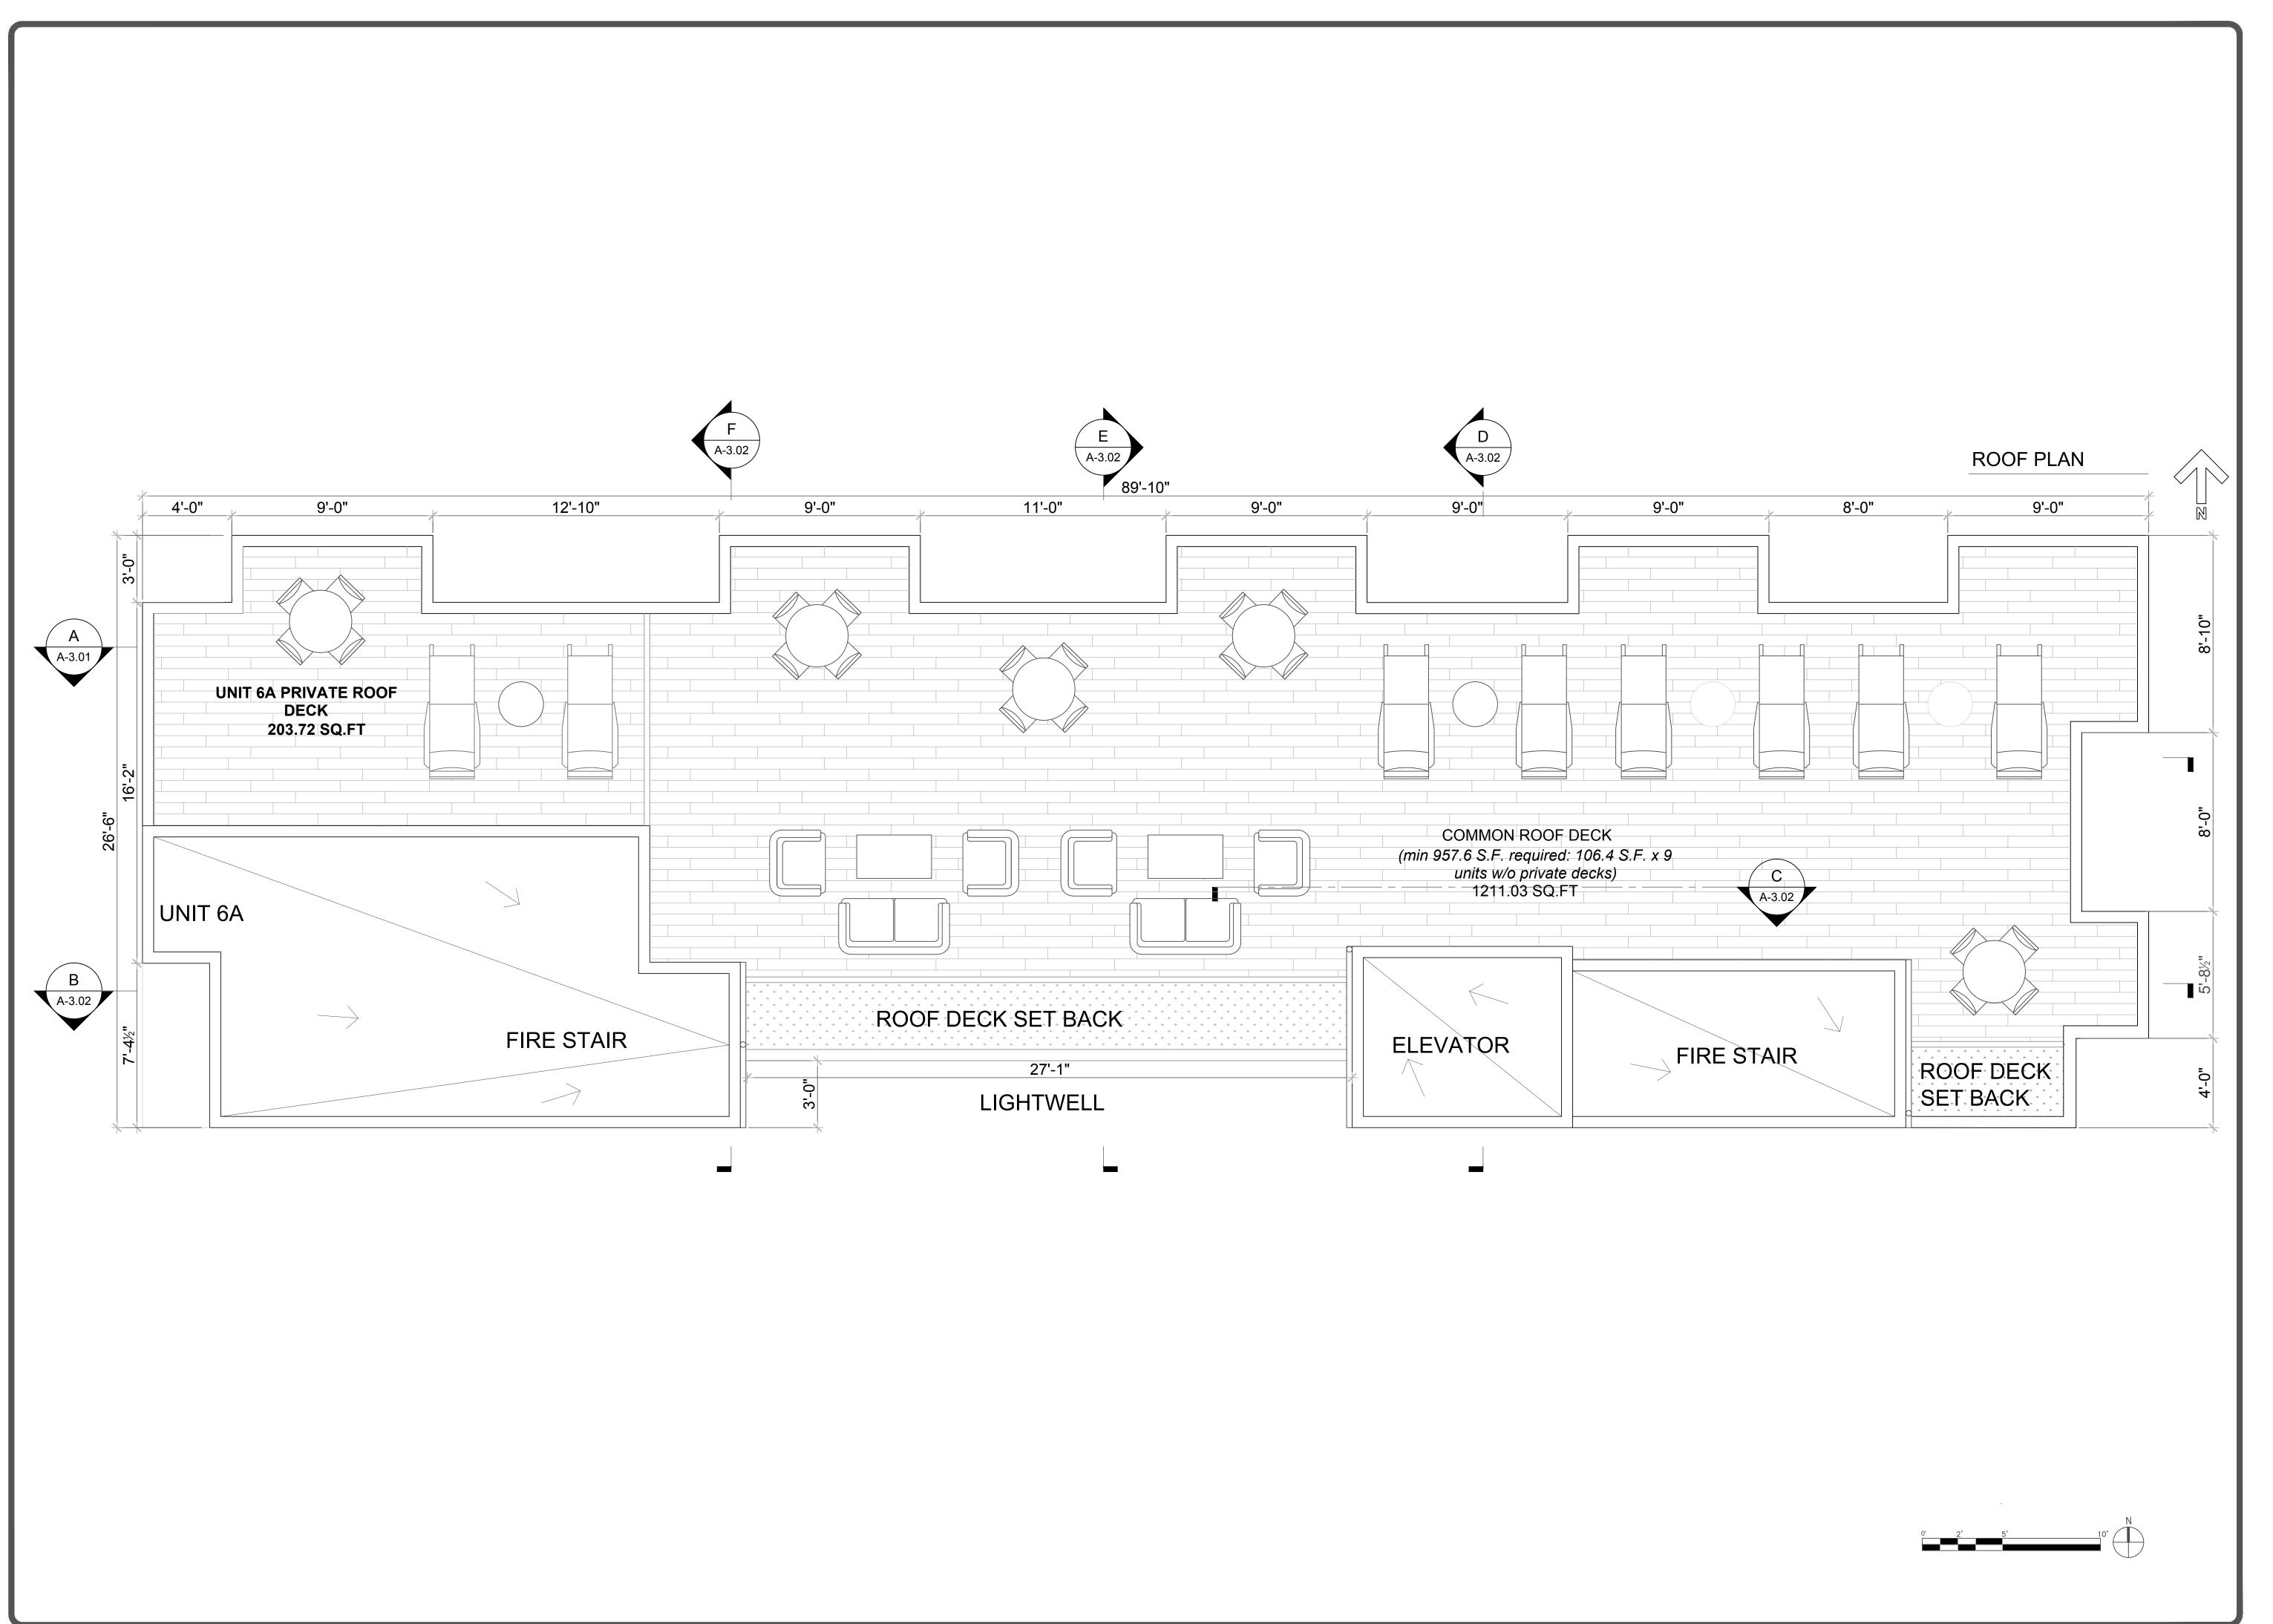
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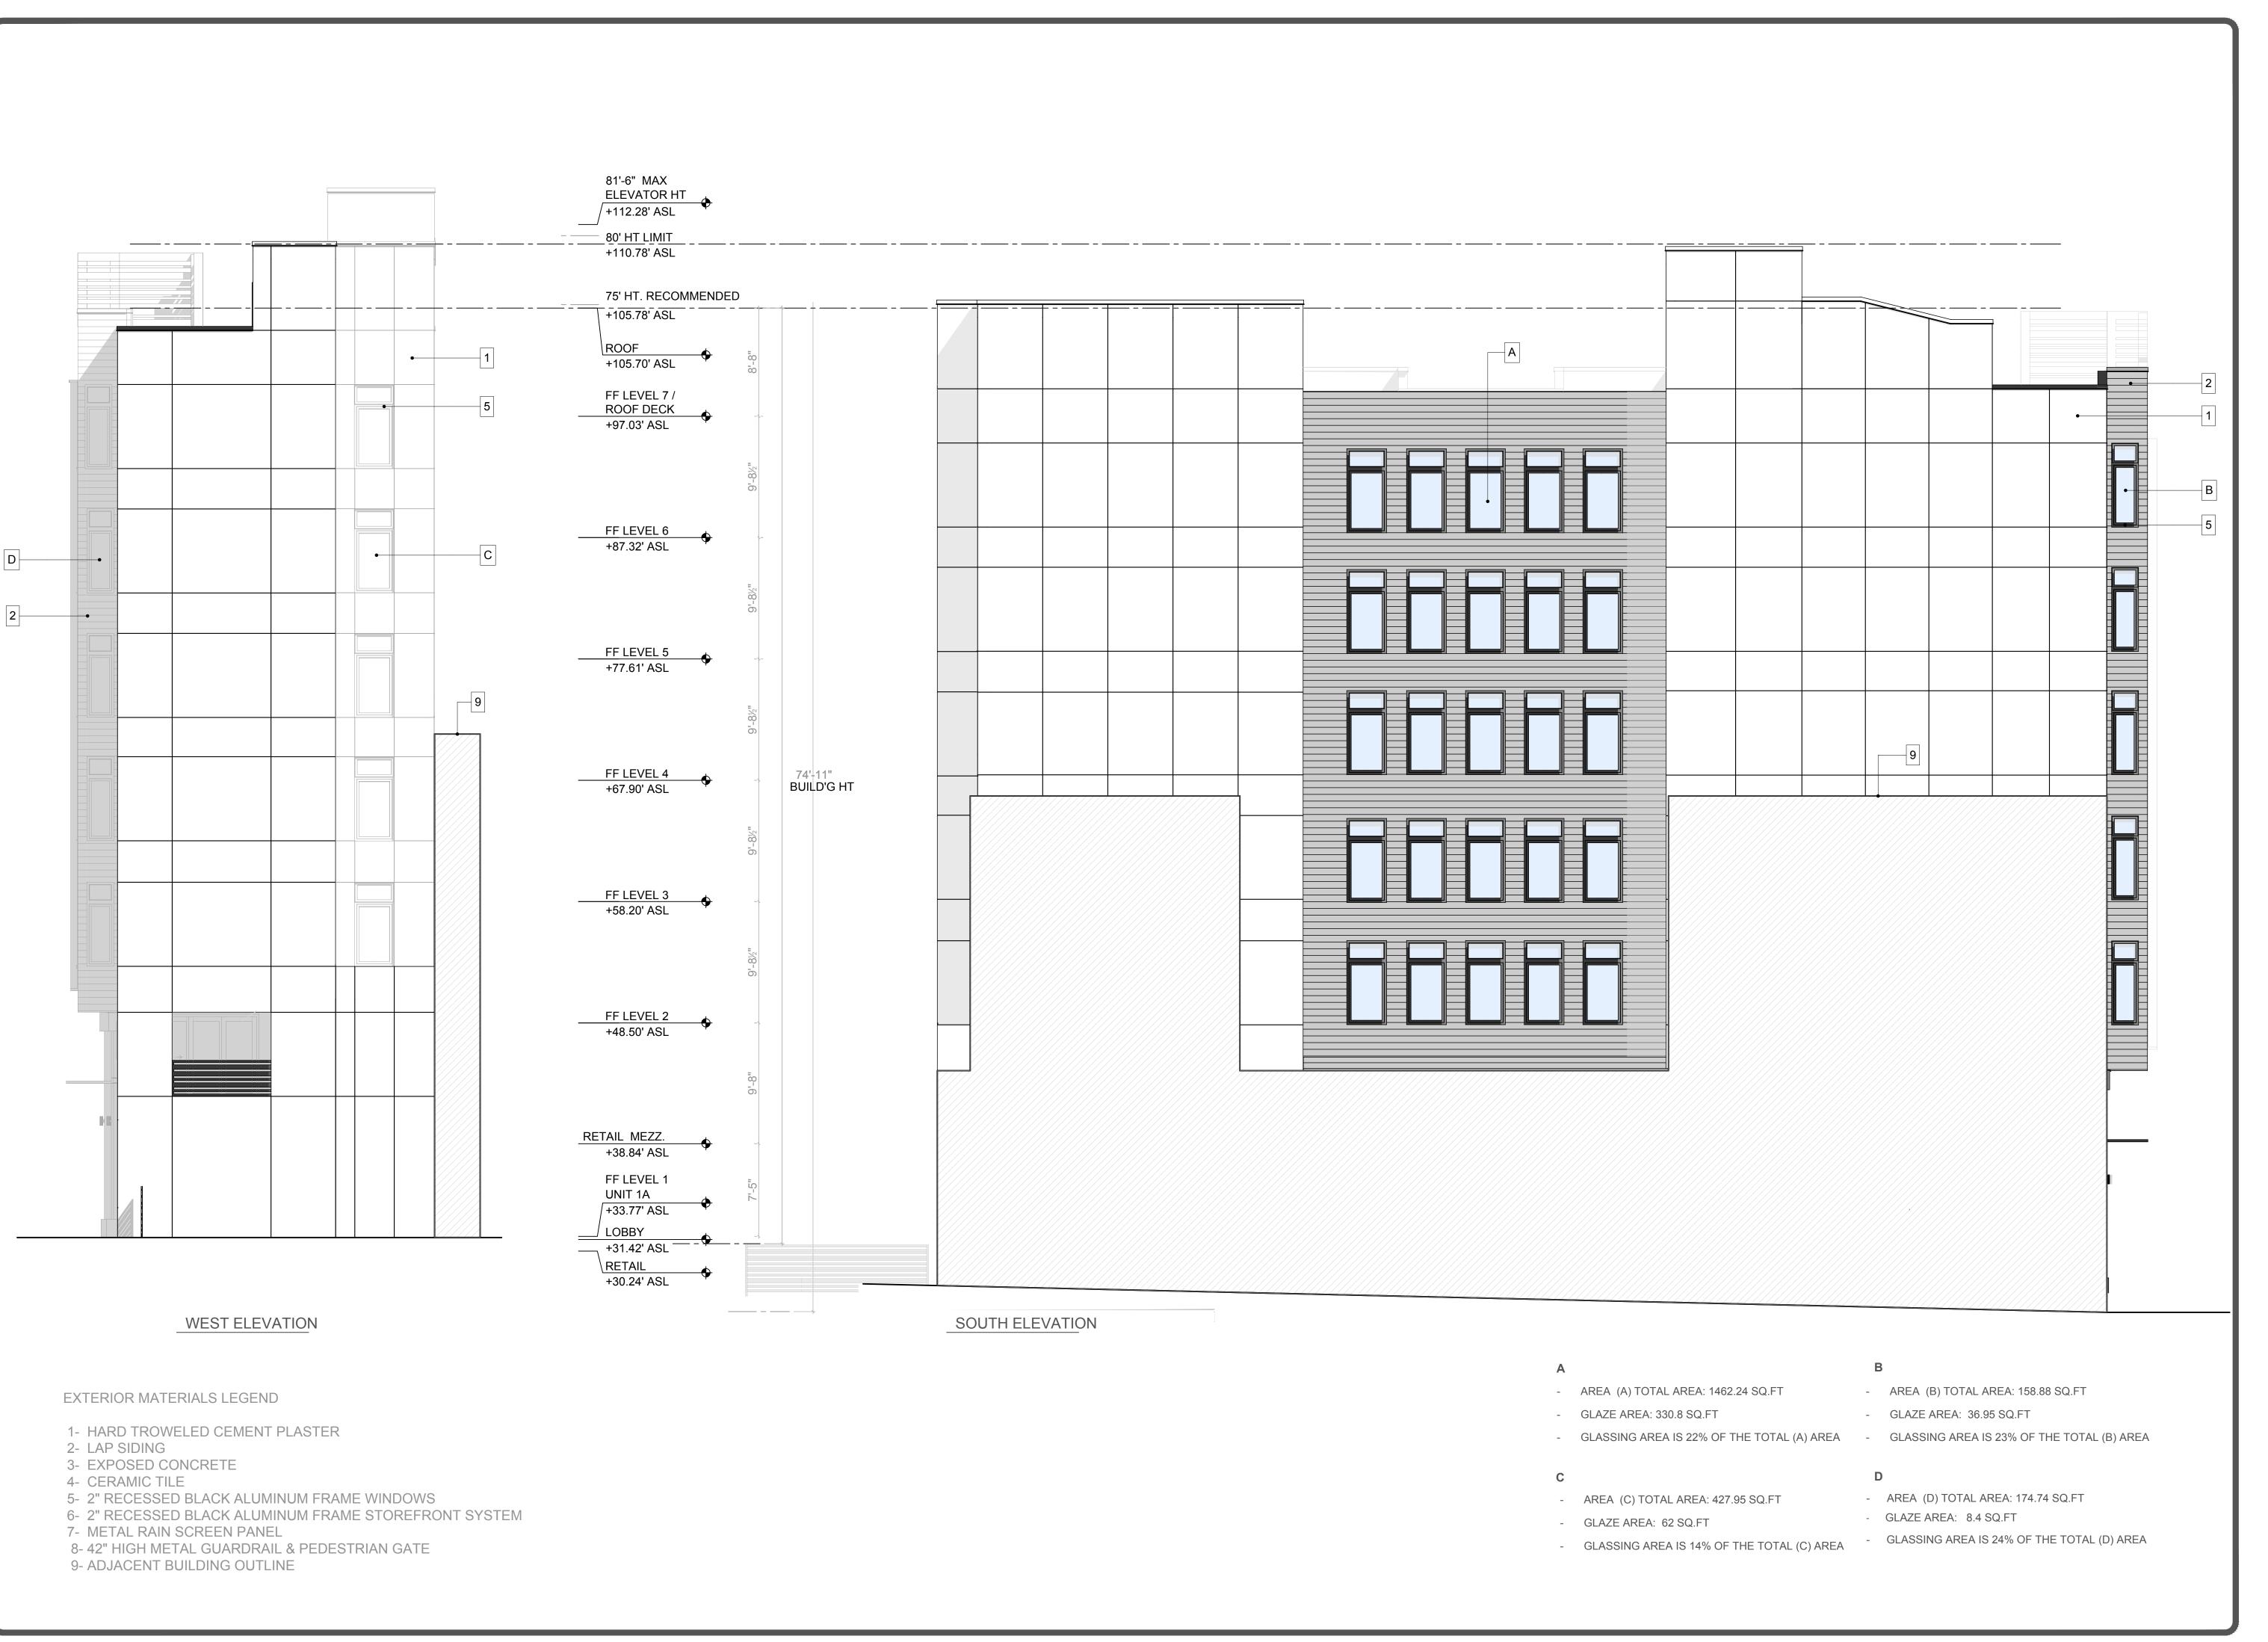


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EVATIONS BUILDING SION **≥** NORTH 900

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1900 MISSION ST, SAN FRANCISCO, SOUTH & WEST BUILDING ELEVATIONS

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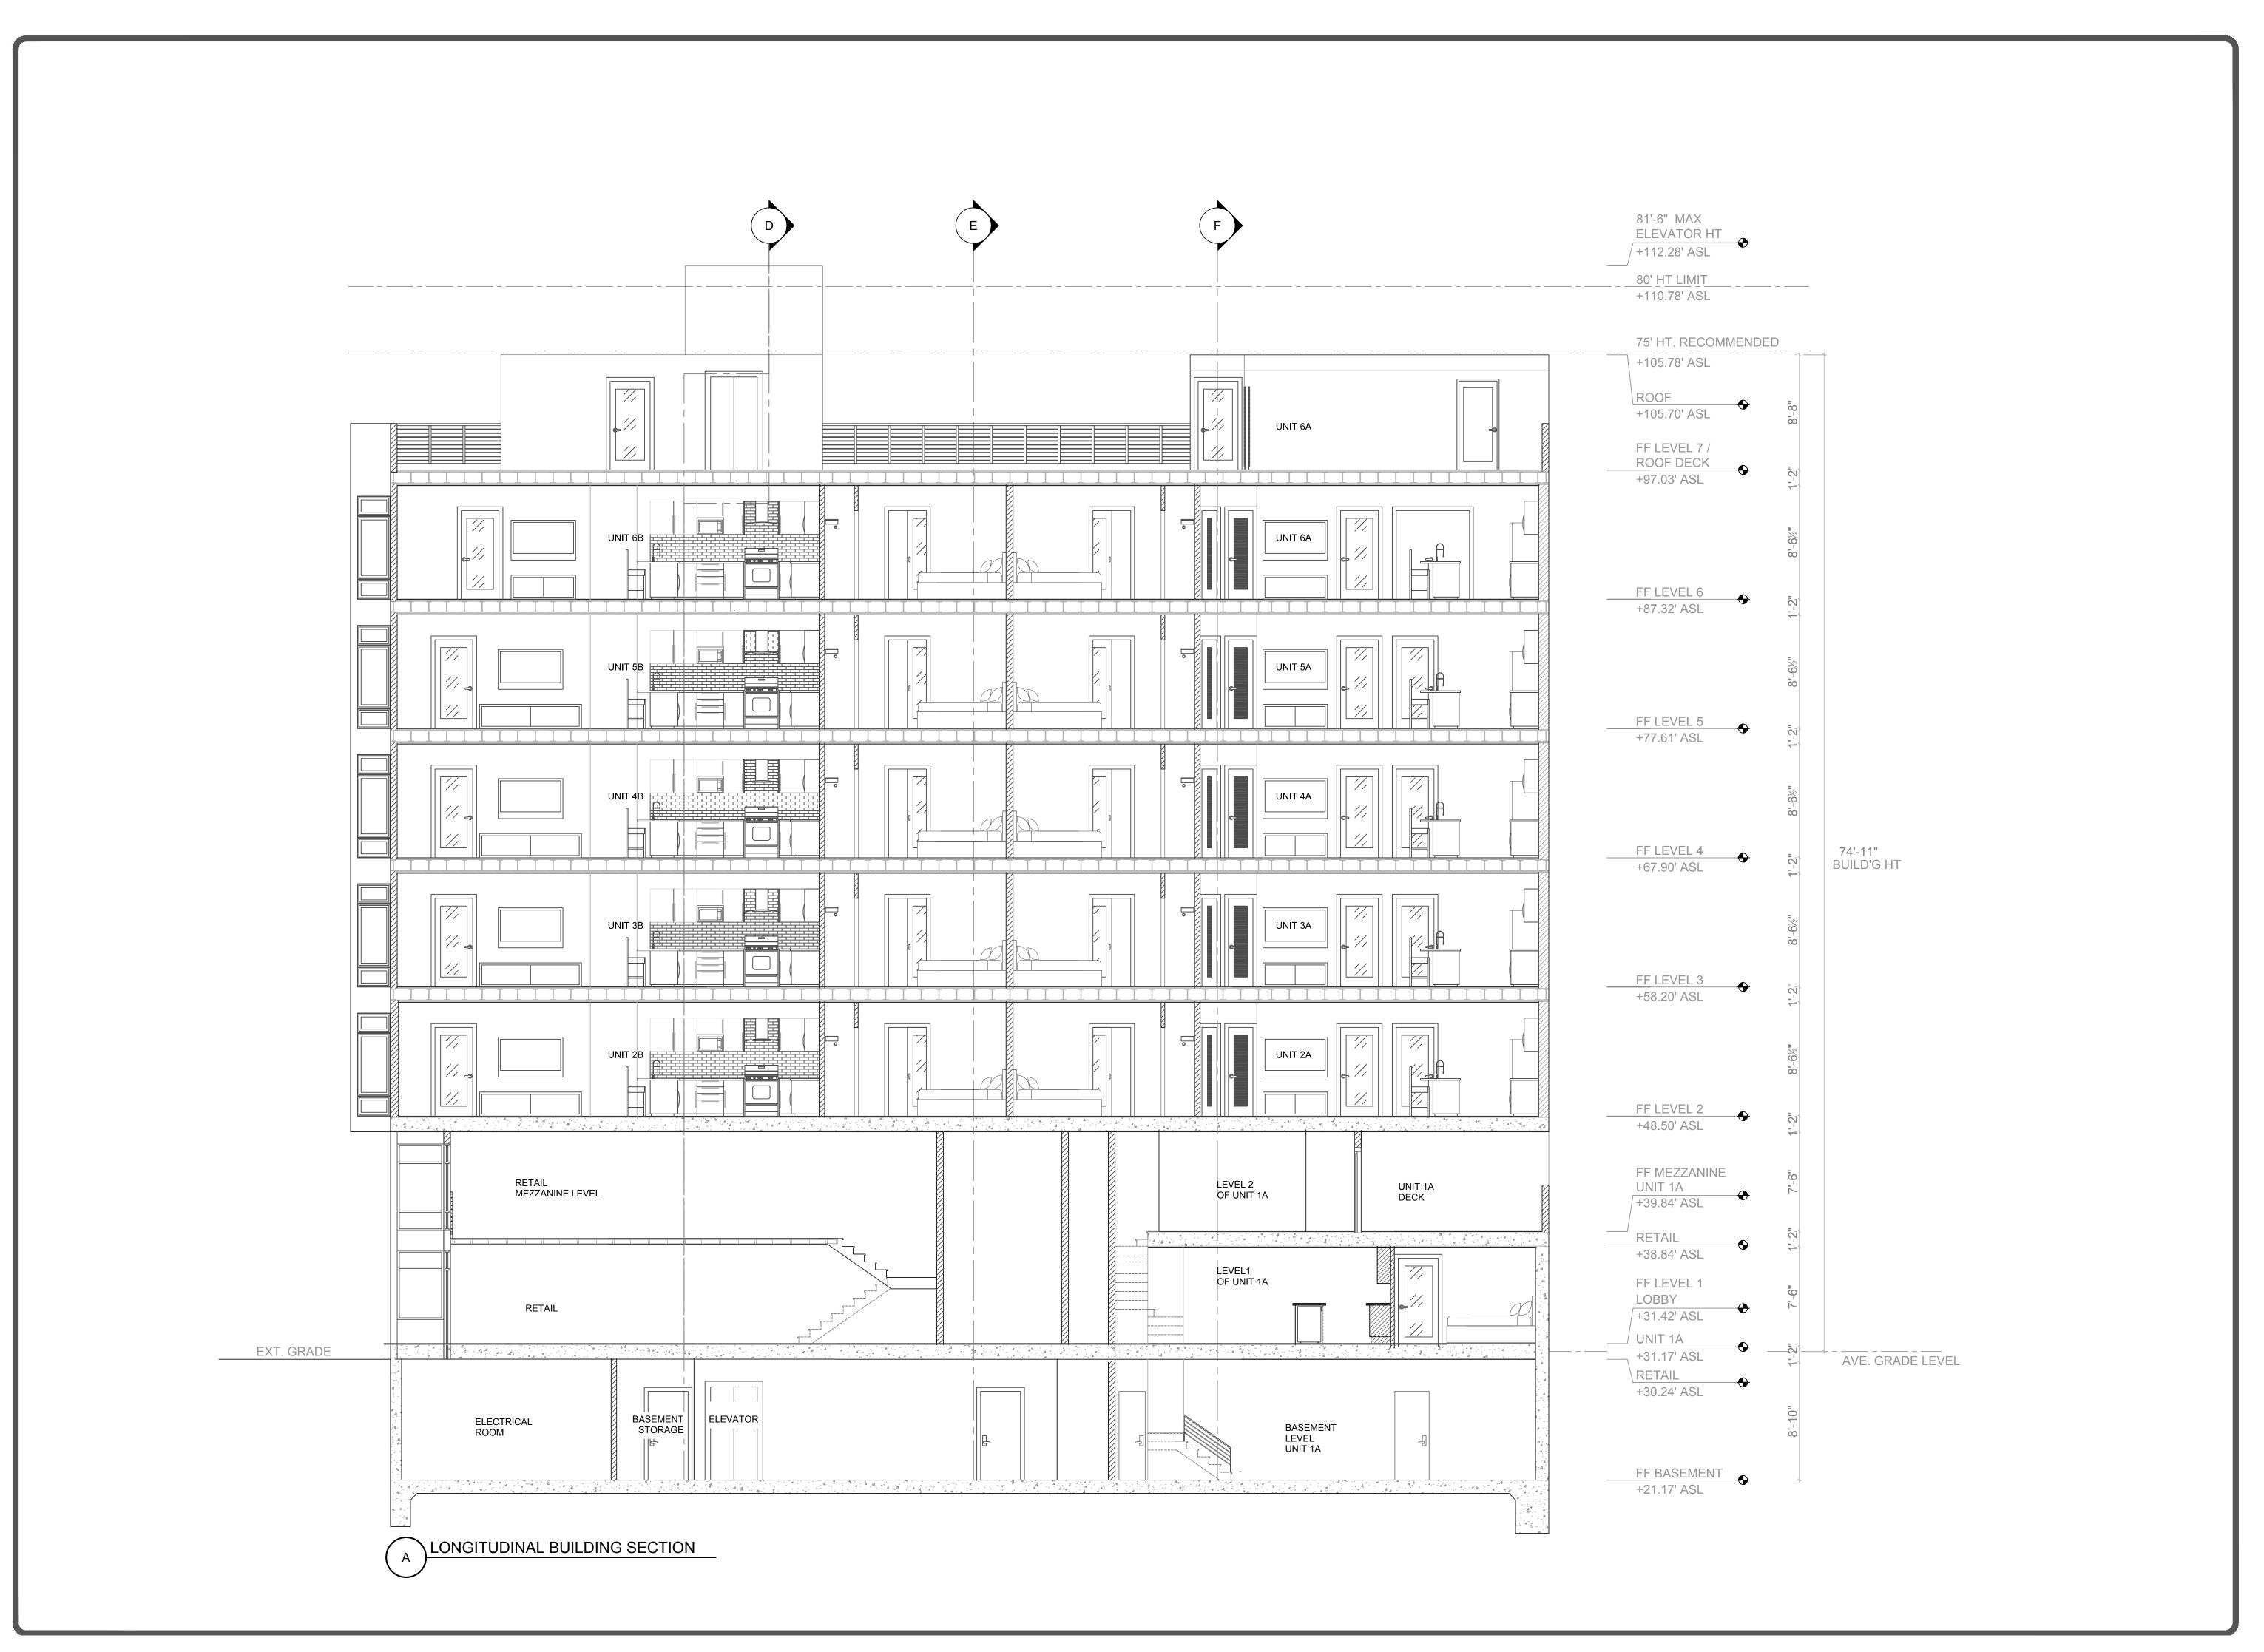
checked: K.S. / J.F.

date: 09/19/2017

scale: 3/16"=1'-0"

sheet:

A-2.02



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07/27/2017 S.A

09/19/2017 S.A



1900 MISSION ST, SAN FRANCISCO, C. LONGITUDINAL BUILDING SECTION

drawn: S.A.


checked: K.S. / J.F.

date: 09/19/2017

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sheet:
sheet

A-3.01



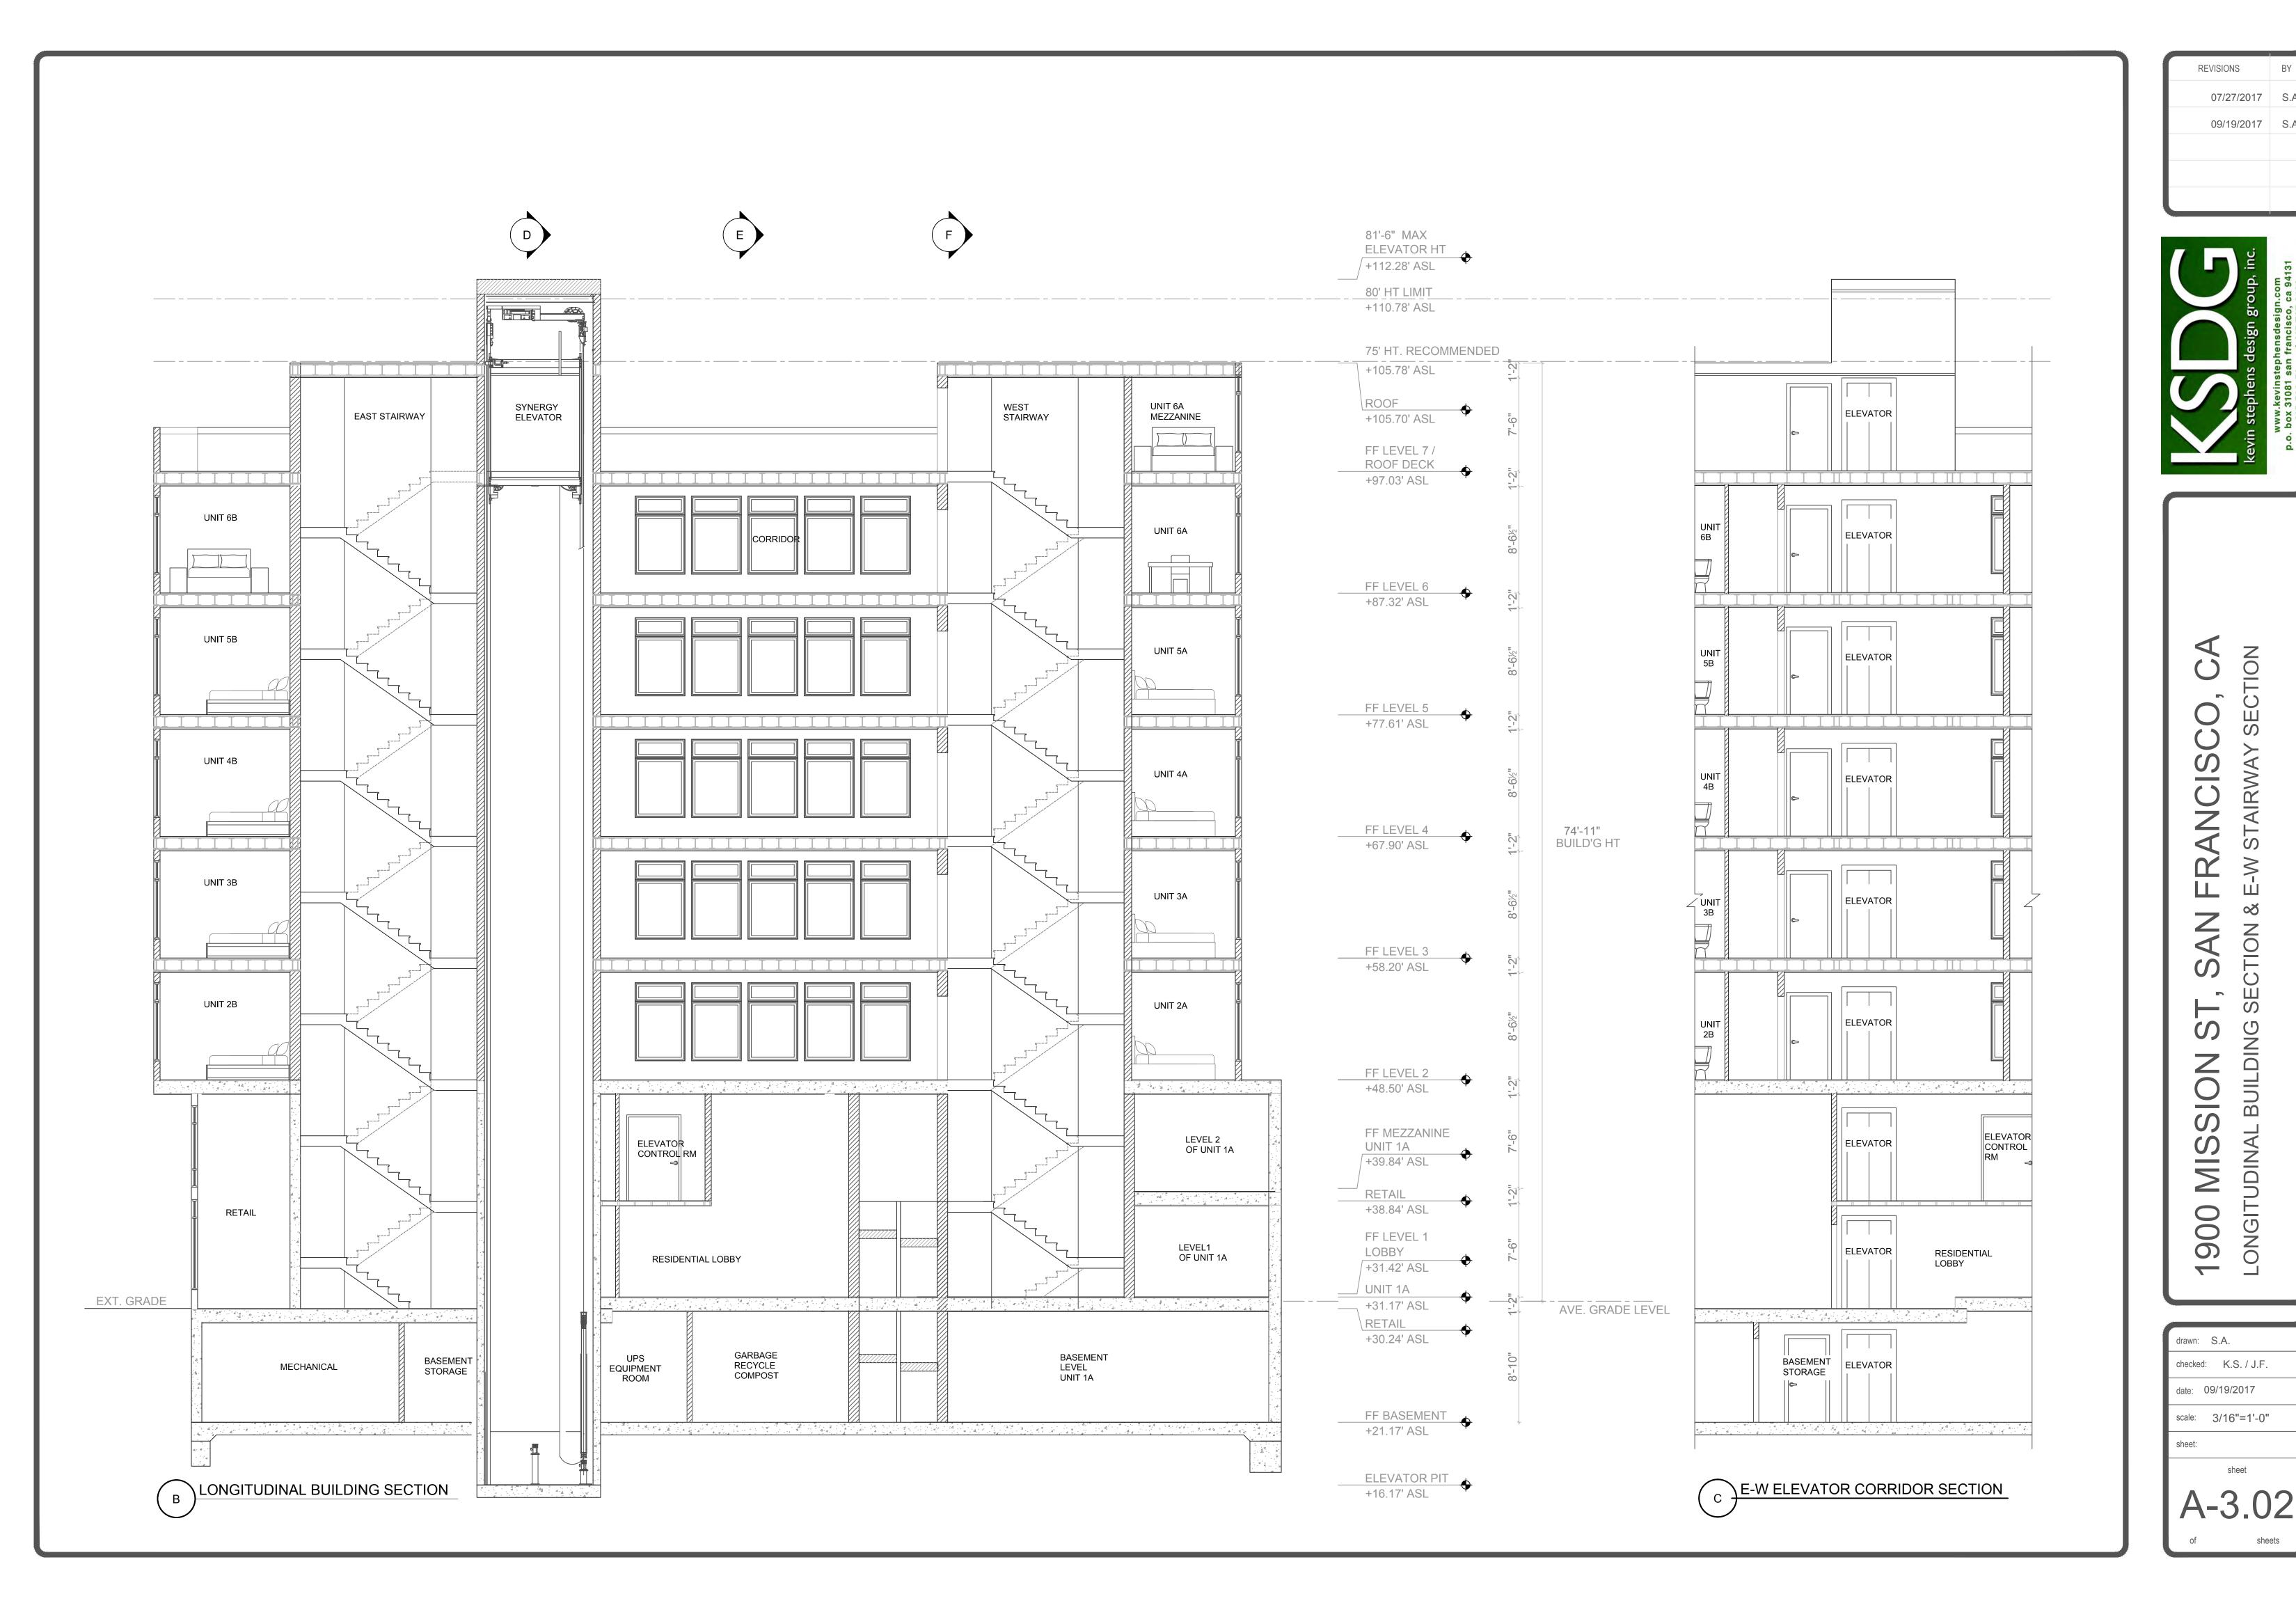


 $\overline{\sum}$

900

07/27/2017 S.A

09/19/2017 S.A

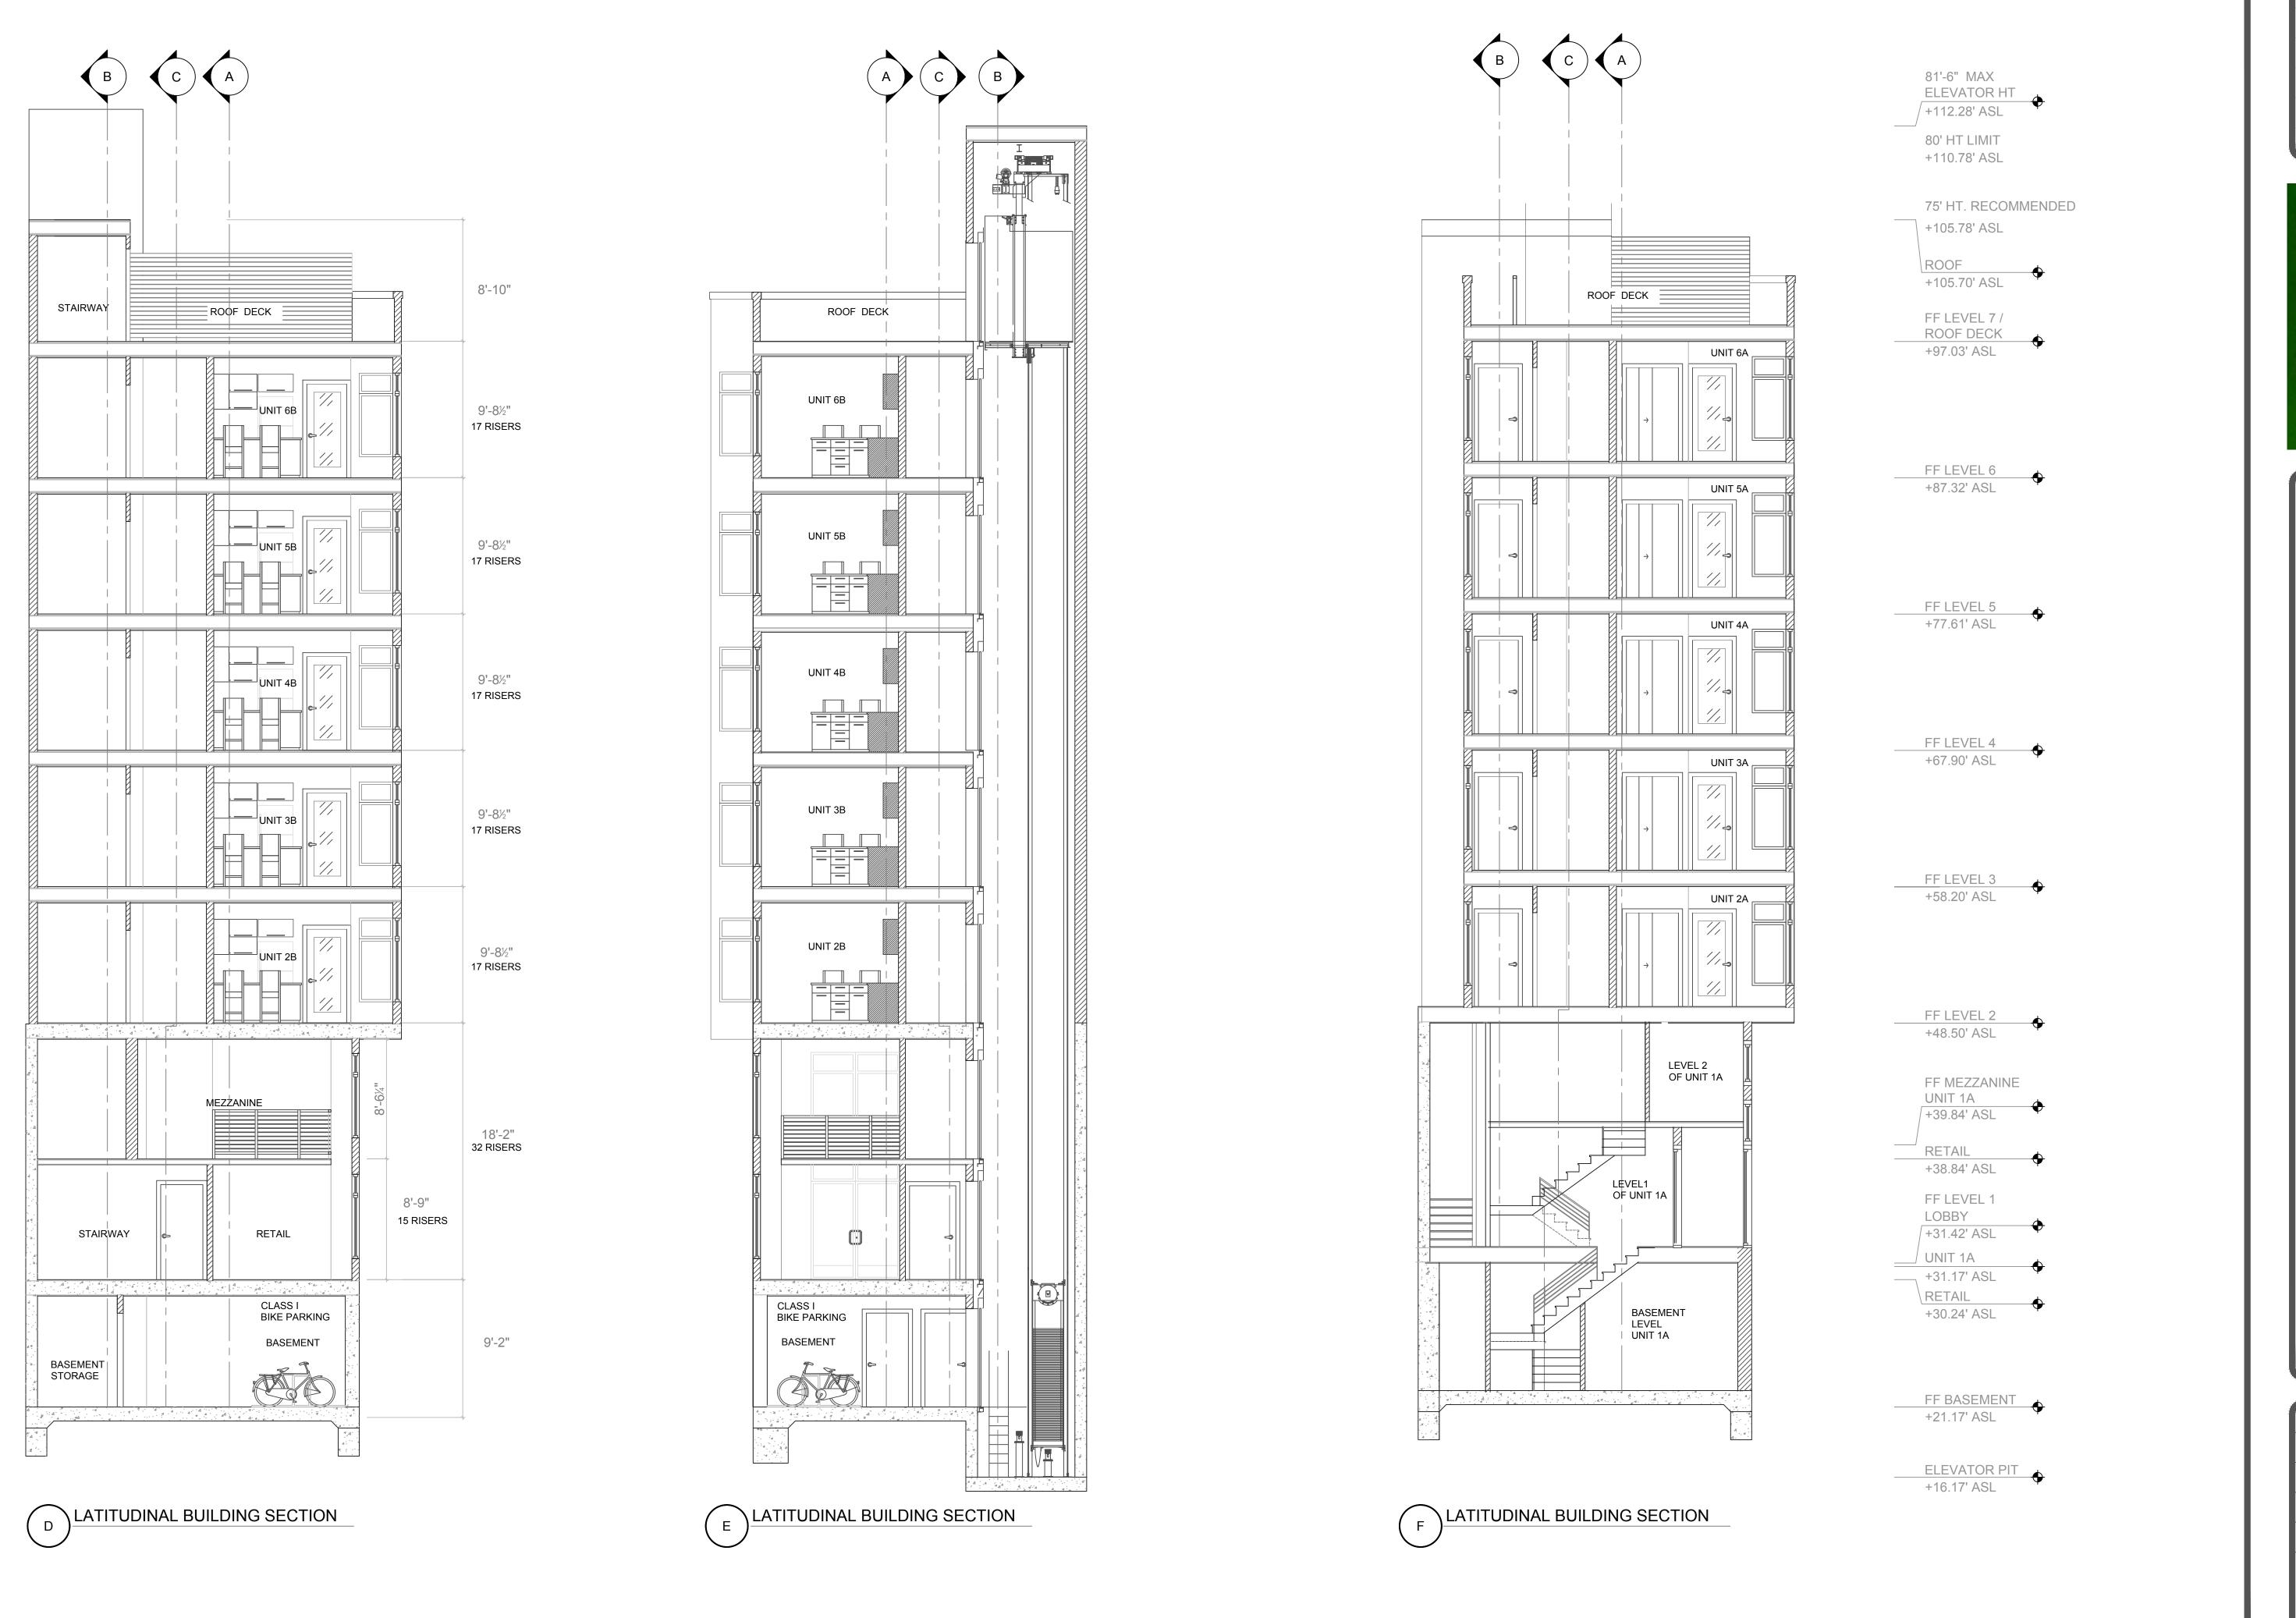


NCISCO SAN TIONS SION

REVISIONS 07/27/2017 S./ 09/19/2017 S.A





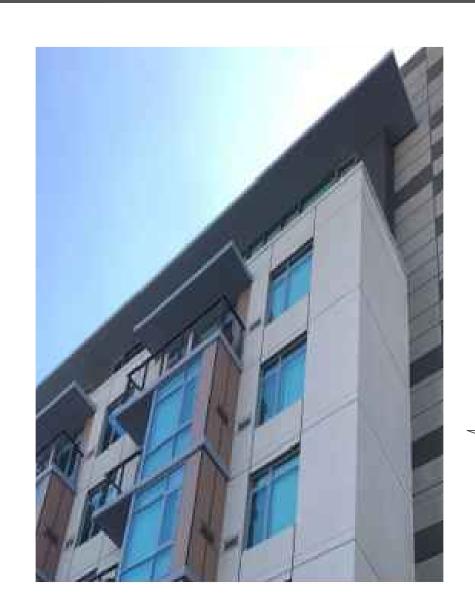

GRAY METAL BROW SURROUNDING CORNER BAY WINDOWS AND ABOVE RETAIL WINDOWS








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HARD TROWELED CEMENT PLASTER ON RECESSED AREAS OF RESIDENTIAL UNITS



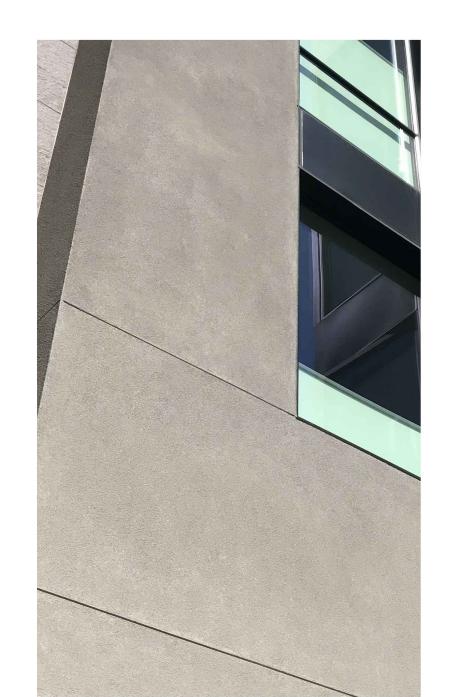

DARK GRAY METAL PANELING WITHIN STOREFRONT WINDOW SYSTEM AND SURROUNDING ENTER TO RESIDENTIAL LOBBY



LAP SIDING ON ALL BAYS EXCEPT CORNER BAY



GLASS CANOPIES ON THE RETAIL DOORS AND 15TH STREET LOBBY DOORS

drawn: S.A.

checked: K.S. / J.F.

date: 09/19/2017

scale: 3/16"=1'-0"

sheet:

sheet

A-4.01

of sheets

MISSION

1900

MATERIALS BOARD

42" HIGH BLACK METAL FABRICATED
RAILING AND GATE AT ENTRY TO
TOWN HOME AND ON TOWN HOME
BALCONY



METAL FRAME WITH GLASS PANEL TOWN HOME DOOR




RECESSED, DARK GRAY METAL MESH FIRE EXIT DOOR



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1900 MISSION ST, SAN FRANCISCO, CA

drawn: S.A.

checked: K.S. / J.F.

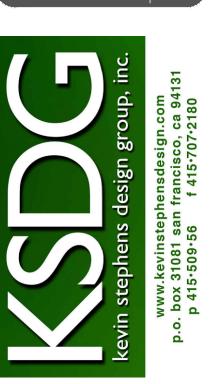date: 09/19/2017

scale: 3/16"=1'-0"

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A-4.02

of sheets















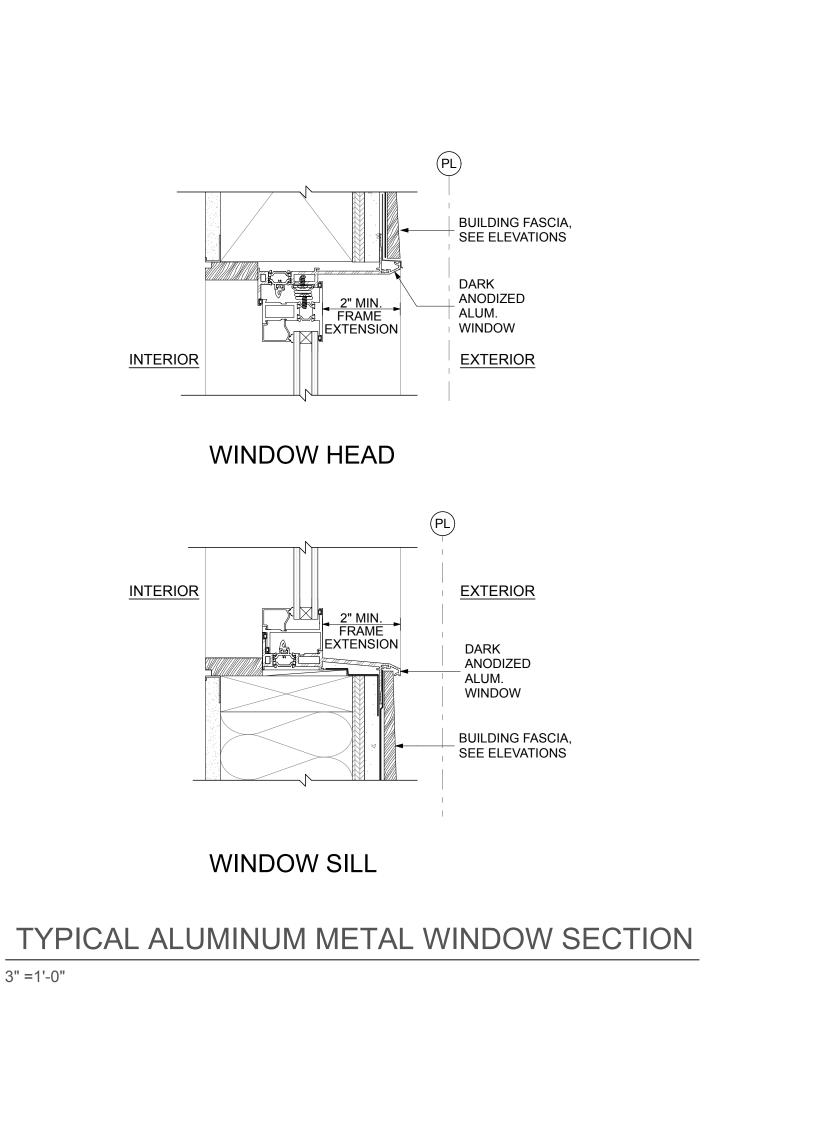

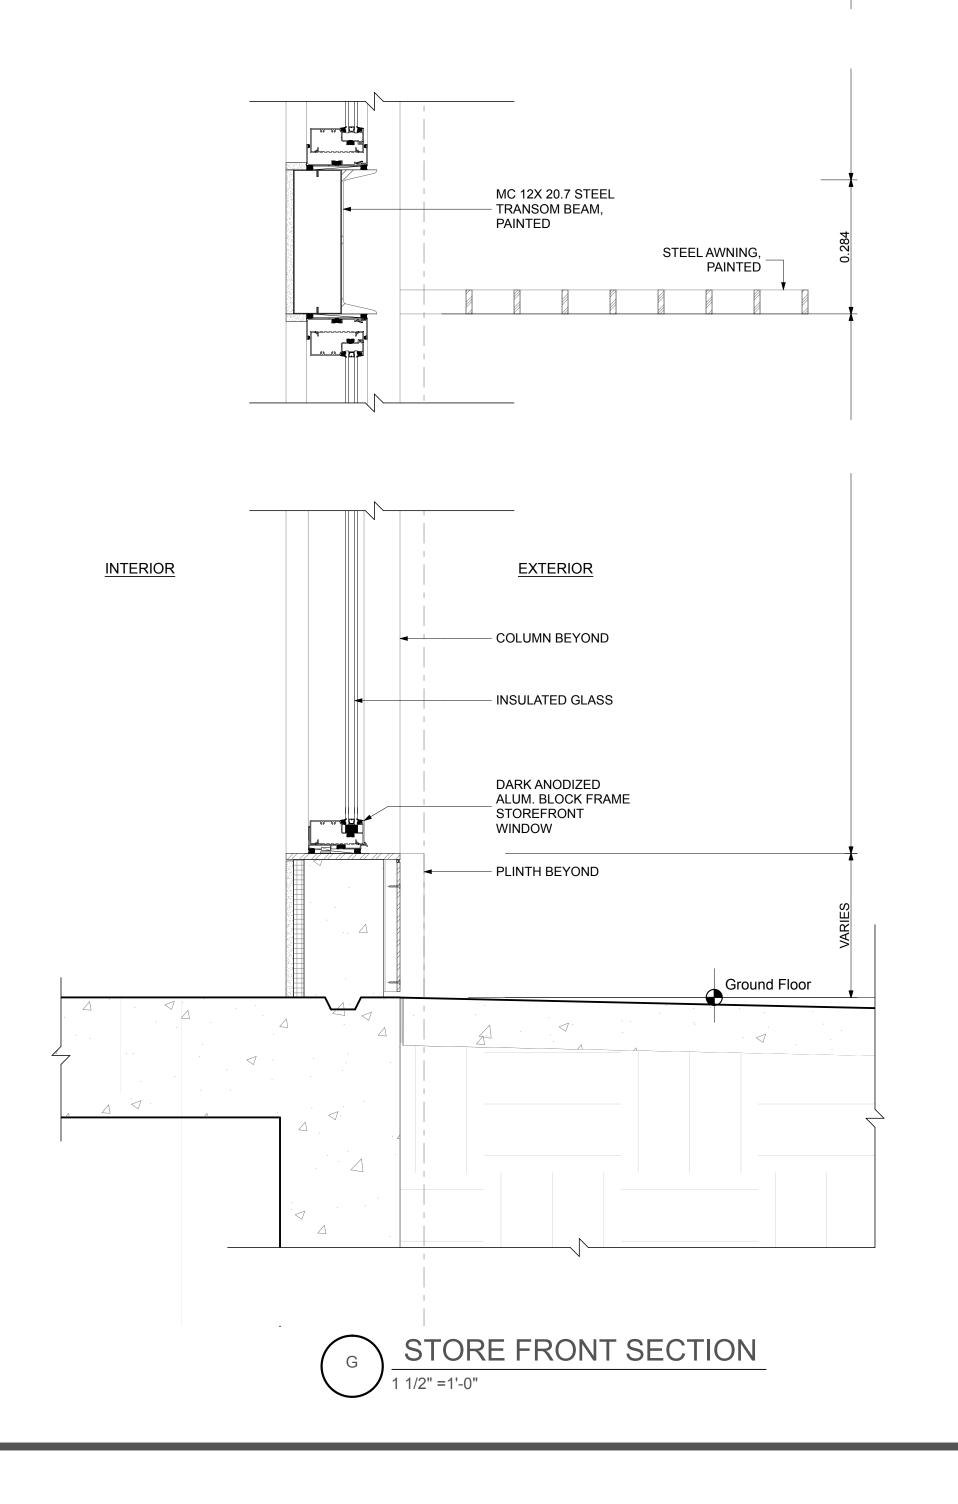

STORY 2


- 3/4" ALUM. REVEAL

— TILE BELT COURSE

DARK ANODIZED
_ ALUM. BLOCK FRAME
STOREFRONT

COLUMN BEYOND

WINDOW

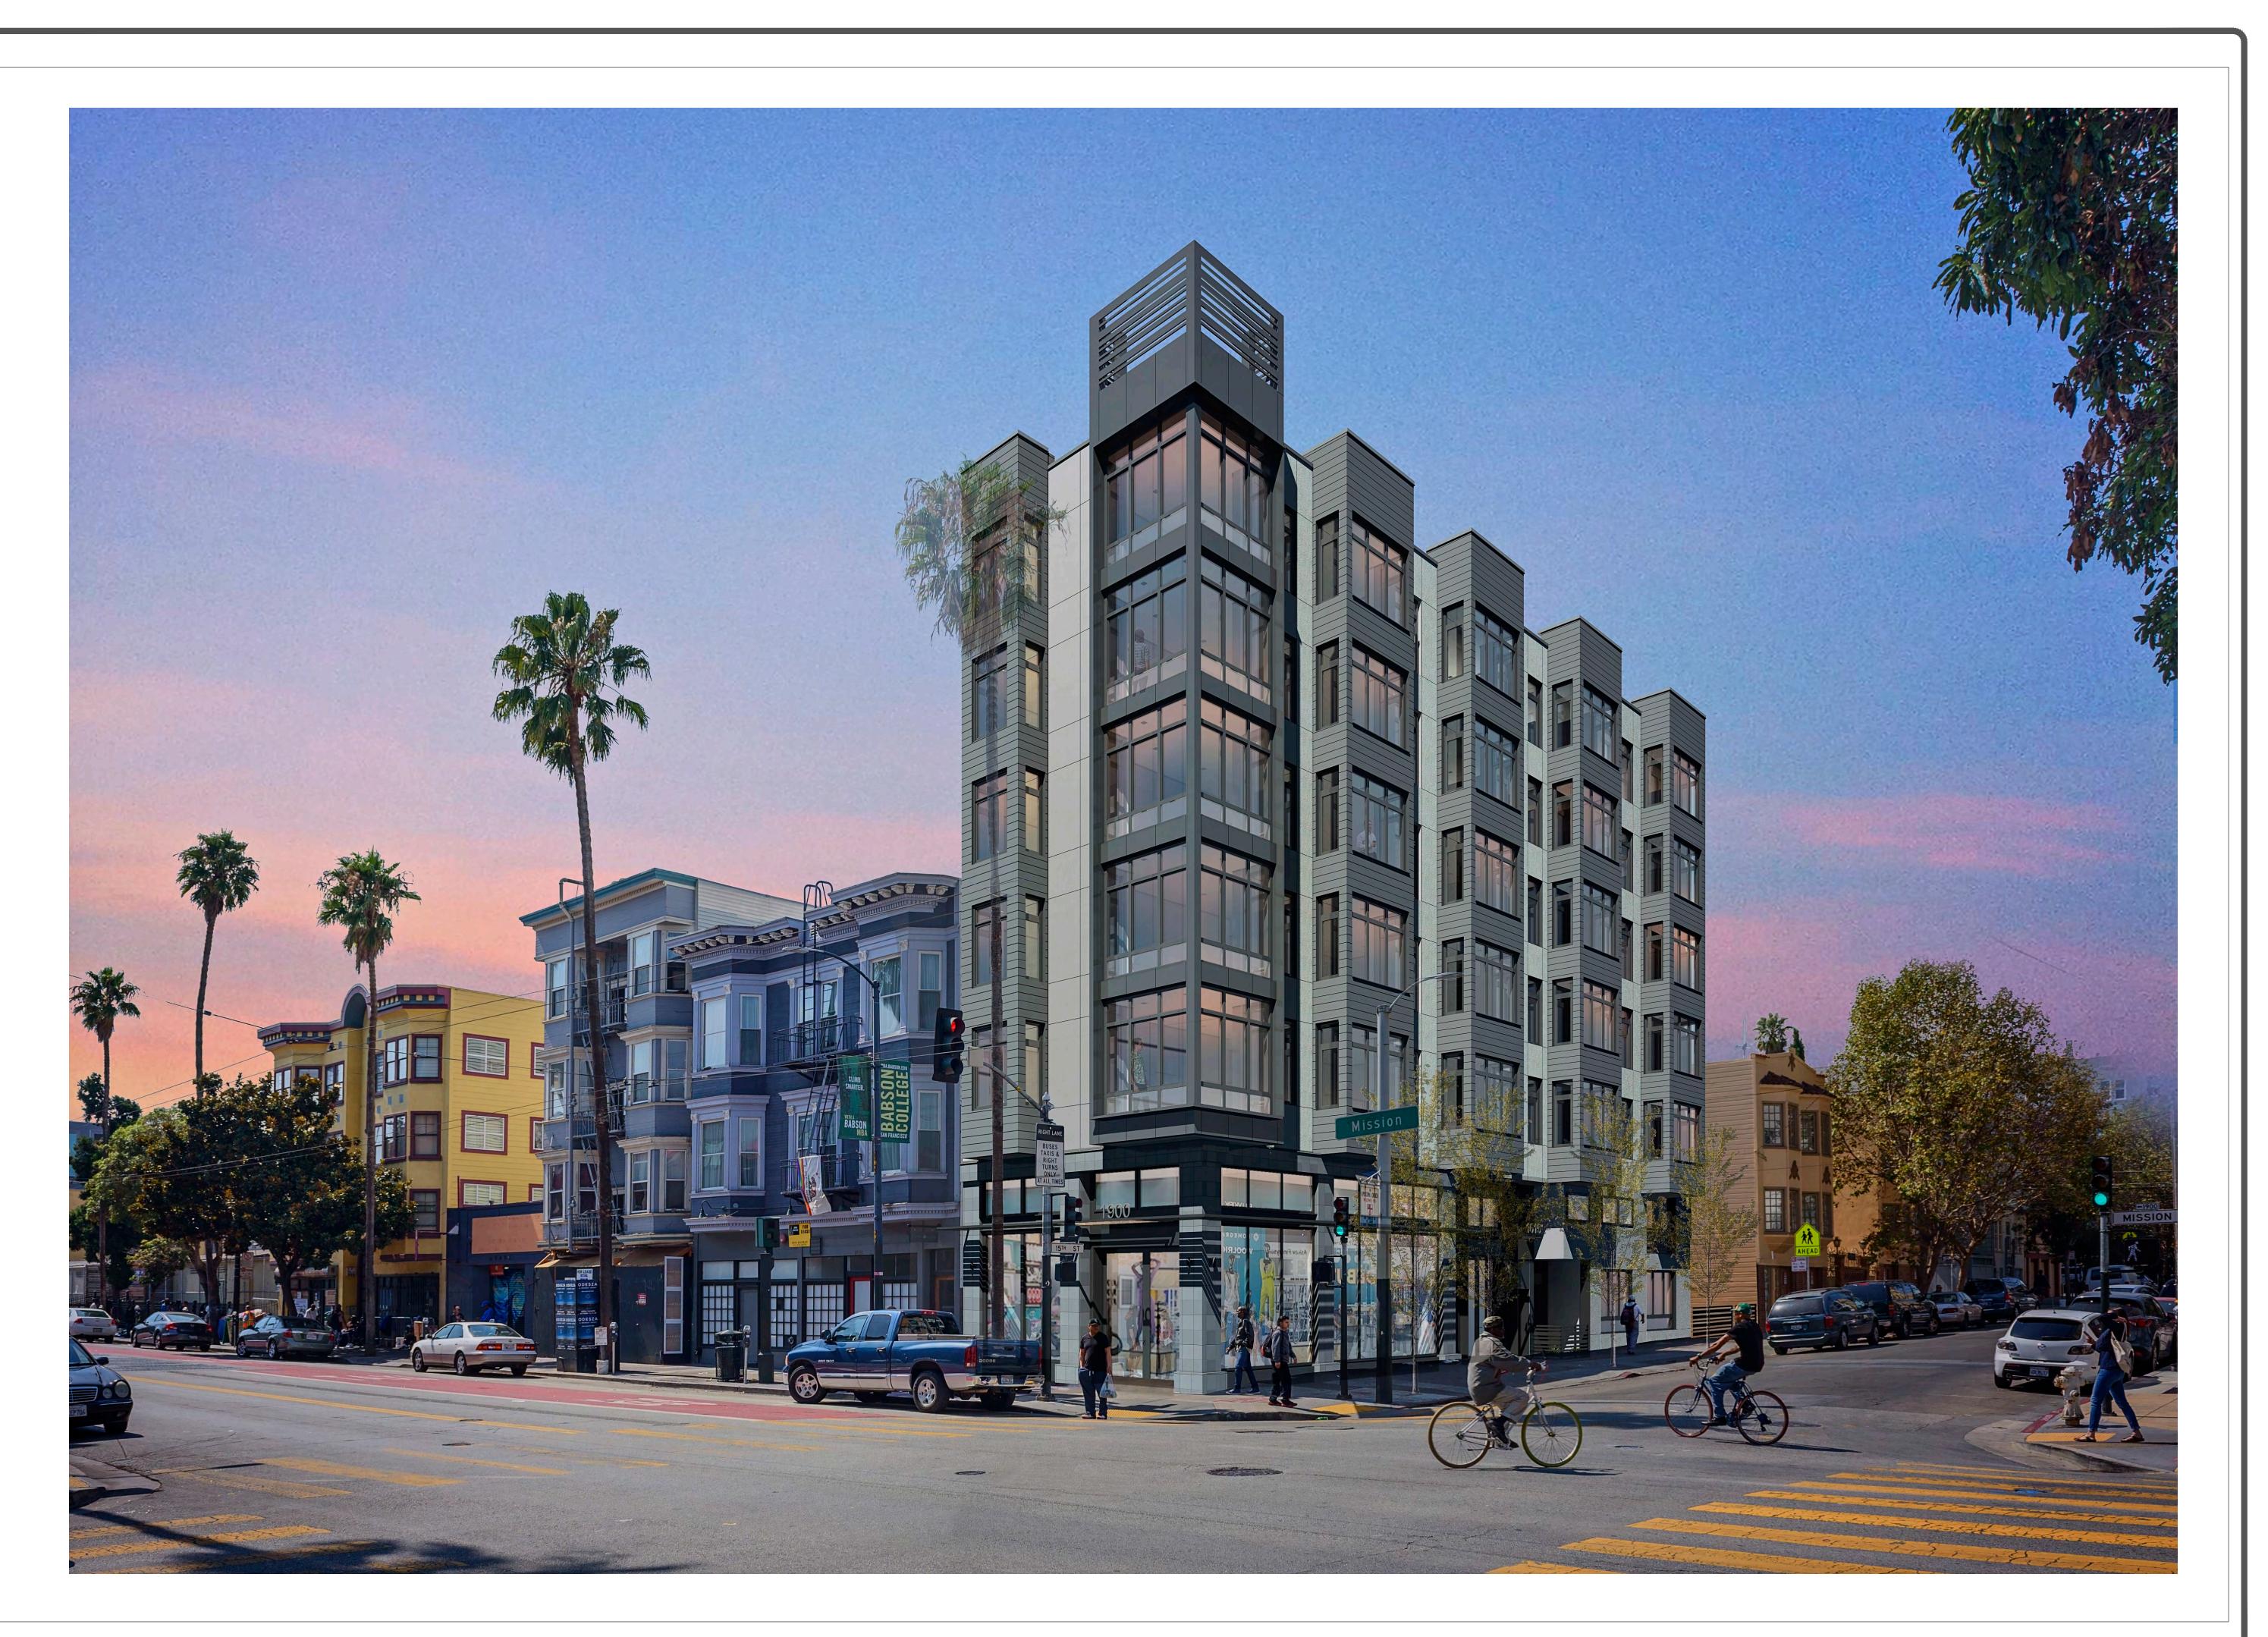

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1900 MISSION ST, SAN FRANCISCO, CA
3D MODEL - VIEW SW FROM INTERSECTION OF 15TH ST AND MISSION ST

drawn: S.A.

checked: K.S. / J.F.

date: 09/19/2017


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sheet:

Sheet

A-4.0



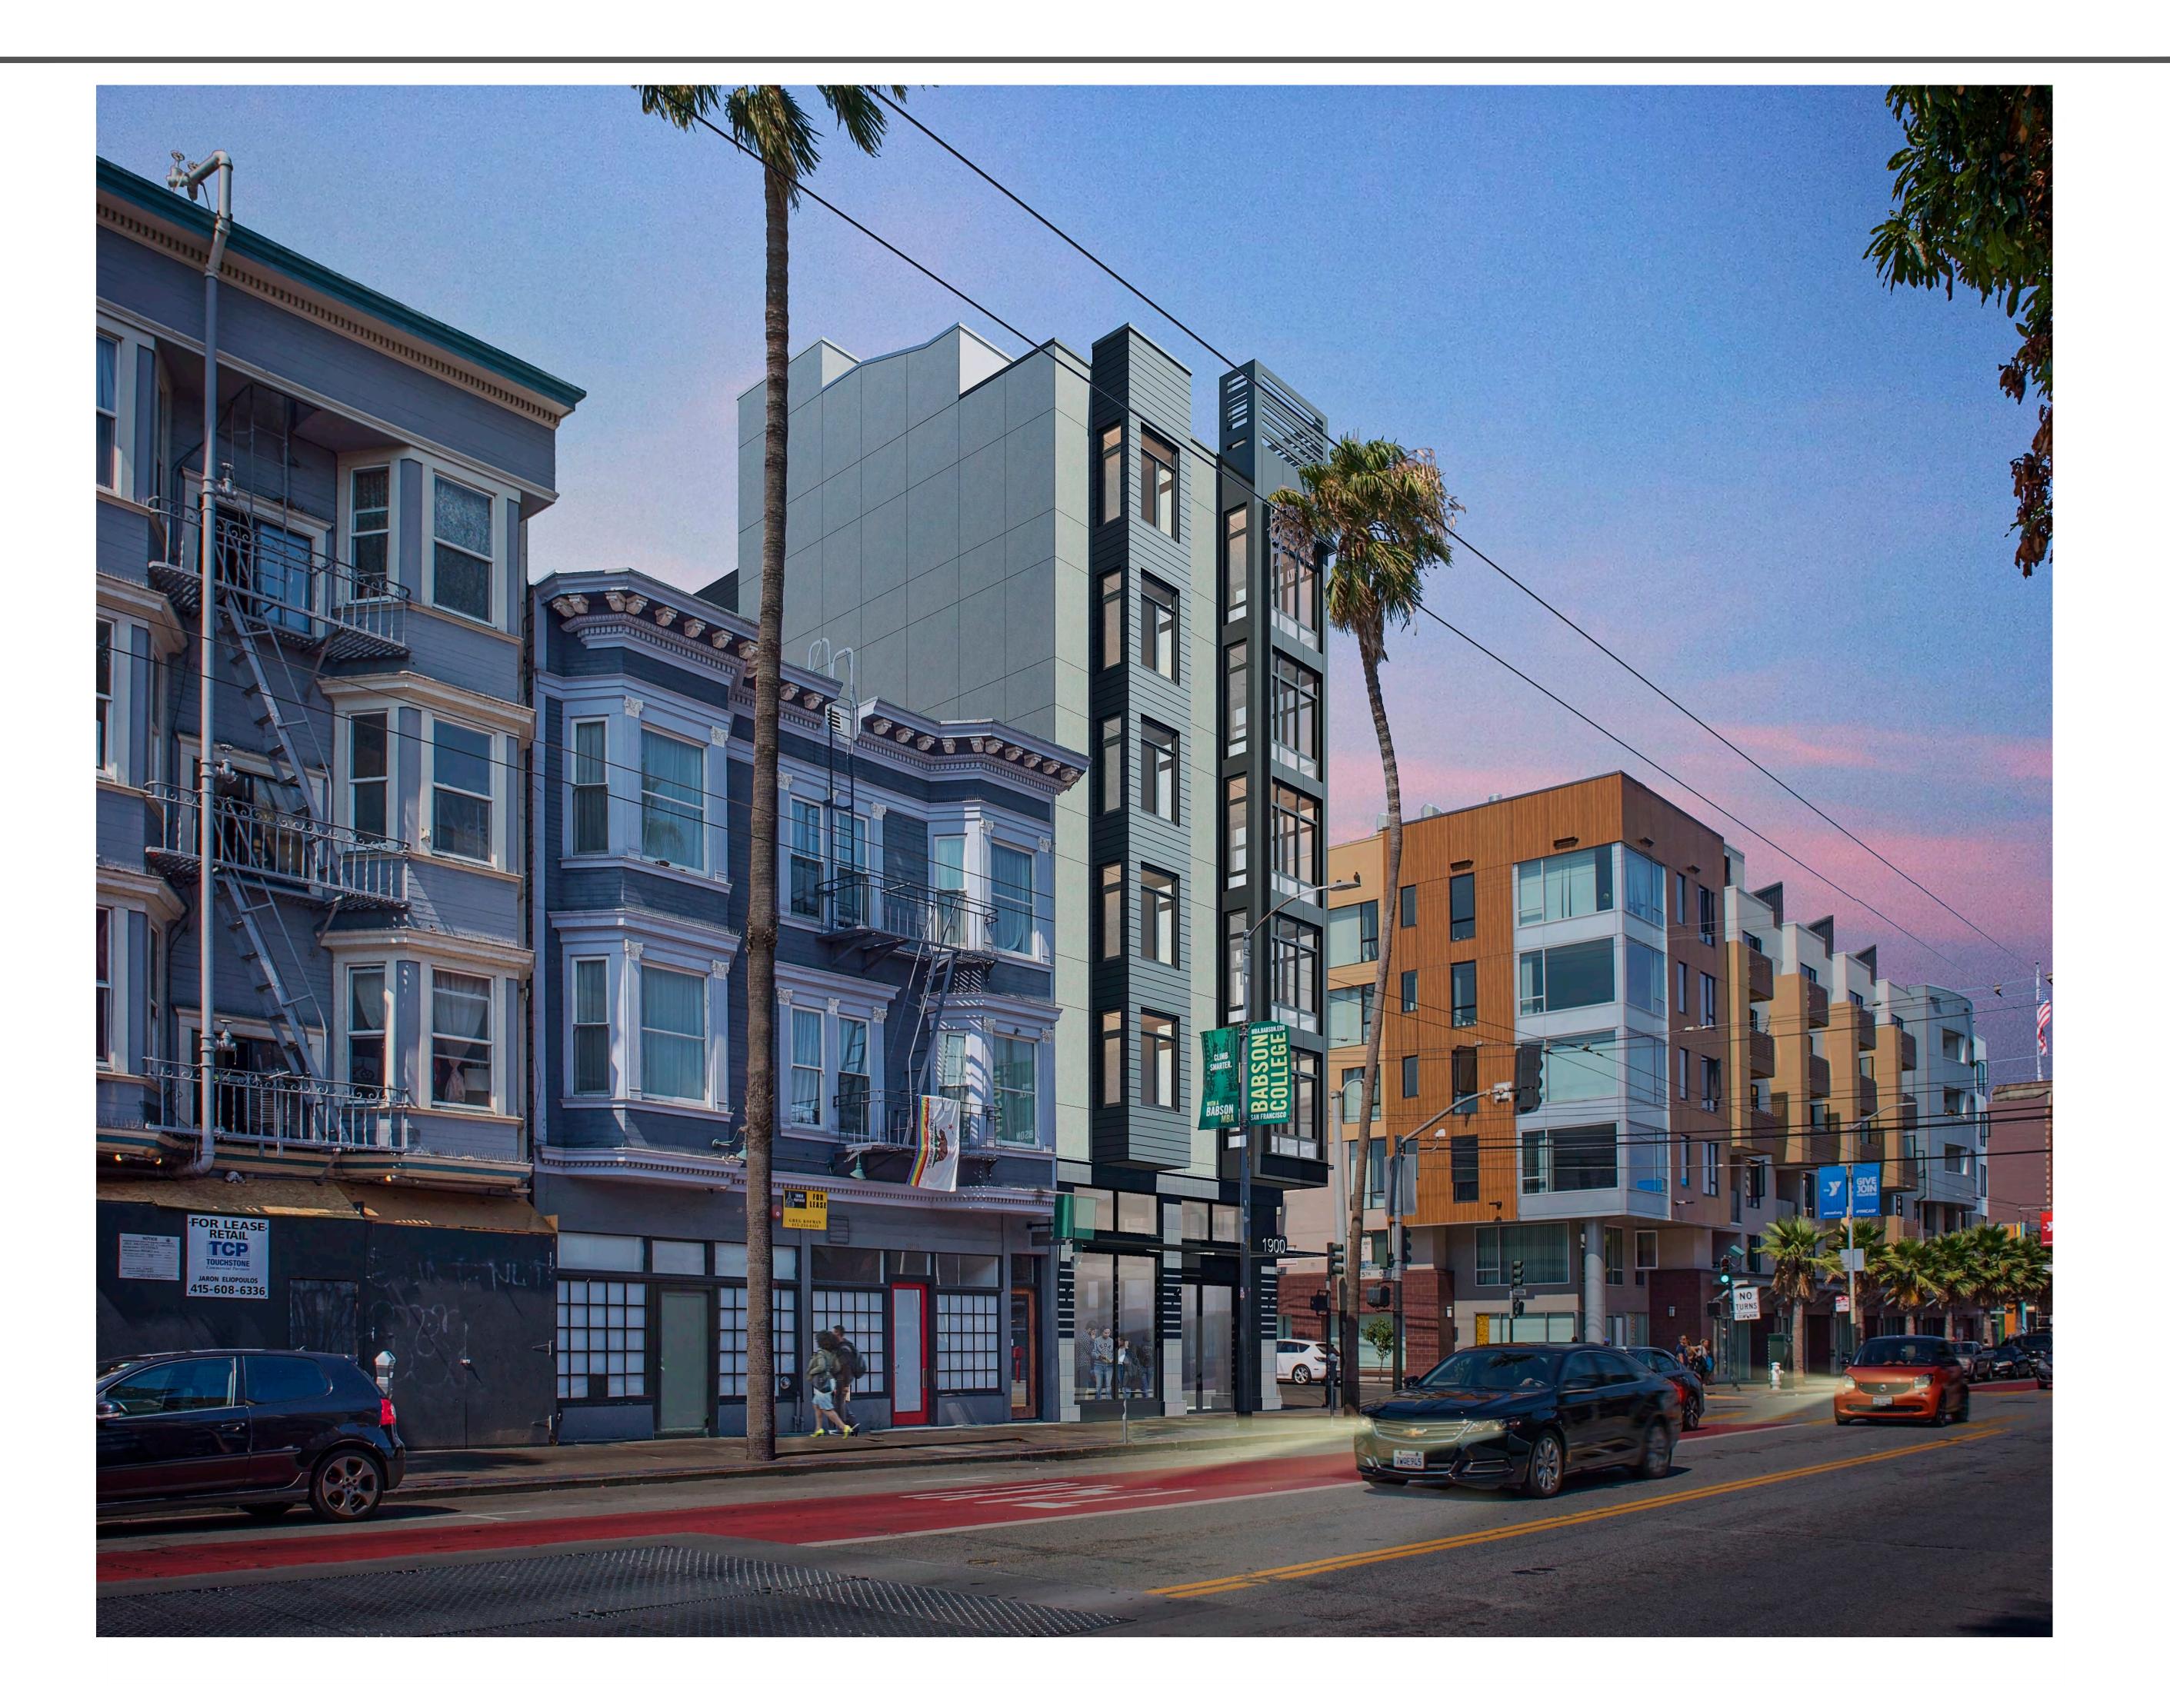

- VIEW SOUTH TO NORTH ON MISSION ST



07/27/2017

09/19/2017 S.A

drawn: S.A. checked: K.S. / J.F. date: 09/19/2017 scale: 3/16"=1'-0"





- 15TH ST VIEW FROM WEST TO I



